



C300

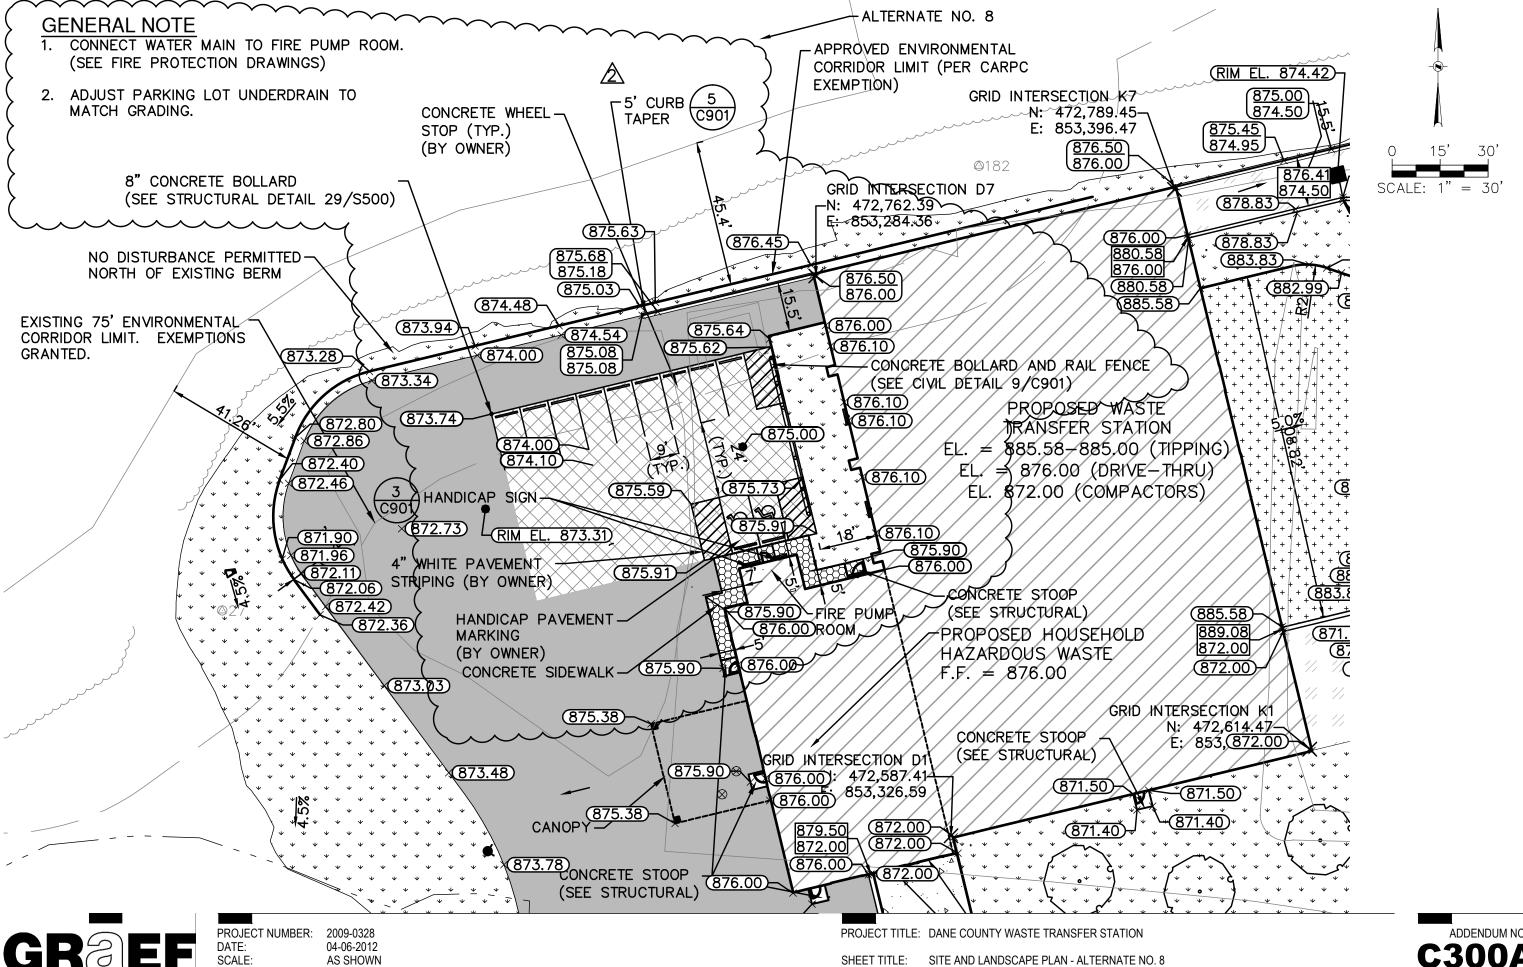

SHEET TITLE: SITE AND LANDSCAPE PLAN - ALTERNATE NO. 8

AS SHOWN

ADDENDUM NO. 2

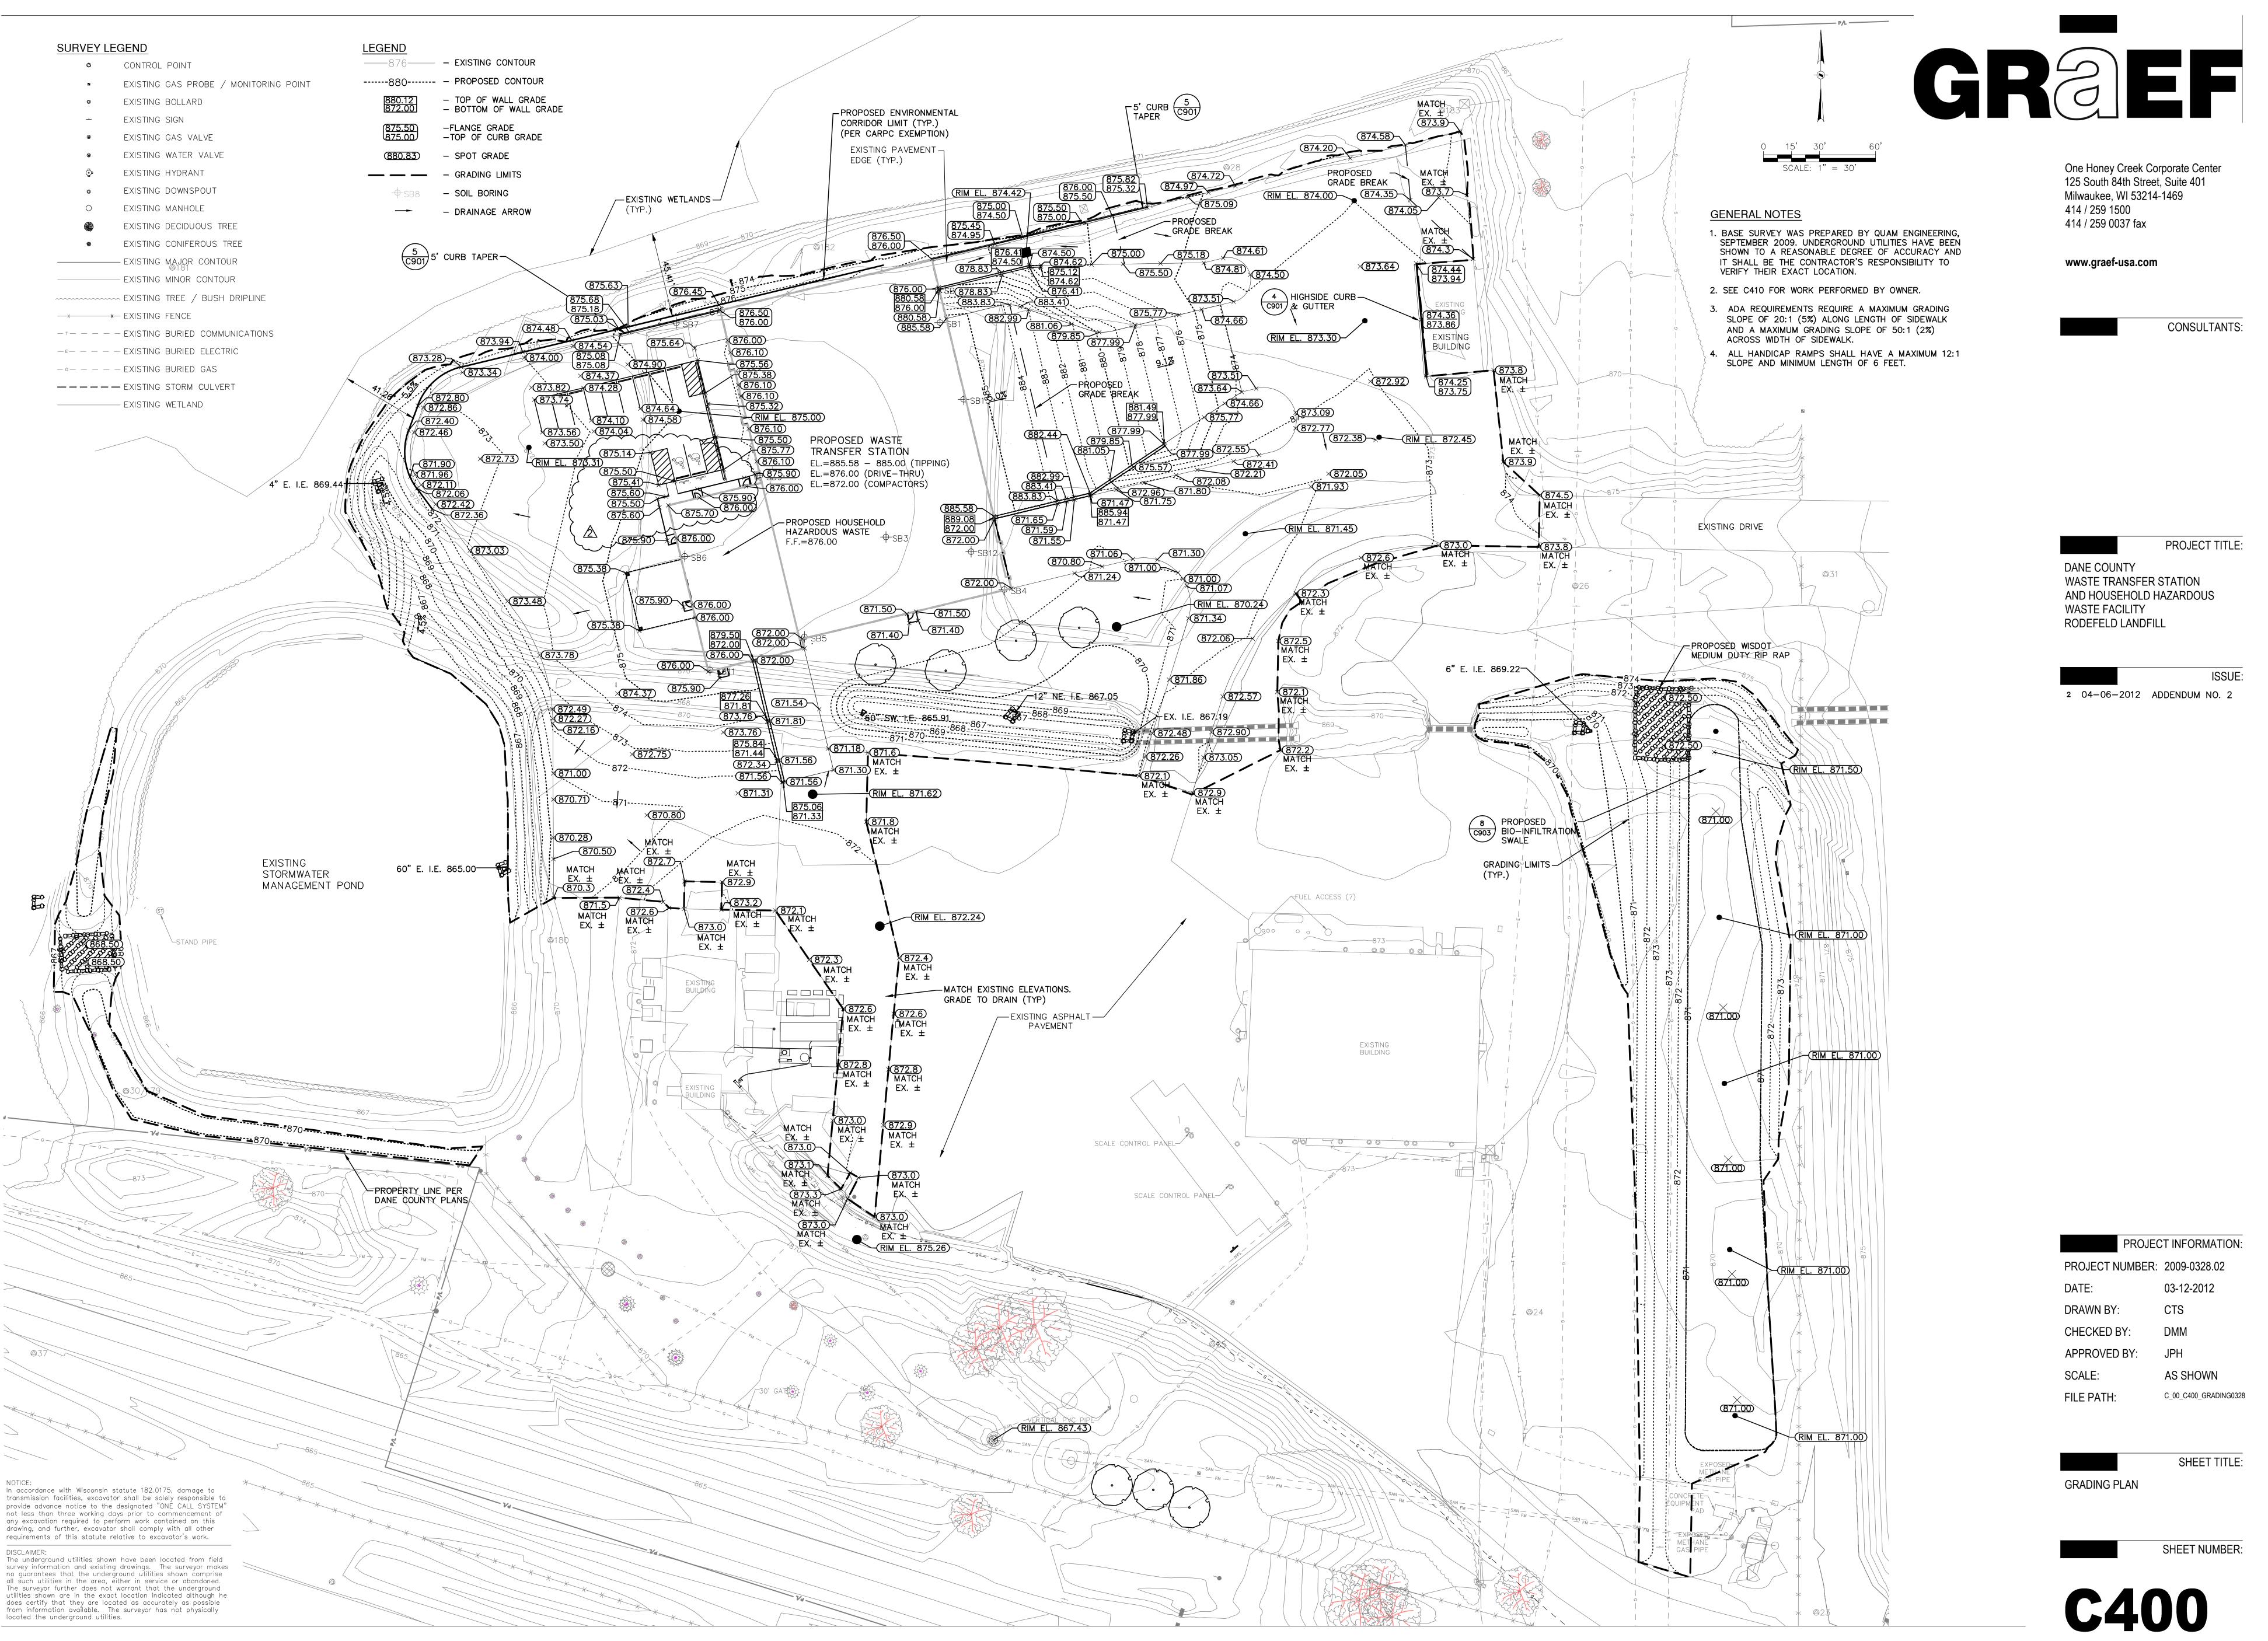

One Honey Creek Corporate Center 125 South 84th Street, Suite 401 Milwaukee, WI 53214-1469 414 / 259 1500 414 / 259 0037 fax

www.graef-usa.com

CONSULTANTS:

PROJECT TITLE:

DANE COUNTY WASTE TRANSFER STATION AND HOUSEHOLD HAZARDOUS WASTE FACILITY RODEFELD LANDFILL

ISSUE: 2 04-06-2012 ADDENDUM NO. 2

PROJECT INFORMATION:

PROJECT NUMBER: 2009-0328.02

DATE: 03-12-2012

DRAWN BY:

CHECKED BY:

APPROVED BY:

SCALE: C\_00\_C400\_GRADING0328

SHEET TITLE:

**GRADING PLAN** 

C400



12"x18"x0.080 ALUM.
SIGN W/IDENTIFICATION
SYMBOL & LETTERING AS
REQUIRED TO CONFORM
TO MOST CURRENT CODES.

\_\_\_ 4" TYPE A1 AGGREGATE

/— SUBGRADE

RESERVED STATE DISABLED PLATES

LEFT ARROW

12"x30" — CONC. BASE

-ASPHALT PAVEMENT (DETAIL 2 ON C901)

5" NON-REINFORCED CONCRETE PAVEMENT SIDEWALK. TOP OF SIDEWALK TO MATCH ADJACENT ASPHALION

PAVEMENT ELEVATION.

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ISSUE:

2 04-06-2012 ADDENDUM NO. 2

9" CONCRETE PAVEMENT 6" TYPE A1 AGGREGATE ——6" TYPE A5 BASE COURSE TYPE 1 GEOTEXTILE 

12"x18"x0.080 ALUM.
SIGN W/IDENTIFICATION
SYMBOL & LETTERING AS
REQUIRED TO CONFORM
TO MOST CURRENT CODES.

REQUIRED FOR VAN — ACCESSIBLE PARKING STALLS.

2" DIA. GALVANIZED — STEEL POLE (TYP.)

12"x30" —— CONC. BASE

RIGHT ARROW

VERTICAL FACE


CURB & GUTTER

12"x30" — CONC. BASE


VAN ACCESS

ACCESSIBLE SIGNS

TIPPING RAMP CONCRETE PAVEMENT

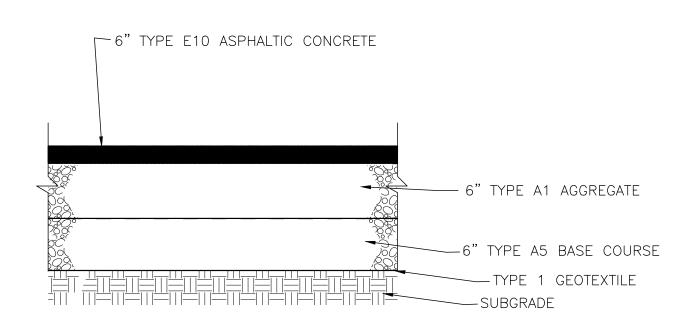

TIPPING RAMP ASPHALT PAVEMENT (BY OWNER)

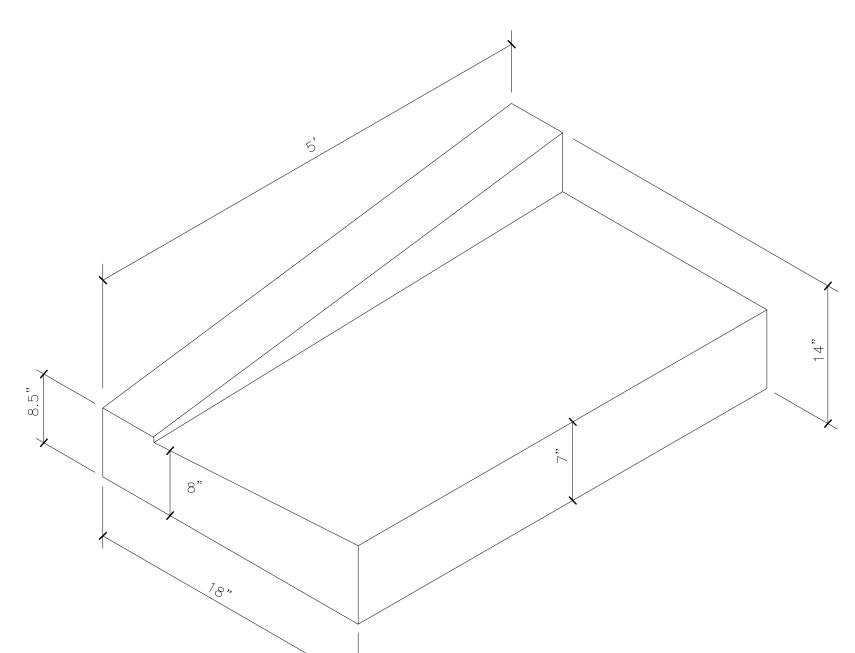

PERFORATION MODIFICATION SCHEDULE

ELEVATION

865.00

866,00

EXISTING 864.00 STRUCTURE PROPOSED STRUCTURE 864.00

EXISTING STRUCTURE

EXISTING

STRUCTURE

STRUCTURE

PROPOSED STRUCTURE

PROPOSE:

HOLE DIA

QUANTITY

9" CONCRETE PAVEMENT

TYPE 1 G

TYPE 1 G

CONCRETE PAVEMENT

6" TYPE E1.0 ASPHALTIC CONCRETE

ASPHALT PAVEMENT (BY OWNER)

---- 6" TYPE A1 AGGREGATE

----6" TYPE A2 AGGREGATE


TYPE 1 GEOTEXTILE

---- 6" TYPE A1 AGGREGATE


-----6" TYPE A2 AGGREGATE

TYPE 1 GEOTEXTILE

5 5' CURB TAPER SECTION

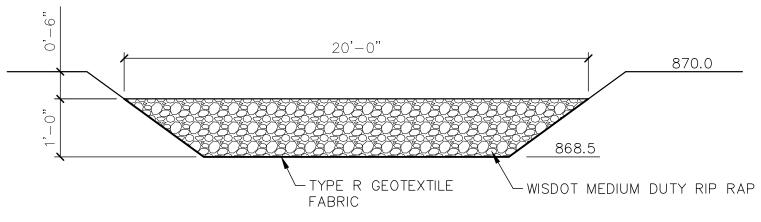

EMERGENCY SPILLWAY

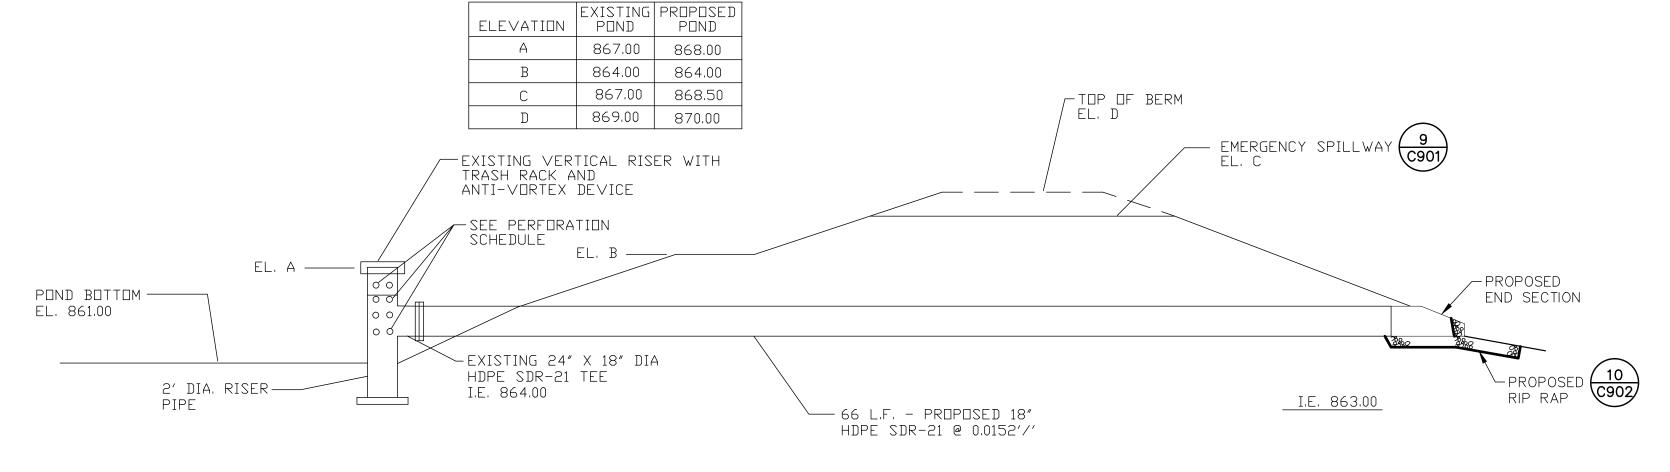

-2" DIA. SCHEDULE 40 PIPE FOR HORIZONTAL RAILS 8" BOLLARD AT 8' O.C. (9 TOTAL AT RAIL FENCE) (SEE STRUCTURAL DETAIL 29/S500) (9) RAIL FENCE DETAIL

(8) EXISTING GRINDER PUMP

WET POND OUTLET STRUCTURE MODIFICATION

PROJECT INFORMATION:

03-12-2012

C\_00\_C900\_DETAILS0328

SHEET TITLE:

SHEET NUMBER:

PROJECT NUMBER: 2009-0328.02

DATE:


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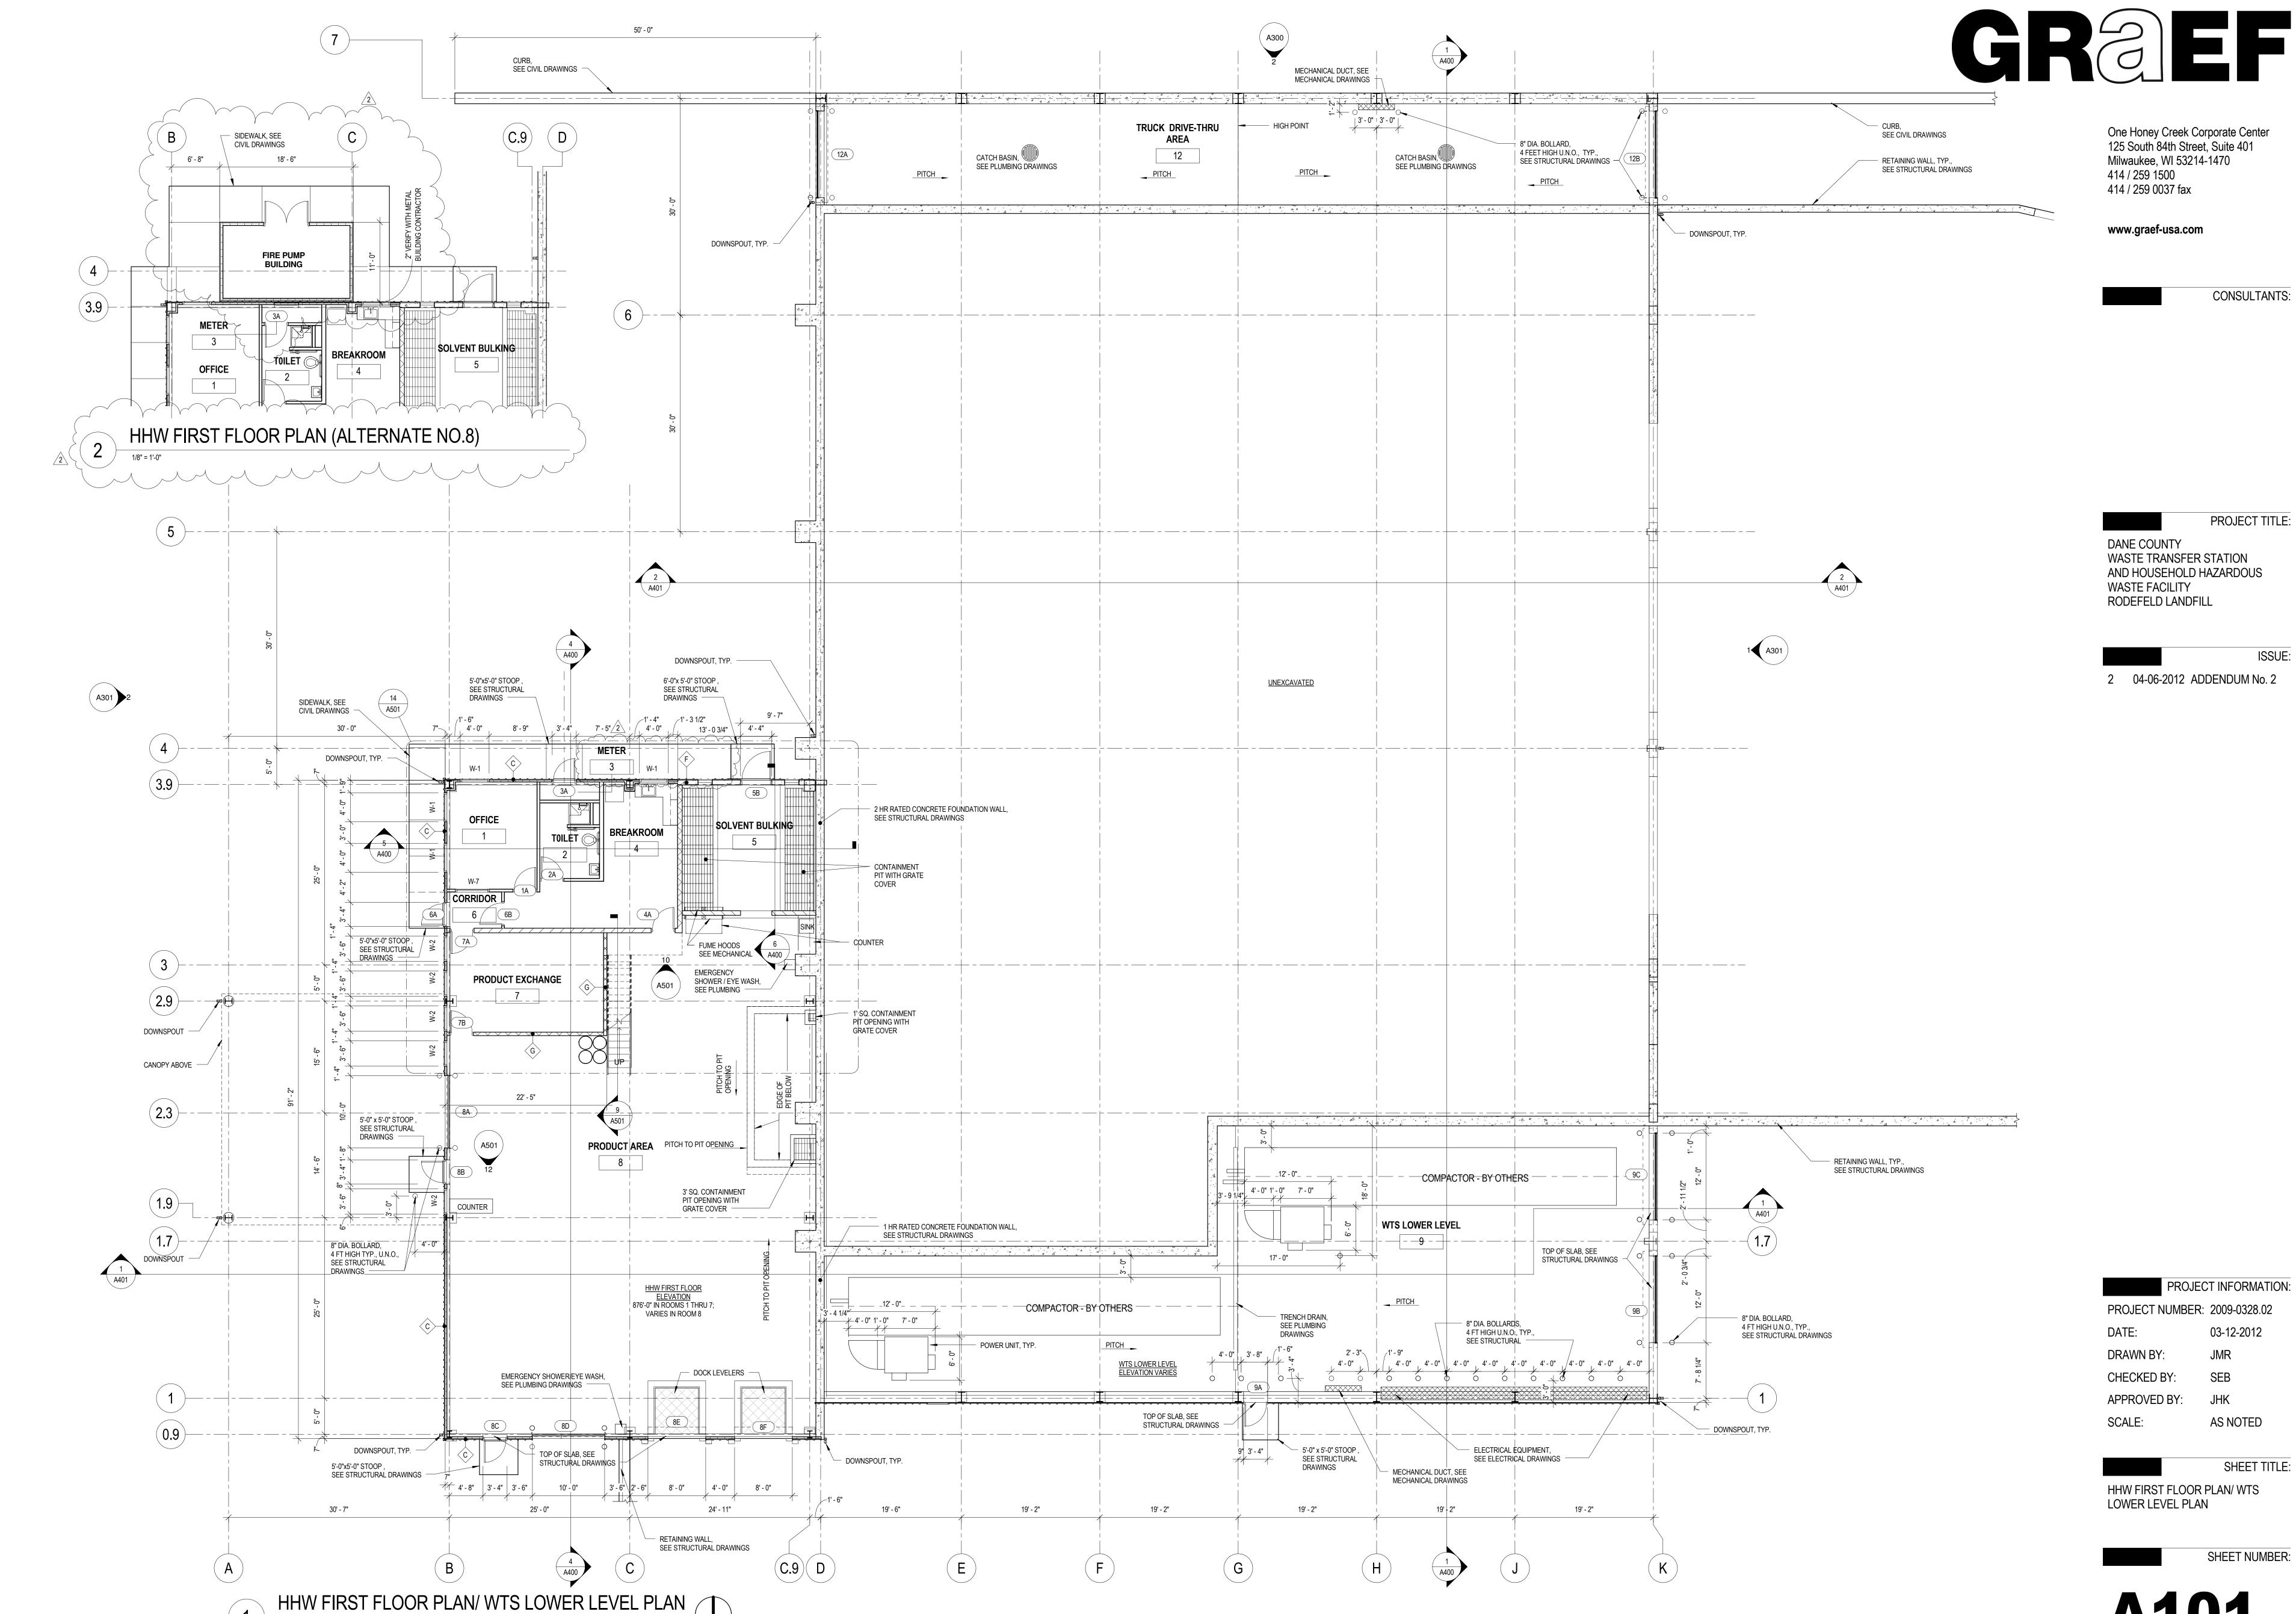
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SITE DETAILS

DRAWN BY:

CHECKED BY:





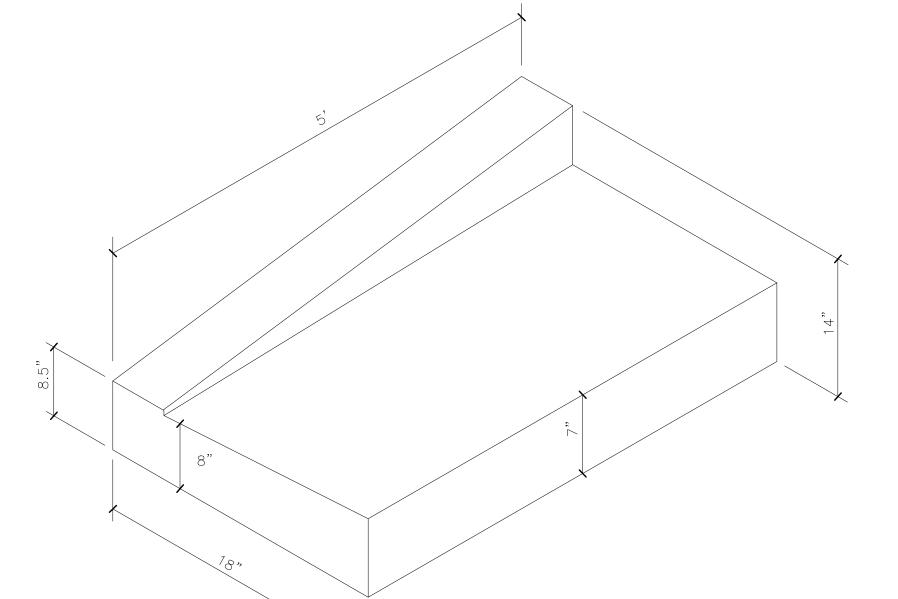

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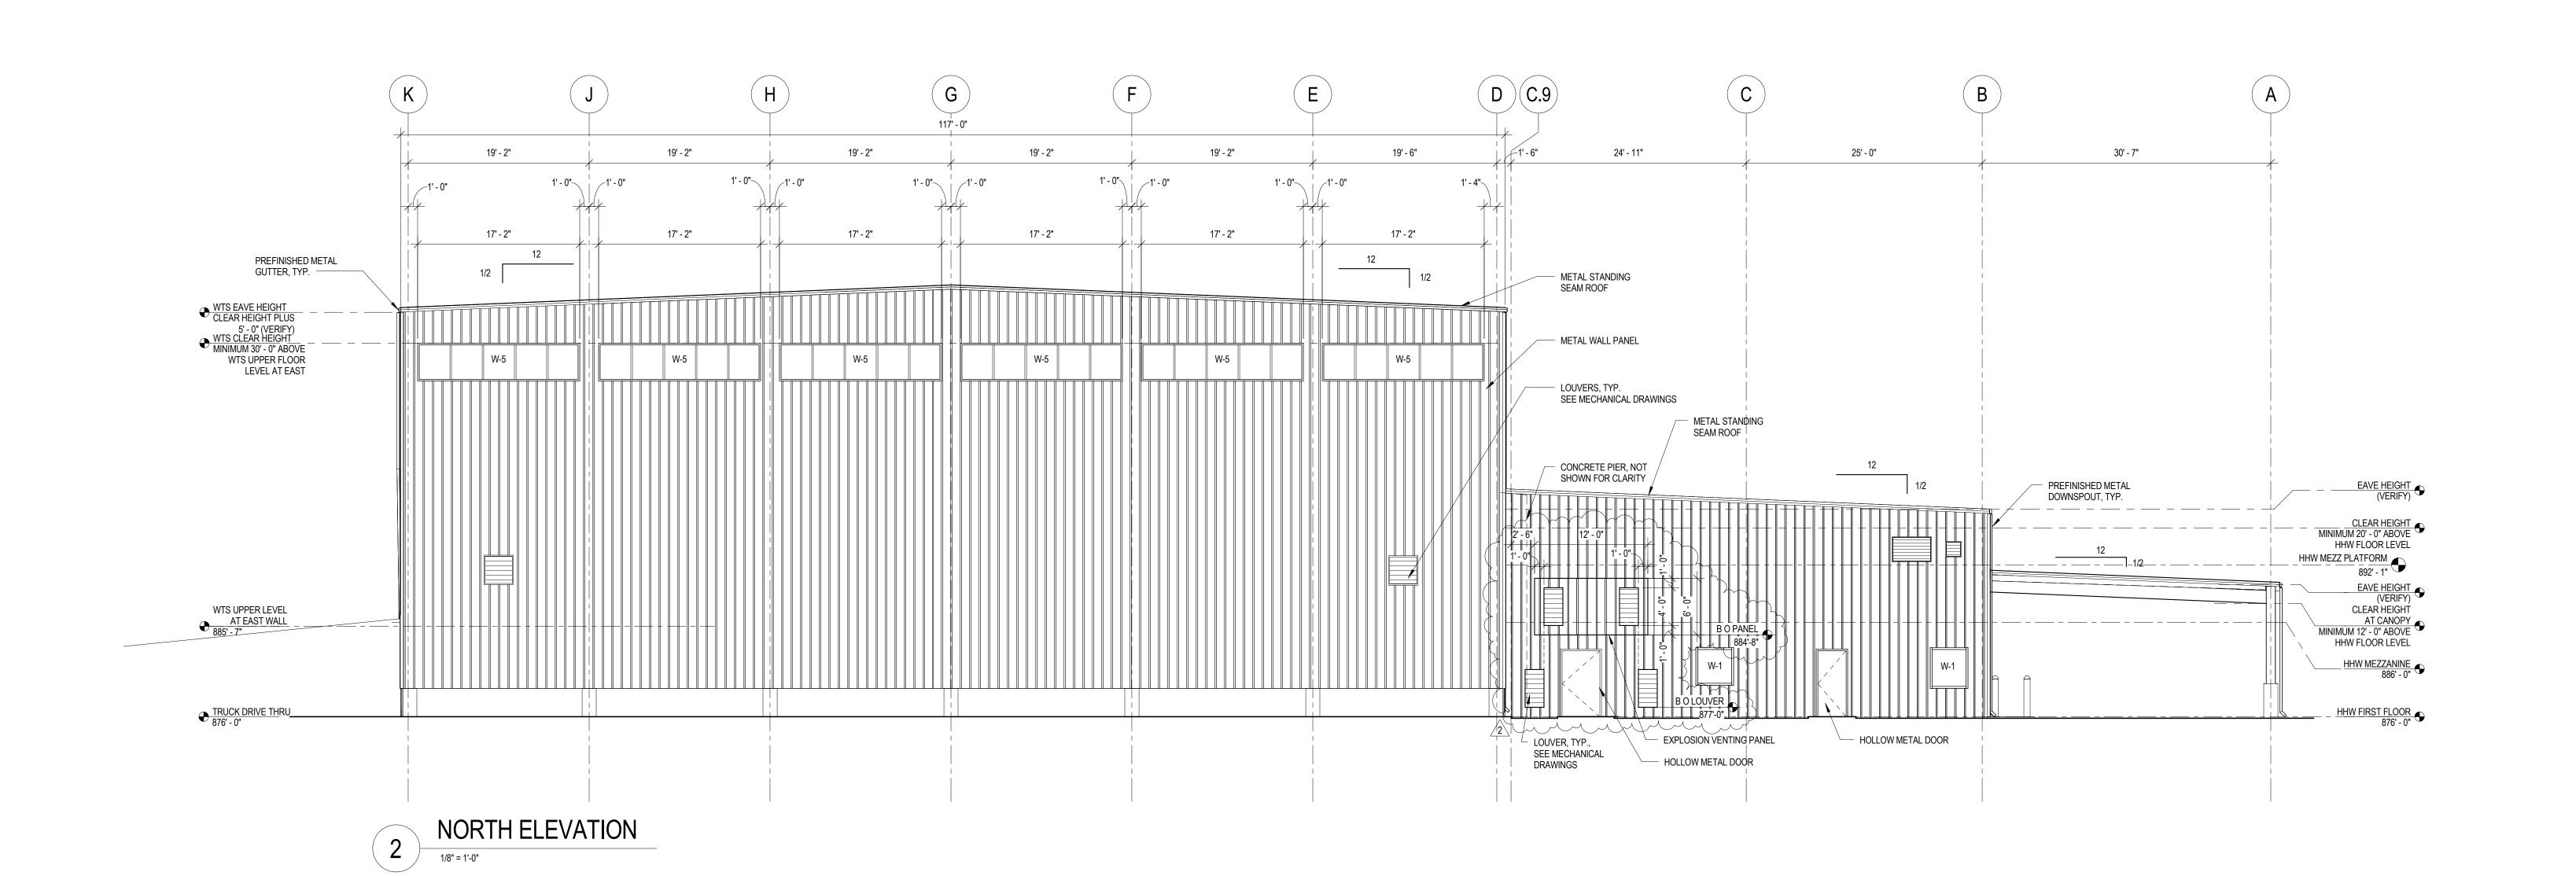
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ISSUE:

2 04-06-2012 ADDENDUM No. 2



(C.9)(D)

19' - 6"

17' - 2"

19' - 2"

17' - 2"

MECHANICAL DRAWINGS

19' - 2"

17' - 2"

1' - 0" \_ 1' - 0"

19' - 2"

17' - 2"

19' - 2"

17' - 2"

19' - 2"

17' - 2"

PREFINISHED METAL GUTTER, TYPICAL

WTS EAVE HEIGHT
CLEAR HEIGHT PLUS
5' - 0" (VERIFY)
WTS CLEAR HEIGHT
MINIMUM 30' - 0"
ABOVE WTS FLOOR
LEVEL AT EAST

CONCRETE RETAINING WALL,
 SEE STRUCTURAL DRAWINGS

WTS UPPER LEVEL

COLOR CHANGE AT PANEL JOINT

26' - 5"

METAL STANDING SEAM ROOF

METAL WALL PANEL

METAL STANDING SEAM ROOF

INSULATED OVERHEAD COILING DOOR

DOCK PIT, TYP.

Downspout, typ.  $-\!\!\!/$ 

4' - 6" 2' - 6" 8' - 0"

25' - 0"

HOLLOW METAL DOOR AND FRAME

INSULATED OVERHEAD SECTIONAL DOOR

8" DIA. BOLLARD, 4 FT HIGH, TYP. U.N.O.,

SEE STRUCTURAL DRAWINGS -

30' - 7"

SIGN BY OWNER

PREFINISHED METAL GUTTER -

SOUTH ELEVATION

1/8" = 1'-0"

PREFINISHED METAL DOWNSPOUT, TYP.

HHW EAVE HEIGHT (VERIFY)

HHW MEZZANINE
886' - 0"
WTS UPPER LEVEL
AT WEST WALL
885' - 0"

HHW CLEAR HEIGHT
MINIMUM 20' - 0" ABOVE
HHW FLOOR LEVEL

PROJECT INFORMATION:

PROJECT NUMBER: 2009-0328.02 DATE: 03-12-2012

CHECKED BY:


APPROVED BY: SCALE: AS NOTED

SHEET TITLE:

**BUILDING ELEVATIONS** 



**A300** 

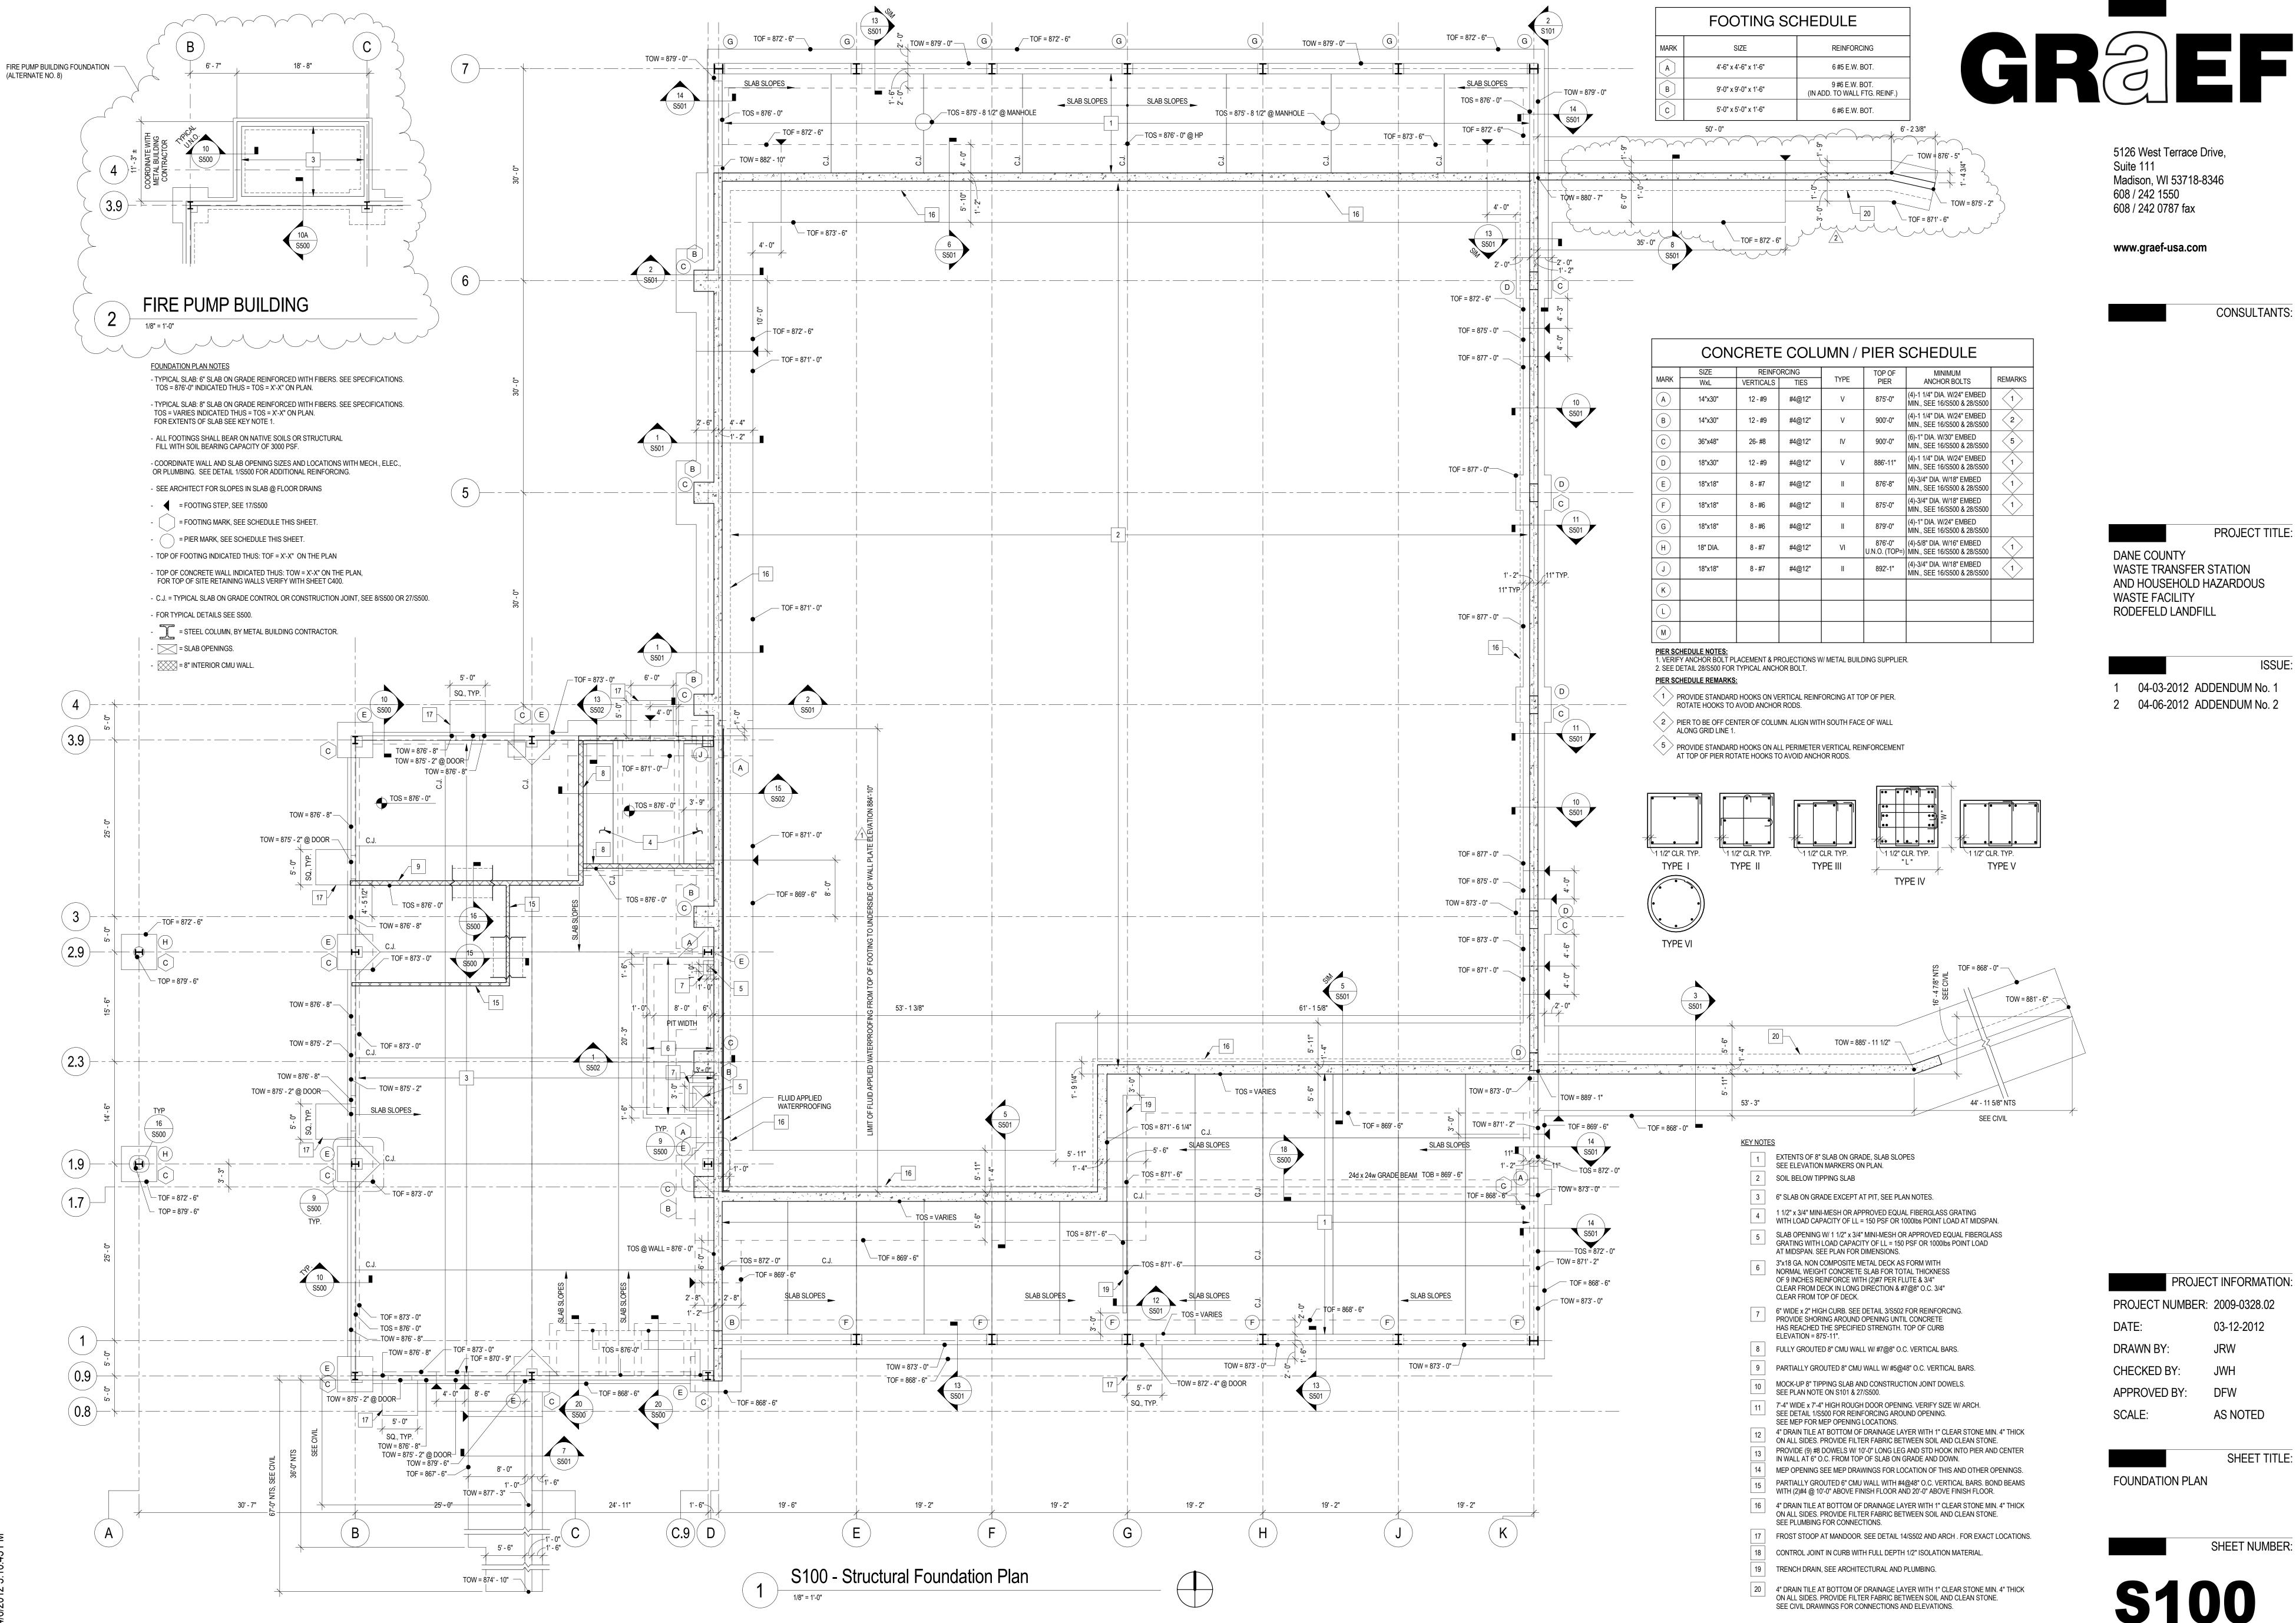



**S100** 

AS NOTED

SHEET TITLE:

**CONSULTANTS:** 

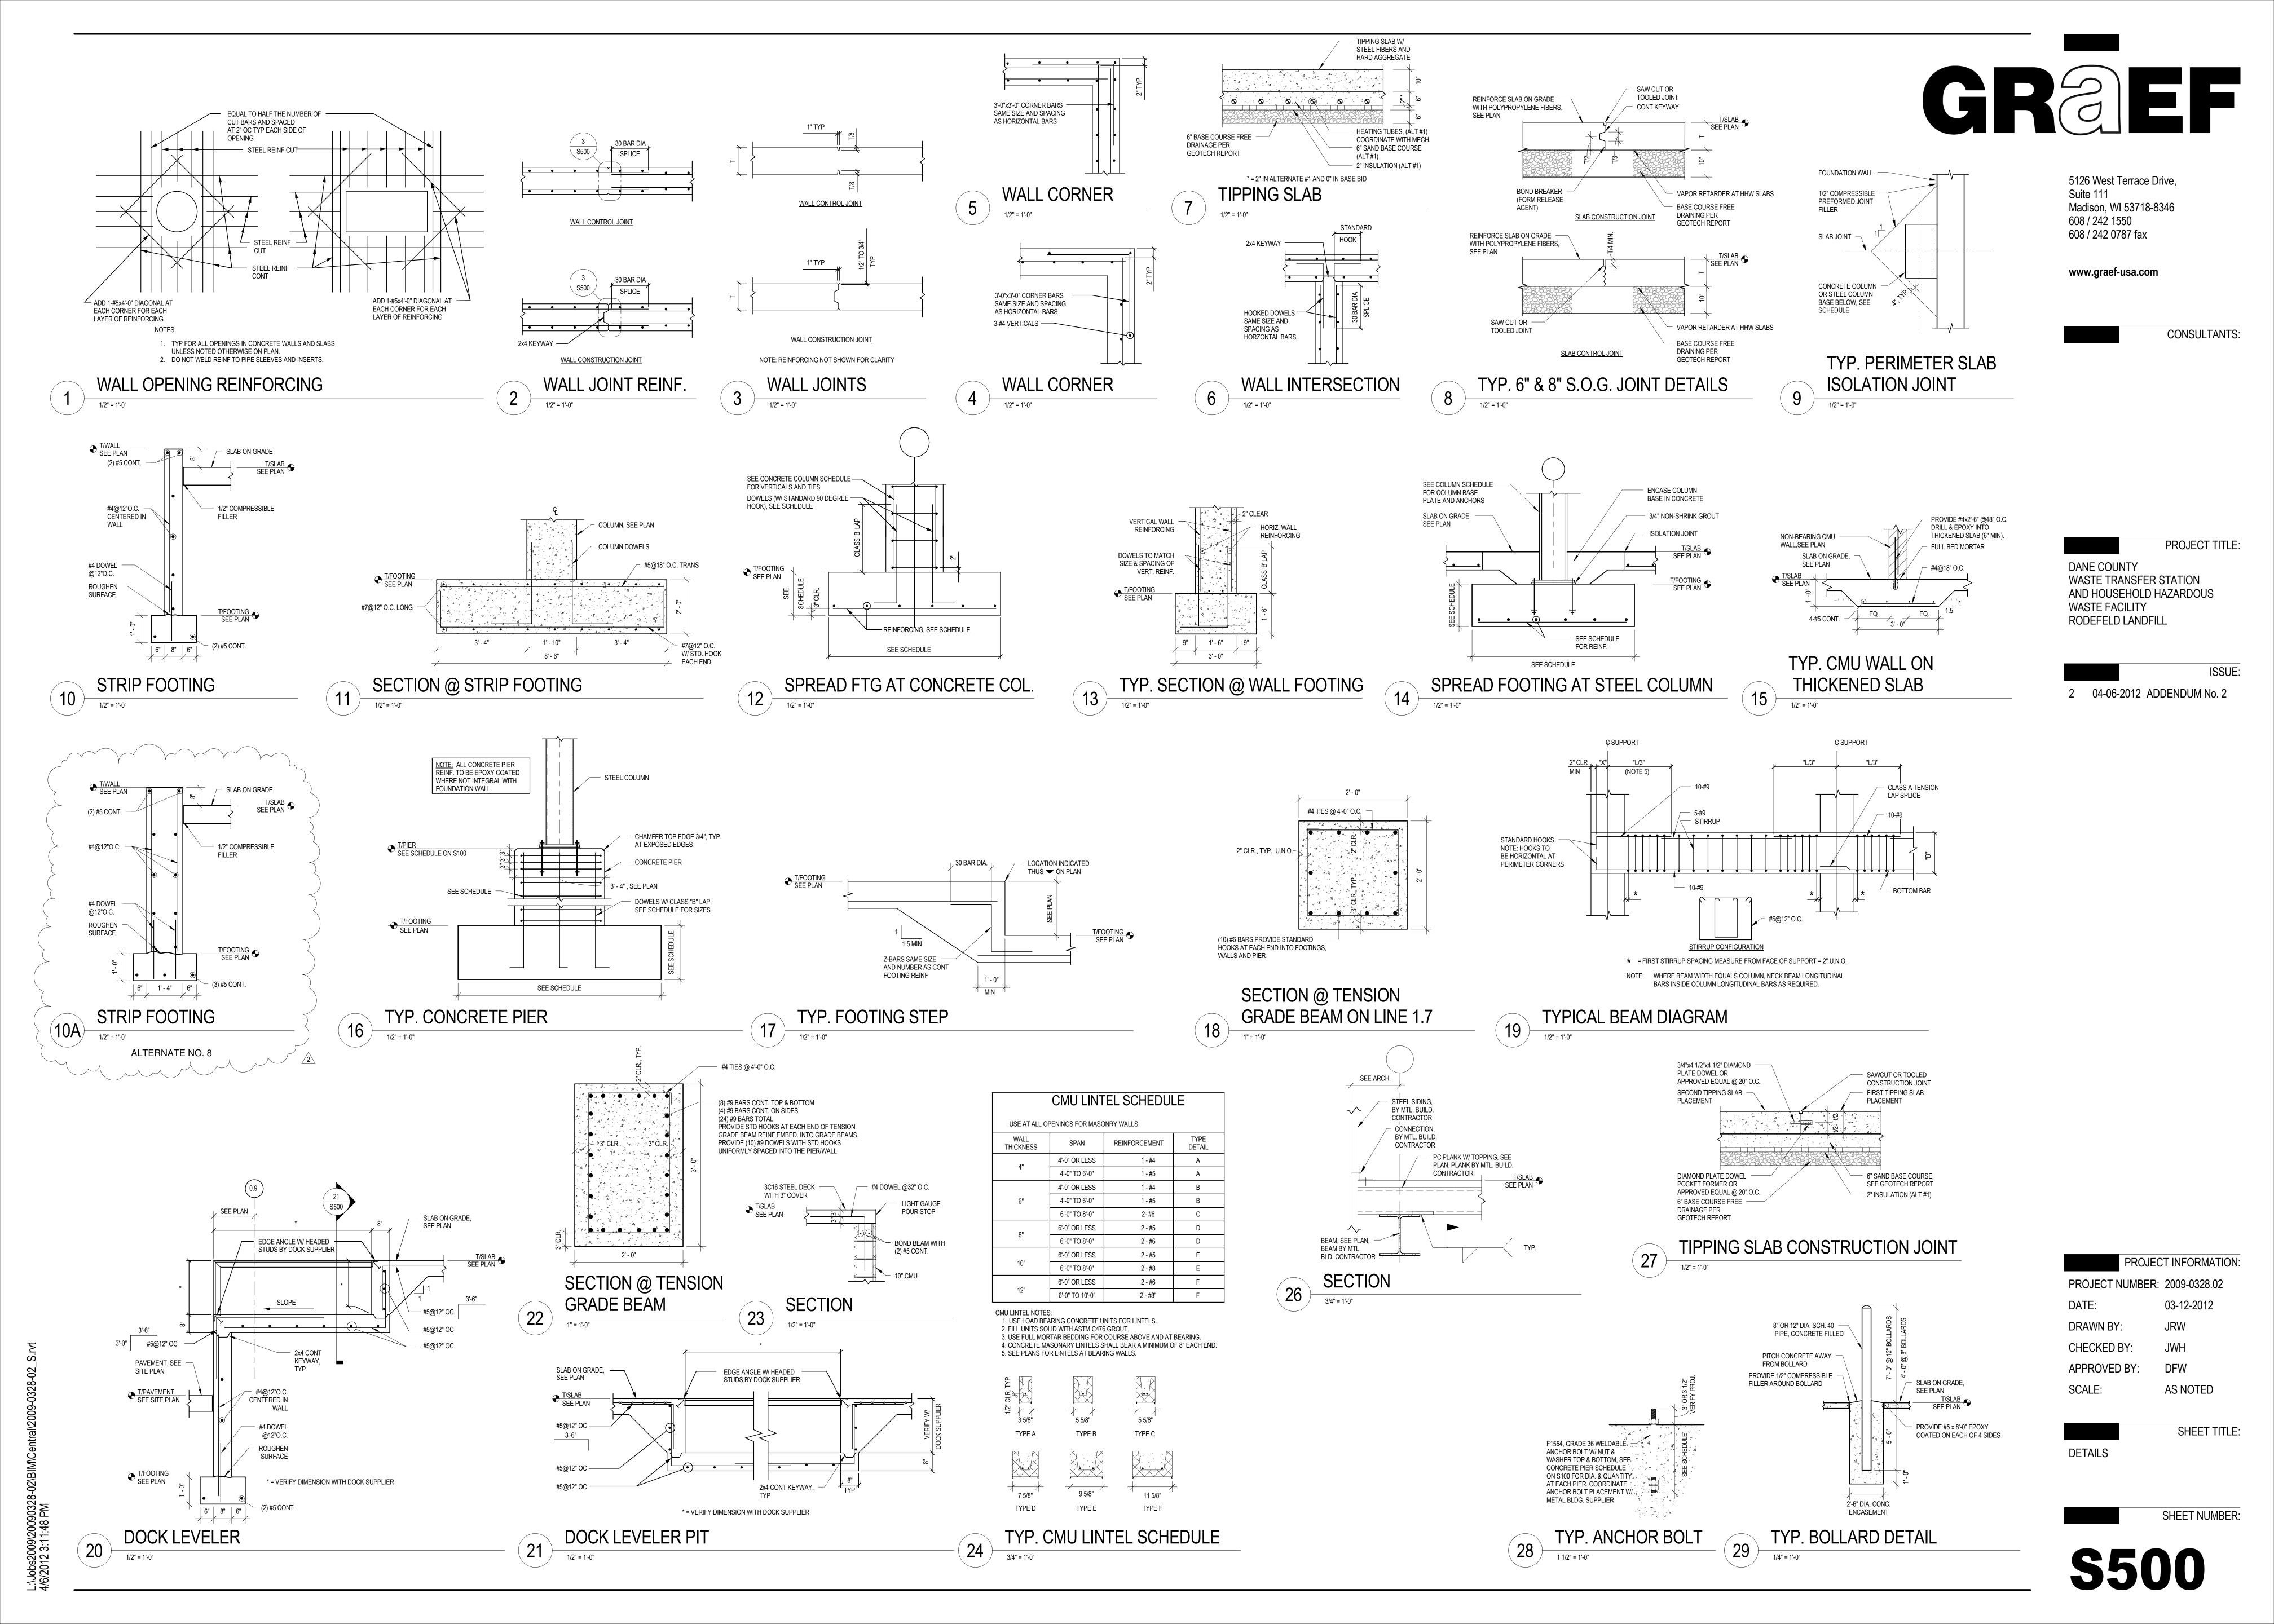

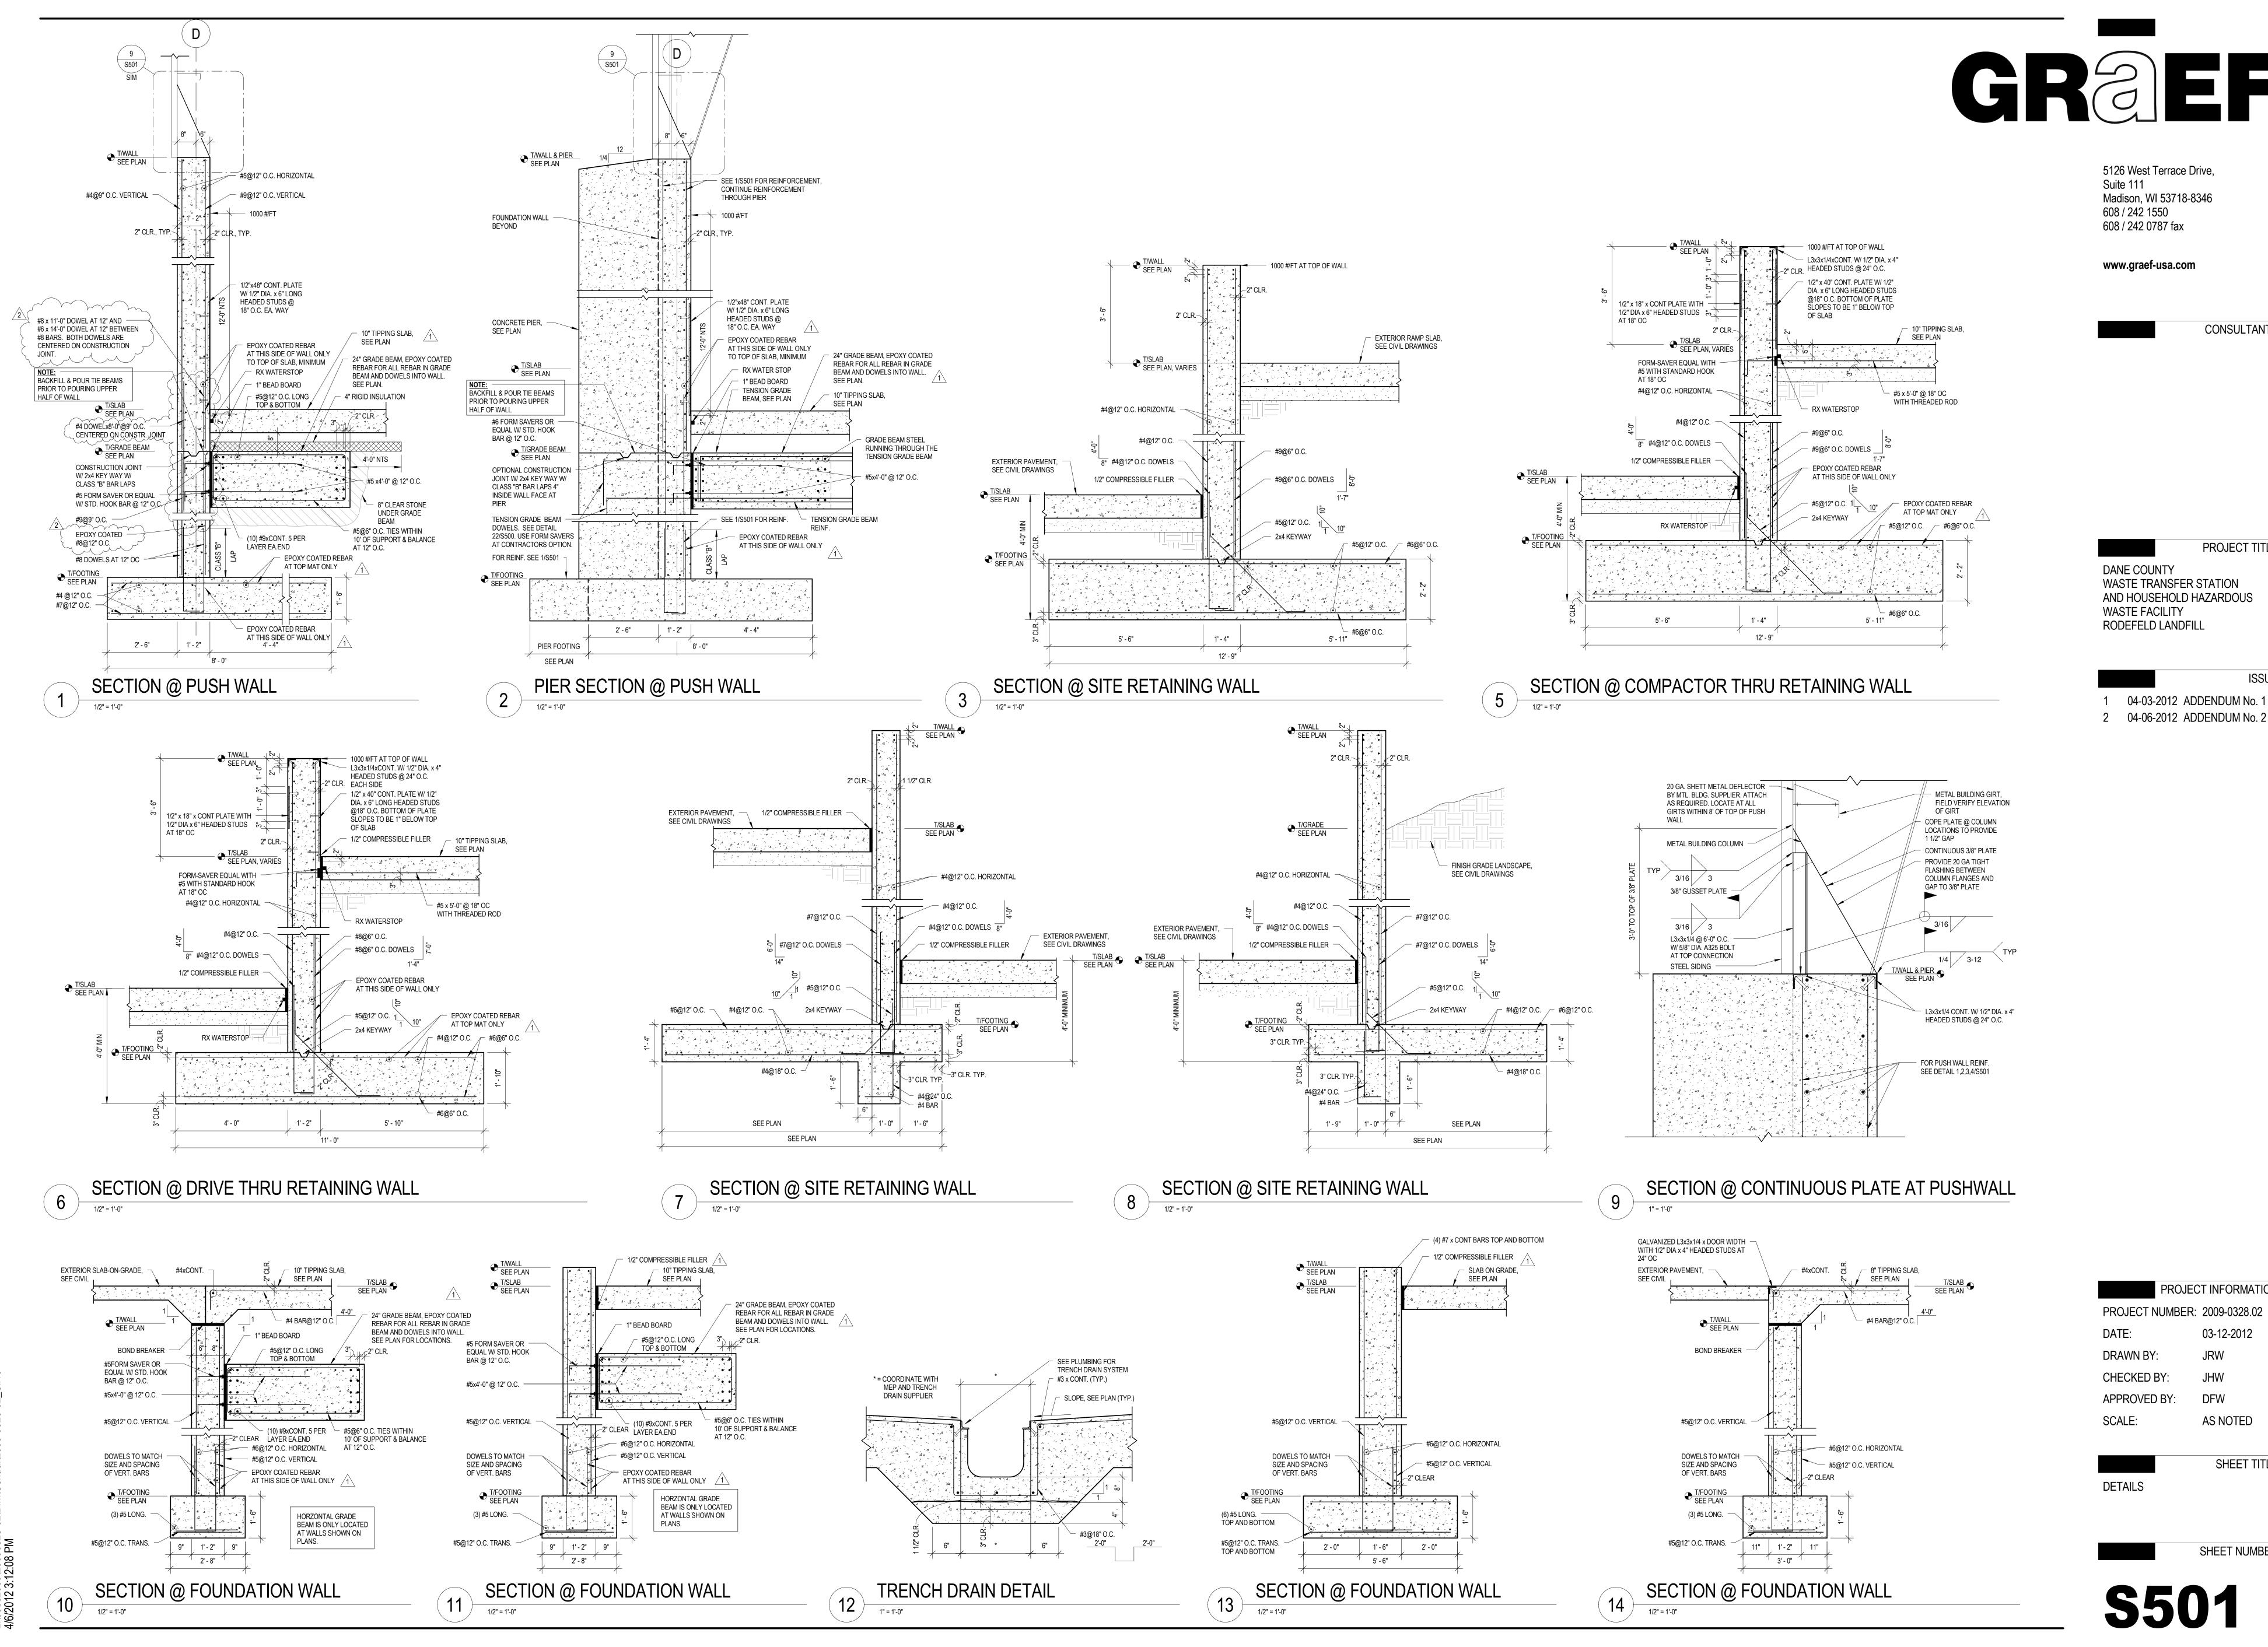

PROJECT INFORMATION:

03-12-2012

AS NOTED

SHEET TITLE:

SHEET NUMBER:

DFW

CONSULTANTS:

PROJECT TITLE:

04-03-2012 ADDENDUM No. 1



2

04-06-2012

ADDENDUM NO. 2

PROJECT TITLE:

CONSULTANTS:

DRAWN BY:

N K K

03-12-2012

CHECKED BY:

NTK

APPROVED BY:


PDZ

AS NOTED

SHEET TITLE:

PROJECT NUMBER: 2009-0328.02

PROJECT INFORMATION:

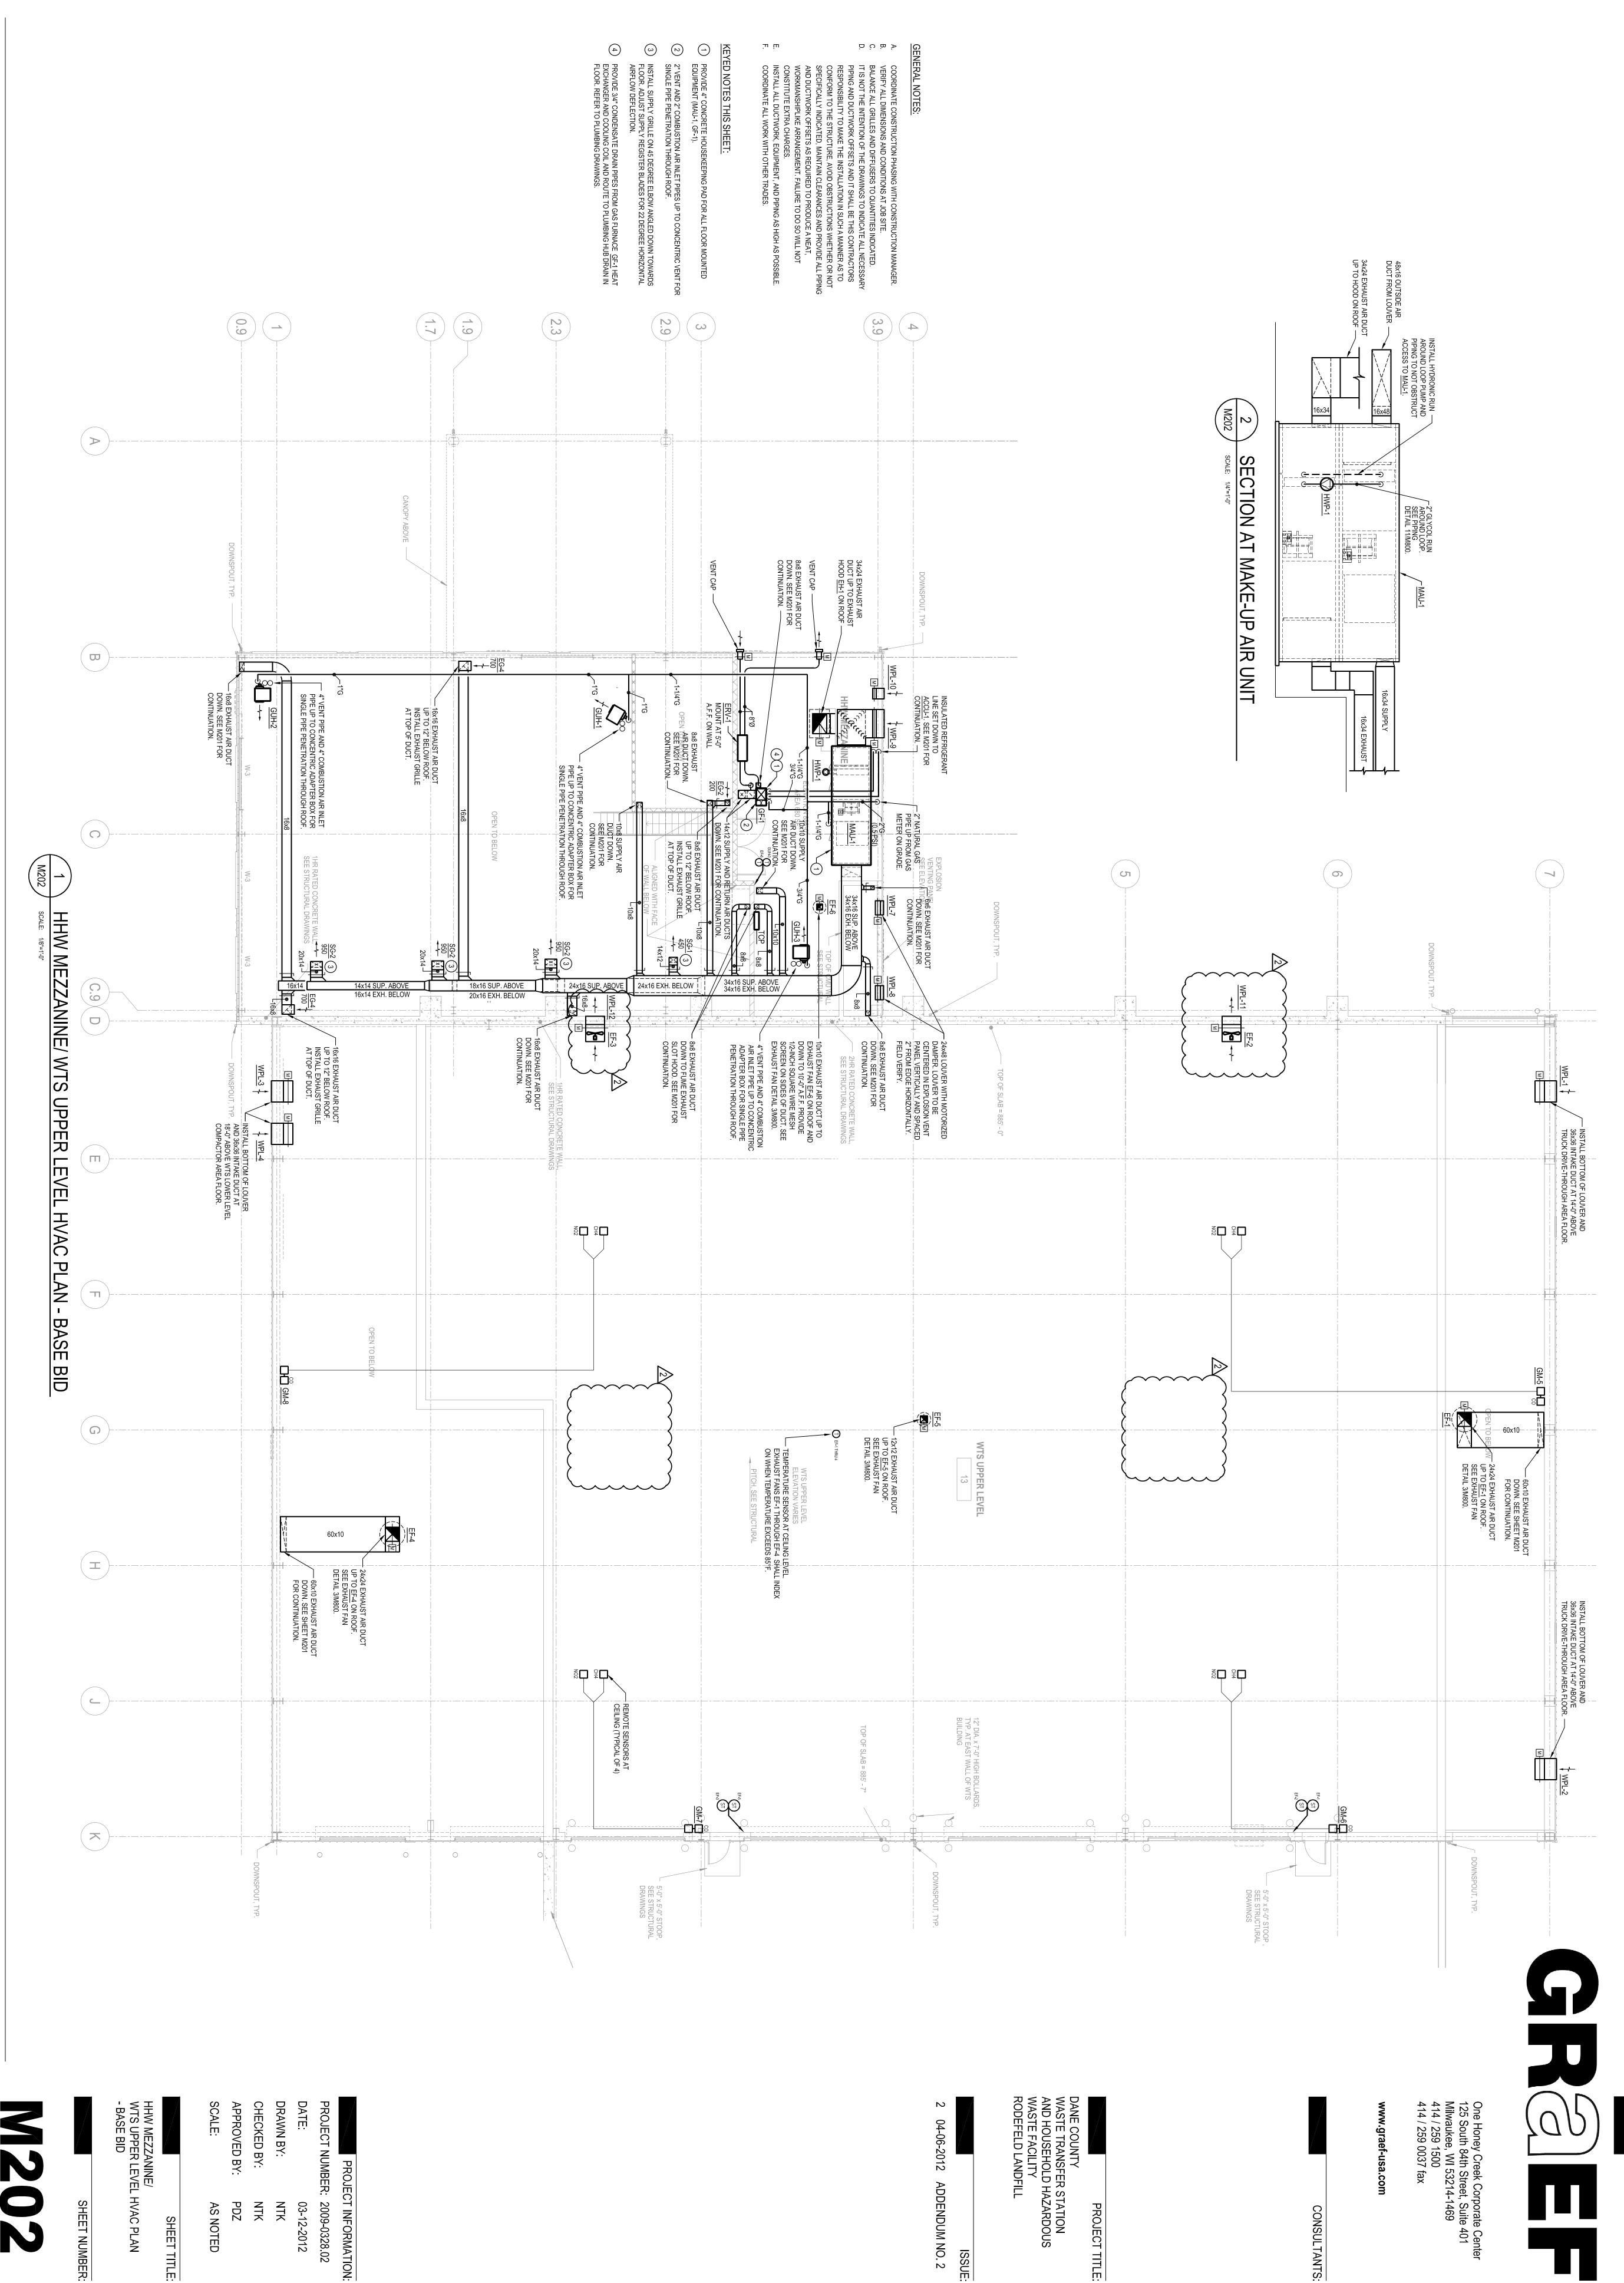

PROJECT TITLE:

CONSULTANTS:

AS NOTED

SHEET TITLE: