



**EROSION CONTROL NOTES** 

1. CONSTRUCTION SITE EROSION CONTROL AND SEDIMENTATION CONTROL SHALL COMPLY WITH THE REQUIREMENTS OF DANE COUNTY, CITY OF MADISON, AND THE WISCONSIN DEPARTMENT OF NATURAL RESOURCES (WDNR) "CONSTRUCTION SITE EROSION AND SEDIMENT CONTROL TECHNICAL STANDARDS".

2. ALL EROSION CONTROL MEASURES SHALL BE ADJUSTED TO MEET FIELD CONDITIONS AT THE TIME OF CONSTRUCTION AND SHALL BE INSTALLED PRIOR TO ANY GRADING OR DISTURBANCE OF EXISTING SURFACE MATERIAL ON SITE.

3. ALL EROSION AND SEDIMENT CONTROL MEASURES WILL BE CHECKED FOR STABILITY AND OPERATION AFTER A RAINFALL OF 0.5 INCHES OR MORE, BUT NO LESS THAN ONCE EVERY WEEK. MAINTENANCE OF ALL EROSION CONTROL STRUCTURES SHALL BE PROVIDED TO INSURE INTENDED PURPOSE IS ACCOMPLISHED. CONTRACTOR SHALL BE RESPONSIBLE FOR CLEANUP AND REMOVAL OF ALL SEDIMENT WHEN LEAVING PROPERTY. EROSION CONTROL MEASURES MUST BE IN WORKING CONDITION AT END OF

4. SILT FENCE SHALL BE INSTALLED IN THE LOCATIONS SHOWN ON THE CONSTRUCTION PLANS. SEDIMENT DEPOSITS WILL BE REMOVED FORM BEHIND THE SILT FENCE WHEN DEPOSITS REACH A DEPTH OF 6 INCHES. THE SILT FENCE WILL BE REPAIRED OR REPLACED AS NECESSARY TO

-5. FILTER FABRIC SHALL BE INSTALLED BENEATH INLET COVERS TO TRAP SEDIMENT AS PER INLET PROTECTION DETAIL IN THE LOCATIONS SHOWN ON THE CONSTRUCTION

6. EROSION CONTROL MEASURES SHALL BE MAINTAINED ON  $\overline{\lang}$ A CONTINUING BASIS UNTIL SITE IS FULLY STABILIZED.

7. PERIODIC STREET SWEEPING WILL BE COMPLETED BY THE OWNER TO MAINTAIN THE PUBLIC STREET FREE OF DUST

FASHION AROUND ALL TOPSOIL AND FILL STOCKPILES. NOTIFY DANE COUNTY OF ANY NEW STOCKPILE LOCATIONS.

-9. CONSTRUCTION SEQUENCE FOR EROSION CONTROL

1. INSTALL STABILIZED CONSTRUCTION ENTRANCE. . INSTALL SILT FENCE AND EROSION BALES 3. REMOVE EXISTING UTILITIES NOTED FOR REMOVAL.

4. STRIP TOPSOIL AND STOCK PILE. 5. PERFORM ROUGH GRADING.

6. INSTALL UTILITIES. 7. INSTALL INLET PROTECTION ON PROPOSED UTILITIES.

8. INSTALL PAVEMENT, SITE WALLS, AND BUILDINGS. 9. INSTALL LANDSCAPING ON COMPLETED SITE WITHIN 7 DAYS OF COMPLETING CONSTRUCTION. 10. REMOVE EROSION CONTROL MEASURES ONLY WHEN

10. SITE DEWATERING. WATER PUMPED FROM THE SITE SHALL BE TREATED BY SEDIMENT BASINS OR OTHER APPROPRIATE BEST MANAGEMENT PRACTICES SPECIFIED BY THE WDNR TECHNICAL STANDARDS. WATER SHALL NOT BE DISCHARGED IN A MANNER THAT CAUSES EROSION OF THE SITE, ADJACENT SITES, OR RECEIVING CHANNELS.

11. WASTE AND MATERIAL DISPOSAL. ALL WASTE AND UNUSED BUILDING MATERIALS (INCLUDING GARBAGE, DEBRIS CLEANING WASTES, WASTEWATER, TOXIC MATERIALS, OR HAZARDOUS MATERIALS) SHALL BE PROPERLY DISPOSED IN ACCORDANCE WITH LANDFILL TIPPING FEE AND RECYCLING REQUIREMENTS AND NOT ALLOWED TO BE CARRIED  $\mathcal{N}$  OFF-SITE BY RUNOFF OR WIND.

 $\{12.\ \mathsf{TRACKING}.\ \mathsf{EACH}\ \mathsf{SITE}\ \mathsf{SHALL}\ \mathsf{HAVE}\ \mathsf{GRAVELED}\ \mathsf{ROADS},$ ACCESS DRIVES AND PARKING AREAS OF SUFFICIENT WIDTH AND LENGTH TO PREVENT SEDIMENT FROM BEING TRACKED <sup>™</sup>ONTO PUBLIC OR PRIVATE ROADWAYS. ANY SEDIMENT 水REACHING A PUBLIC OR PRIVATE ROAD SHALL BE REMOVED BY STREET CLEANING, TO THE SATISFACTION OF THE  $ot\hspace{-1pt}
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olimits_{\mathcal{A}}$  COUNTY BEFORE THE END OF EACH WORKDAY. FLUSHING MAY NOT BE USED UNLESS SEDIMENT WILL BE CONTROLLED BY A SEDIMENT BASIN OR OTHER APPROPRIATE BEST STANDARDS. NOTIFY DANE COUNTY FOR CHANGES IN

13. SEDIMENT CLEANUP. ALL OFF-SITE SEDIMENT DEPOSITS NOCCURRING AS A RESULT OF A STORM EVENT SHALL BE CLEANED UP BY THE END OF THE NEXT WORK DAY. ALL OTHER OFF-SITE SEDIMENT DEPOSITS OCCURRING AS A RESULT OF CONSTRUCTION ACTIVITIES SHALL BE CLEANED

14. ALL DISTURBED GROUND LEFT INACTIVE FOR SEVEN OR MORE DAYS SHALL BE STABILIZED BY TEMPORARY OR PERMANENT SEEDING, TEMPORARY OR PERMANENT SEEDING AND MULCHING, SODDING, COVERING WITH TARPS, OR EQUIVALENT BEST MANAGEMENT PRACTICES. IF TEMPORARY SEEDING IS USED, A PERMANENT COVER SHALL ALSO BE REQUIRED AS PART OF THE FINAL SITE STABILIZATION. SEEDING OR SODDING SHALL BE REQUIRED AS PART OF THE FINAL SITE STABILIZATION.

15. SOIL OR DIRT STORAGE PILES SHALL BE LOCATED A MINIMUM OF 30 FEET FROM ANY DOWNSLOPE ROAD, LAKE STREAM, WETLAND, OR DRAINAGE CHANNEL. STRAW BALE OR FILTER FABRIC FENCES SHALL BE PLACED ON THE DOWN SLOPE SIDE OF THE PILES. IF REMAINING FOR MORE THAN THIRTY DAYS, PILES SHALL BE STABILIZED BY MULCHING, VEGETATIVE COVER, TARPS OR OTHER MEANS.

16. WHEN THE DISTURBED AREA HAS BEEN STABILIZED BY PERMANENT VEGETATION OR OTHER MEANS. TEMPORARY BEST MANAGEMENT PRACTICES SUCH AS FILTER FABRIC FENCES, STRAW BALES, SEDIMENT AND SEDIMENT TRAPS SHALL BE REMOVED.

COMMENCING ANY LAND DEVELOPMENT OR LAND DISTURBING ACTIVITY.

18. NOTIFY THE COUNTY OF COMPLETION OF ANY BEST MANAGEMENT PRACTICES WITHIN THE NEXT WORKING DAY AFTER THEIR INSTALLATION.

19. OBTAIN PERMISSION IN WRITING FROM DANE COUNTY ENGINEERING DEPARTMENT PRIOR TO MODIFYING THE EROSION CONTROL PLAN.

20. REPAIR ANY SILTATION OR EROSION DAMAGE TO ADJOINING SURFACES AND DRAINAGEWAYS RESULTING FROM LAND DEVELOPMENT OR LAND DISTURBING ACTIVITIES.

21. KEEP A COPY OF THE EROSION CONTROL PLAN ON

One Honey Creek Corporate Center 125 South 84th Street, Suite 401 Milwaukee, WI 53214-1469 414 / 259 1500 414 / 259 0037 fax

www.graef-usa.com

CONSULTANTS:

PROJECT TITLE:

DANE COUNTY WASTE TRANSFER STATION AND HOUSEHOLD HAZARDOUS WASTE FACILITY RODEFELD LANDFILL

ISSUE:

1 04-03-2012 ADDENDUM NO. 1

PROJECT INFORMATION:

PROJECT NUMBER: 2009-0328.02 03-12-2012

DRAWN BY:

CHECKED BY: APPROVED BY:


C\_00\_C200\_DEMO\_EC0328 FILE PATH:

SHEET TITLE:

DEMOLITION AND EROSION CONTROL PLAN



**C200** 

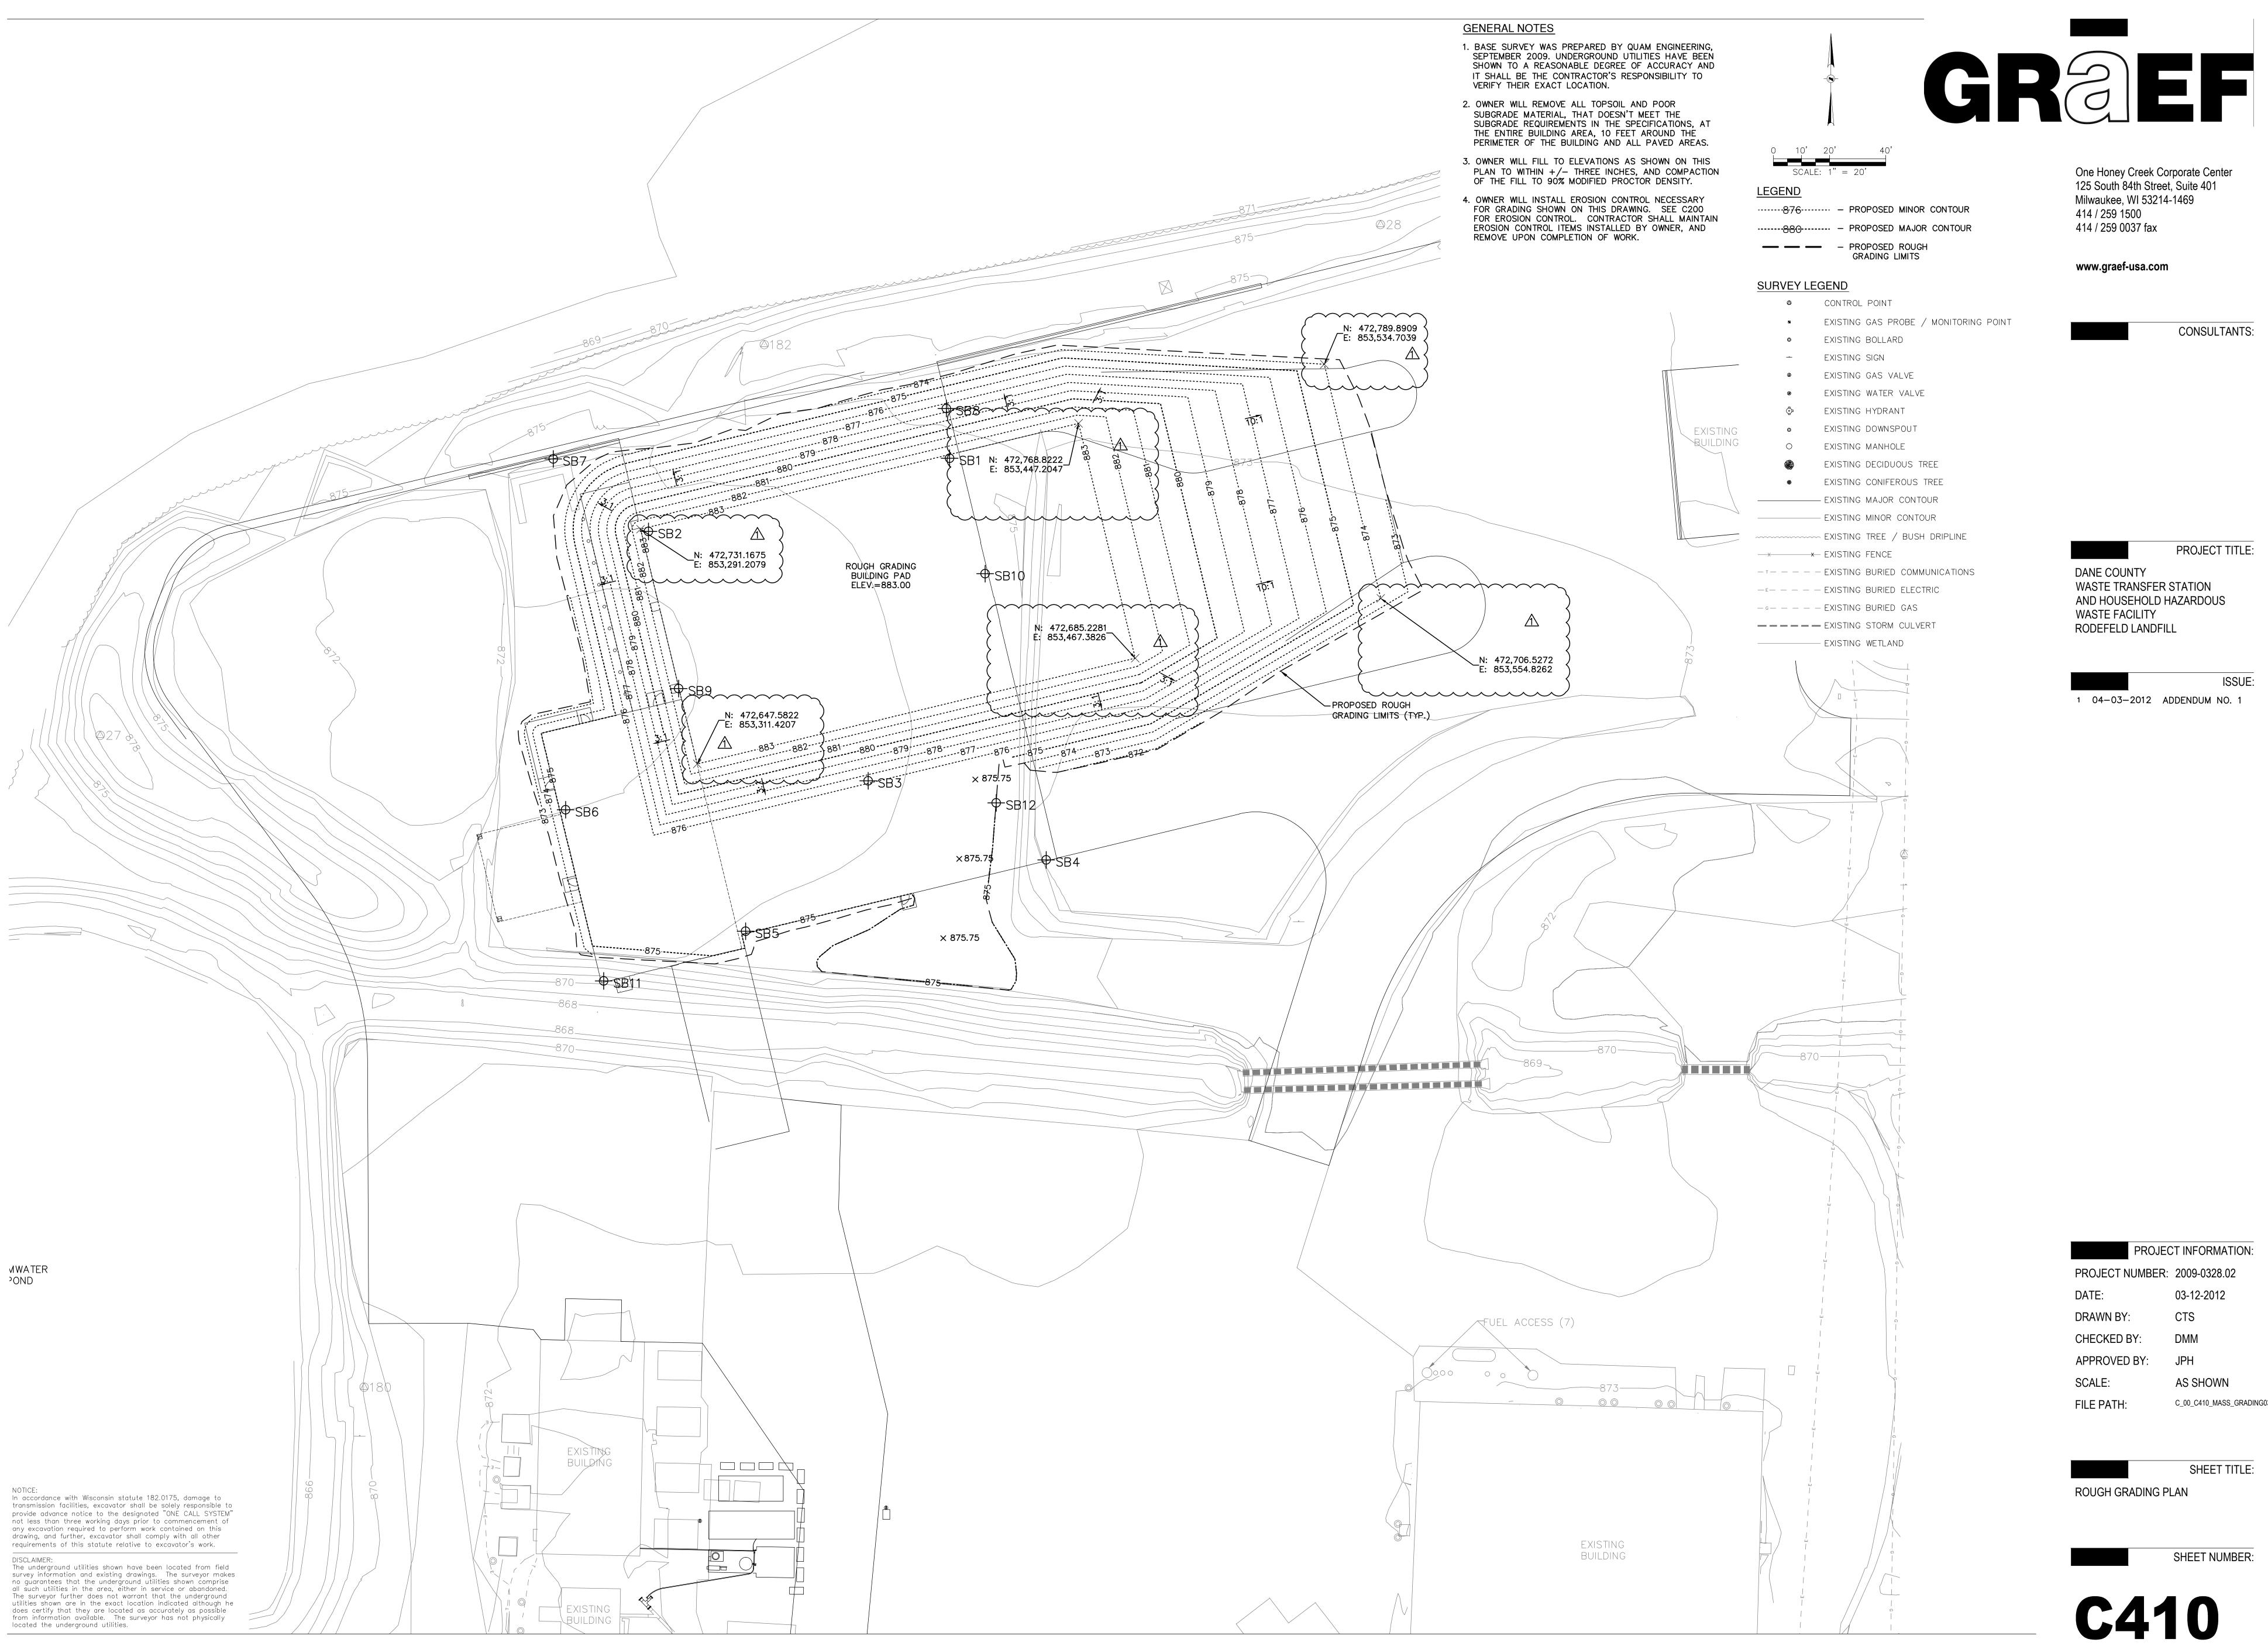

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CONSULTANTS:

PROJECT TITLE:

DANE COUNTY WASTE TRANSFER STATION AND HOUSEHOLD HAZARDOUS WASTE FACILITY RODEFELD LANDFILL

ISSUE: 1 04-03-2012 ADDENDUM NO. 1

PROJECT INFORMATION:

C\_00\_C410\_MASS\_GRADING0328

PROJECT NUMBER: 2009-0328.02

DATE: 03-12-2012


CHECKED BY:

APPROVED BY:


SCALE:

SHEET TITLE:

ROUGH GRADING PLAN

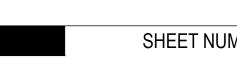

C410

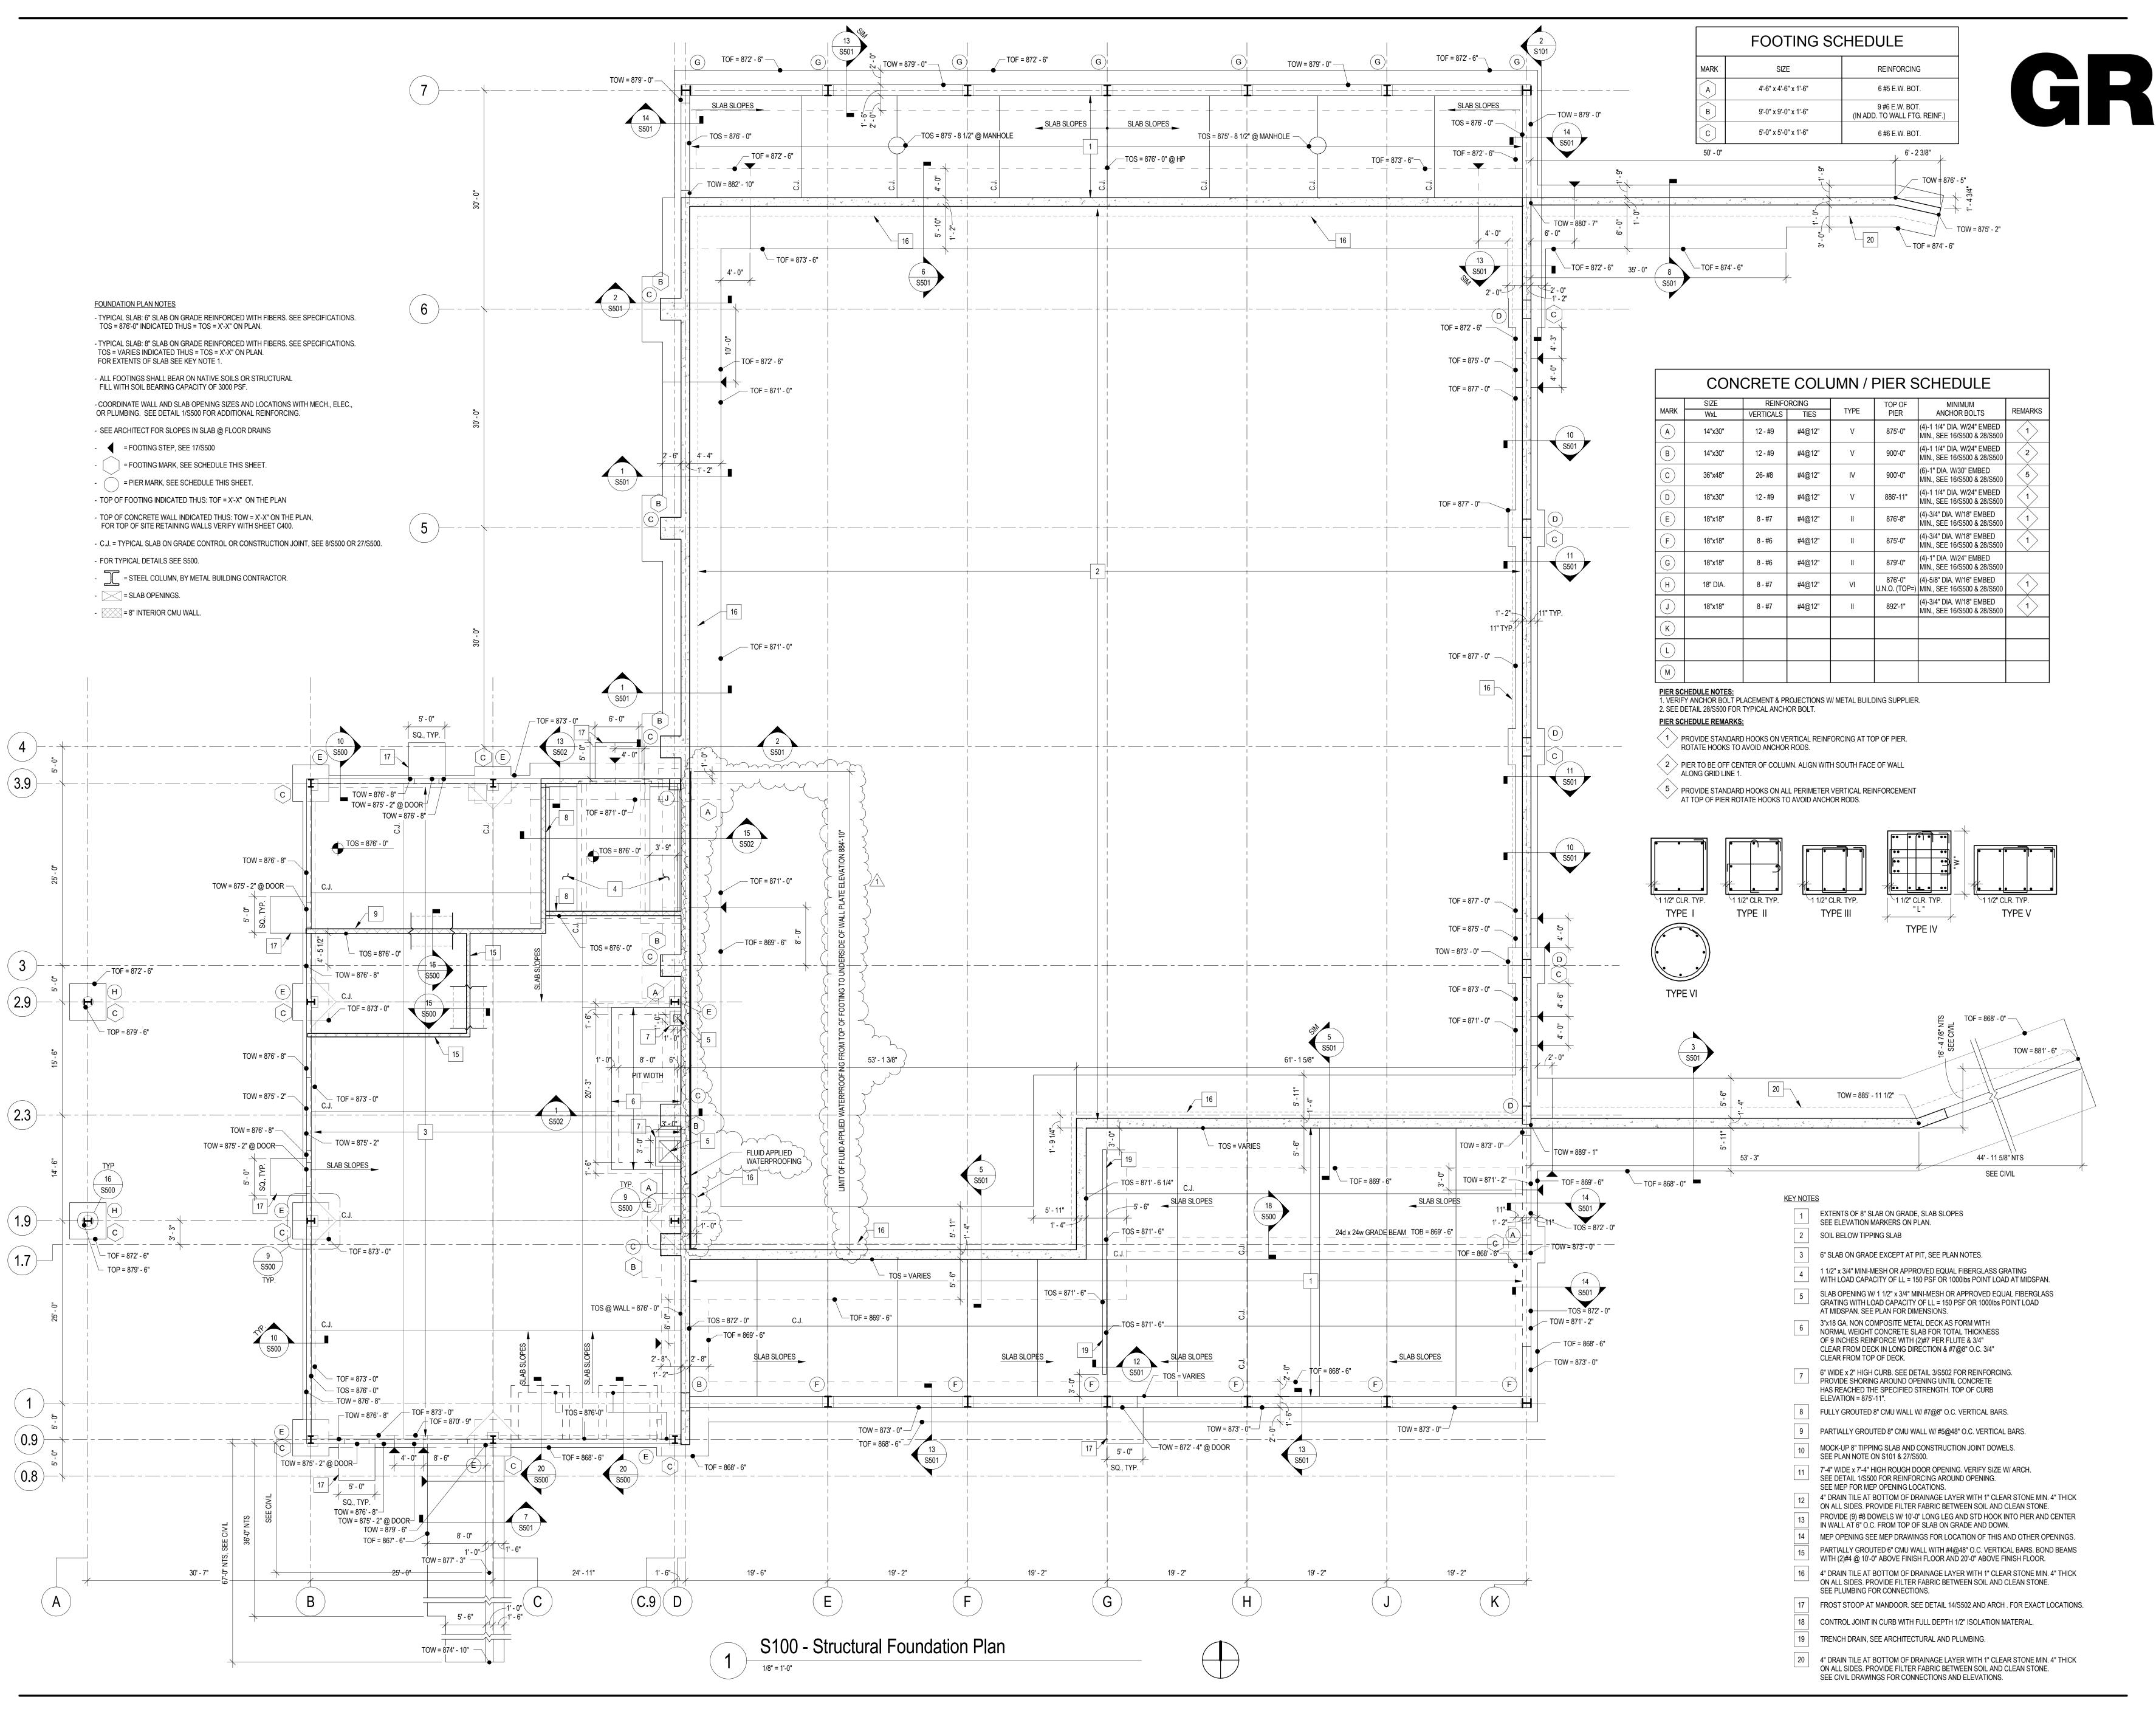

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CONSULTANTS:

PROJECT TITLE:

DANE COUNTY
WASTE TRANSFER STATION
AND HOUSEHOLD HAZARDOUS
WASTE FACILITY
RODEFELD LANDFILL

1000L

1 04-03-2012 ADDENDUM No. 1

PROJECT INFORMATION:

PROJECT NUMBER: 2009-0328.02

DATE: 03-12-2012

DRAWN BY: JRW
CHECKED BY: JWH

APPROVED BY: DFW


SCALE: AS NOTED

CALE: AS NOTED

SHEET TITLE: FOUNDATION PLAN

SHEET NUMBER:

**S100** 

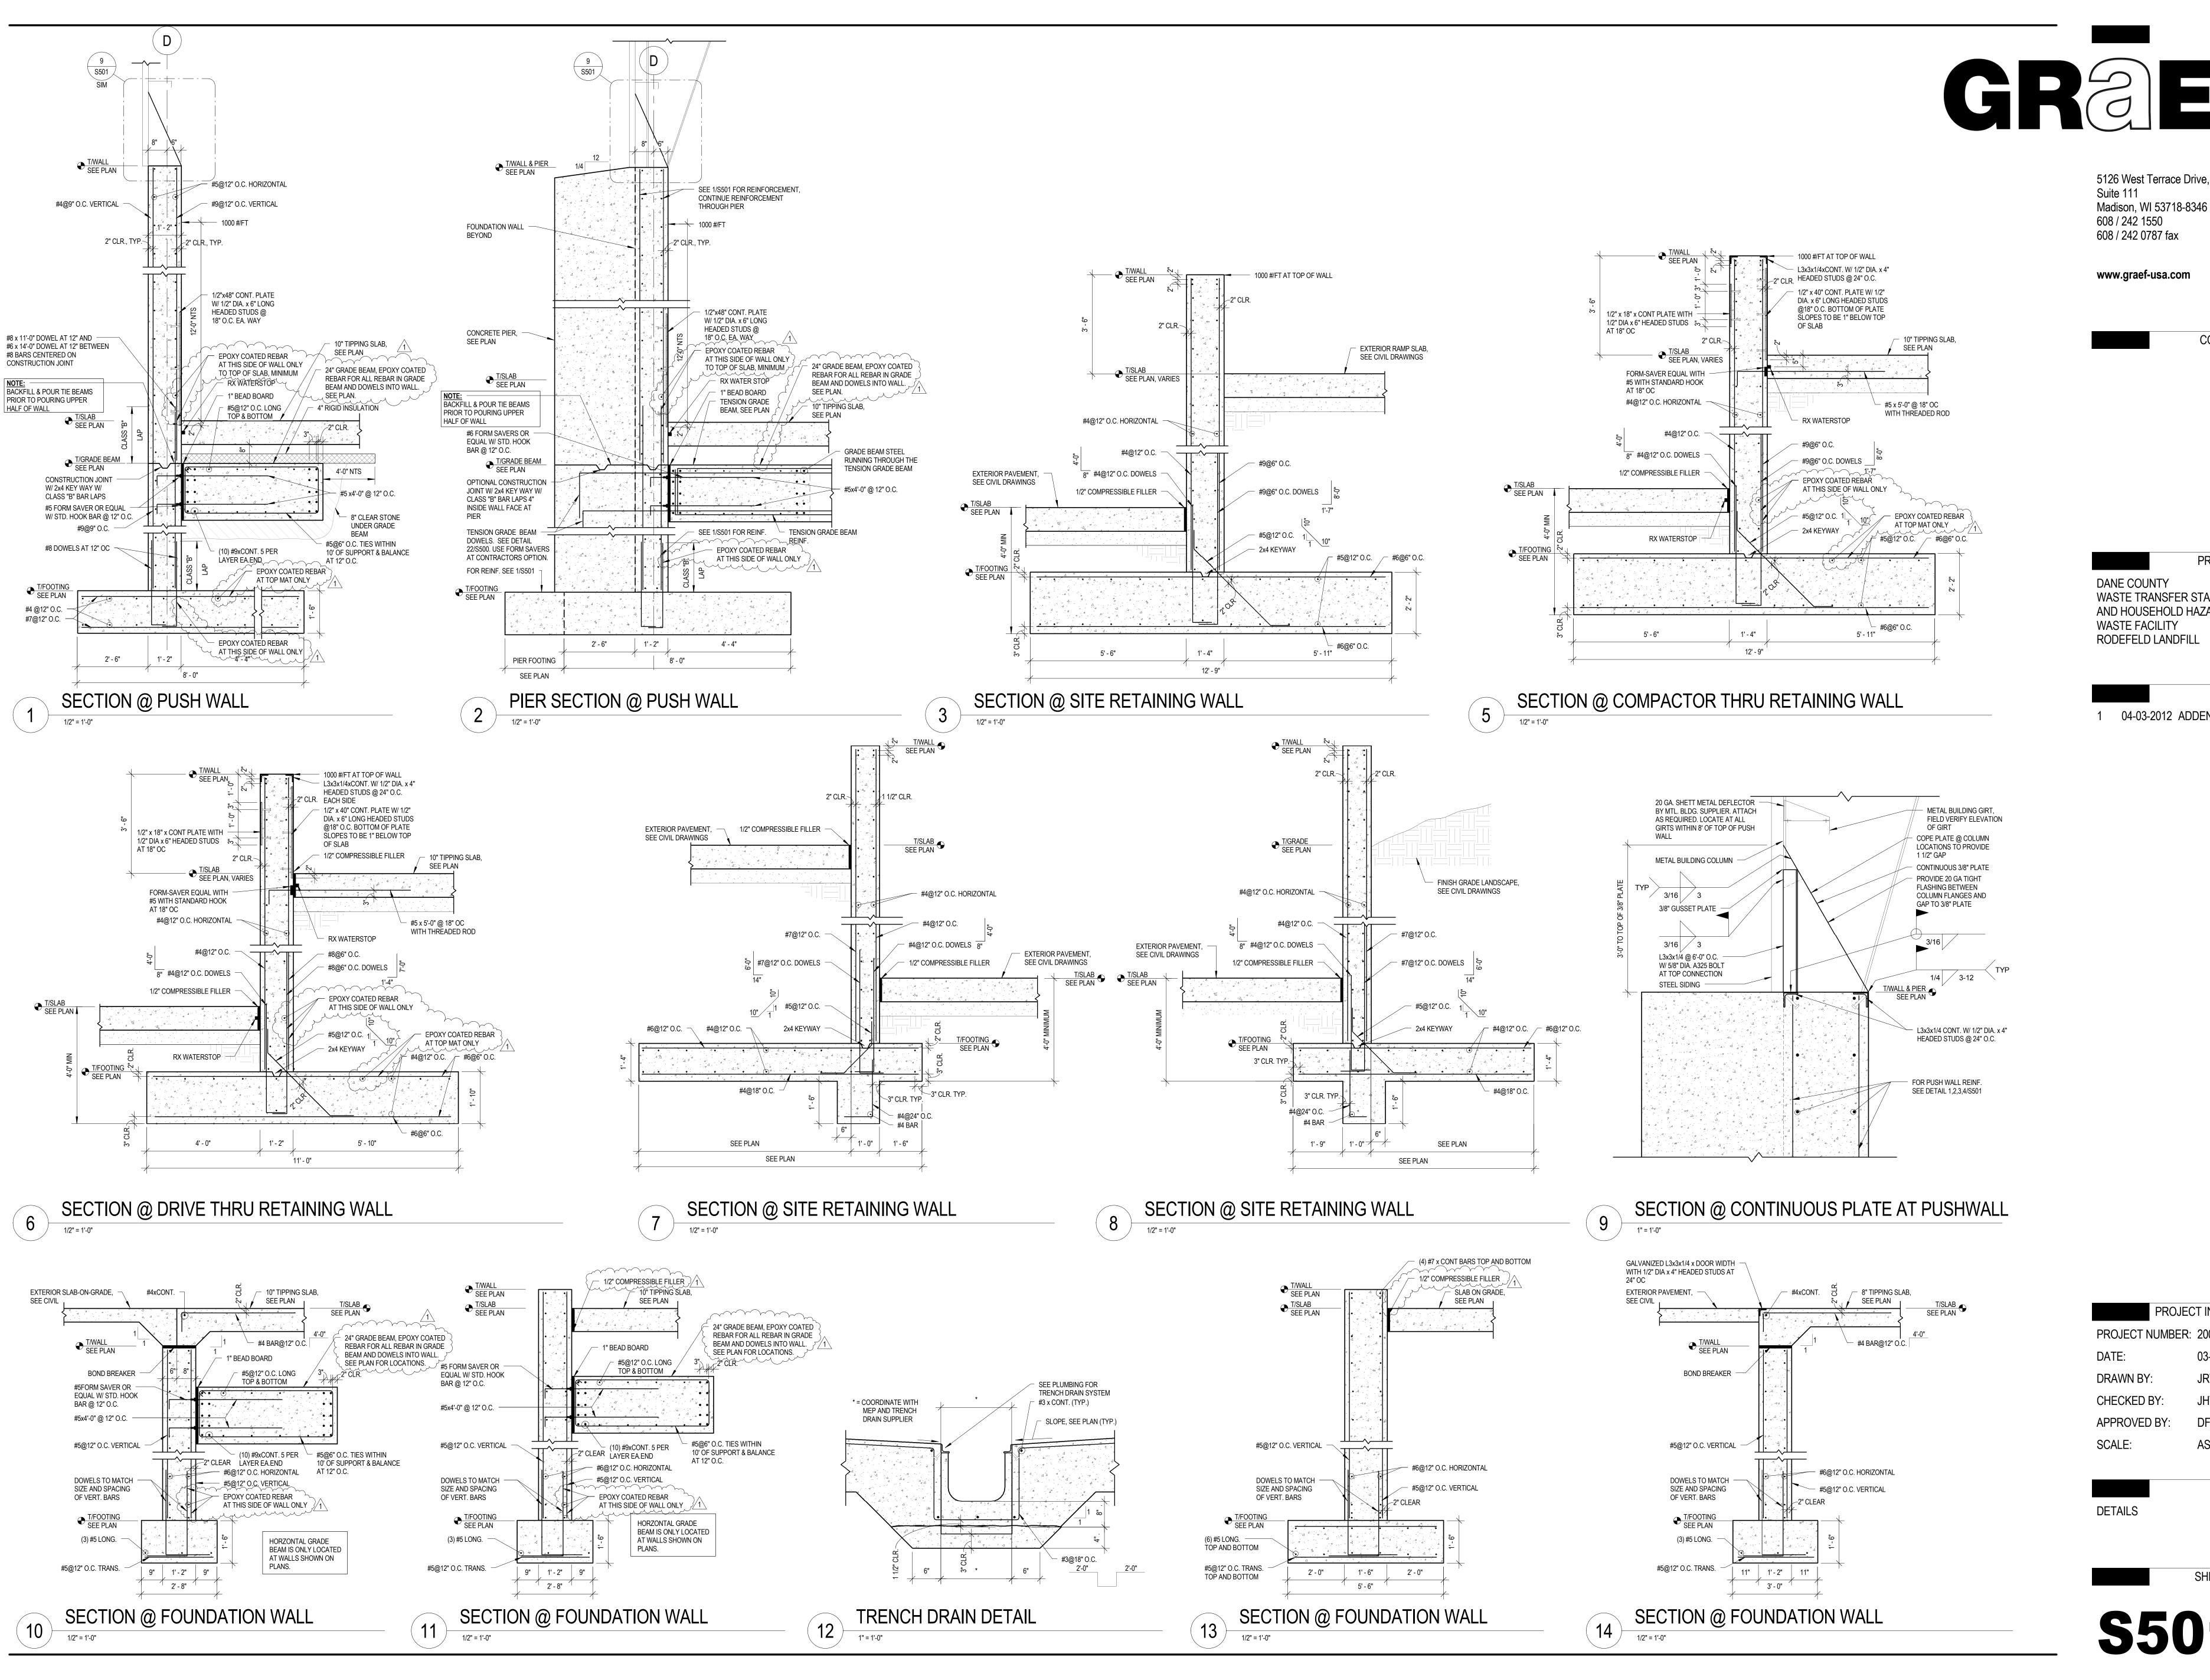

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Madison, WI 53718-8346

CONSULTANTS:

PROJECT TITLE:

DANE COUNTY WASTE TRANSFER STATION AND HOUSEHOLD HAZARDOUS WASTE FACILITY RODEFELD LANDFILL

04-03-2012 ADDENDUM No. 1

PROJECT INFORMATION:


PROJECT NUMBER: 2009-0328.02 DATE: 03-12-2012

DRAWN BY: CHECKED BY:

APPROVED BY: DFW SCALE: AS NOTED

SHEET TITLE: **DETAILS** 

SHEET NUMBER:

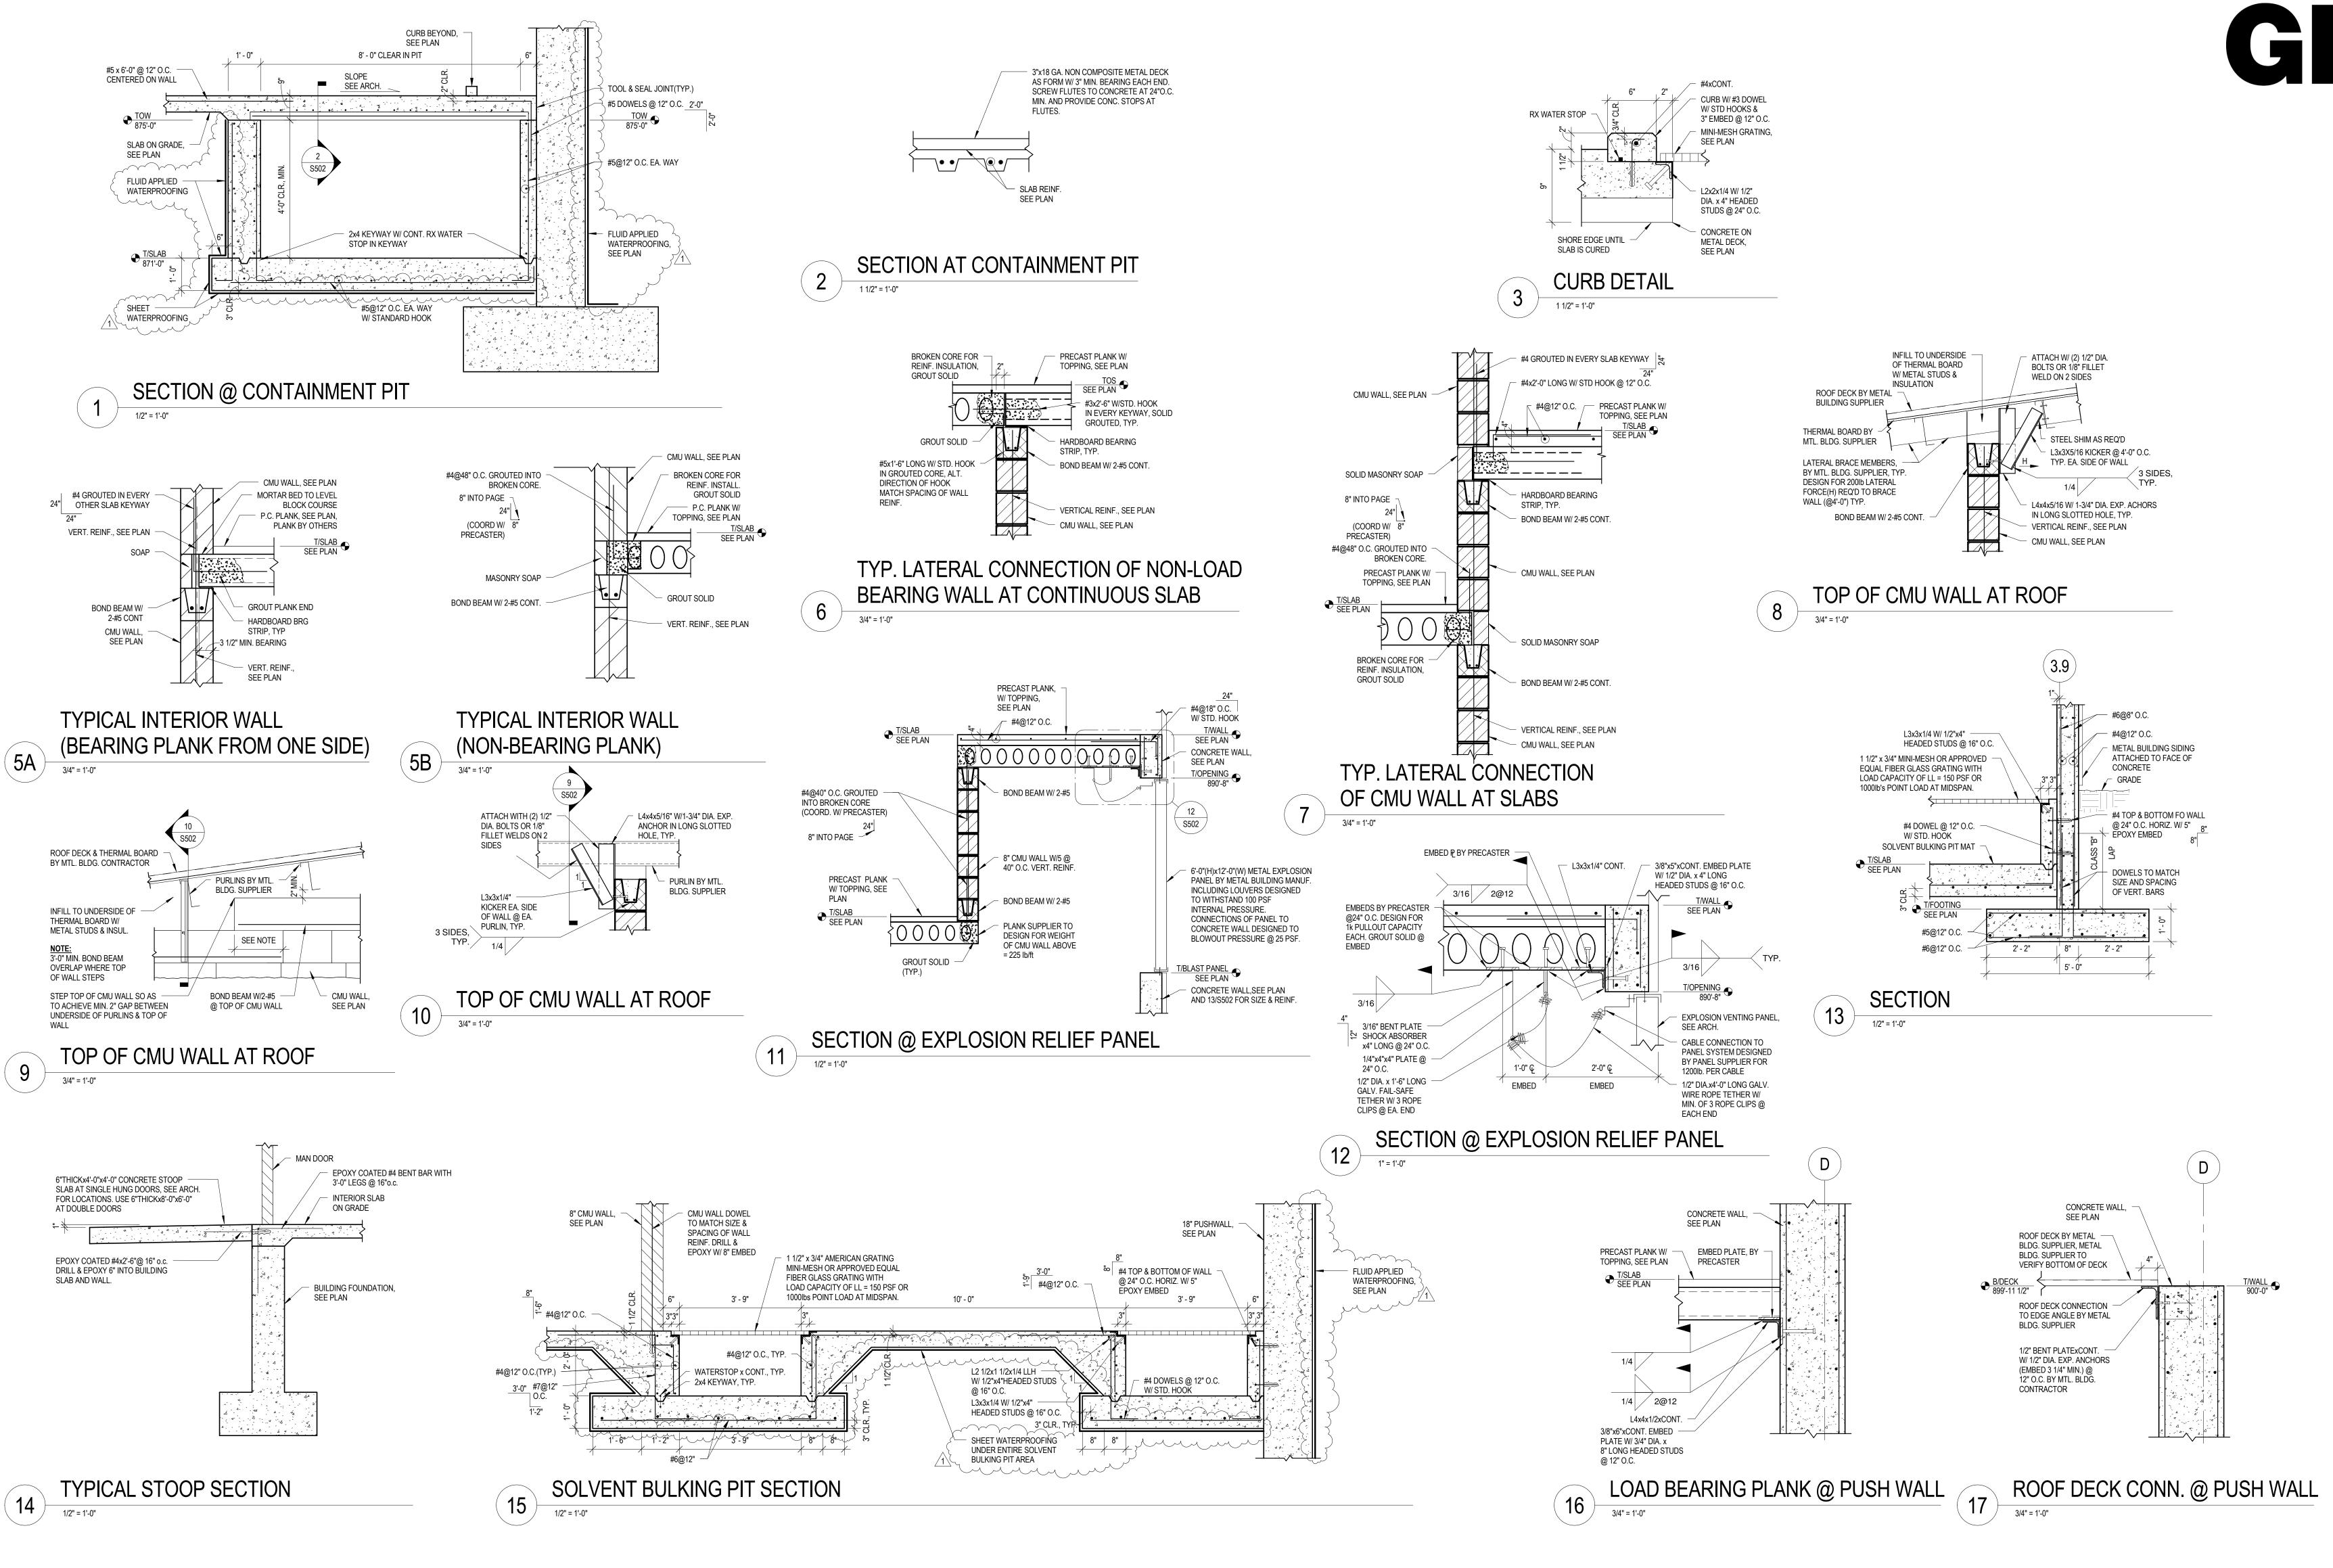

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CONSULTANTS:

PROJECT TITLE:

DANE COUNTY WASTE TRANSFER STATION AND HOUSEHOLD HAZARDOUS WASTE FACILITY RODEFELD LANDFILL

04-03-2012 ADDENDUM No. 1

PROJECT INFORMATION: PROJECT NUMBER: 2009-0328.02

DATE: 03-12-2012 CHECKED BY:

SCALE: AS NOTED

SHEET TITLE:

**DETAILS** 

SHEET NUMBER: