


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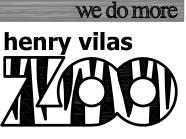
RESTAURANT FLOOR PLAN



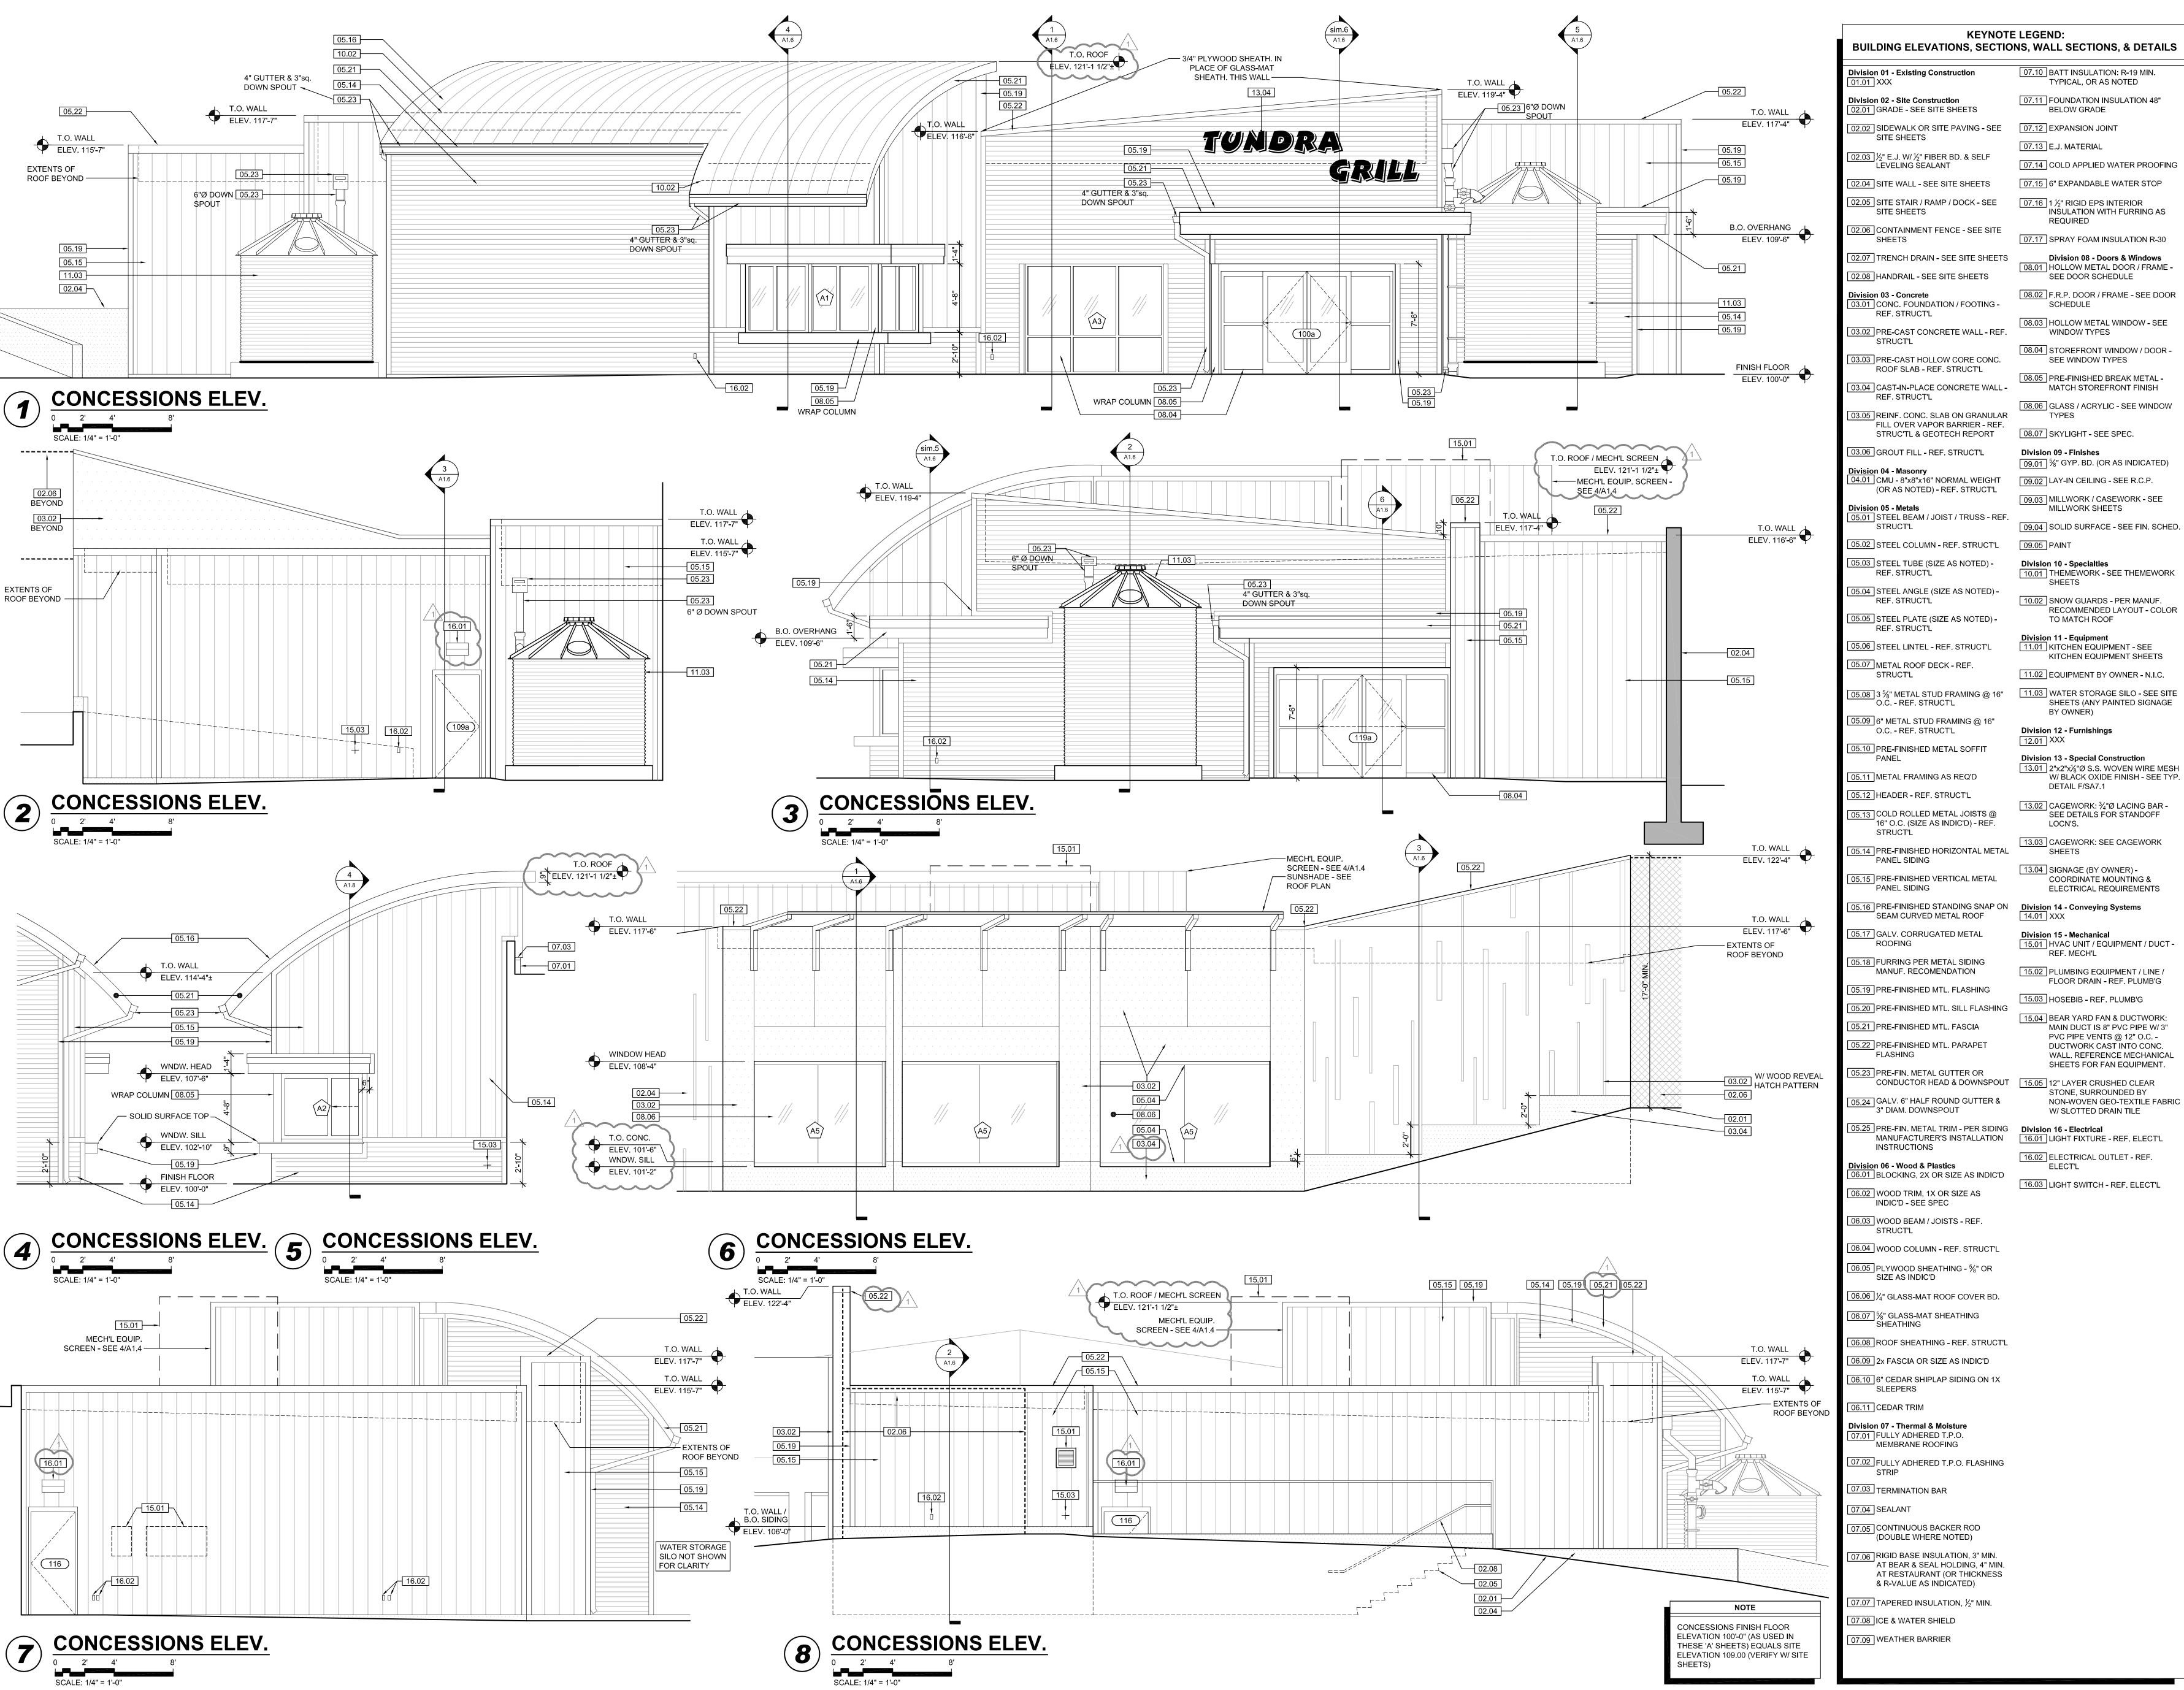

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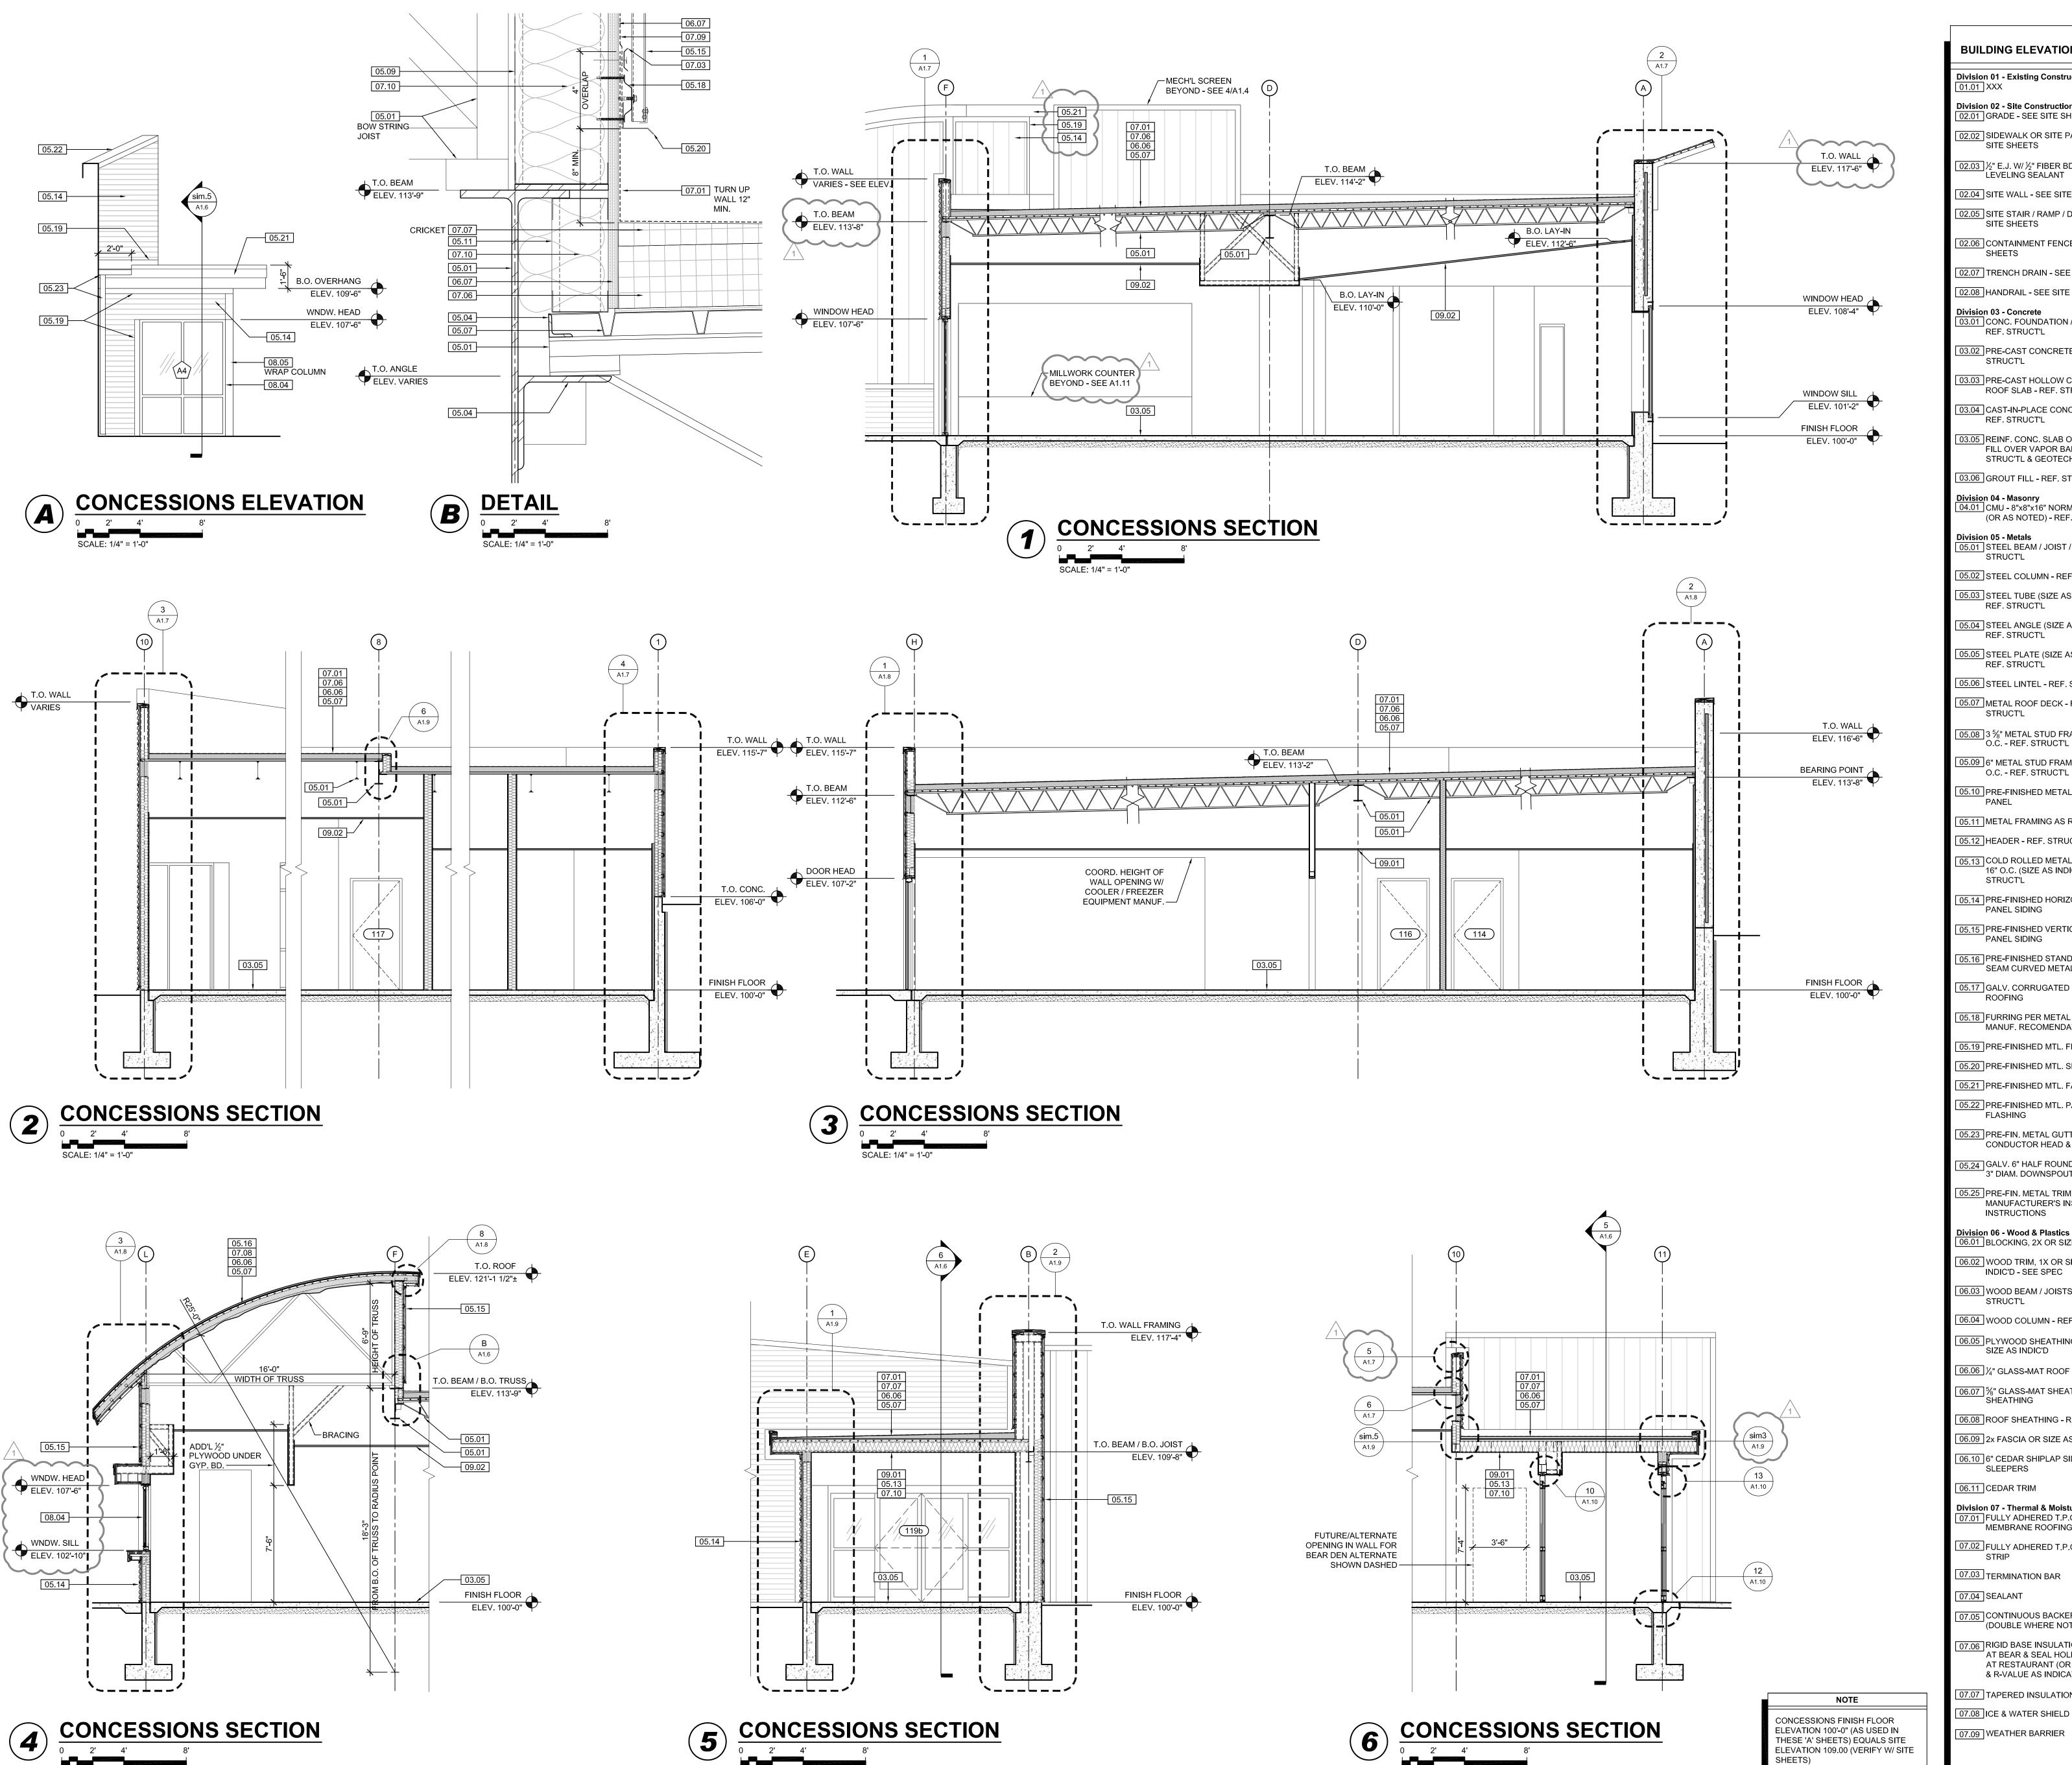
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11.13.2013 - Bid Documents 11.25.2013 - Addendum #3

WDM No. 13046 checked: SR

CONCESSIONS ELEVATIONS



SCALE: 1/4" = 1'-0"

SCALE: 1/4" = 1'-0"

SCALE: 1/4" = 1'-0"

**KEYNOTE LEGEND: BUILDING ELEVATIONS, SECTIONS, WALL SECTIONS, & DETAILS** 07.10 BATT INSULATION: R-19 MIN. **Division 01 - Existing Construction** TYPICAL, OR AS NOTED Division 02 - Site Construction 07.11 FOUNDATION INSULATION 48" 02.01 GRADE - SEE SITE SHEETS BELOW GRADE 02.02 SIDEWALK OR SITE PAVING - SEE 07.12 EXPANSION JOINT SITE SHEETS 07.13 E.J. MATERIAL 02.03 ½" E.J. W/½" FIBER BD. & SELF 07.14 COLD APPLIED WATER PROOFING LEVELING SEALANT 02.04 SITE WALL - SEE SITE SHEETS 07.15 6" EXPANDABLE WATER STOP 07.16 1½" RIGID EPS INTERIOR INSULATION WITH FURRING AS 02.05 SITE STAIR / RAMP / DOCK - SEE SITE SHEETS REQUIRED 02.06 CONTAINMENT FENCE - SEE SITE 07.17 SPRAY FOAM INSULATION R-30 02.07 TRENCH DRAIN - SEE SITE SHEETS Division 08 - Doors & Windows 08.01 HOLLOW METAL DOOR / FRAME -02.08 HANDRAIL - SEE SITE SHEETS SEE DOOR SCHEDULE 08.02 F.R.P. DOOR / FRAME - SEE DOOR Division 03 - Concrete 3.01 CONC. FOUNDATION / FOOTING -SCHEDULE REF. STRUCT'L 08.03 HOLLOW METAL WINDOW - SEE WINDOW TYPES 03.02 PRE-CAST CONCRETE WALL - REF. STRUCT'L 08.04 STOREFRONT WINDOW / DOOR -03.03 PRE-CAST HOLLOW CORE CONC. SEE WINDOW TYPES ROOF SLAB - REF. STRUCT'L 08.05 PRE-FINISHED BREAK METAL -03.04 CAST-IN-PLACE CONCRETE WALL -MATCH STOREFRONT FINISH REF. STRUCT'L 08.06 GLASS / ACRYLIC - SEE WINDOW 3.05 REINF. CONC. SLAB ON GRANULAR FILL OVER VAPOR BARRIER - REF. 08.07 SKYLIGHT - SEE SPEC. STRUC'TL & GEOTECH REPORT 03.06 GROUT FILL - REF. STRUCT'L Division 09 - Finishes 09.01 %" GYP. BD. (OR AS INDICATED) <u>Divisio</u>n 04 - Masonry 04.01 CMU - 8"x8"x16" NORMAL WEIGHT 09.02 LAY-IN CEILING - SEE R.C.P. (OR AS NOTED) - REF. STRUCT'L 09.03 MILLWORK / CASEWORK - SEE Division 05 - Metals MILLWORK SHEETS 5.01 STEEL BEAM / JOIST / TRUSS - REF. STRUCT'L 09.04 SOLID SURFACE - SEE FIN. SCHED. 05.02 STEEL COLUMN - REF. STRUCT'L 05.03 STEEL TUBE (SIZE AS NOTED) -Division 10 - Specialties 10.01 THEMEWORK - SEE THEMEWORK REF. STRUCT'L SHEETS 05.04 STEEL ANGLE (SIZE AS NOTED) -REF. STRUCT'L 10.02 SNOW GUARDS - PER MANUF. RECOMMENDED LAYOUT - COLOR 05.05 STEEL PLATE (SIZE AS NOTED) -TO MATCH ROOF REF. STRUCT'L <u> Divisio</u>n 11 - Equipment 05.06 STEEL LINTEL - REF. STRUCT'L 11.01 KITCHEN EQUIPMENT - SEE KITCHEN EQUIPMENT SHEETS 05.07 METAL ROOF DECK - REF. 11.02 EQUIPMENT BY OWNER - N.I.C. STRUCT'L BY OWNER) 05.09 6" METAL STUD FRAMING @ 16" O.C. - REF. STRUCT'L Division 12 - Furnishings 12.01 XXX 05.10 PRE-FINISHED METAL SOFFIT Division 13 - Special Construction 13.01 2"x2"x%"Ø S.S. WOVEN WIRE MESH W/ BLACK OXIDE FINISH - SEE TYP. 05.11 METAL FRAMING AS REQ'D DETAIL F/SA7.1 05.12 HEADER - REF. STRUCT'L 13.02 CAGEWORK: ¾"Ø LACING BAR -05.13 COLD ROLLED METAL JOISTS @ SEE DETAILS FOR STANDOFF ี 16" O.C. (SIZE AS INDIC'D) - REF. 13.03 CAGEWORK: SEE CAGEWORK 05.14 PRE-FINISHED HORIZONTAL METAL SHEETS 13.04 SIGNAGE (BY OWNER) -05.15 PRE-FINISHED VERTICAL METAL COORDINATE MOUNTING & PANEL SIDING ELECTRICAL REQUIREMENTS 05.16 PRE-FINISHED STANDING SNAP ON **Division 14 - Conveying Systems** SEAM CURVED METAL ROOF 05.17 GALV. CORRUGATED METAL Division 15 - Mechanical 15.01 HVAC UNIT / EQUIPMENT / DUCT -REF. MECH'L 05.18 FURRING PER METAL SIDING MANUF. RECOMENDATION 15.02 PLUMBING EQUIPMENT / LINE / FLOOR DRAIN - REF. PLUMB'G 05.19 PRE-FINISHED MTL. FLASHING 15.03 HOSEBIB - REF. PLUMB'G 05.20 PRE-FINISHED MTL. SILL FLASHING 15.04 BEAR YARD FAN & DUCTWORK 05.21 PRE-FINISHED MTL. FASCIA MAIN DUCT IS 8" PVC PIPE W/ 3" PVC PIPE VENTS @ 12" O.C. -05.22 PRE-FINISHED MTL. PARAPET DUCTWORK CAST INTO CONC. \_\_\_FLASHING WALL. REFERENCE MECHANICAL SHEETS FOR FAN EQUIPMENT. 05.23 PRE-FIN. METAL GUTTER OR CONDUCTOR HEAD & DOWNSPOUT 15.05 12" LAYER CRUSHED CLEAR STONE, SURROUNDED BY NON-WOVEN GEO-TEXTILE FABRIC 05.24 GALV. 6" HALF ROUND GUTTER & 3" DIAM. DOWNSPOUT W/ SLOTTED DRAIN TILE 05.25 PRE-FIN. METAL TRIM - PER SIDING Division 16 - Electrical 16.01 LIGHT FIXTURE - REF. ELECT'L MANUFACTURER'S INSTALLATION INSTRUCTIONS 16.02 ELECTRICAL OUTLET - REF. Division 06 - Wood & Plastics 06.01 BLOCKING, 2X OR SIZE AS INDIC'D 16.03 LIGHT SWITCH - REF. ELECT'L 06.02 WOOD TRIM, 1X OR SIZE AS INDIC'D - SEE SPEC 06.03 WOOD BEAM / JOISTS - REF. 06.04 WOOD COLUMN - REF. STRUCT'L 06.05 PLYWOOD SHEATHING - \( \frac{1}{2} \)" OR SIZE AS INDIC'D 06.06 1/4" GLASS-MAT ROOF COVER BD. 06.07 %" GLASS-MAT SHEATHING SHEATHING 06.08 ROOF SHEATHING - REF. STRUCT'L 06.09 2x FASCIA OR SIZE AS INDIC'D 06.10 6" CEDAR SHIPLAP SIDING ON 1X SLEEPERS 06.11 CEDAR TRIM Division 07 - Thermal & Moisture <u>7.01</u> FULLY ADHERED T.P.O. MEMBRANE ROOFING 07.02 FULLY ADHERED T.P.O. FLASHING 07.03 TERMINATION BAR 07.04 SEALANT 07.05 CONTINUOUS BACKER ROD (DOUBLE WHERE NOTED) 07.06 RIGID BASE INSULATION, 3" MIN. 「AT BEAR & SEAL HOLDING, 4" MIN

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AT RESTAURANT (OR THICKNESS & R-VALUE AS INDICATED) 07.07 TAPERED INSULATION, ½" MIN.

WDM No. 13046 checked: SR CONCESSIONS SECTIONS

PRINTS ISSUED

09.23.2013 - 65% CD's

10.21.2013 - 95% CD's

10.07.2013 - Pricing Set


11.13.2013 - Bid Documents


11.25.2013 - Addendum #3

07.26.2013 - Schematic Design

08.23.2013 - Design Development

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WDM No. 13046 checked: SR CONCESSIONS WALL SECTIONS
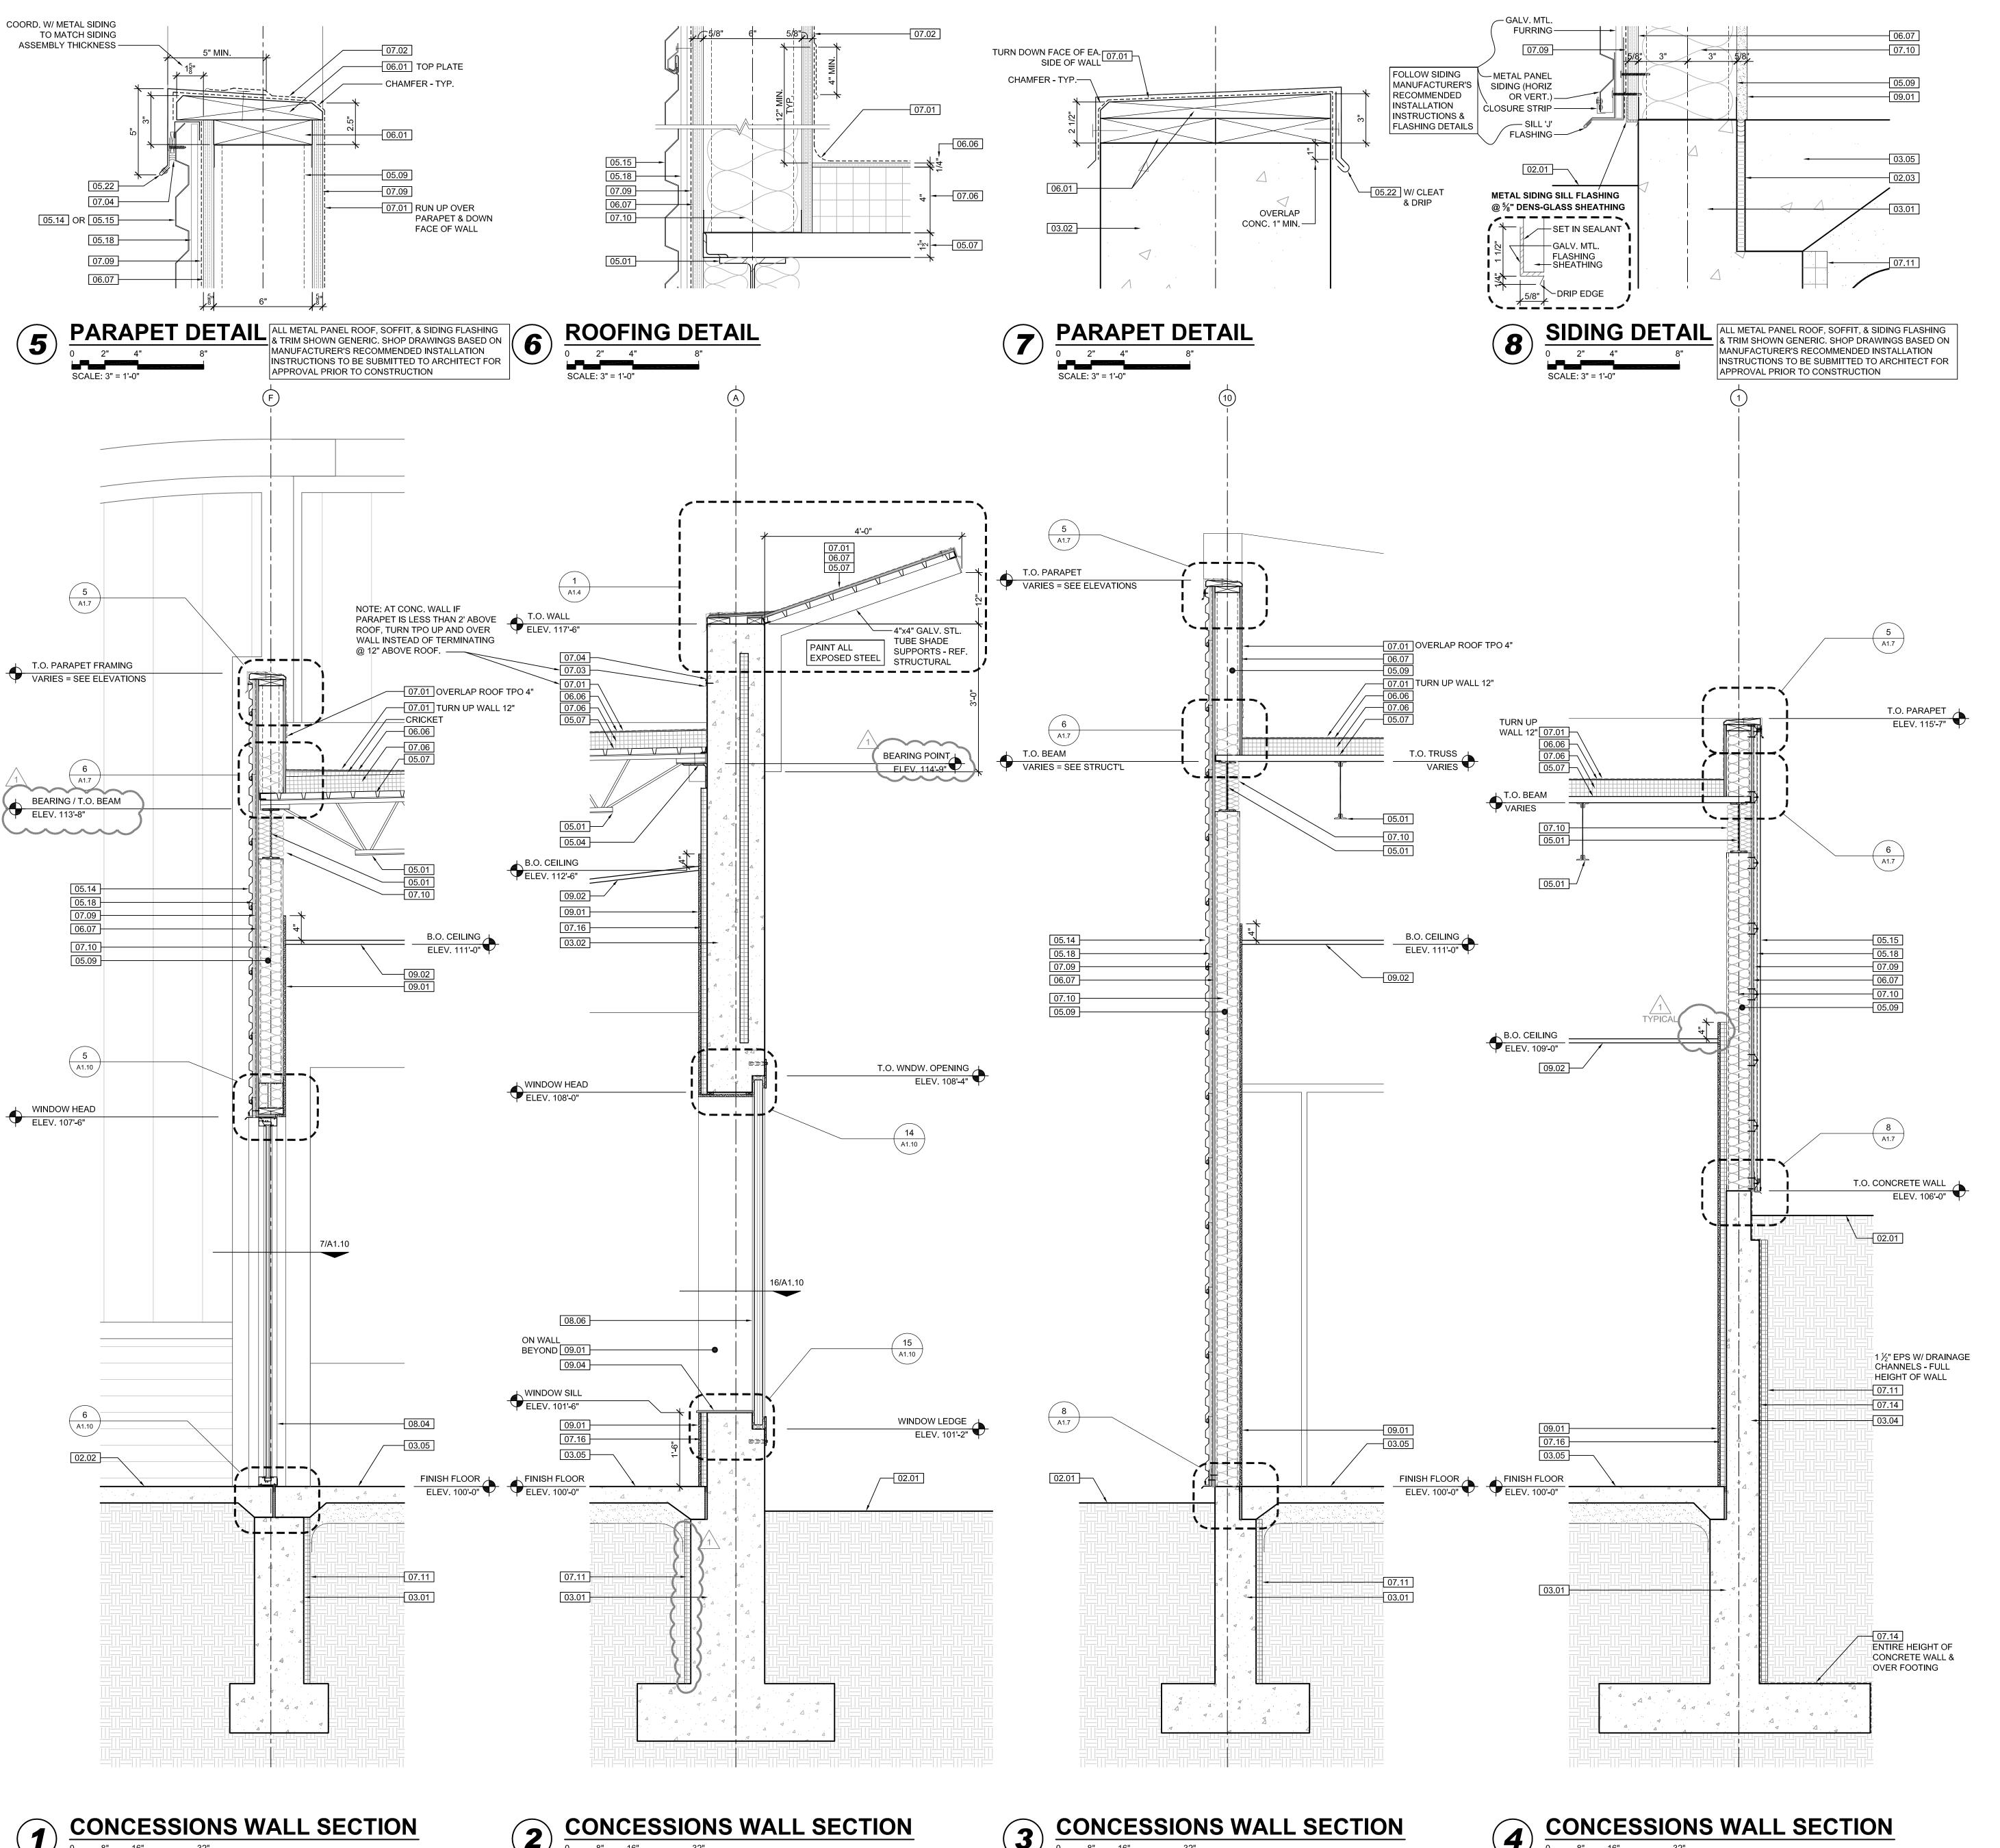
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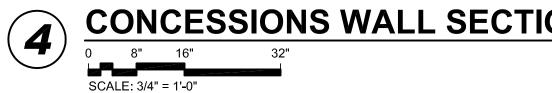
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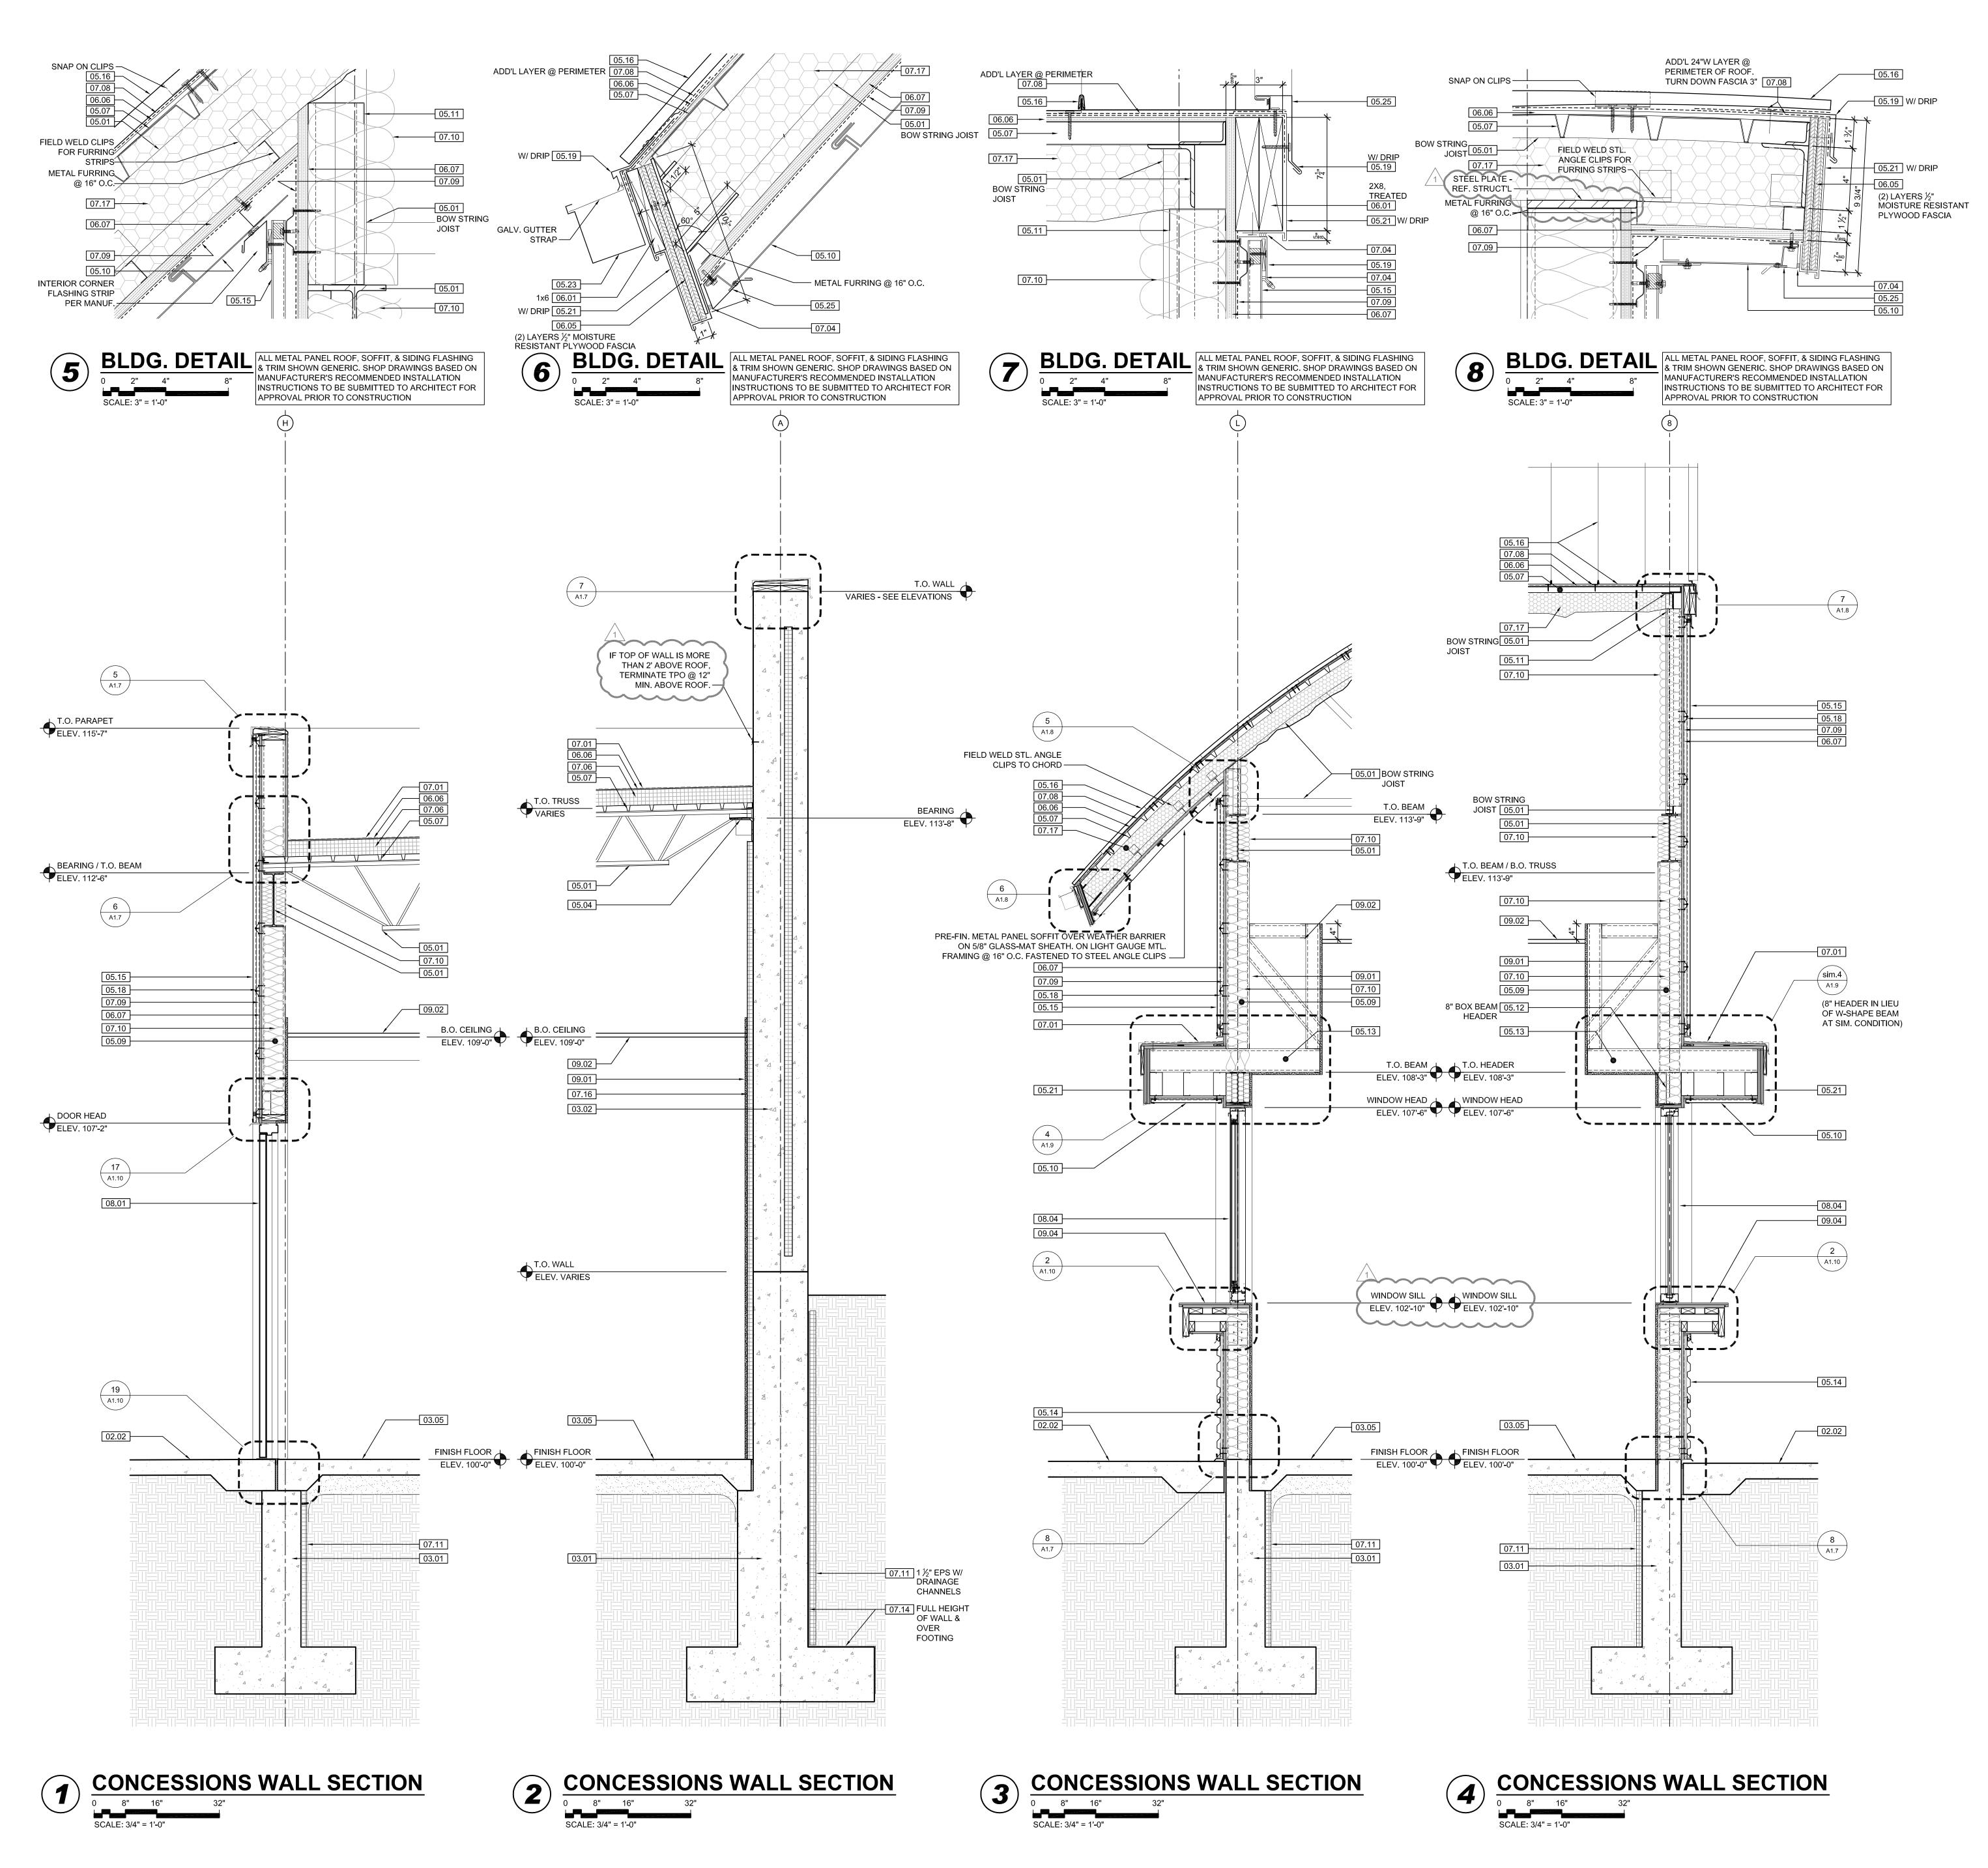
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07.08 ICE & WATER SHIELD

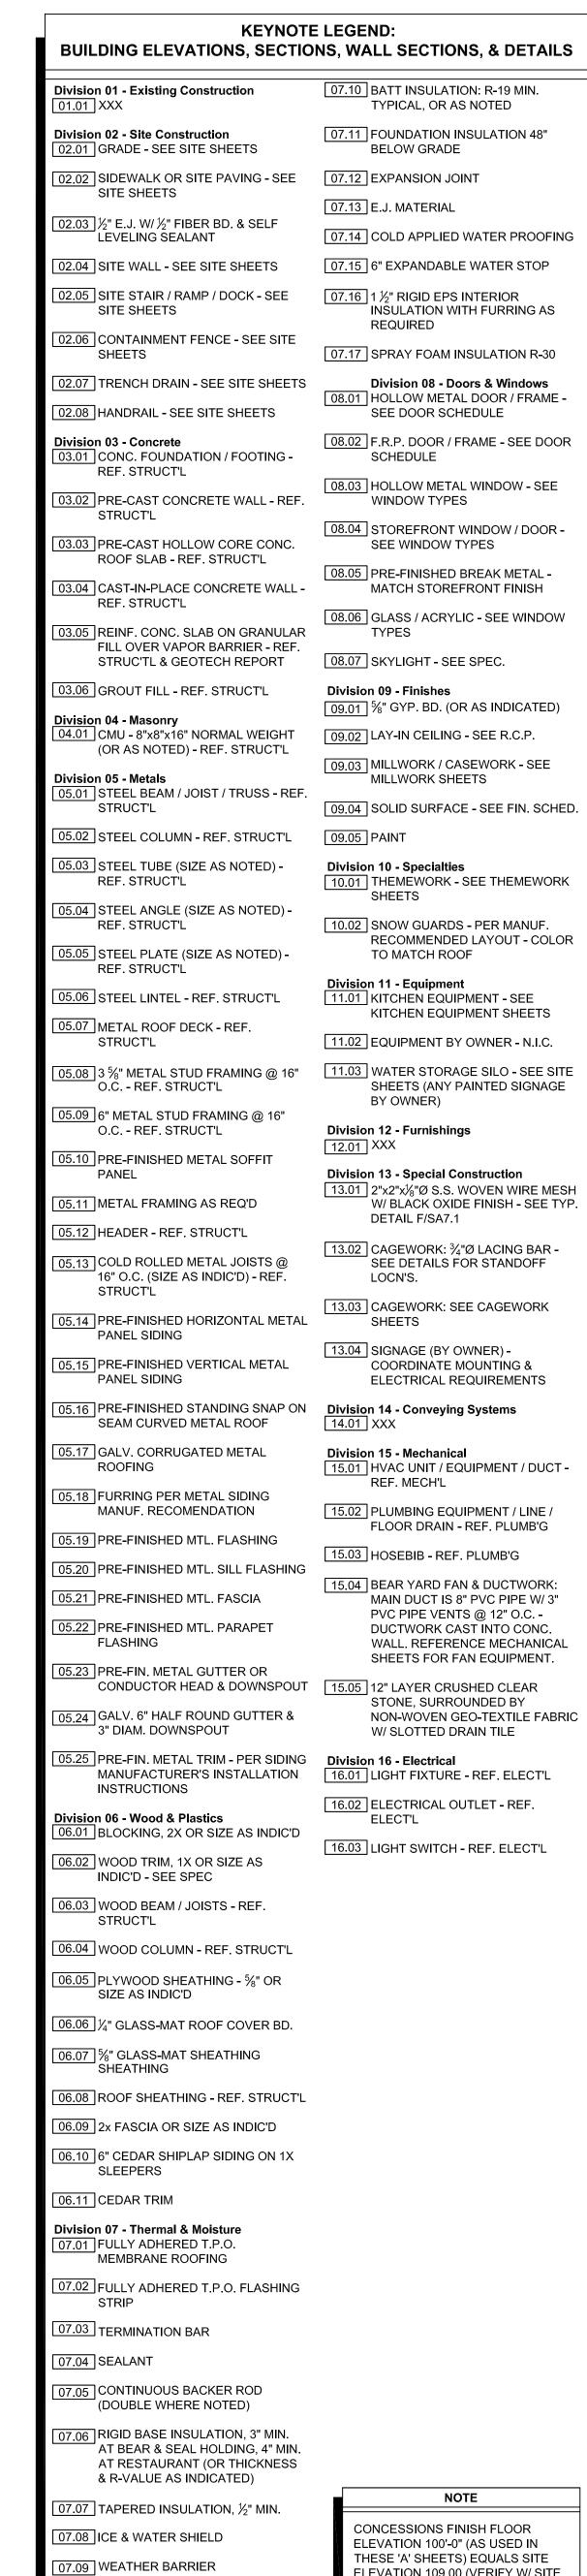07.09 WEATHER BARRIER

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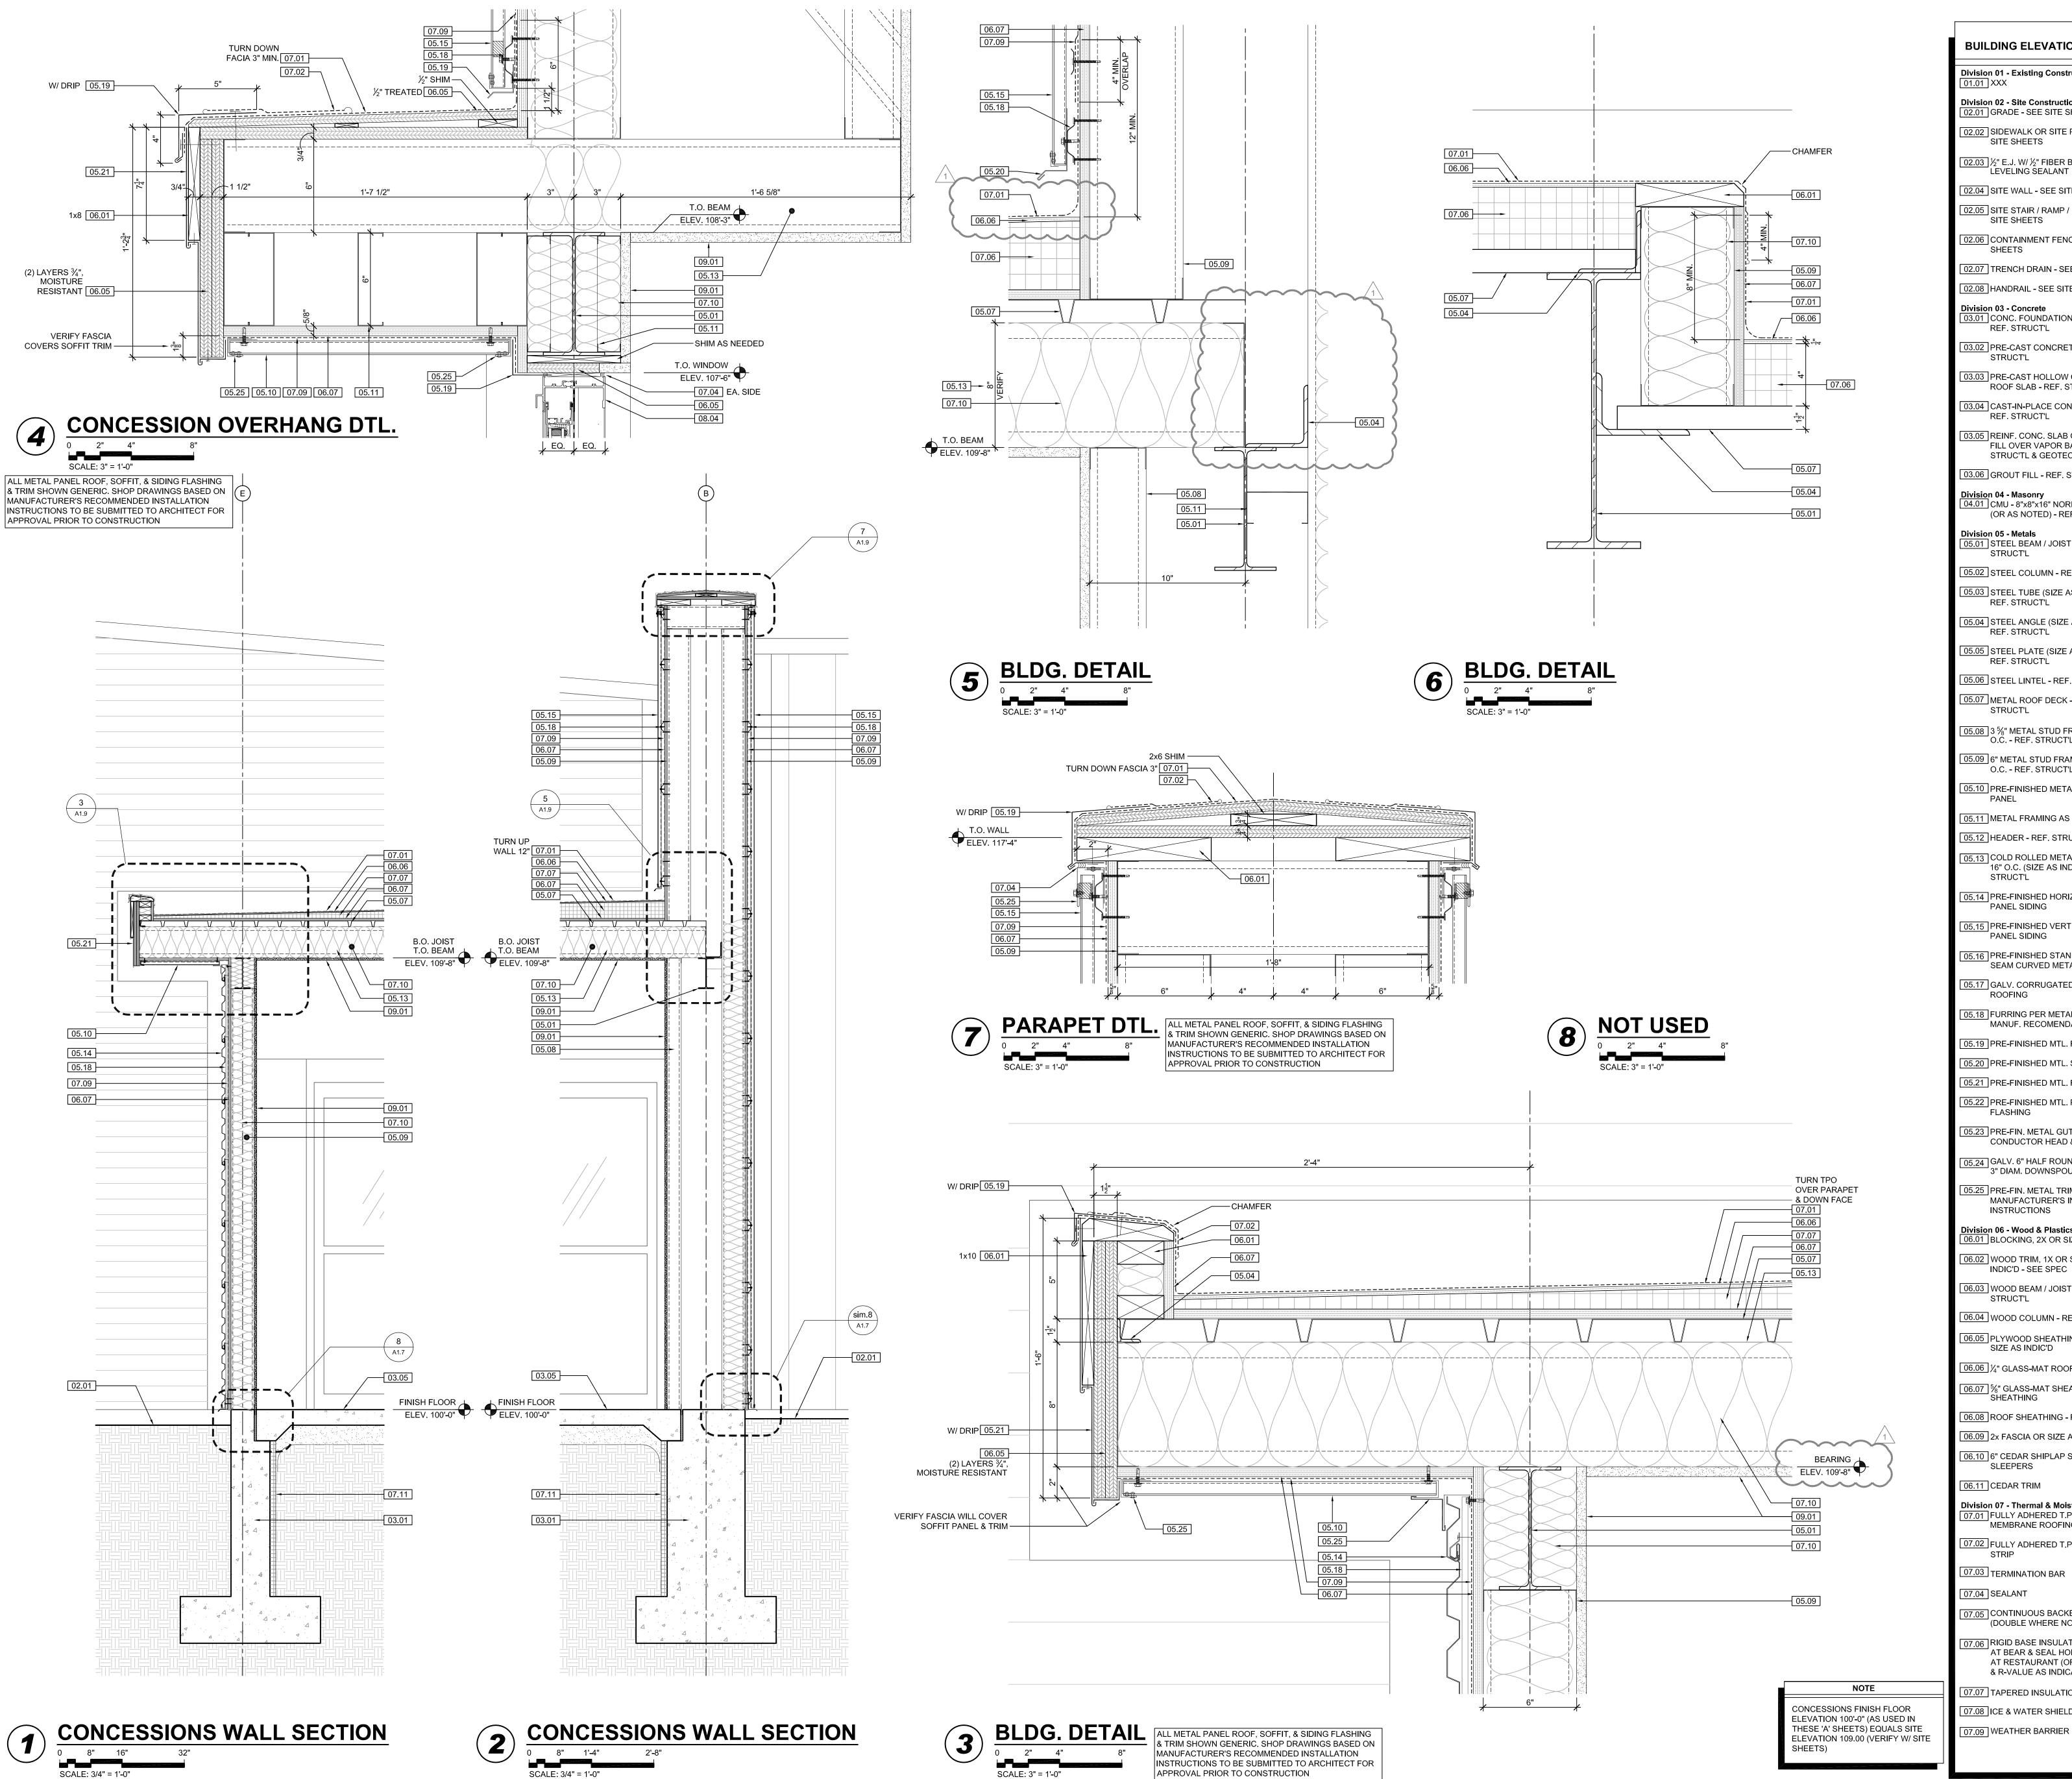
WDM No. 13046 checked: SR CONCESSIONS DETAILS

ELEVATION 109.00 (VERIFY W/ SITE

ELEVATION 100'-0" (AS USED IN

SHEETS)

THESE 'A' SHEETS) EQUALS SITE



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07.05 CONTINUOUS BACKER ROD (DOUBLE WHERE NOTED)

07.06 RIGID BASE INSULATION, 3" MIN. 「AT BEAR & SEAL HOLDING, 4" MIN. AT RESTAURANT (OR THICKNESS & R-VALUE AS INDICATED)

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WDM No. 13046

PRINTS ISSUED

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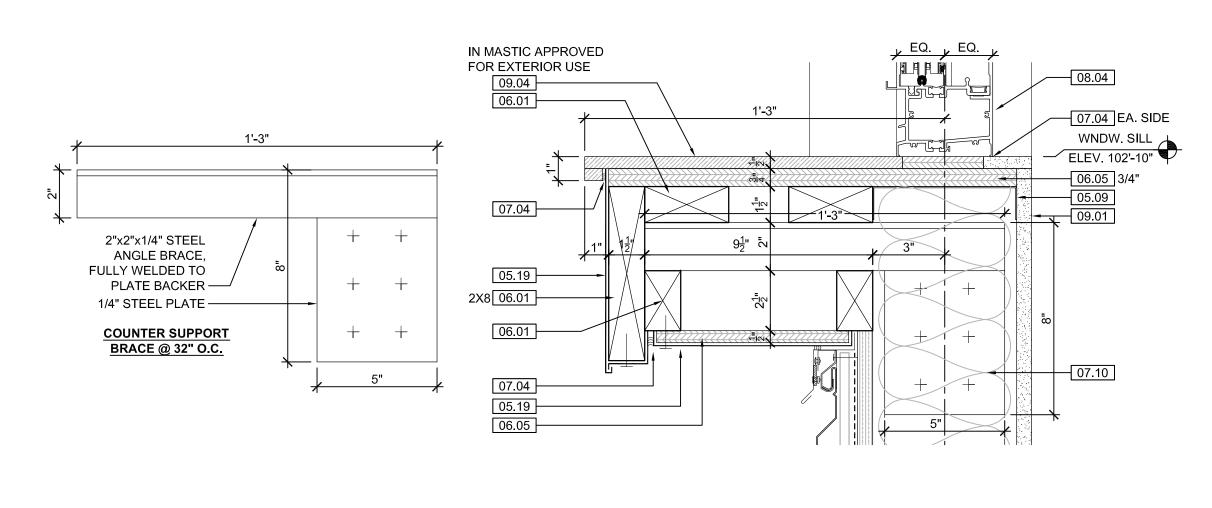
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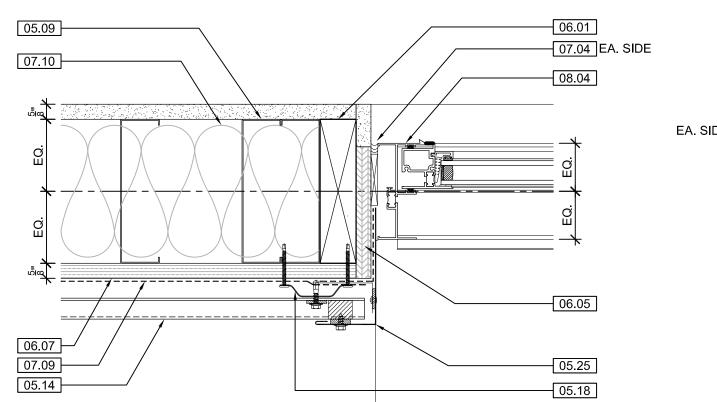
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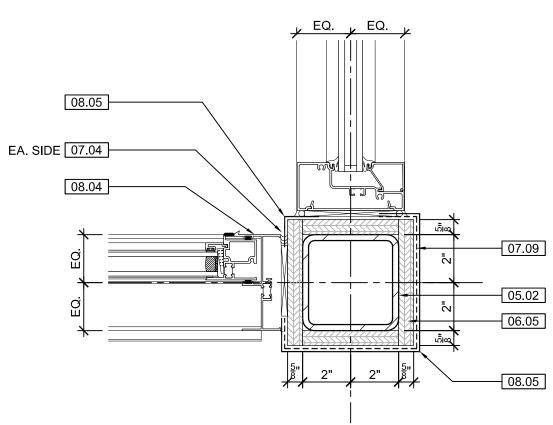
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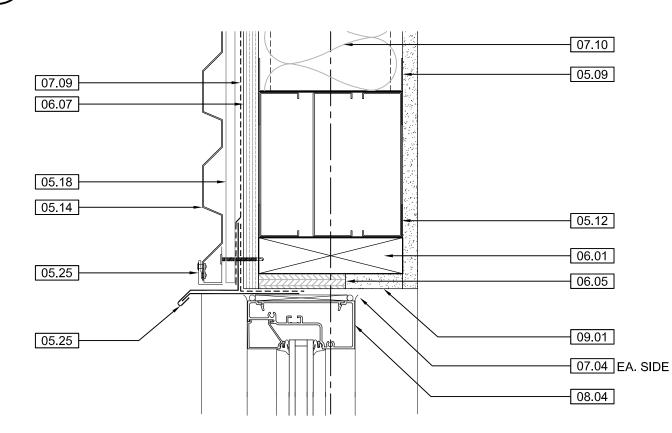
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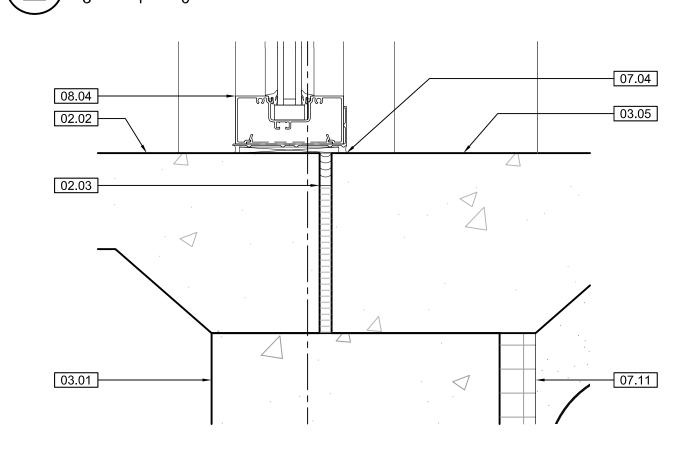





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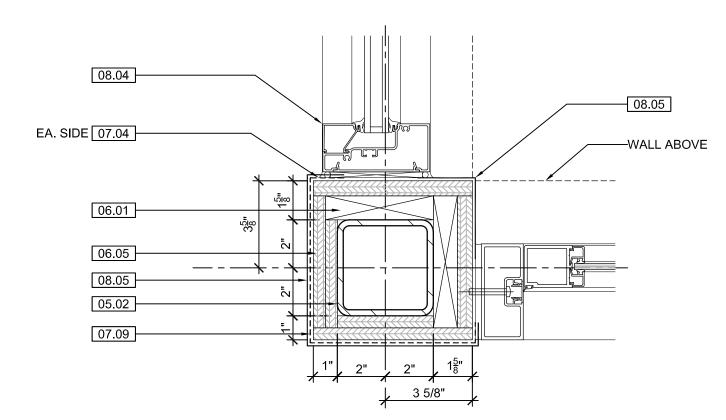





## **CONCESSION WNDW. JAMB DTL.**




## **CONCESSION WNDW. JAMB DTL.**

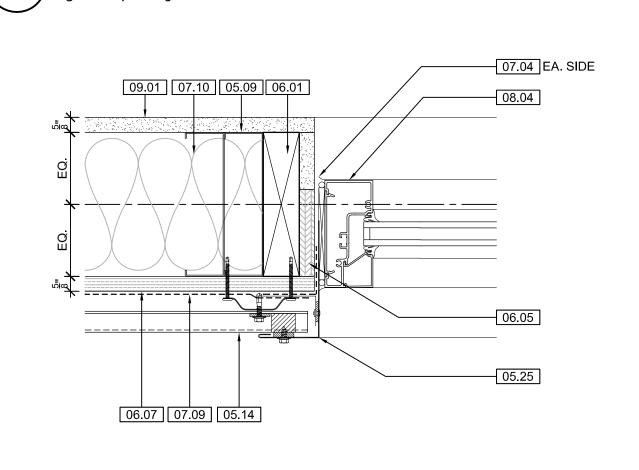


## TYPICAL WNDW. HEAD DTL.

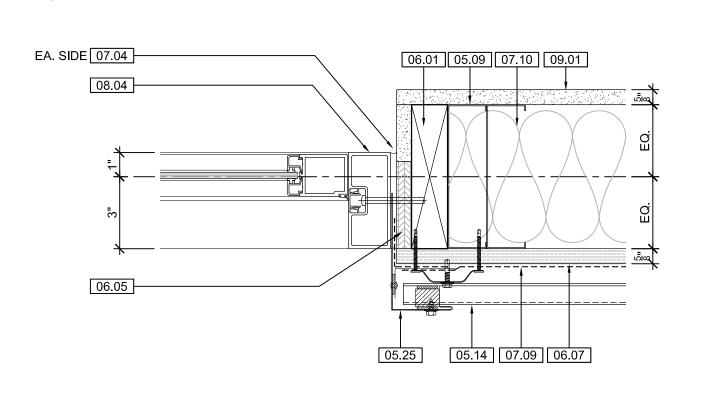


# TYP. WNDW. SILL DTL.

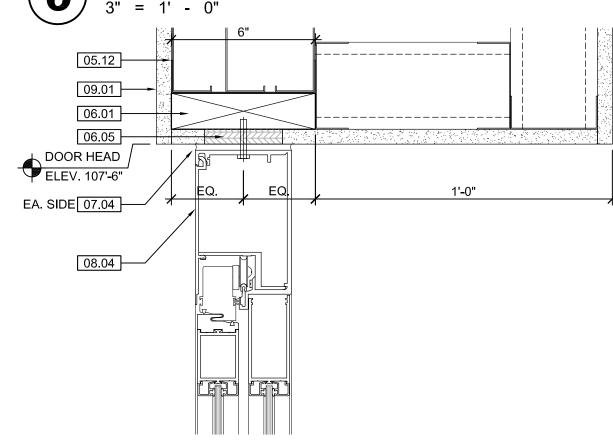


# TYP. WNDW. JAMB DTL. 3" = 1' - 0"

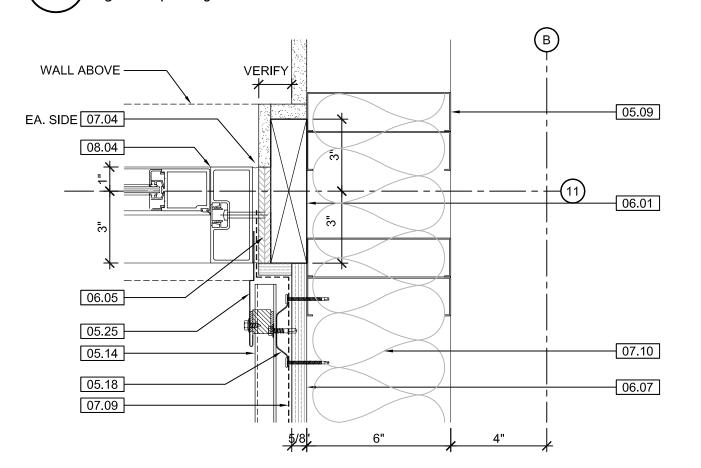


# WNDW. JAMB DTL. @ CORNER COL.

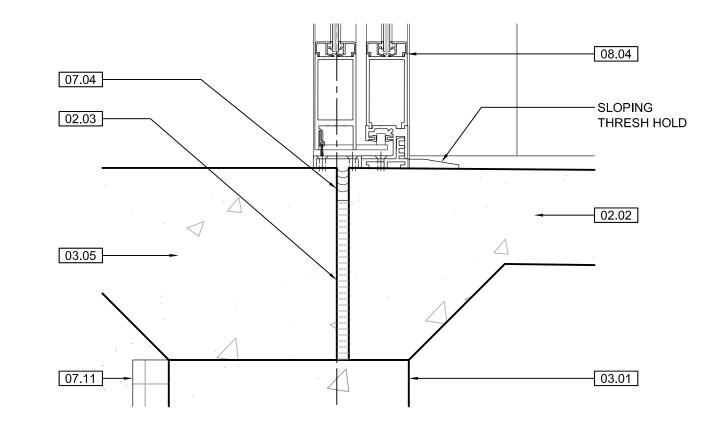


### SLIDE DOOR JAMB DTL.

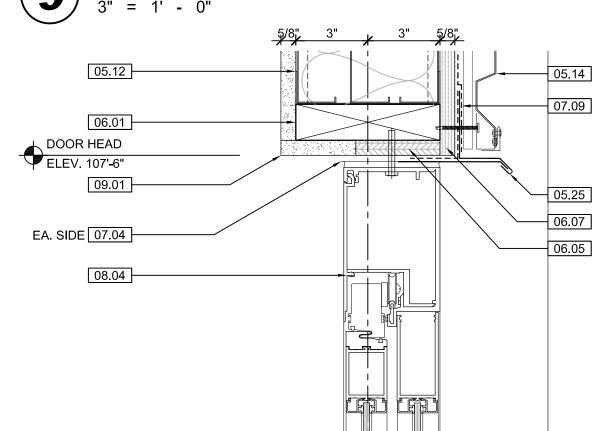


INT. SLIDE DOOR HEAD DTL.

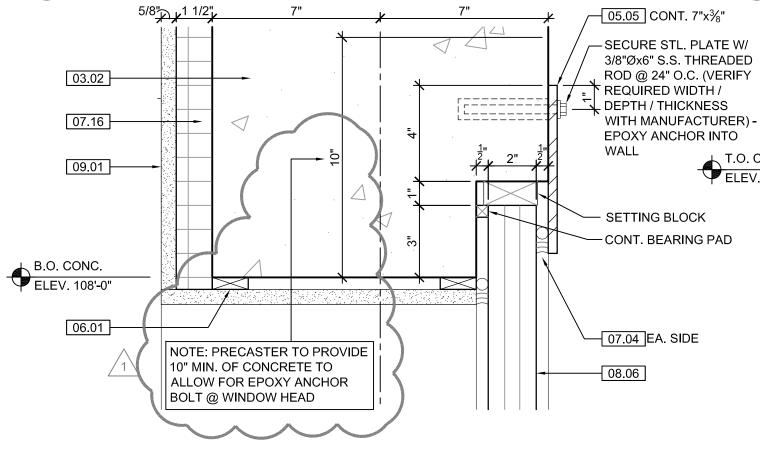


# SLIDE DOOR JAMB DTL.

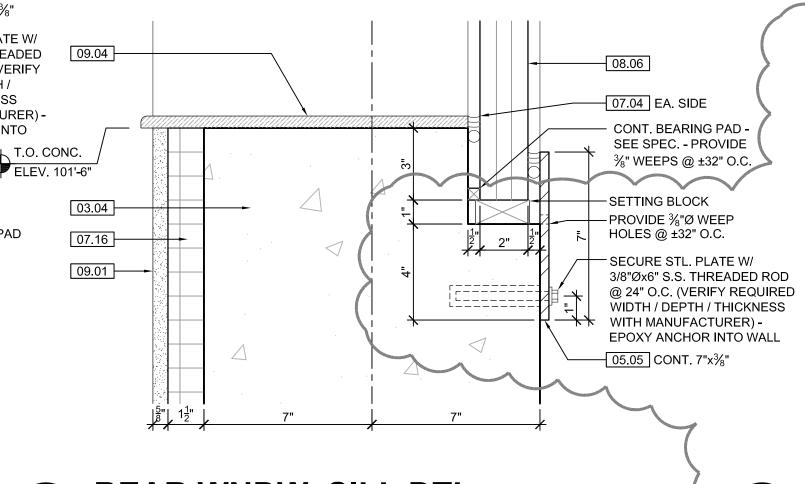


#### SLIDE DOOR SILL DTL.

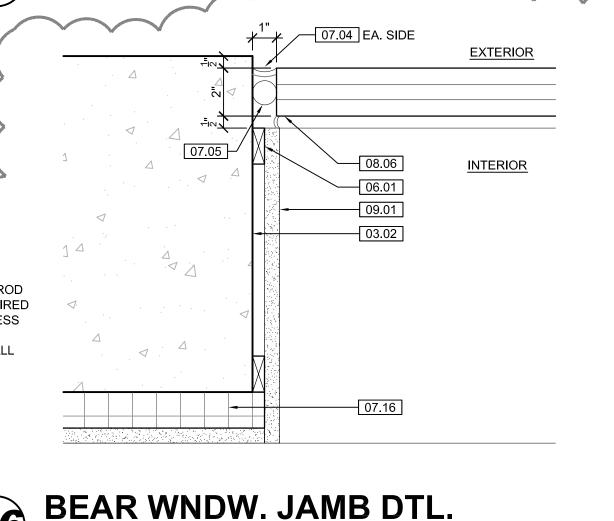

# SLIDE DOOR HEAD DTL. 3" = 1' - 0"

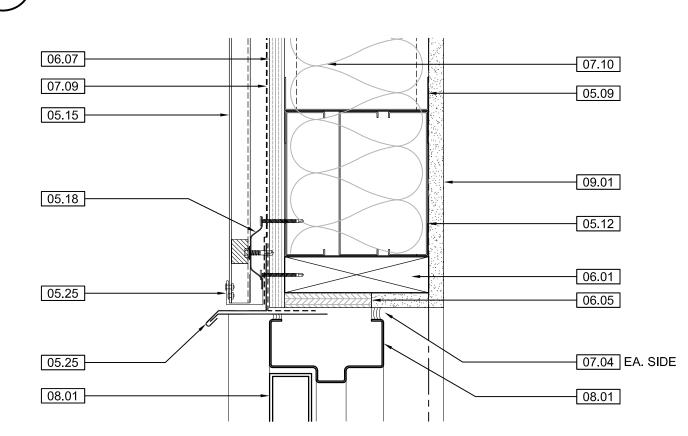


BEAR WNDW. HEAD DTL.

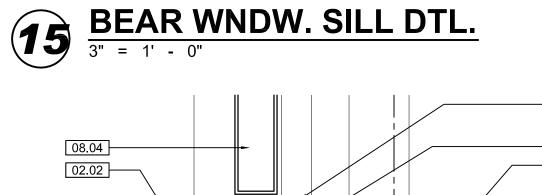


- ALUM. THRESHOLD

SET IN SEALANT

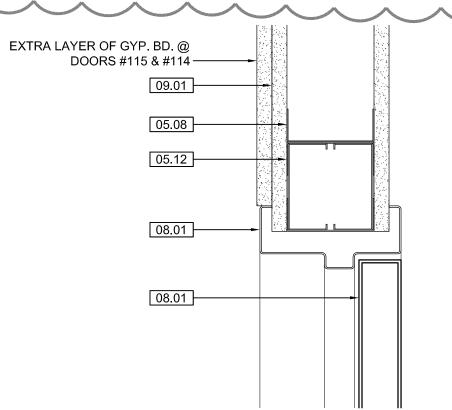



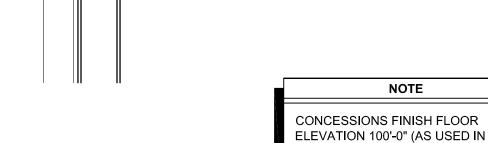

THESE 'A' SHEETS) EQUALS SITE

SHEETS)

ELEVATION 109.00 (VERIFY W/ SITE

#### ALL SECTIONS, & DETAILS BATT INSULATION: R-19 MIN.

KEYNOTE LEGEND: BUILDING ELEVATIONS, SECTIONS, WALL SECTIONS, & DETAILS						
Division 01 - Existing Construction  01.01 XXX	07.10 BATT INSULATION: R-19 MIN. TYPICAL, OR AS NOTED					
Division 02 - Site Construction  02.01 GRADE - SEE SITE SHEETS	07.11 FOUNDATION INSULATION 48" BELOW GRADE					
02.02 SIDEWALK OR SITE PAVING - SEE SITE SHEETS	07.12 EXPANSION JOINT					
L	07.13 E.J. MATERIAL					
02.03 ½" E.J. W/½" FIBER BD. & SELF LEVELING SEALANT	07.14 COLD APPLIED WATER PROOFING					
02.04 SITE WALL - SEE SITE SHEETS	07.15 6" EXPANDABLE WATER STOP					
02.05 SITE STAIR / RAMP / DOCK - SEE SITE SHEETS	07.16 1 ½" RIGID EPS INTERIOR INSULATION WITH FURRING AS REQUIRED					
02.06 CONTAINMENT FENCE - SEE SITE SHEETS	07.17 SPRAY FOAM INSULATION R-30					
02.07 TRENCH DRAIN - SEE SITE SHEETS	Division 08 - Doors & Windows					
02.08 HANDRAIL - SEE SITE SHEETS	08.01 HOLLOW METAL DOOR / FRAME - SEE DOOR SCHEDULE					
Division 03 - Concrete  03.01 CONC. FOUNDATION / FOOTING - REF. STRUCT'L	08.02 F.R.P. DOOR / FRAME - SEE DOOR SCHEDULE					
03 02 DDE CAST CONCRETE WALL DEE	08.03 HOLLOW METAL WINDOW - SEE					

03.02 PRE-CAST CONCRETE WALL - REF. STRUCT'L

08.04 STOREFRONT WINDOW / DOOR -03.03 PRE-CAST HOLLOW CORE CONC. SEE WINDOW TYPES ROOF SLAB - REF. STRUCT'L 08.05 PRE-FINISHED BREAK METAL -MATCH STOREFRONT FINISH 03.04 CAST-IN-PLACE CONCRETE WALL -REF. STRUCT'L 08.06 GLASS / ACRYLIC - SEE WINDOW 3.05 REINF. CONC. SLAB ON GRANULAR

WINDOW TYPES

MILLWORK SHEETS

SHEETS

TO MATCH ROOF

BY OWNER)

Division 12 - Furnishings

LOCN'S.

SHEETS

Division 15 - Mechanical

REF. MECH'L

12.01 XXX

KITCHEN EQUIPMENT SHEETS

SEE DETAILS FOR STANDOFF

COORDINATE MOUNTING &

15.01 HVAC UNIT / EQUIPMENT / DUCT -

FLOOR DRAIN - REF. PLUMB'G

MAIN DUCT IS 8" PVC PIPE W/ 3"

PVC PIPE VENTS @ 12" O.C. -

DUCTWORK CAST INTO CONC.

SHEETS FOR FAN EQUIPMENT.

STONE, SURROUNDED BY

W/ SLOTTED DRAIN TILE

16.01 LIGHT FIXTURE - REF. ELECT'L

16.02 ELECTRICAL OUTLET - REF.

16.03 LIGHT SWITCH - REF. ELECT'L

Division 16 - Electrical

WALL. REFERENCE MECHANICAL

NON-WOVEN GEO-TEXTILE FABRIC

15.02 PLUMBING EQUIPMENT / LINE /

15.04 BEAR YARD FAN & DUCTWORK:

15.03 HOSEBIB - REF. PLUMB'G

**ELECTRICAL REQUIREMENTS** 

13.03 CAGEWORK: SEE CAGEWORK

FILL OVER VAPOR BARRIER - REF. 08.07 SKYLIGHT - SEE SPEC. STRUC'TL & GEOTECH REPORT 03.06 GROUT FILL - REF. STRUCT'L Division 09 - Finishes 09.01 %" GYP. BD. (OR AS INDICATED) <u>Divisio</u>n 04 - Masonry 04.01 CMU - 8"x8"x16" NORMAL WEIGHT 09.02 LAY-IN CEILING - SEE R.C.P.

(OR AS NOTED) - REF. STRUCT'L 09.03 MILLWORK / CASEWORK - SEE Division 05 - Metals 5.01 STEEL BEAM / JOIST / TRUSS - REF. STRUCT'L 09.04 SOLID SURFACE - SEE FIN. SCHED. 05.02 STEEL COLUMN - REF. STRUCT'L

05.03 STEEL TUBE (SIZE AS NOTED) -Division 10 - Specialties 10.01 THEMEWORK - SEE THEMEWORK REF. STRUCT'L 05.04 STEEL ANGLE (SIZE AS NOTED) -REF. STRUCT'L 10.02 SNOW GUARDS - PER MANUF.

05.05 STEEL PLATE (SIZE AS NOTED) -REF. STRUCT'L <u>ivisio</u>n 11 - Equipment 05.06 STEEL LINTEL - REF. STRUCT'L 11.01 KITCHEN EQUIPMENT - SEE

05.07 METAL ROOF DECK - REF. 11.02 EQUIPMENT BY OWNER - N.I.C. STRUCT'L 05.08 3 %" METAL STUD FRAMING @ 16" 11.03 WATER STORAGE SILO - SEE SITE SHEETS (ANY PAINTED SIGNAGE

05.09 6" METAL STUD FRAMING @ 16" O.C. - REF. STRUCT'L 05.10 PRE-FINISHED METAL SOFFIT

Division 13 - Special Construction 13.01 2"x2"x1/8"Ø S.S. WOVEN WIRE MESH W/ BLACK OXIDE FINISH - SEE TYP. 05.11 METAL FRAMING AS REQ'D DETAIL F/SA7.1 05.12 HEADER - REF. STRUCT'L 13.02 CAGEWORK: ¾"Ø LACING BAR -

05.13 COLD ROLLED METAL JOISTS @ ี 16" O.C. (SIZE AS INDIC'D) - REF. STRUCT'L

05.14 PRE-FINISHED HORIZONTAL METAL PANEL SIDING 13.04 SIGNAGE (BY OWNER) -05.15 PRE-FINISHED VERTICAL METAL

PANEL SIDING 05.16 PRE-FINISHED STANDING SNAP ON <u>Division</u> 14 - Conveying Systems SEAM CURVED METAL ROOF

05.17 GALV. CORRUGATED METAL ROOFING 05.18 FURRING PER METAL SIDING

MANUF. RECOMENDATION 05.19 PRE-FINISHED MTL. FLASHING 05.20 PRE-FINISHED MTL. SILL FLASHING 05.21 PRE-FINISHED MTL. FASCIA

05.22 PRE-FINISHED MTL. PARAPET FLASHING 05.23 PRE-FIN. METAL GUTTER OR CONDUCTOR HEAD & DOWNSPOUT 15.05 12" LAYER CRUSHED CLEAR

05.24 GALV. 6" HALF ROUND GUTTER & 3" DIAM. DOWNSPOUT 05.25 PRE-FIN. METAL TRIM - PER SIDING MANUFACTURER'S INSTALLATION INSTRUCTIONS

Division 06 - Wood & Plastics

STRUCT'L

06.01 BLOCKING, 2X OR SIZE AS INDIC'D 06.02 WOOD TRIM, 1X OR SIZE AS INDIC'D - SEE SPEC 06.03 WOOD BEAM / JOISTS - REF.

06.04 WOOD COLUMN - REF. STRUCT'L 06.05 PLYWOOD SHEATHING - %" OR SIZE AS INDIC'D

06.07 %" GLASS-MAT SHEATHING SHEATHING 06.08 ROOF SHEATHING - REF. STRUCT'L 06.09 2x FASCIA OR SIZE AS INDIC'D

06.06  $\frac{1}{4}$ " GLASS-MAT ROOF COVER BD.

06.10 6" CEDAR SHIPLAP SIDING ON 1X SLEEPERS 06.11 CEDAR TRIM

Division 07 - Thermal & Moisture 7.01 FULLY ADHERED T.P.O.

MEMBRANE ROOFING 07.02 FULLY ADHERED T.P.O. FLASHING

07.03 TERMINATION BAR

07.04 SEALANT

07.05 CONTINUOUS BACKER ROD (DOUBLE WHERE NOTED) 7.06 RIGID BASE INSULATION, 3" MIN. ゙AT BEAR & SEAL HOLDING, 4" MIN AT RESTAURANT (OR THICKNESS

& R-VALUE AS INDICATED)  $\overline{07.07}$  TAPERED INSULATION,  $\frac{1}{2}$ " MIN.

07.08 ICE & WATER SHIELD

07.09 WEATHER BARRIER

RECOMMENDED LAYOUT - COLOR ARCHITECTS

> WDM Architects P.A. 105 North Washington Wichita, KS 67202-2815 T 316.262.4700 F 316.262.0002 wdmarchitects.com



ON

PRINTS ISSUED 07.26.2013 - Schematic Design 08.23.2013 - Design Development 09.23.2013 - 65% CD's 10.07.2013 - Pricing Set 10.21.2013 - 95% CD's

11.13.2013 - Bid Documents

11.25.2013 - Addendum #3

WDM No. 13046


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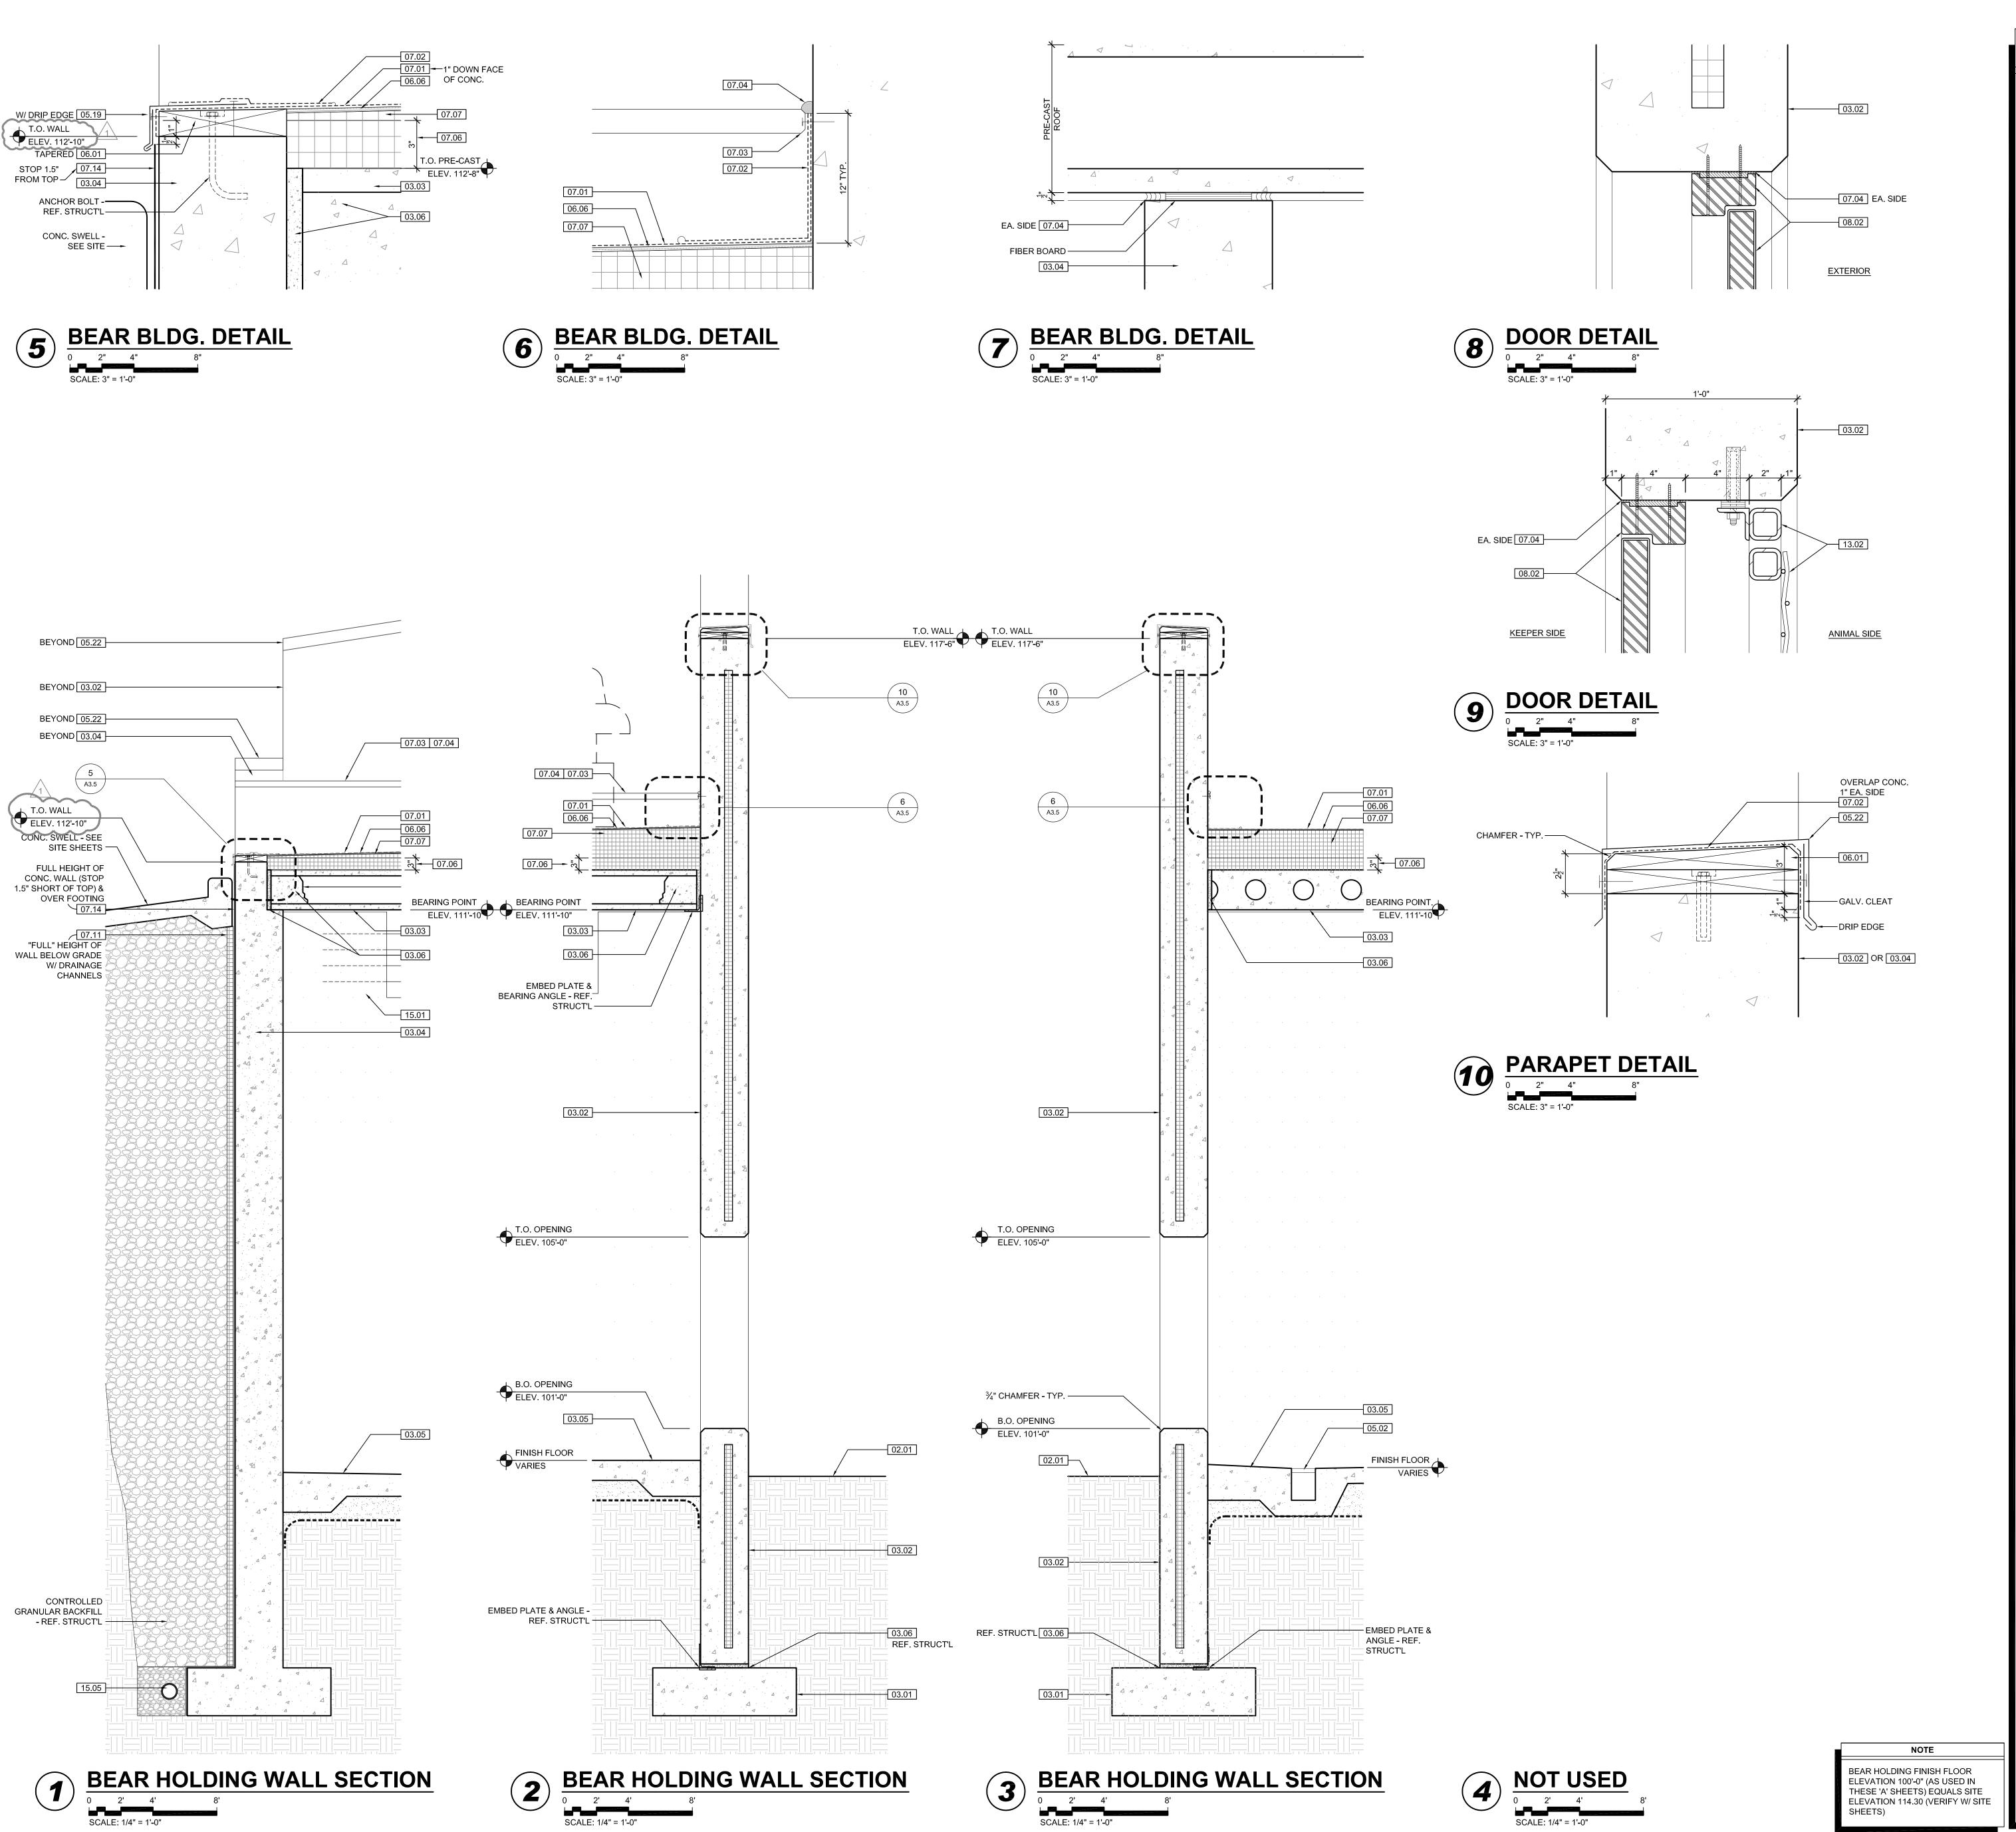
A1.10

**18** NOT USED

3" = 1' - 0"

**19 DOOR SILL DTL.** 3" = 1' - 0"



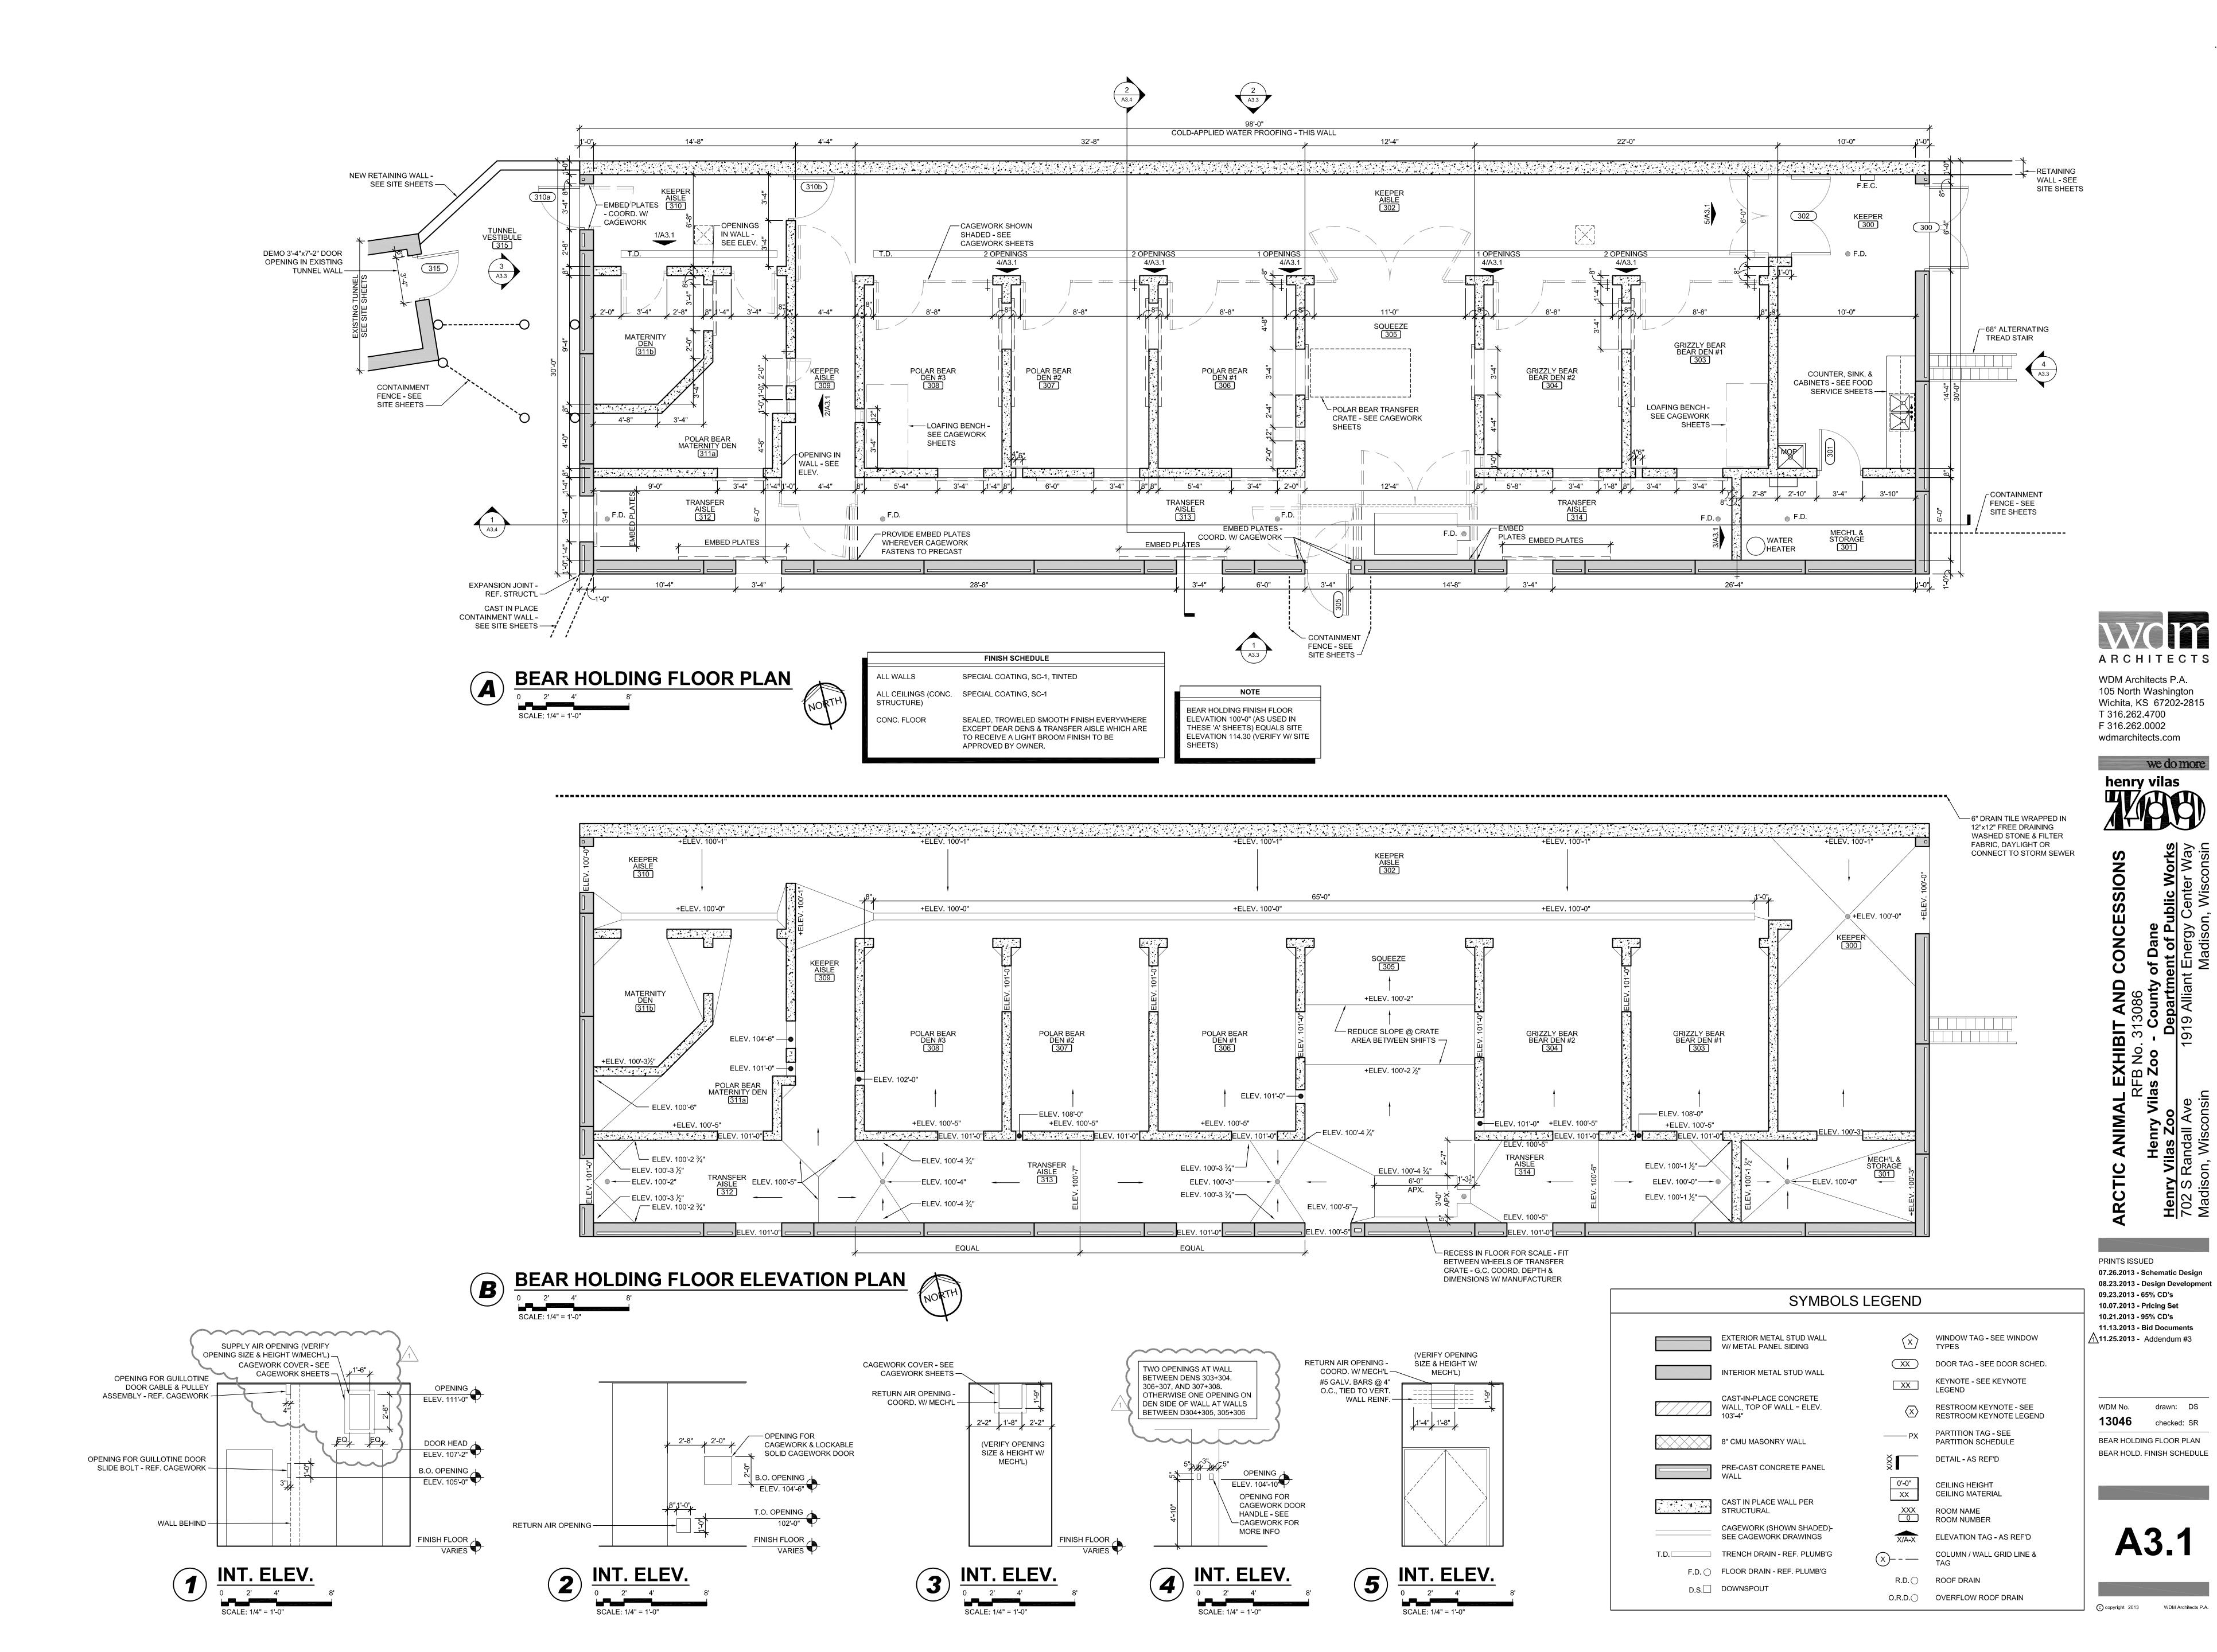


**KEYNOTE LEGEND: BUILDING ELEVATIONS, SECTIONS, WALL SECTIONS, & DETAILS** 07.10 BATT INSULATION: R-19 MIN. **Division 01 - Existing Construction** TYPICAL, OR AS NOTED Division 02 - Site Construction 07.11 FOUNDATION INSULATION 48" 02.01 GRADE - SEE SITE SHEETS BELOW GRADE 07.12 EXPANSION JOINT 02.02 SIDEWALK OR SITE PAVING - SEE SITE SHEETS 07.13 E.J. MATERIAL 02.03 ½" E.J. W/ $\frac{1}{2}$ " FIBER BD. & SELF 07.14 COLD APPLIED WATER PROOFING LEVELING SEALANT 07.15 6" EXPANDABLE WATER STOP 02.04 SITE WALL - SEE SITE SHEETS 07.16 1 ½" RIGID EPS INTERIOR INSULATION WITH FURRING AS 02.05 SITE STAIR / RAMP / DOCK - SEE SITE SHEETS REQUIRED 02.06 CONTAINMENT FENCE - SEE SITE 07.17 SPRAY FOAM INSULATION R-30 02.07 TRENCH DRAIN - SEE SITE SHEETS Division 08 - Doors & Windows 08.01 HOLLOW METAL DOOR / FRAME -02.08 HANDRAIL - SEE SITE SHEETS SEE DOOR SCHEDULE 08.02 F.R.P. DOOR / FRAME - SEE DOOR Division 03 - Concrete 3.01 CONC. FOUNDATION / FOOTING -SCHEDULE REF. STRUCT'L 08.03 HOLLOW METAL WINDOW - SEE 03.02 PRE-CAST CONCRETE WALL - REF. WINDOW TYPES 08.04 STOREFRONT WINDOW / DOOR -03.03 PRE-CAST HOLLOW CORE CONC. SEE WINDOW TYPES ROOF SLAB - REF. STRUCT'L 08.05 PRE-FINISHED BREAK METAL -03.04 CAST-IN-PLACE CONCRETE WALL -MATCH STOREFRONT FINISH REF. STRUCT'L 08.06 GLASS / ACRYLIC - SEE WINDOW 3.05 REINF. CONC. SLAB ON GRANULAR FILL OVER VAPOR BARRIER - REF. 08.07 SKYLIGHT - SEE SPEC. STRUC'TL & GEOTECH REPORT 03.06 GROUT FILL - REF. STRUCT'L Division 09 - Finishes 09.01 %" GYP. BD. (OR AS INDICATED) 04.01 CMU - 8"x8"x16" NORMAL WEIGHT 09.02 LAY-IN CEILING - SEE R.C.P. (OR AS NOTED) - REF. STRUCT'L 09.03 MILLWORK / CASEWORK - SEE MILLWORK SHEETS Division 05 - Metals 05.01 STEEL BEAM / JOIST / TRUSS - REF. 09.04 SOLID SURFACE - SEE FIN. SCHED. STRUCT'L 05.02 STEEL COLUMN - REF. STRUCT'L 05.03 STEEL TUBE (SIZE AS NOTED) -Division 10 - Specialties 10.01 THEMEWORK - SEE THEMEWORK REF. STRUCT'L SHEETS 05.04 STEEL ANGLE (SIZE AS NOTED) REF. STRUCT'L 10.02 SNOW GUARDS - PER MANUF. RECOMMENDED LAYOUT - COLOR 05.05 STEEL PLATE (SIZE AS NOTED) -TO MATCH ROOF REF. STRUCT'L <u>Divisio</u>n 11 - Equipment 05.06 STEEL LINTEL - REF. STRUCT'L 11.01 KITCHEN EQUIPMENT - SEE KITCHEN EQUIPMENT SHEETS 05.07 METAL ROOF DECK - REF. 11.02 EQUIPMENT BY OWNER - N.I.C. STRUCT'L 05.08 3  $\frac{5}{8}$ " METAL STUD FRAMING @ 16" 11.03 WATER STORAGE SILO - SEE SITE O.C. - REF. STRUCTL SHEETS (ANY PAINTED SIGNAGE BY OWNER) 05.09 6" METAL STUD FRAMING @ 16" O.C. - REF. STRUCT'L Division 12 - Furnishings 12.01 XXX 05.10 PRE-FINISHED METAL SOFFIT Division 13 - Special Construction 13.01 2" $\times$ 2" $\times$ 1/8"Ø S.S. WOVEN WIRE MESH 05.11 METAL FRAMING AS REQ'D W/ BLACK OXIDE FINISH - SEE TYP. DETAIL F/SA7.1 05.12 HEADER - REF. STRUCT'L 13.02 CAGEWORK: ¾"Ø LACING BAR -SEE DETAILS FOR STANDOFF 05.13 COLD ROLLED METAL JOISTS @ 16" O.C. (SIZE AS INDIC'D) - REF. LOCN'S. 13.03 CAGEWORK: SEE CAGEWORK 05.14 PRE-FINISHED HORIZONTAL METAL SHEETS PANEL SIDING 13.04 SIGNAGE (BY OWNER) -COORDINATE MOUNTING & 5.15 PRE-FINISHED VERTICAL METAL PANEL SIDING ELECTRICAL REQUIREMENTS 05.16 PRE-FINISHED STANDING SNAP ON <u>Divisio</u>n 14 - Conveying Systems SEAM CURVED METAL ROOF 5.17 GALV. CORRUGATED METAL Division 15 - Mechanical 15.01 HVAC UNIT / EQUIPMENT / DUCT -ROOFING REF. MECH'L 05.18 FURRING PER METAL SIDING 15.02 PLUMBING EQUIPMENT / LINE / MANUF. RECOMENDATION FLOOR DRAIN - REF. PLUMB'G 05.19 PRE-FINISHED MTL. FLASHING 15.03 HOSEBIB - REF. PLUMB'G 05.20 PRE-FINISHED MTL. SILL FLASHING 15.04 BEAR YARD FAN & DUCTWORK: 05.21 PRE-FINISHED MTL. FASCIA MAIN DUCT IS 8" PVC PIPE W/ 3" PVC PIPE VENTS @ 12" O.C. -05.22 PRE-FINISHED MTL. PARAPET DUCTWORK CAST INTO CONC. FLASHING WALL. REFERENCE MECHANICAL SHEETS FOR FAN EQUIPMENT. 05.23 PRE-FIN. METAL GUTTER OR CONDUCTOR HEAD & DOWNSPOUT 15.05 12" LAYER CRUSHED CLEAR STONE, SURROUNDED BY 05.24 GALV. 6" HALF ROUND GUTTER & NON-WOVEN GEO-TEXTILE FABRIC 3" DIAM. DOWNSPOUT W/ SLOTTED DRAIN TILE 05.25 PRE-FIN. METAL TRIM - PER SIDING Division 16 - Electrical MANUFACTURER'S INSTALLATION 16.01 LIGHT FIXTURE - REF. ELECT'L INSTRUCTIONS 16.02 ELECTRICAL OUTLET - REF. Division 06 - Wood & Plastics 06.01 BLOCKING, 2X OR SIZE AS INDIC'D 16.03 LIGHT SWITCH - REF. ELECT'L 06.02 WOOD TRIM, 1X OR SIZE AS INDIC'D - SEE SPEC 06.03 WOOD BEAM / JOISTS - REF. STRUCT'L 06.04 WOOD COLUMN - REF. STRUCT'L 06.05 PLYWOOD SHEATHING - %" OR SIZE AS INDIC'D 06.06 1/4" GLASS-MAT ROOF COVER BD. 06.07 %" GLASS-MAT SHEATHING SHEATHING 06.08 ROOF SHEATHING - REF. STRUCT'L 06.09 2x FASCIA OR SIZE AS INDIC'D 06.10 6" CEDAR SHIPLAP SIDING ON 1X SLEEPERS 06.11 CEDAR TRIM Division 07 - Thermal & Moisture 07.01 FULLY ADHERED T.P.O. MEMBRANE ROOFING 07.02 FULLY ADHERED T.P.O. FLASHING 07.03 TERMINATION BAR 07.04 SEALANT 07.05 CONTINUOUS BACKER ROD (DOUBLE WHERE NOTED) 7.06 RIGID BASE INSULATION, 3" MIN. <sup>1</sup> AT BEAR & SEAL HOLDING, 4" MIN. AT RESTAURANT (OR THICKNESS & R-VALUE AS INDICATED) 07.07 TAPERED INSULATION,  $\frac{1}{2}$ " MIN

07.08 ICE & WATER SHIELD

07.09 WEATHER BARRIER

ARCHITECTS

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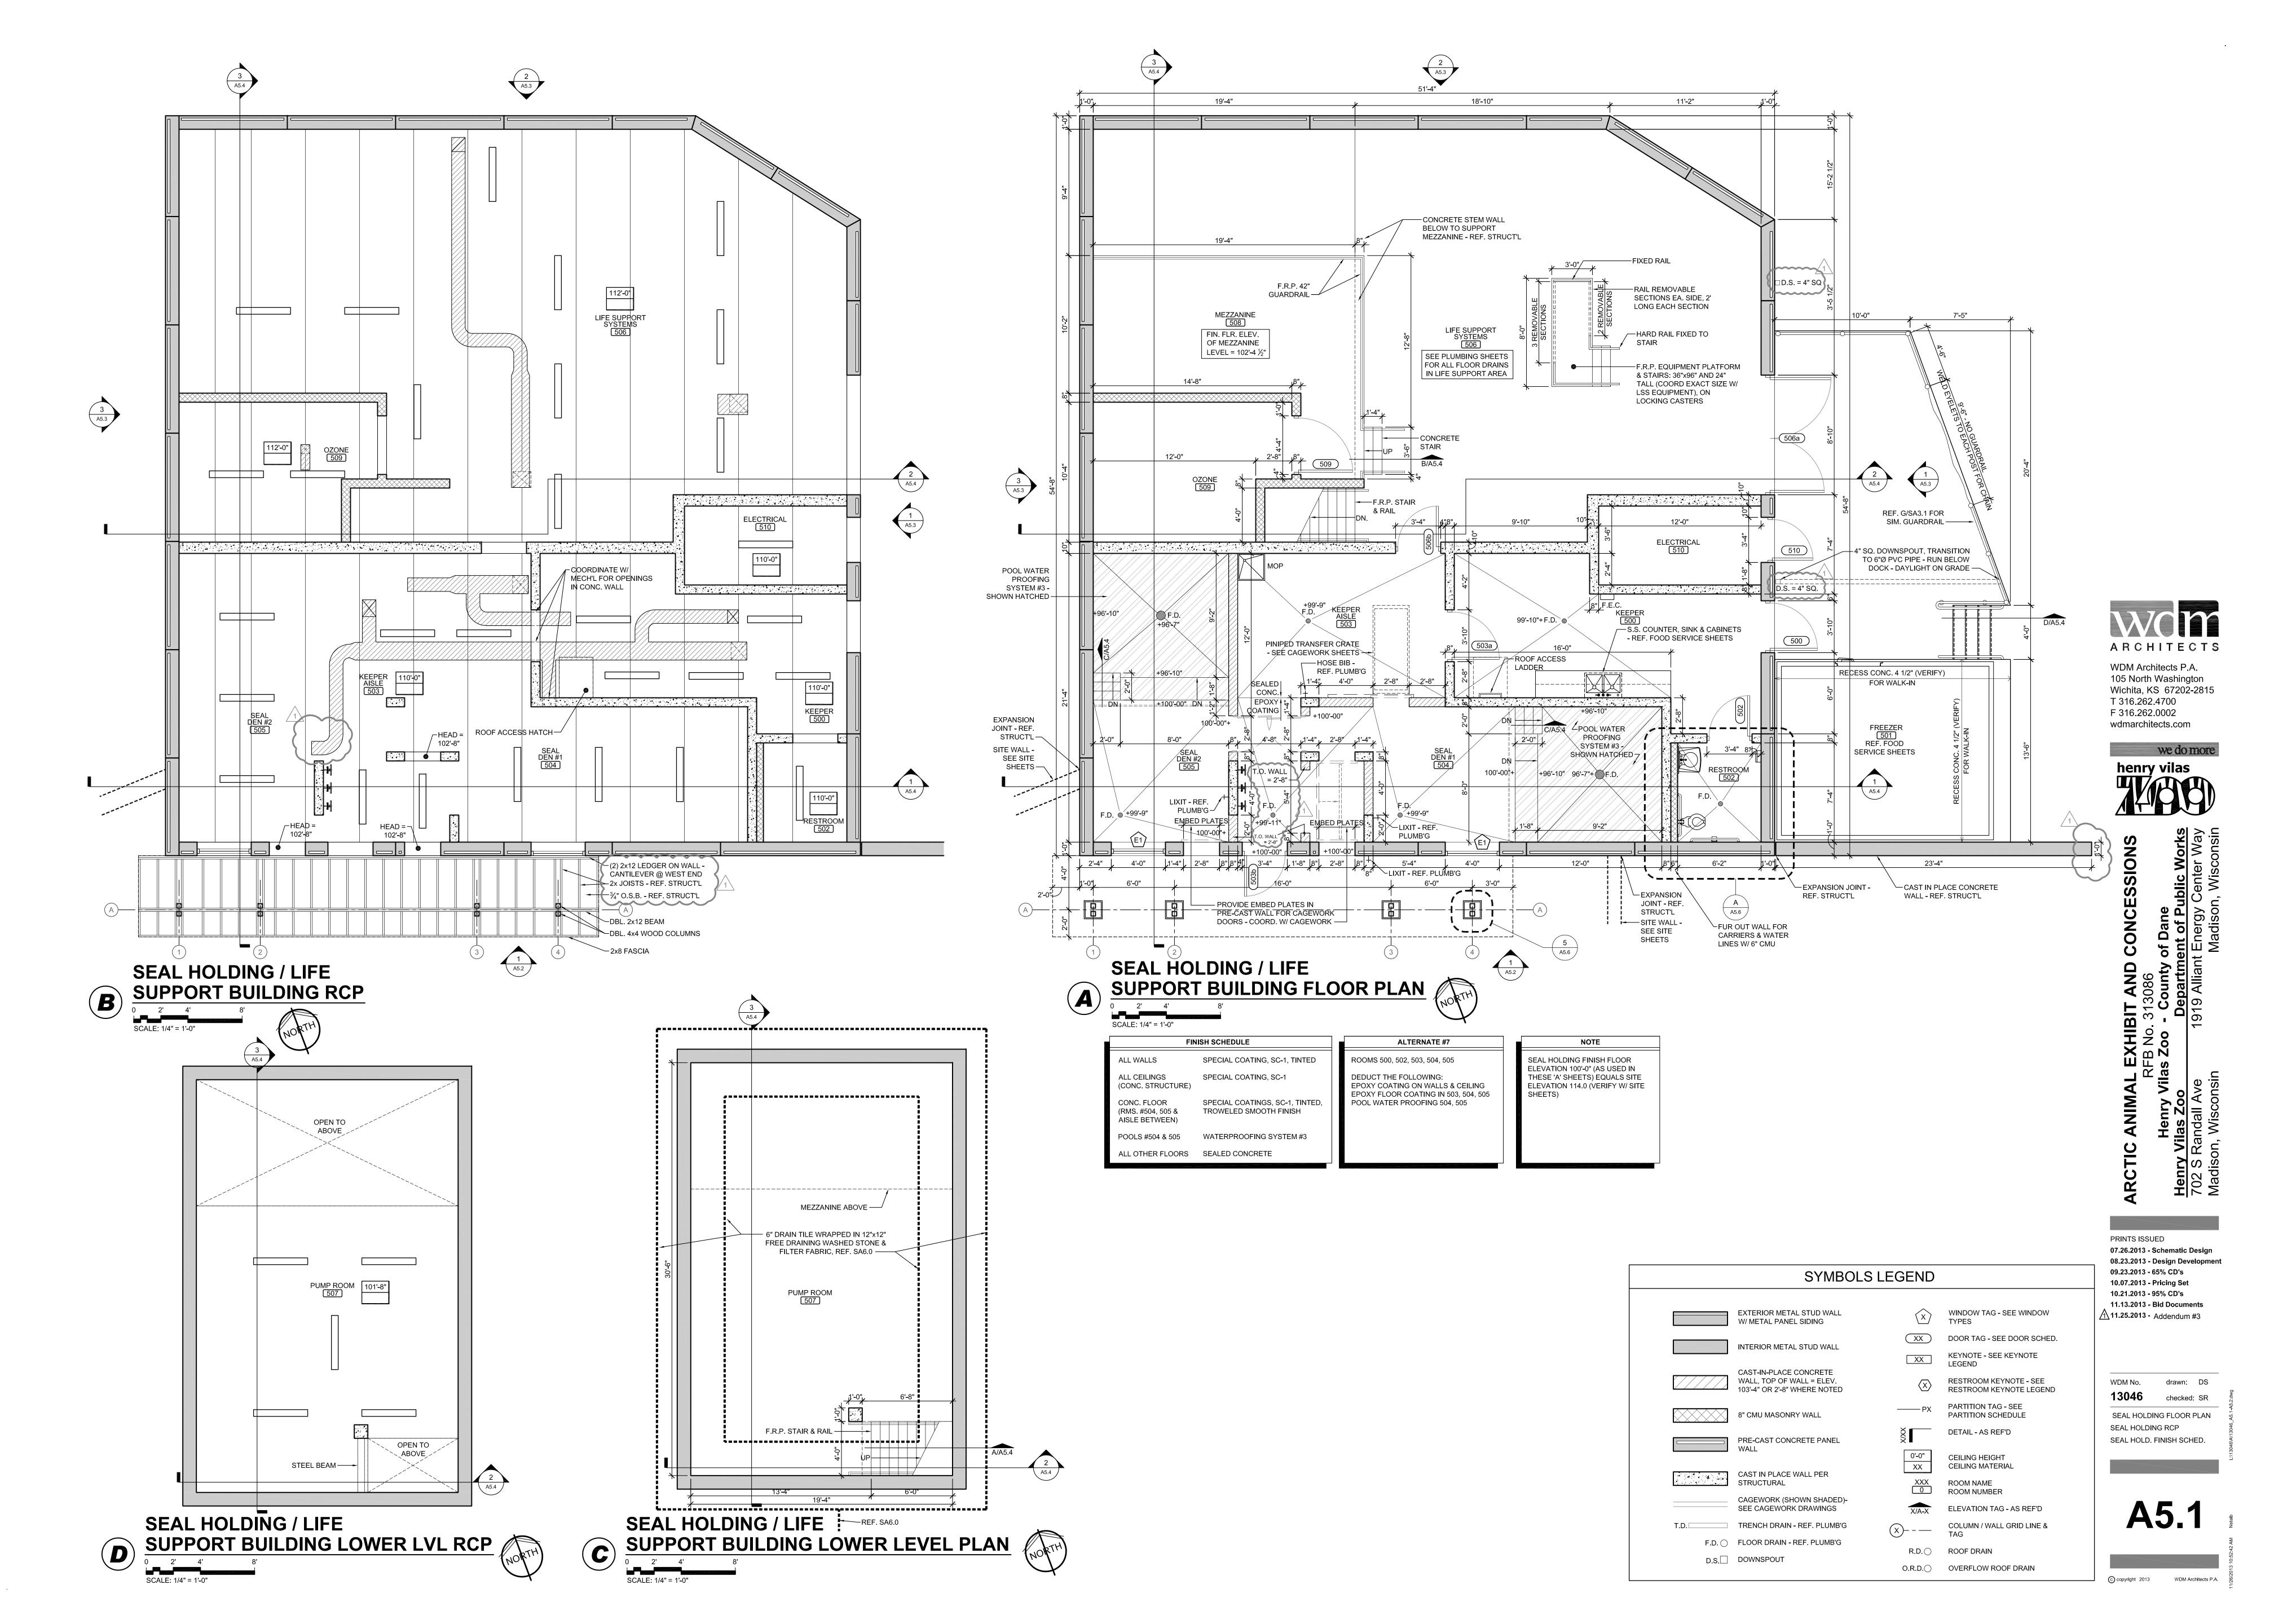
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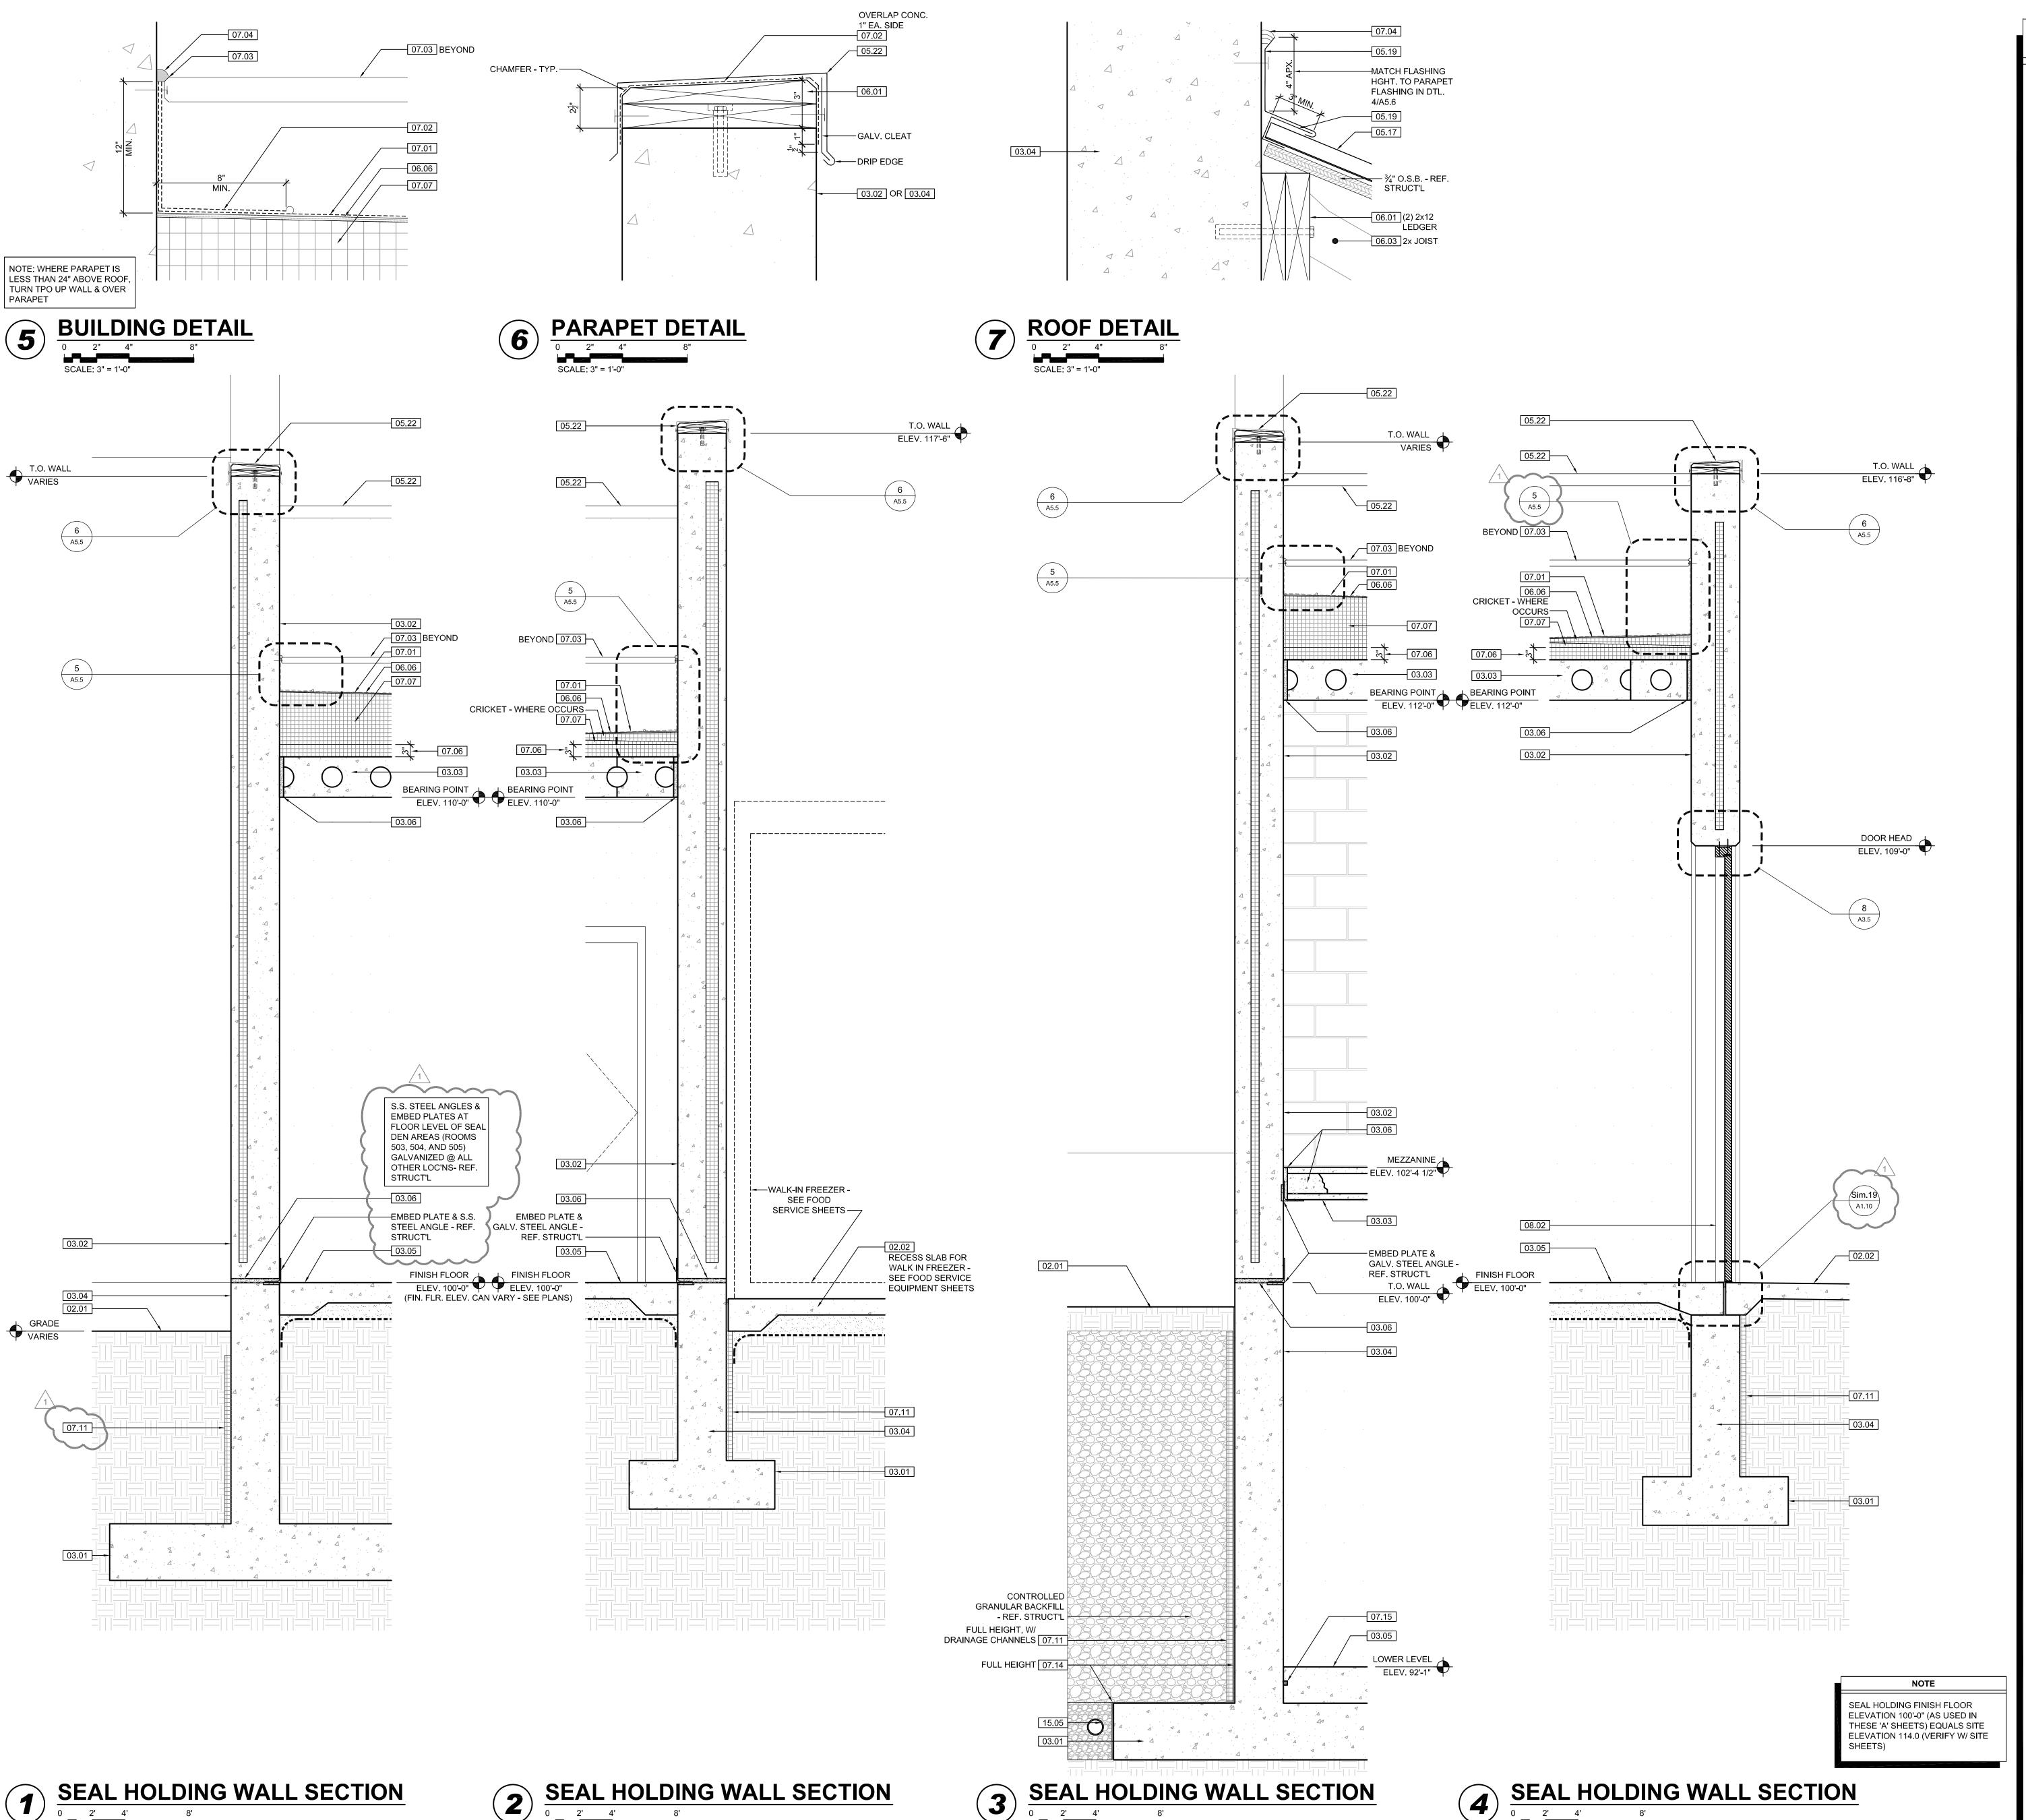
PRINTS ISSUED 07.26.2013 - Schematic Design 08.23.2013 - Design Development 09.23.2013 - 65% CD's 10.07.2013 - Pricing Set 10.21.2013 - 95% CD's 11.13.2013 - Bid Documents 11.25.2013 - Addendum #3

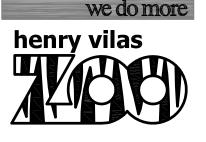C

WDM No. 13046 checked: SR BEAR HOLDING SECTIONS

A3.5





SCALE: 1/4" = 1'-0"

SCALE: 1/4" = 1'-0"

SCALE: 1/4" = 1'-0"

SCALE: 1/4" = 1'-0"

**KEYNOTE LEGEND: BUILDING ELEVATIONS, SECTIONS, WALL SECTIONS, & DETAILS** 07.10 BATT INSULATION: R-19 MIN. Division 01 - Existing Construction 07.11 FOUNDATION INSULATION 48" Division 02 - Site Construction 02.01 GRADE - SEE SITE SHEETS 07.12 EXPANSION JOINT 02.02 SIDEWALK OR SITE PAVING - SEE SITE SHEETS 07.13 E.J. MATERIAL 02.03 ½" E.J. W/ ½" FIBER BD. & SELF LEVELING SEALANT 07.14 COLD APPLIED WATER PROOFING 07.15 6" EXPANDABLE WATER STOP 02.04 SITE WALL - SEE SITE SHEETS 02.05 SITE STAIR / RAMP / DOCK - SEE 07.16 1 ½" RIGID EPS INTERIOR SITE SHEETS 02.06 CONTAINMENT FENCE - SEE SITE 7.17 SPRAY FOAM INSULATION R-30 SHEETS Division 08 - Doors & Windows

08.01 HOLLOW METAL DOOR / FRAME -02.07 TRENCH DRAIN - SEE SITE SHEETS 02.08 HANDRAIL - SEE SITE SHEETS Division 03 - Concrete

03.01 CONC. FOUNDATION / FOOTING -08.02 F.R.P. DOOR / FRAME - SEE DOOR REF. STRUCT'L 08.03 HOLLOW METAL WINDOW - SEE 03.02 PRE-CAST CONCRETE WALL - REF. STRUCT'L 08.04 STOREFRONT WINDOW / DOOR -03.03 PRE-CAST HOLLOW CORE CONC. ROOF SLAB - REF. STRUCT'L 08.05 PRE-FINISHED BREAK METAL -03.04 CAST-IN-PLACE CONCRETE WALL -REF. STRUCT'L 08.06 GLASS / ACRYLIC - SEE WINDOW 03.05 REINF. CONC. SLAB ON GRANULAR FILL OVER VAPOR BARRIER - REF. STRUC'TL & GEOTECH REPORT 08.07 SKYLIGHT - SEE SPEC. 03.06 GROUT FILL - REF. STRUCT'L Division 09 - Finishes 09.01 %" GYP. BD. (OR AS INDICATED) Division 04 - Masonry 04.01 CMU - 8"x8"x16" NORMAL WEIGHT 09.02 LAY-IN CEILING - SEE R.C.P. (OR AS NOTED) - REF. STRUCT'L 09.03 MILLWORK / CASEWORK - SEE Division 05 - Metals 5.01 STEEL BEAM / JOIST / TRUSS - REF. 09.04 SOLID SURFACE - SEE FIN. SCHED. STRUCT'L 05.02 STEEL COLUMN - REF. STRUCT'L 05.03 STEEL TUBE (SIZE AS NOTED) -Division 10 - Specialties REF STRUCT'L 10.01 THEMEWORK - SEE THEMEWORK 05.04 STEEL ANGLE (SIZE AS NOTED) -10.02 SNOW GUARDS - PER MANUF. REF. STRUCT'L 05.05 STEEL PLATE (SIZE AS NOTED) -REF. STRUCT'L ivision 11 - Equipment 05.06 STEEL LINTEL - REF. STRUCT'L 11.01 KITCHEN EQUIPMENT - SEE 05.07 METAL ROOF DECK - REF. 11.02 EQUIPMENT BY OWNER - N.I.C. 05.08 3 %" METAL STUD FRAMING @ 16" 11.03 WATER STORAGE SILO - SEE SITE O.C. - REF. STRUCT'L 05.09 6" METAL STUD FRAMING @ 16" O.C. - REF. STRUCT'L Division 12 - Furnishings 12.01 XXX 05.10 PRE-FINISHED METAL SOFFIT Division 13 - Special Construction 13.01 2"x2"x1/8"Ø S.S. WOVEN WIRE MESH 05.11 METAL FRAMING AS REQ'D 05.12 HEADER - REF. STRUCT'L 13.02 CAGEWORK: 3/4 "Ø LACING BAR -05.13 COLD ROLLED METAL JOISTS @ ี่ 16" O.C. (SIZE AS INDIC'D) - REF. 13.03 CAGEWORK: SEE CAGEWORK 05.14 PRE-FINISHED HORIZONTAL METAL PANEL SIDING 05.15 PRE-FINISHED VERTICAL METAL PANEL SIDING 05.16 PRE-FINISHED STANDING SNAP ON <u>Division</u> 14 - Conveying Systems SEAM CURVED METAL ROOF 05.17 GALV. CORRUGATED METAL ROOFING 05.18 FURRING PER METAL SIDING MANUF. RECOMENDATION 05.19 PRE-FINISHED MTL. FLASHING 05.20 PRE-FINISHED MTL. SILL FLASHING 05.21 PRE-FINISHED MTL. FASCIA 05.22 PRE-FINISHED MTL. PARAPET FLASHING 05.23 PRE-FIN. METAL GUTTER OR CONDUCTOR HEAD & DOWNSPOUT 15.05 12" LAYER CRUSHED CLEAR 05.24 GALV. 6" HALF ROUND GUTTER & 3" DIAM. DOWNSPOUT 05.25 PRE-FIN. METAL TRIM - PER SIDING Division 16 - Electrical MANUFACTURER'S INSTALLATION INSTRUCTIONS Division 06 - Wood & Plastics 06.01 BLOCKING, 2X OR SIZE AS INDIC'D 06.02 WOOD TRIM, 1X OR SIZE AS INDIC'D - SEE SPEC 06.03 WOOD BEAM / JOISTS - REF. STRUCT'L 06.04 WOOD COLUMN - REF. STRUCT'L 06.05 PLYWOOD SHEATHING - %" OR SIZE AS INDIC'D 06.06 1/4" GLASS-MAT ROOF COVER BD. 06.07 %" GLASS-MAT SHEATHING SHEATHING 06.08 ROOF SHEATHING - REF. STRUCT'L 06.09 2x FASCIA OR SIZE AS INDIC'D 06.10 6" CEDAR SHIPLAP SIDING ON 1X SLEEPERS 06.11 CEDAR TRIM **Division 07 - Thermal & Moisture** 01 FULLY ADHERED T.P.O. MEMBRANE ROOFING 07.02 FULLY ADHERED T.P.O. FLASHING 07.03 TERMINATION BAR 07.04 SEALANT 07.05 CONTINUOUS BACKER ROD (DOUBLE WHERE NOTED) 07.06 RIGID BASE INSULATION, 3" MIN. AT BEAR & SEAL HOLDING, 4" MIN AT RESTAURANT (OR THICKNESS & R-VALUE AS INDICATED)

 $\overline{07.07}$  TAPERED INSULATION,  $\frac{1}{2}$ " MIN.

07.08 ICE & WATER SHIELD

07.09 WEATHER BARRIER

ARCHITECTS

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N O

13.04 SIGNAGE (BY OWNER) -COORDINATE MOUNTING & ELECTRICAL REQUIREMENTS

Division 15 - Mechanical 15.01 HVAC UNIT / EQUIPMENT / DUCT -REF. MECH'L

TYPICAL, OR AS NOTED

INSULATION WITH FURRING AS

SEE DOOR SCHEDULE

SCHEDULE

WINDOW TYPES

SEE WINDOW TYPES

MILLWORK SHEETS

RECOMMENDED LAYOUT - COLOR

KITCHEN EQUIPMENT SHEETS

SHEETS (ANY PAINTED SIGNAGE

W/ BLACK OXIDE FINISH - SEE TYP.

SEE DETAILS FOR STANDOFF

SHEETS

TO MATCH ROOF

BY OWNER)

DETAIL F/SA7.1

LOCN'S.

MATCH STOREFRONT FINISH

BELOW GRADE

15.02 PLUMBING EQUIPMENT / LINE / FLOOR DRAIN - REF. PLUMB'G 15.03 HOSEBIB - REF. PLUMB'G 15.04 BEAR YARD FAN & DUCTWORK

MAIN DUCT IS 8" PVC PIPE W/ 3" PVC PIPE VENTS @ 12" O.C. -DUCTWORK CAST INTO CONC. WALL. REFERENCE MECHANICAL SHEETS FOR FAN EQUIPMENT. STONE, SURROUNDED BY

NON-WOVEN GEO-TEXTILE FABRIC W/ SLOTTED DRAIN TILE 16.01 LIGHT FIXTURE - REF. ELECT'L 16.02 ELECTRICAL OUTLET - REF.

16.03 LIGHT SWITCH - REF. ELECT'L

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11.25.2013 - Addendum #3

WDM No. SEAL WALL SECTIONS

**A5.5** 

- 1. SEE SHEET S.01 FOR ADDITIONAL NOTES.
- 2. CONTROL JOINTS: ALL CONCRETE SLABS SHALL BE SAW CUT AS SOON AS THE CONCRETE WILL SUPPORT THE SAWING EQUIPMENT AND DOES NOT RAVEL DURING THE SAWING OPERATION. ALL SAW CUTTING SHALL BE PERFORMED THE SAME DAY THE CONCRETE IS PLACED. SAW CUTS SHALL BE ½" WIDE WITH DEPTHS OF AT LEAST 25% OF THE SLAB THICKNESS. JOINTING PATTERN SHALL BE IN A SQUARE PATTERN, WITH MAXIMUM SPACINGS OF 12'-0" FOR 4" THICK SLABS, 15'-0" FOR 6" THICK SLABS AND 20'-0" FOR 8" THICK SLABS, UNLESS NOTED OTHERWISE.
- 3. CURING: ALL CONCRETE FLAT WORK SHALL BE COVERED IMMEDIATELY FOLLOWING SAW CUTTING AND MAINTAINED CONTINUOUSLY WET FOR A MINIMUM OF 7 DAYS AFTER PLACING. CURING SHEETS SHALL BE USED, AND ARE TO REMAIN IN PLACE, DURING THIS PERIOD. CURING COMPOUND MAY BE USED AND MUST BE APPLIED PER MANUFACTURER'S RECOMMENDATIONS.
- 4. SEE SHEET S7.1 DETAIL 1 FOR ANCHOR BOLT REQUIREMENTS.
- 5. SEE SHEET S7.1 DETAILS 2 & 3 FOR FOOTING & FOUNDATION WALL CORNER REINFORCING.
- 6. SEE SHEET S7.1 DETAILS 4 & 5 FOR ADDED REINFORCING AT ROUND & RECTANGULAR OPENINGS.
- 7. PROVIDE 2-#4 BARS AT ALL DEAD ENDS & REENTRANT CORNERS. SEE DETAIL 6/S7.1.
- 8. SLAB CONTROL JOINTS SHALL BE AS SHOWN ON PLAN OR SIMILAR. JOINT SPACING SHALL NOT EXCEED 10'-0" O.C. SLAB JOINT ASPECT RATIO SHALL NOT EXCEED 1.5:1. SEE DETAIL 7/S7.1.
- 9. SEE SHEET S7.1 DETAIL 8 FOR WALL JOINT REQUIREMENTS.
- 10. SEE SHEET S7.1 DETAIL 9 FOR FOOTING STEP REQUIREMENTS
- 11. SITE PLAN DATUM ELEVATION: 109.00' = 100'-0"


CONCRETE FOOTING —	\ \ \ \ 1
CONCRETE PIER —	
TOP OF PIER ELEVATION —	TP=X'-X"
COLUMN GRID MARK	— (A)———————————————————————————————————
COLUMN FOOTING MARK (SEE FOUNDATION SCHEDULE)	X'-
TOP OF COLUMN FOOTING ELEVATION	P
COLUMN PIER MARK (SEE PIER SCHEDULE) ————	
CONCRETE WALL & FOOTING	<u>-</u> [
TOP OF WALL FOOTING ELEVATION —	X'-X"
TOP OF LEDGE ELEVATION —	— TL=X'-X" — i
TOP OF WALL ELEVATION —	──── TW=X'-X"
TOP OF PIER ELEVATION ————	— TP=X'-X"
FOOTING STEP	
FOOTING DIMENSION —	—————————————————————————————————————
EXPANSION JOINT-SEE NOTES FOR WALL CONTROL JOINT SPACING —	


	FOOTING SCHEDULE				
FOOTING MARK	FOOTING DIMENSION (W x L x D)	FOOTING REINFORCING EACH WAY, BOTTOM			
F1	3'-0" x 3'-0" x 1'-0"	3-#5 EA WAY			
F2	4'-0" x 4'-0" x 1'-0"	4-#6 EA WAY			
F3 5'-0" x 5'-0" x 1'-0"		5-#6 EA WAY			
W1	2'-0" x 1'-0" x CONT	(2) #4 x CONT			
W2	3'-0" x 1'-0" x CONT	(3) #5 x CONT			
W3	5'-6" x 1'-0" x CONT	(5) #5 x CONT #5 @16"oc			
W4	4'-0" x 1'-2" x CONT	(4) #5 x CONT #5 @16"oc			

		.E	
MARK	SIZE	BASE P	REMARKS
C1	HSS4x4x <sup>5</sup> ∕₁6	P_ ¾"x12"x1'−0" w/ (4) ¾"ø A.B.'s	
C2	HSS5x5x¾	P ¾"x12"x1'-0" w/ (4) ¾"ø A.B.'s	
C3	HSS4x4x⅓	P ¾"x12"x1'-0" w/ (4) ¾"ø A.B.'s	
C4	HSS5.000x0.375	P ¾"x12"x1'-0" w/ (4) ¾"ø A.B.'s	
C5	HSS6.000x0.375	P ¾"x12"x1'-0" w/ (4) ¾"ø A.B.'s	

PIER SCHEDULE				
(C)	A	B C D		D
PIER MARK	PIER DIMENSION (W x L)	PIER REINFORCING	TYPE	REMARKS
P1	1'-4" x 1'-4"	8-#6 VERT W/ #3 TIES @ 10"oc	В	
P2	2'-5" x 1'-4"	16-#6 VERT W/ #3 TIES @ 10"OC	В	
P3	1'-8" x 1'-8"	8-#6 VERT W/ #3 TIES @ 10"OC	В	
P4	1'-3" x 1'-3"	6-#6 VERT W/ #3 TIES @ 10"0C	С	

 CENTER PIER UNDER COLUMN <u>OR</u> UNDER BEAM BEARING UNLESS NOTED OTHERWISE.
 SEE DETAIL X/S7.X FOR TYPICAL PIER SECTION.

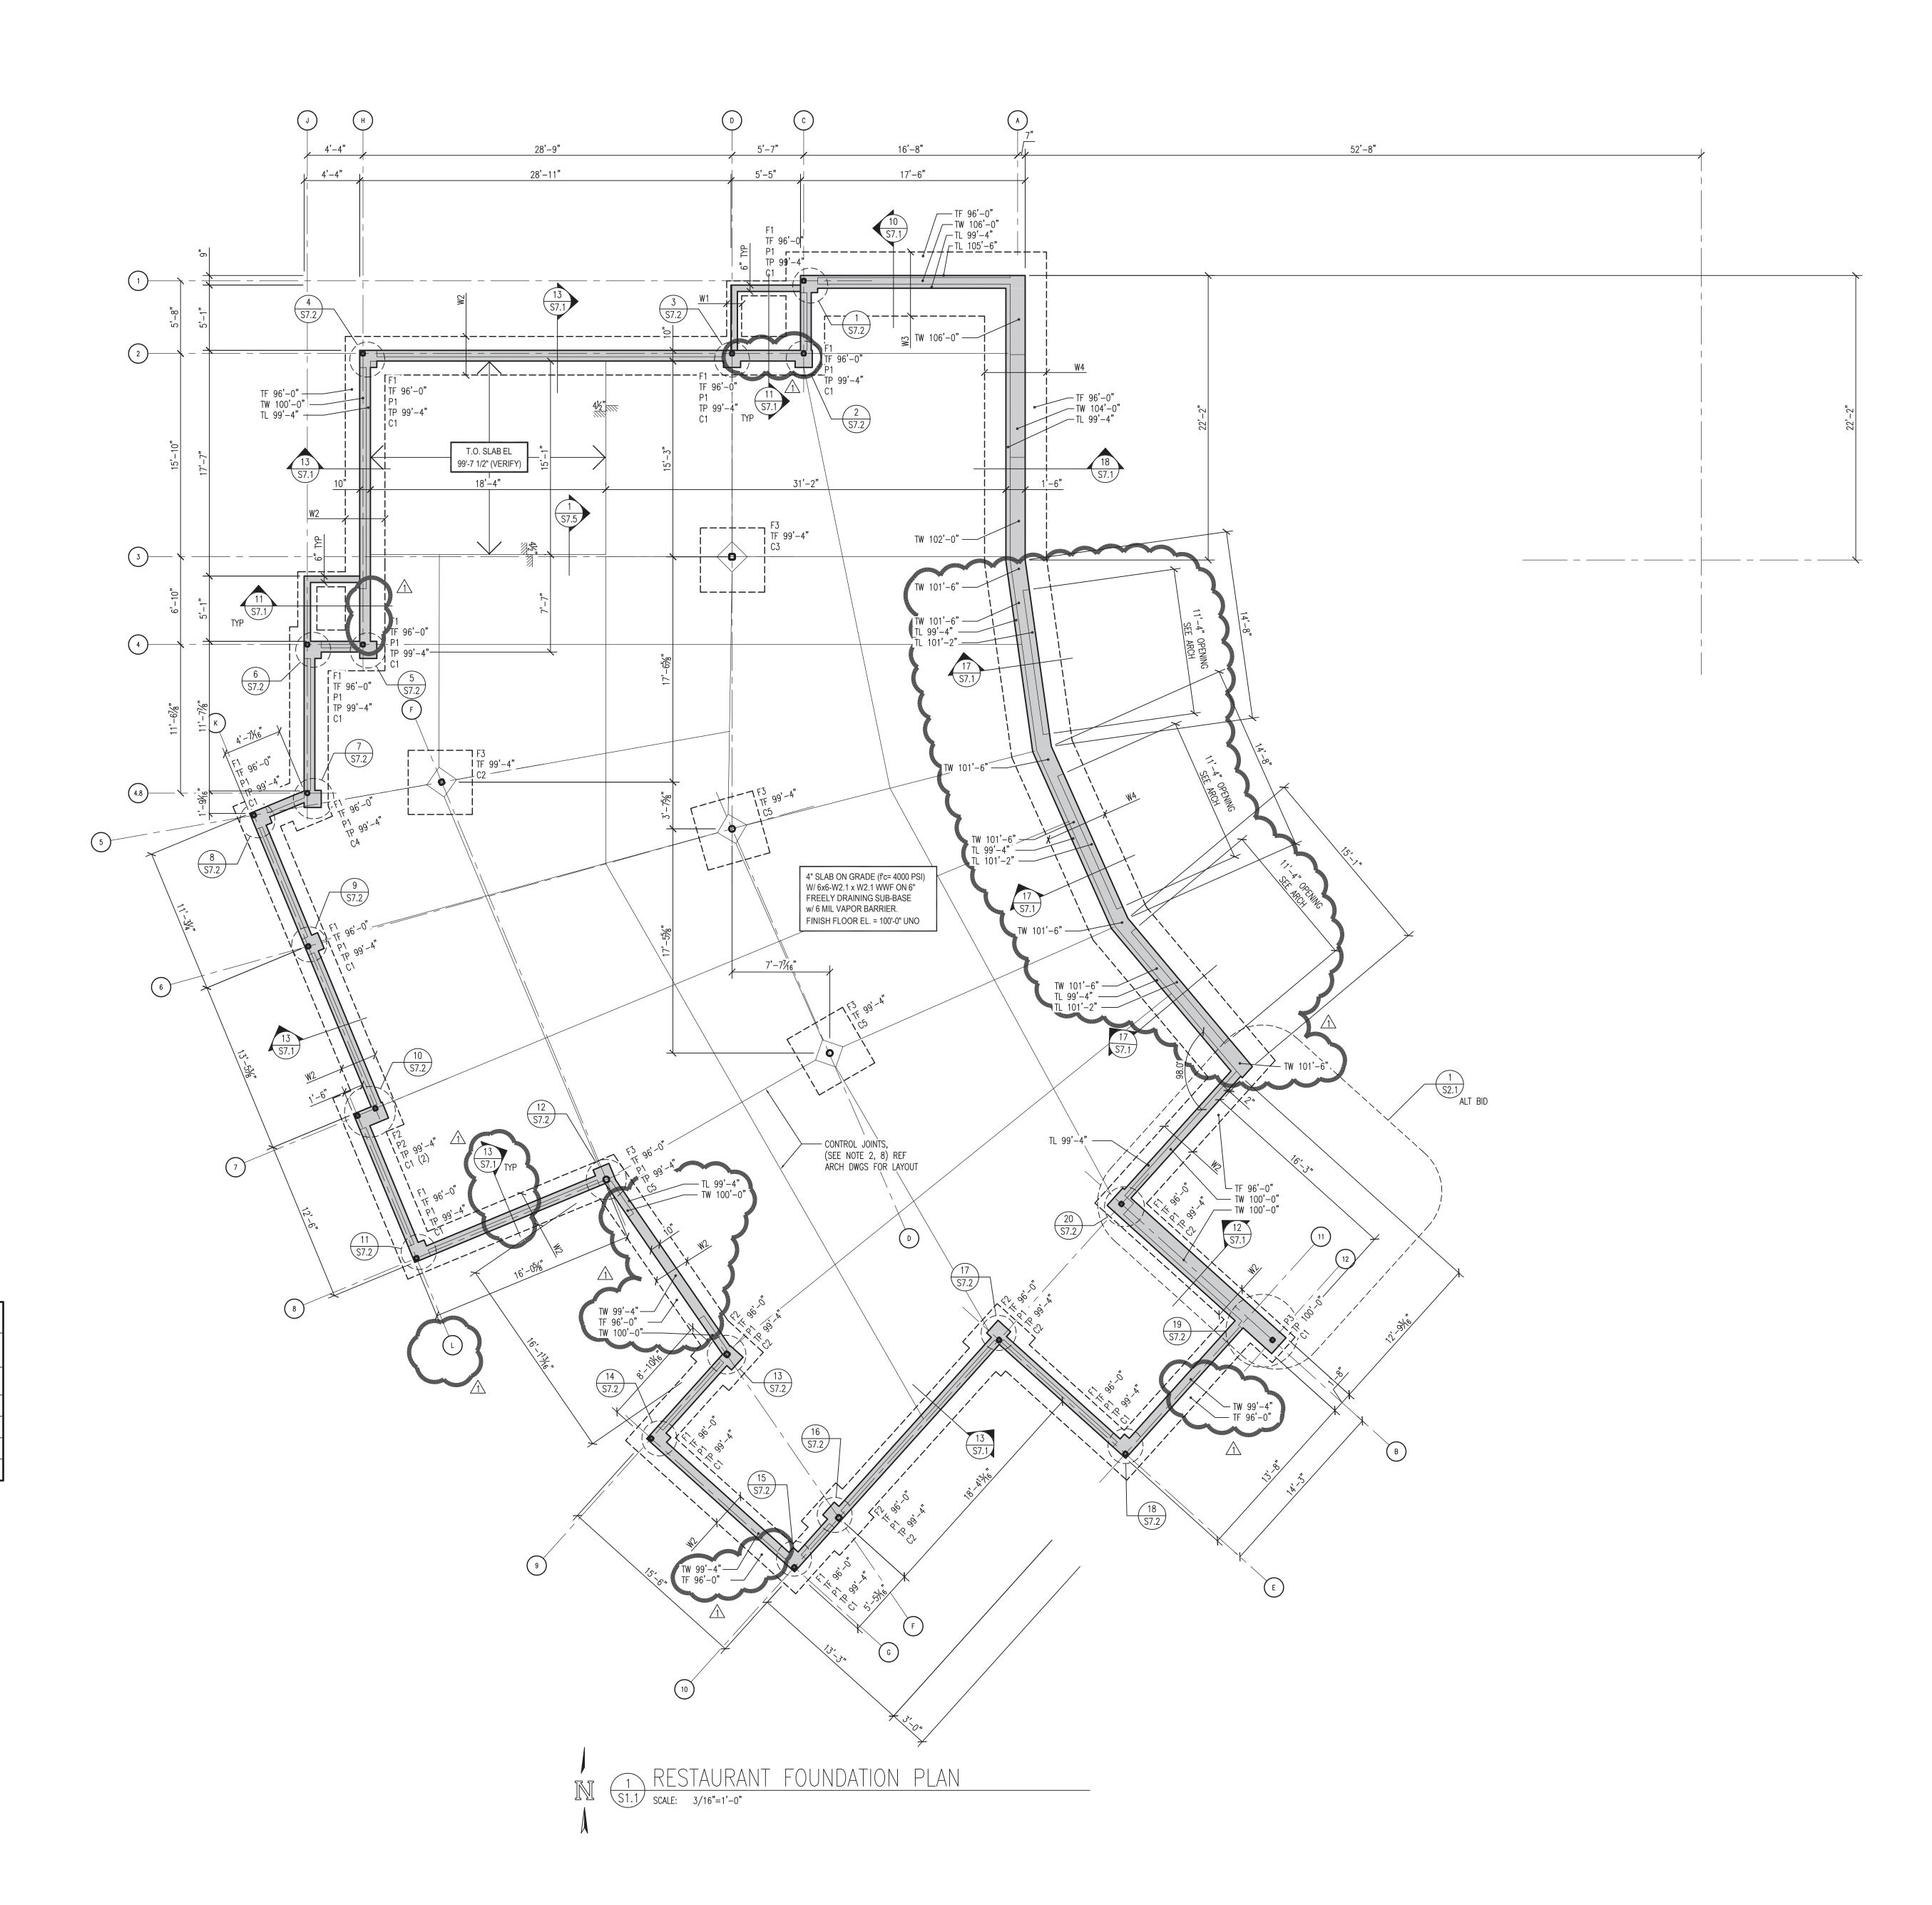

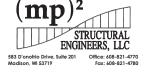



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Zoo - County of Dane

Department of Public W

1919 Alliant Energy Center

Henry Vilas Zoo
702 S Randall Ave

PRINTS ISSUED

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10.21.2013 - 95% CD's

11.13.2013 - Bid Documents

11.25.2013 - Addendum #3

WDM No. drawn: MP2

13046 checked: MP2

RESTURANT FOUNDATION
PLAN


S1.


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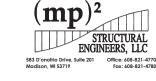
- 1. SEE SHEET S001 FOR ADDITIONAL NOTES.
- 2. 1 800S162-68 COLD FORM ROOF JOISTS @ 24"oc w/ 20 GA 1.5 B-DECK (D1)
- 3. SEE SHEET S9.1, DETAIL 10 FOR METAL DECK SCHEDULE AND DECK ATTACHMENT REQUIREMENTS
- 4. SEE SHEET SO.1 FOR ADDITIONAL PRECAST REQUIREMENTS AND ENVIRONMENTAL LOADING REQUIREMENTS.
- 5. STYLE OF PRECAST WALLS (SANDWICH PANEL OR INSULATED CORES)
  SHOWN AS CONCEPTUAL ONLY. ALL PRECAST WALL PANELS SHALL HAVE
  ARCHITECTURAL FINISH AND "R" INSULATION VALUES AS SPECIFIED BY
  ARCHITECT
- 6. PRECAST WYTHES EXPOSED TO ANIMAL ACTIVITY SHALL BE RIGID ENOUGH TO NOT CRACK WHEN ANIMAL LOADS ARE APPLIED (SEE NOTE 6 BELOW FOR LOADS).
- 7. ALL PRECAST WALL PANELS EXPOSED TO ANIMAL ACTIVITY SHALL BE DESIGNED FOR ENVIRONMENTAL LOADS SHOWN ON SHEET SO.1 AND FOR (2) 2.0k IMPACT POINT LOADS APPLIED OVER A 0.5 SQ-FT AREA AT 2'-0" APART AT ANY LOCATION IN THE BOTTOM 12'-0" ON THE EXTERIOR FACE OF THE WALL.
- 8. PRECAST WALL SHALL BE DESIGNED AS SHEAR WALLS TO RESIST SOIL, WIND, SEISMIC FORCES PER PLAN.
- 9. PROVIDE FORM LINER PER ARCHITECTURAL PLANS.

#### ROOF JOIST NOTES

- 1. SEE SHEET SO.1 FOR ADDITIONAL NOTES.
- 2. ALL JOISTS SHALL BE DESIGNED FOR A NET WIND UPLIFT OF 13.2
- 3. ALL KCS JOISTS HAVE BEEN SPECIFIIED TO SUPPORT SNOW DRIFT AND RTU LOADS IN ACCORDANCE WITH SJI CODE OF STANDARD PRACTICE USING A FLAT POSITIVE MOMENT & FLAT SHEAR FNEVELOPES
- 4. JOIST BRIDGING WHERE SHOWN IS SCHEMATIC IN NATURE ONLY. SUPPLIER SHALL DESIGN AND INDICATE LOCATION AND CONNECTION DETAILS OF ALL BRIDGING ON JOIST ERECTION DRAWINGS. SUPPLIER SHALL FURNISH ALL BRIDGING MATERIAL.
- 5. PROVIDE "X" BRIDGING BETWEEN JOIST AND PERIMETER W-SECTIONS AND/OR HARD WALL
- 6. ALL JOIST SHALL BE DESIGNED FOR A BOTTOM CHORD APPLIED 5 PSF COLLATERAL GRAVITY LOAD. THIS LOAD HAS BEEN INCLUDED IN THE JOIST SELECTION.
- 7. CONTRACTOR TO VERIFY SIZE, WEIGHT, & LOCATION OF RTU PRIOR TO ERECTING STEEL JOISTS. RTU & CURB MUST BE SUPPORTED BY JOISTS. LOCATE JOISTS TO SUPPORT RTU PER FINAL MEP PLAN. SEE DETAIL 18/S9.1 FOR TYP JOIST REINFORCING AT CONCENTRATED LOADS & 4/S9.2 FOR TYPICAL RTU SUPPORT.
- 8. CONTRACTOR TO VERIFY SIZE AND LOCATION OF ALL ROOF PENETRATIONS. PROVIDE STEEL ANGLE FRAMES PER DETAILS 16 & 17 ON SHEET S9.1.



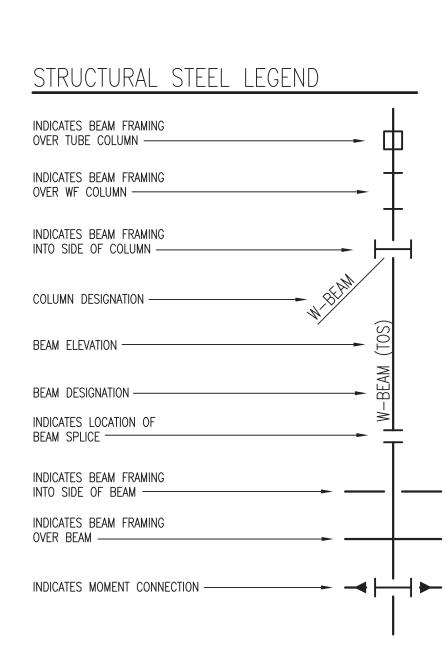

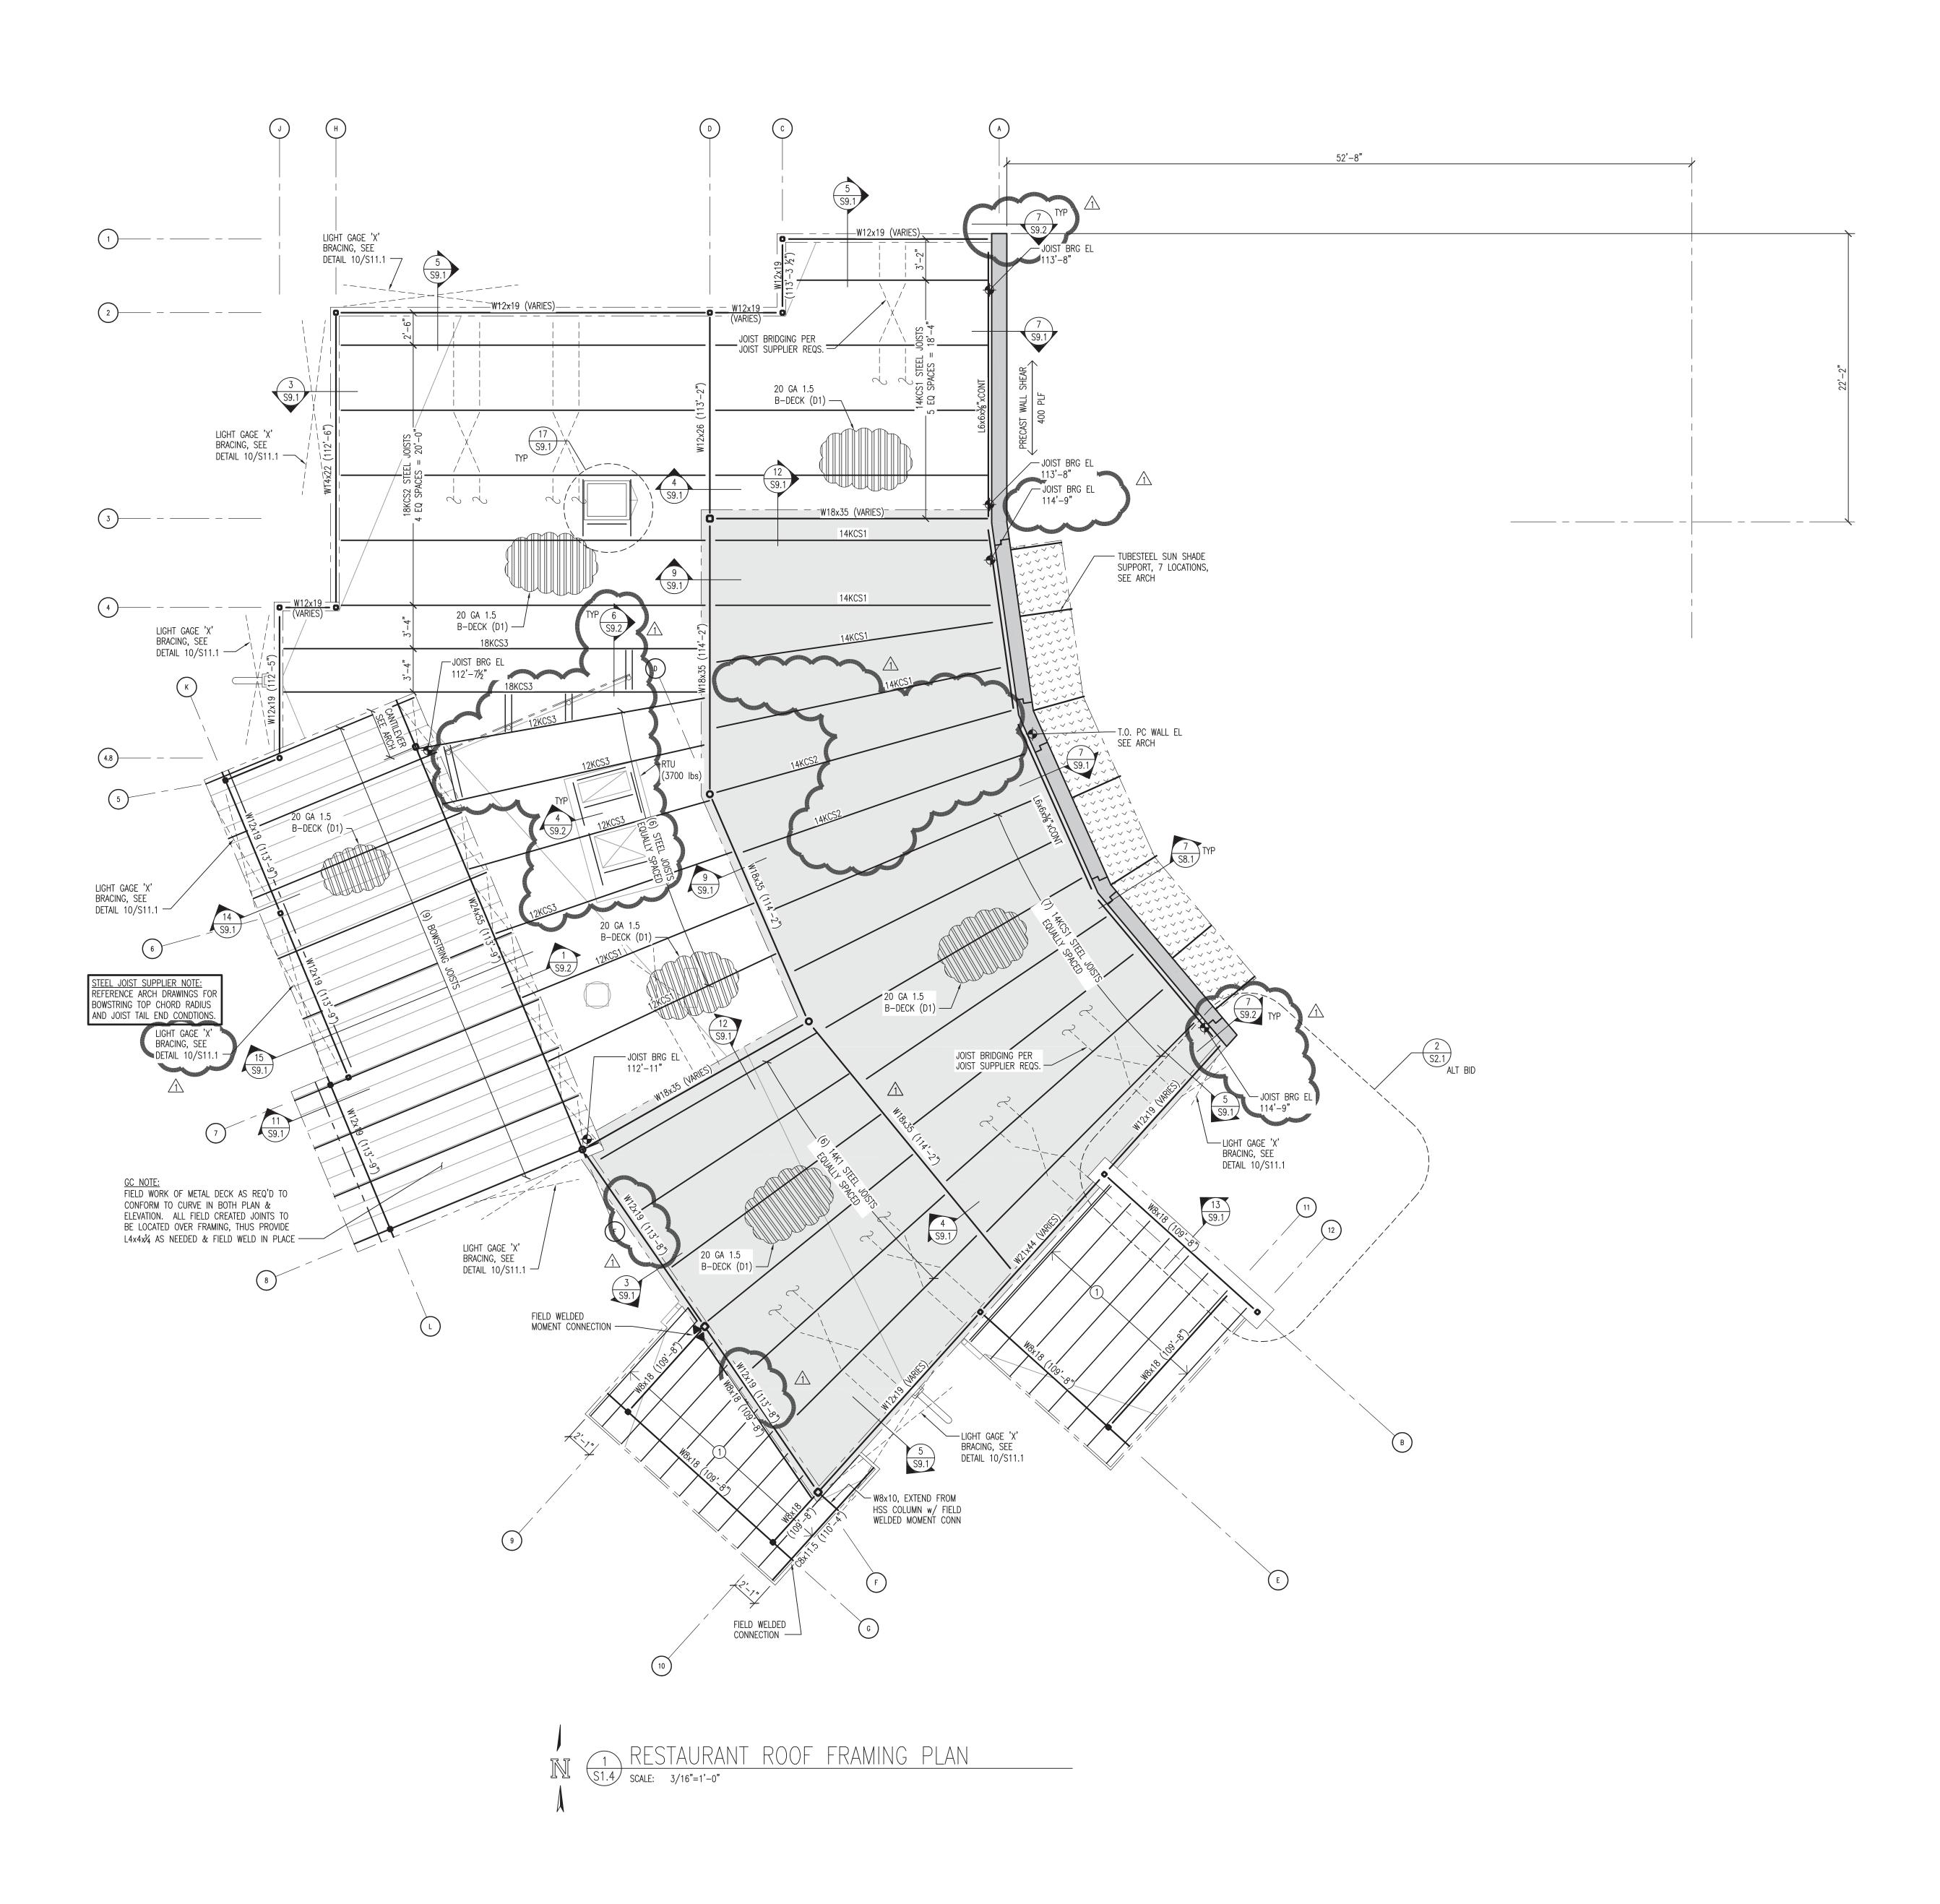



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Zoo - County of Dane

Department of Public No. 1919 Alliant Energy Cente

Henry Vilas Zoo

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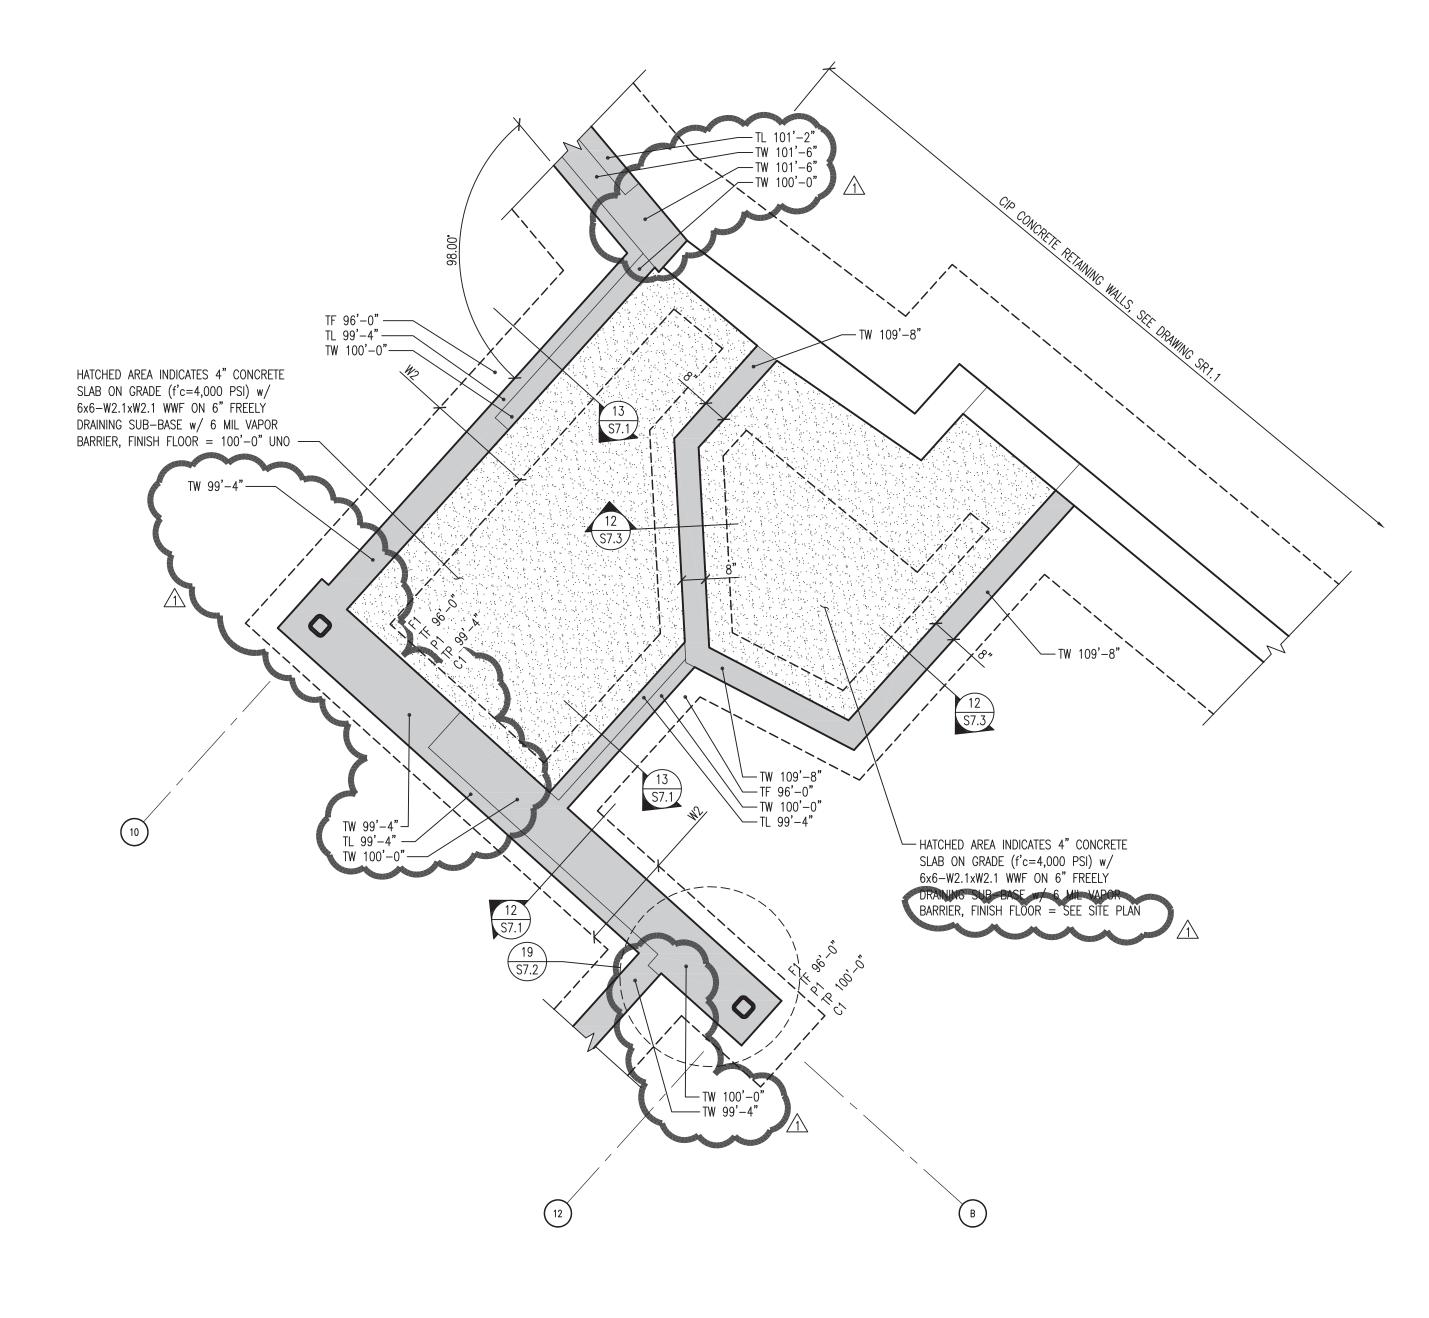
WDM No. drawn: MI
13046 checked: MI

RESTURANT ROOF
FRAMING PLAN


**S1.2** 

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- 1. SEE SHEET S001 FOR ADDITIONAL NOTES.
- 2. 1 800S162-68 COLD FORM ROOF JOISTS @ 24"oc w/ 20 GA 1.5 B-DECK (D1)
- 3. 2 8" CAST-IN-PLACE STEEL REINFORCED SLAB



1 DEN FOUNDATION PLAN S2.1 SCALE: 3/8"=1'-0"

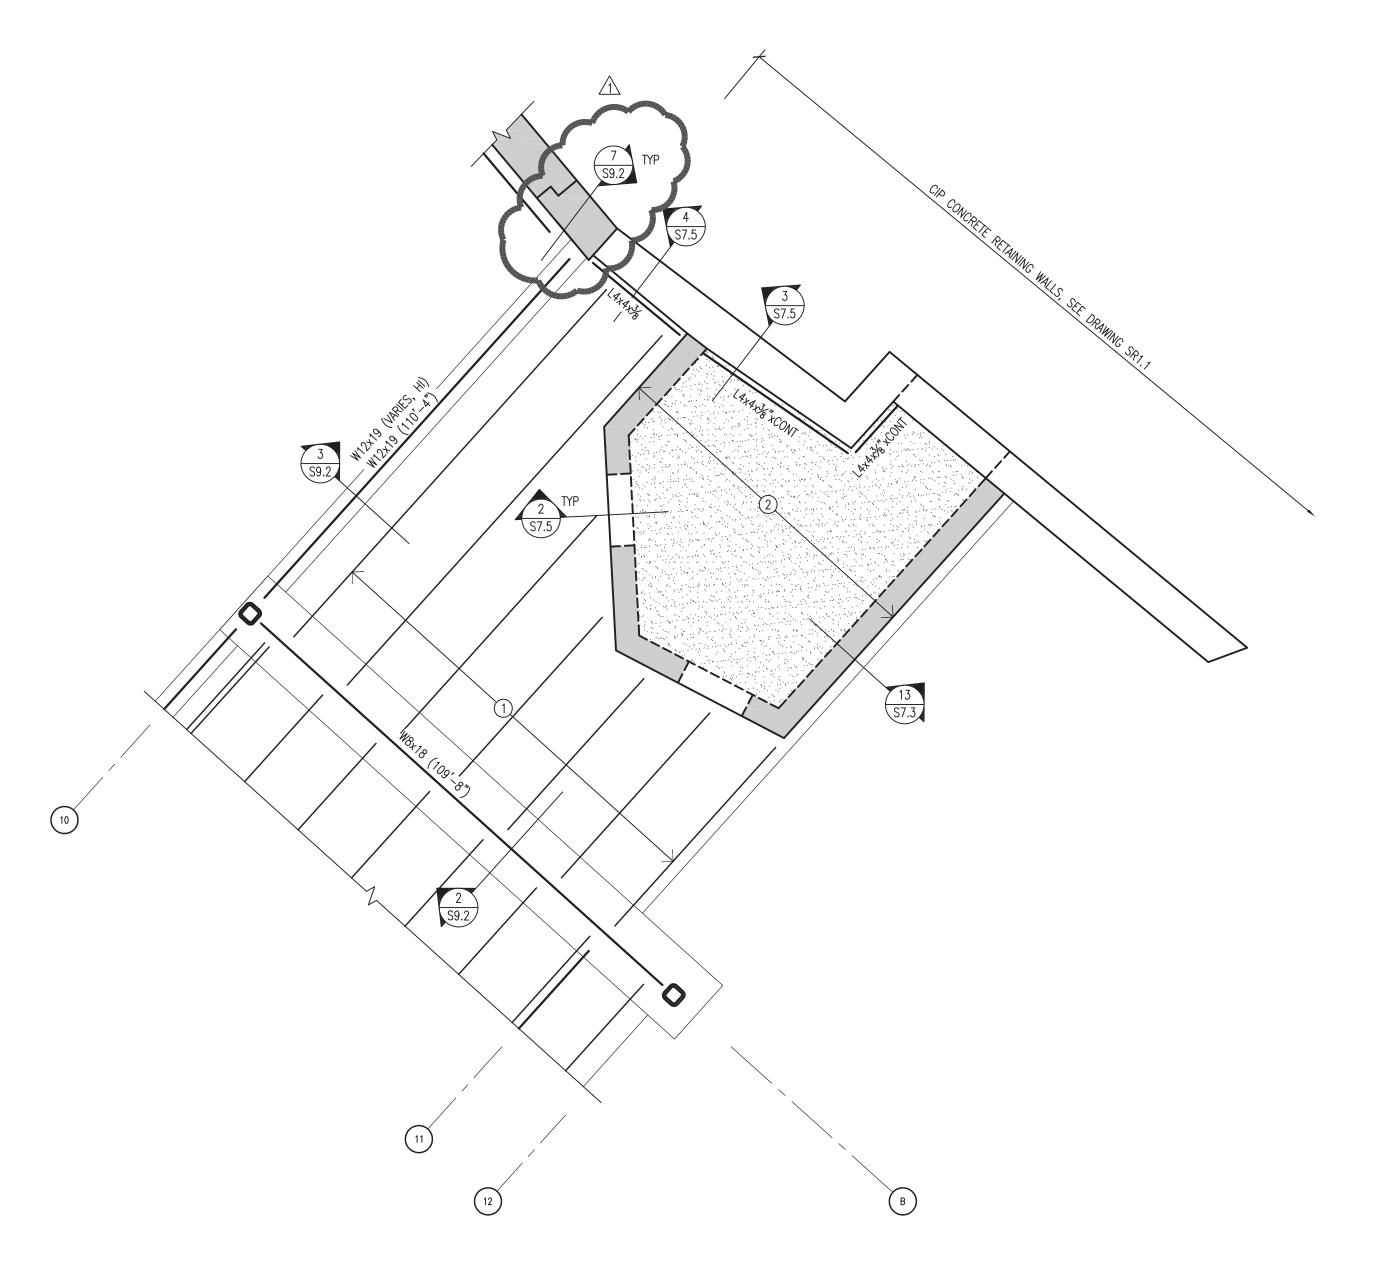

2 DEN ROOF FRAMING PLAN S2.1) SCALE: 3/8"=1'-0"

STRUCTURAL ENGINEERS, LLC

583 D'onofrio Drive, Sulte 201

Madison, Wi 53719

Fax: 608-821-4770
Fax: 608-821-4780



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13046 checked: MP2

DEN FOUNDATION PLAN
DEN ROOF FRAMING PLAN

**S2.1** 


- 1. SEE SHEET S.01 FOR ADDITIONAL NOTES.
- 2. SEE SHEET S7.1 DETAIL 1 FOR ANCHOR BOLT REQUIREMENTS. 3. SEE SHEET S7.1 DETAILS 2 & 3 FOR FOOTING & FOUNDATION
- WALL CORNER REINFORCING.
- 4. SEE SHEET S7.1 DETAILS 4 & 5 FOR ADDED REINFORCING AT ROUND & RECTANGULAR OPENINGS.
- 5. PROVIDE 2-#4 BARS AT ALL DEAD ENDS & REENTRANT CORNERS. SEE DETAIL 6/S7.1.
- 6. SLAB CONTROL JOINTS SHALL BE AS SHOWN ON PLAN OR SIMILAR. JOINT SPACING SHALL NOT EXCEED 10'-0" O.C. SLAB JOINT ASPECT RATIO SHALL NOT EXCEED 1.5:1. SEE DETAIL 7/S7.1.
- 7. SEE SHEET S7.1 DETAIL 8 FOR WALL JOINT REQUIREMENTS.
- 8. SITE PLAN DATUM ELEATION: 114.30' = 100'-0"
- 9. SLOPE DRAIN AND MAINTAIN MINIMUM THICKNESS SHOWN. SEE A3.1 FOR FLOOR ELEVATIONS.
- 10. SEE ARCH FOR ALL WALL OPENING LOCATIONS & DIMENSIONS.
- 11. SEE A3.1 FOR WALL OPENING DETAILS NOT SPECIFICALLY SHOWN ON THIS SHEET.
- 12. ALL BACKFILL AT FOUNDATION WALLS WITH UNBALANCED FILL LEVELS MUST BE GRANULAR BACKFILL APPROVED BY THE GEOTECHNICAL ENGINEER TO NOT EXCEED LOADS ASSUMED ON SHEET 0.1.


#### FOUNDATION LEGEND


TOUNDATION LEGEND	_	_	_
CONCRETE FOOTING — CONCRETE PIER —	1		)
TOP OF PIER ELEVATION — TP=X'-X"		ノ 	
COLUMN GRID MARK — A			<u> </u>  -  -
COLUMN FOOTING MARK  (SEE FOUNDATION SCHEDULE)	-   )	κ'-	- X
TOP OF COLUMN FOOTING ELEVATION	. 1	> >	K
COLUMN PIER MARK (SEE PIER SCHEDULE)	$\prod$	T	T
CONCRETE WALL & FOOTING	Ш		į
TOP OF WALL FOOTING ELEVATION X'-X"	<b>9</b>		
TOP OF LEDGE ELEVATION — TL=X'-X"	+		į
TOP OF WALL ELEVATION — TW=X'-X"	#	•	<u>i</u> 
TOP OF PIER ELEVATION — TP=X'-X"			11111
FOOTING STEP X'-X"	$\downarrow$	ŀ	<u> </u>  -
FOOTING DIMENSION — WXD	1		į
EXPANSION JOINT-SEE NOTES FOR WALL CONTROL JOINT SPACING	1	<u> </u>	"  -  -
			1

#### PRECAST FRAMING NOTES

- 1. SEE SHEET SO.1 FOR ADDITIONAL PRECAST REQUIREMENTS AND ENVIRONMENTAL LOADING REQUIREMENTS.
- 2. STYLE OF PRECAST WALLS (SANDWICH PANEL OR INSULATED CORES) SHOWN AS CONCEPTUAL ONLY. ALL PRECAST WALL PANELS SHALL HAVE ARCHITECTURAL FINISH AND "R" INSULATION VALUES AS SPECIFIED BY
- 3. PRECAST WYTHES EXPOSED TO ANIMAL ACTIVITY SHALL BE RIGID ENOUGH TO NOT CRACK WHEN ANIMAL LOADS ARE APPLIED (SEE NOTE 6 BELOW FOR LOADS).
- 4. ALL PRECAST WALL PANELS EXPOSED TO ANIMAL ACTIVITY SHALL BE DESIGNED FOR ENVIRONMENTAL LOADS SHOWN ON SHEET SO.1 AND FOR (2) 2.0k IMPACT POINT LOADS APPLIED OVER A 0.5 SQ-FT AREA AT 2'-0" APART AT ANY LOCATION IN THE BOTTOM 12'-0" ON THE EXTERIOR
- 5. PRECAST WALL SHALL BE DESIGNED AS SHEAR WALLS TO RESIST SOIL, WIND, SEISMIC FORCES PER PLAN.
- 6. PROVIDE FORM LINER PER ARCHITECTURAL PLANS.
- 7. ALL PRECAST WALLS TO EXTEND BELOW GRADE TO FOOTING TYP. CAGE WORK WITH PRECAST SUPPLIER AT ALL EXTERIOR DOORS AND ROO

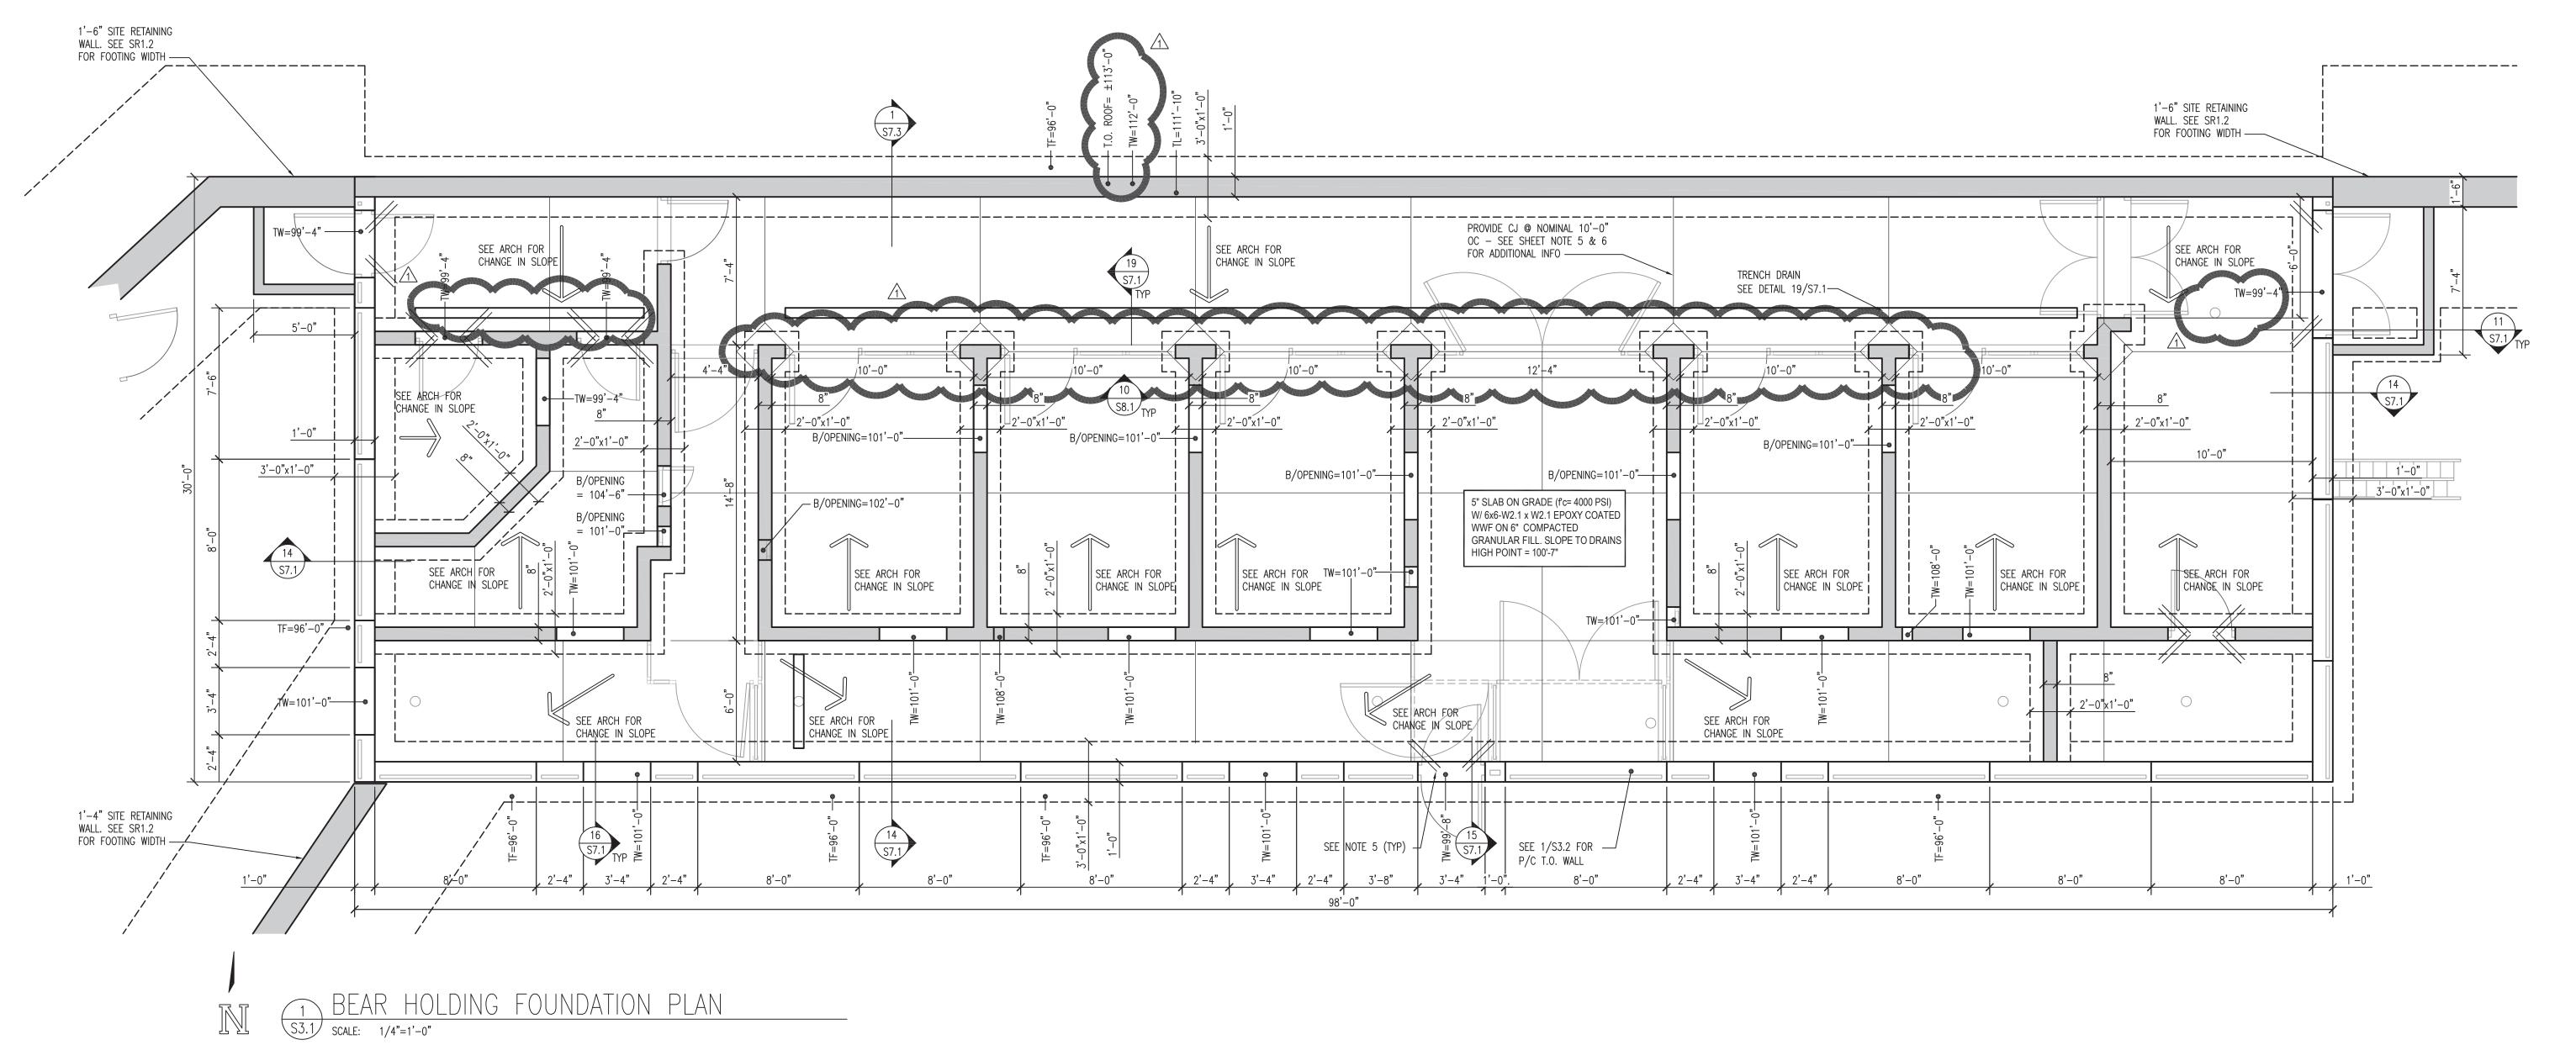

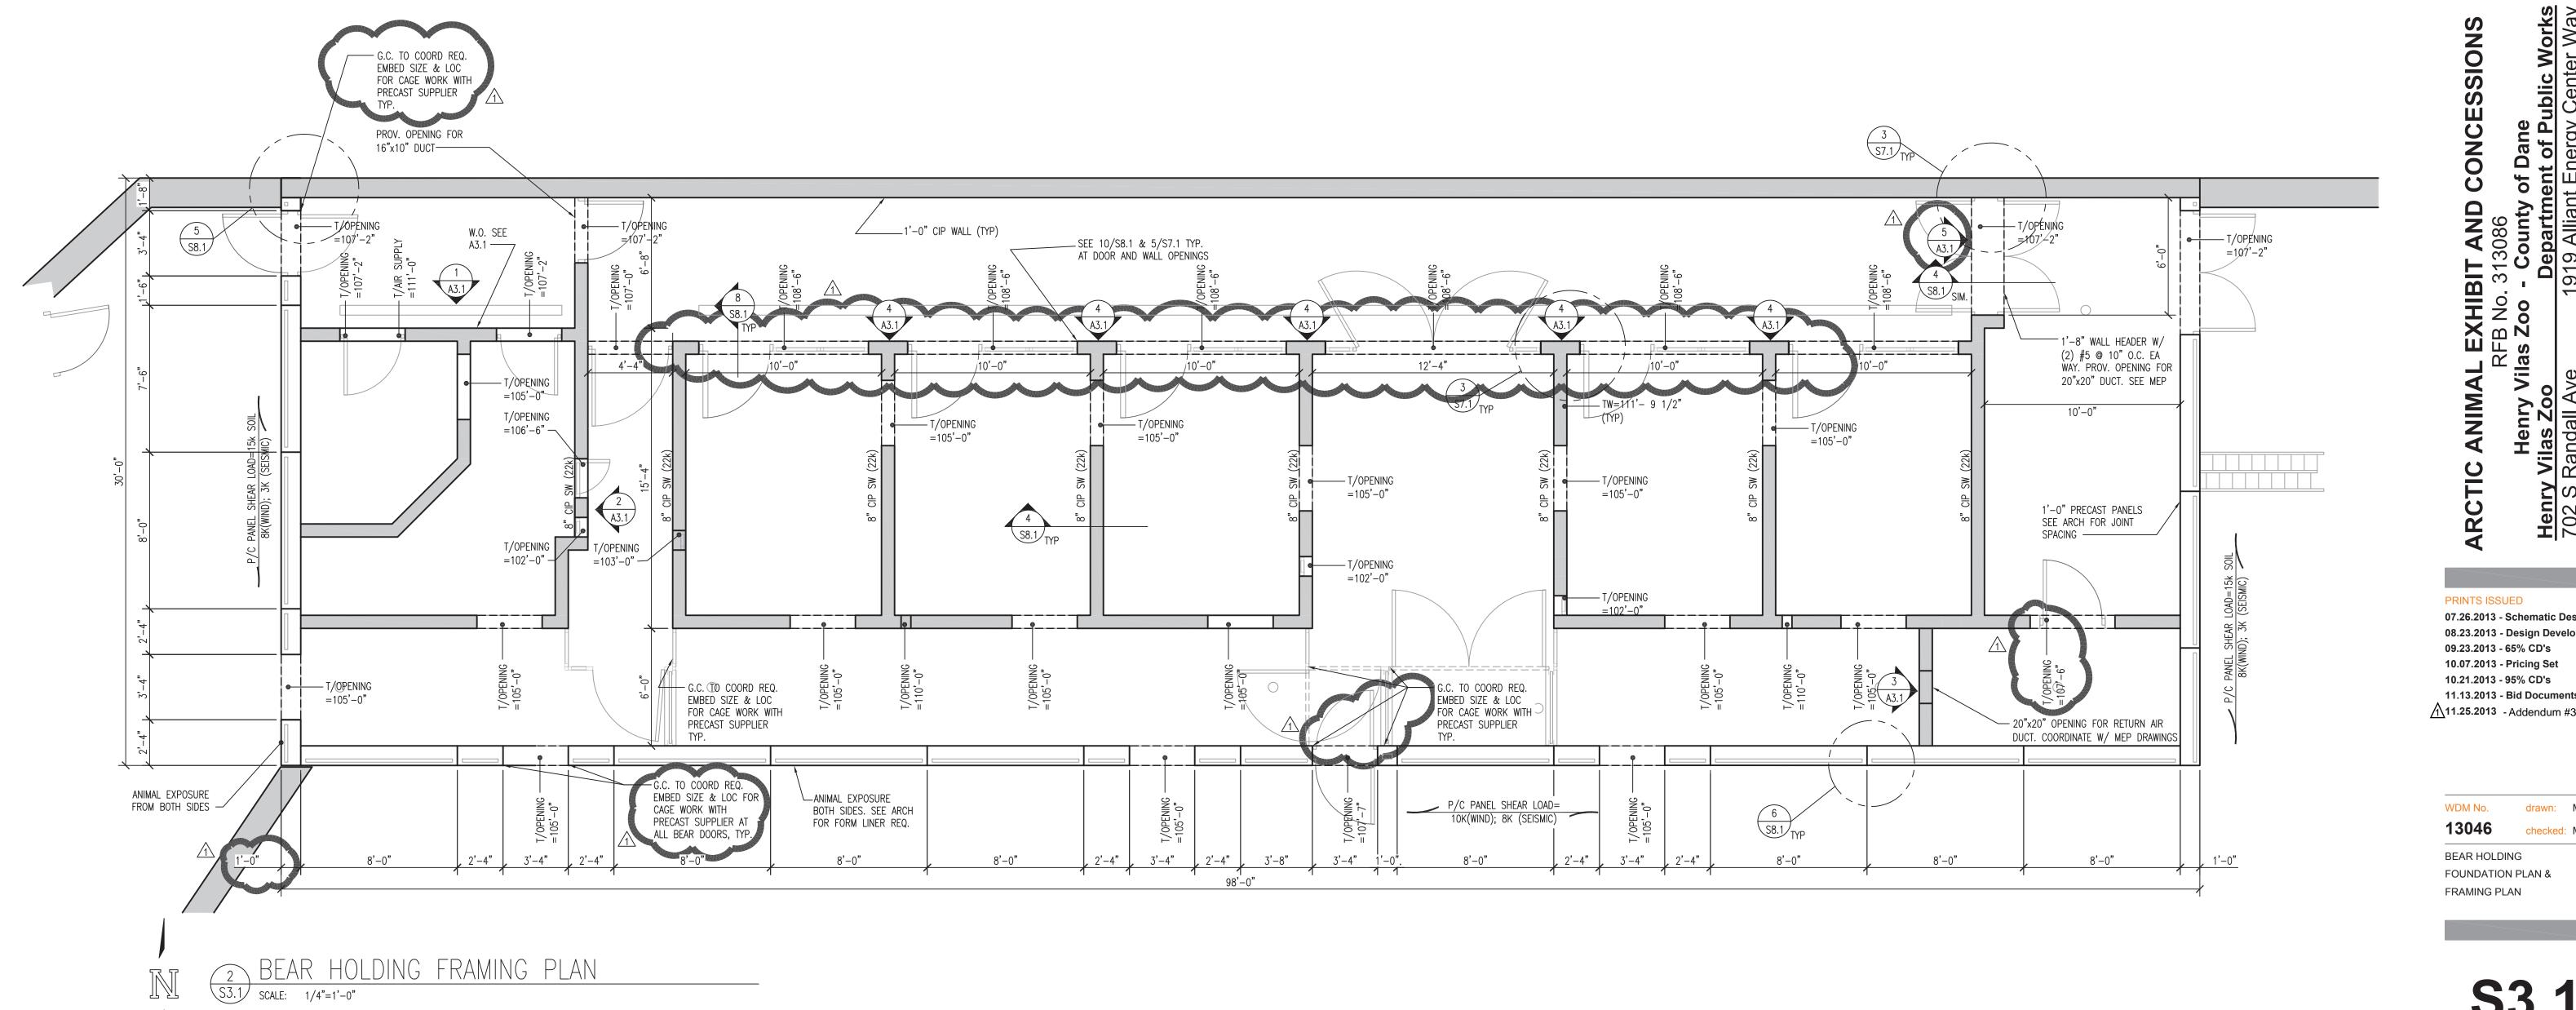

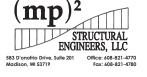




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WDM No. BEAR HOLDING FOUNDATION PLAN & FRAMING PLAN

**S3.1** 



TYP. ALONG EAST, WEST, & SOUTH WALLS

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 drawn:
 MP2
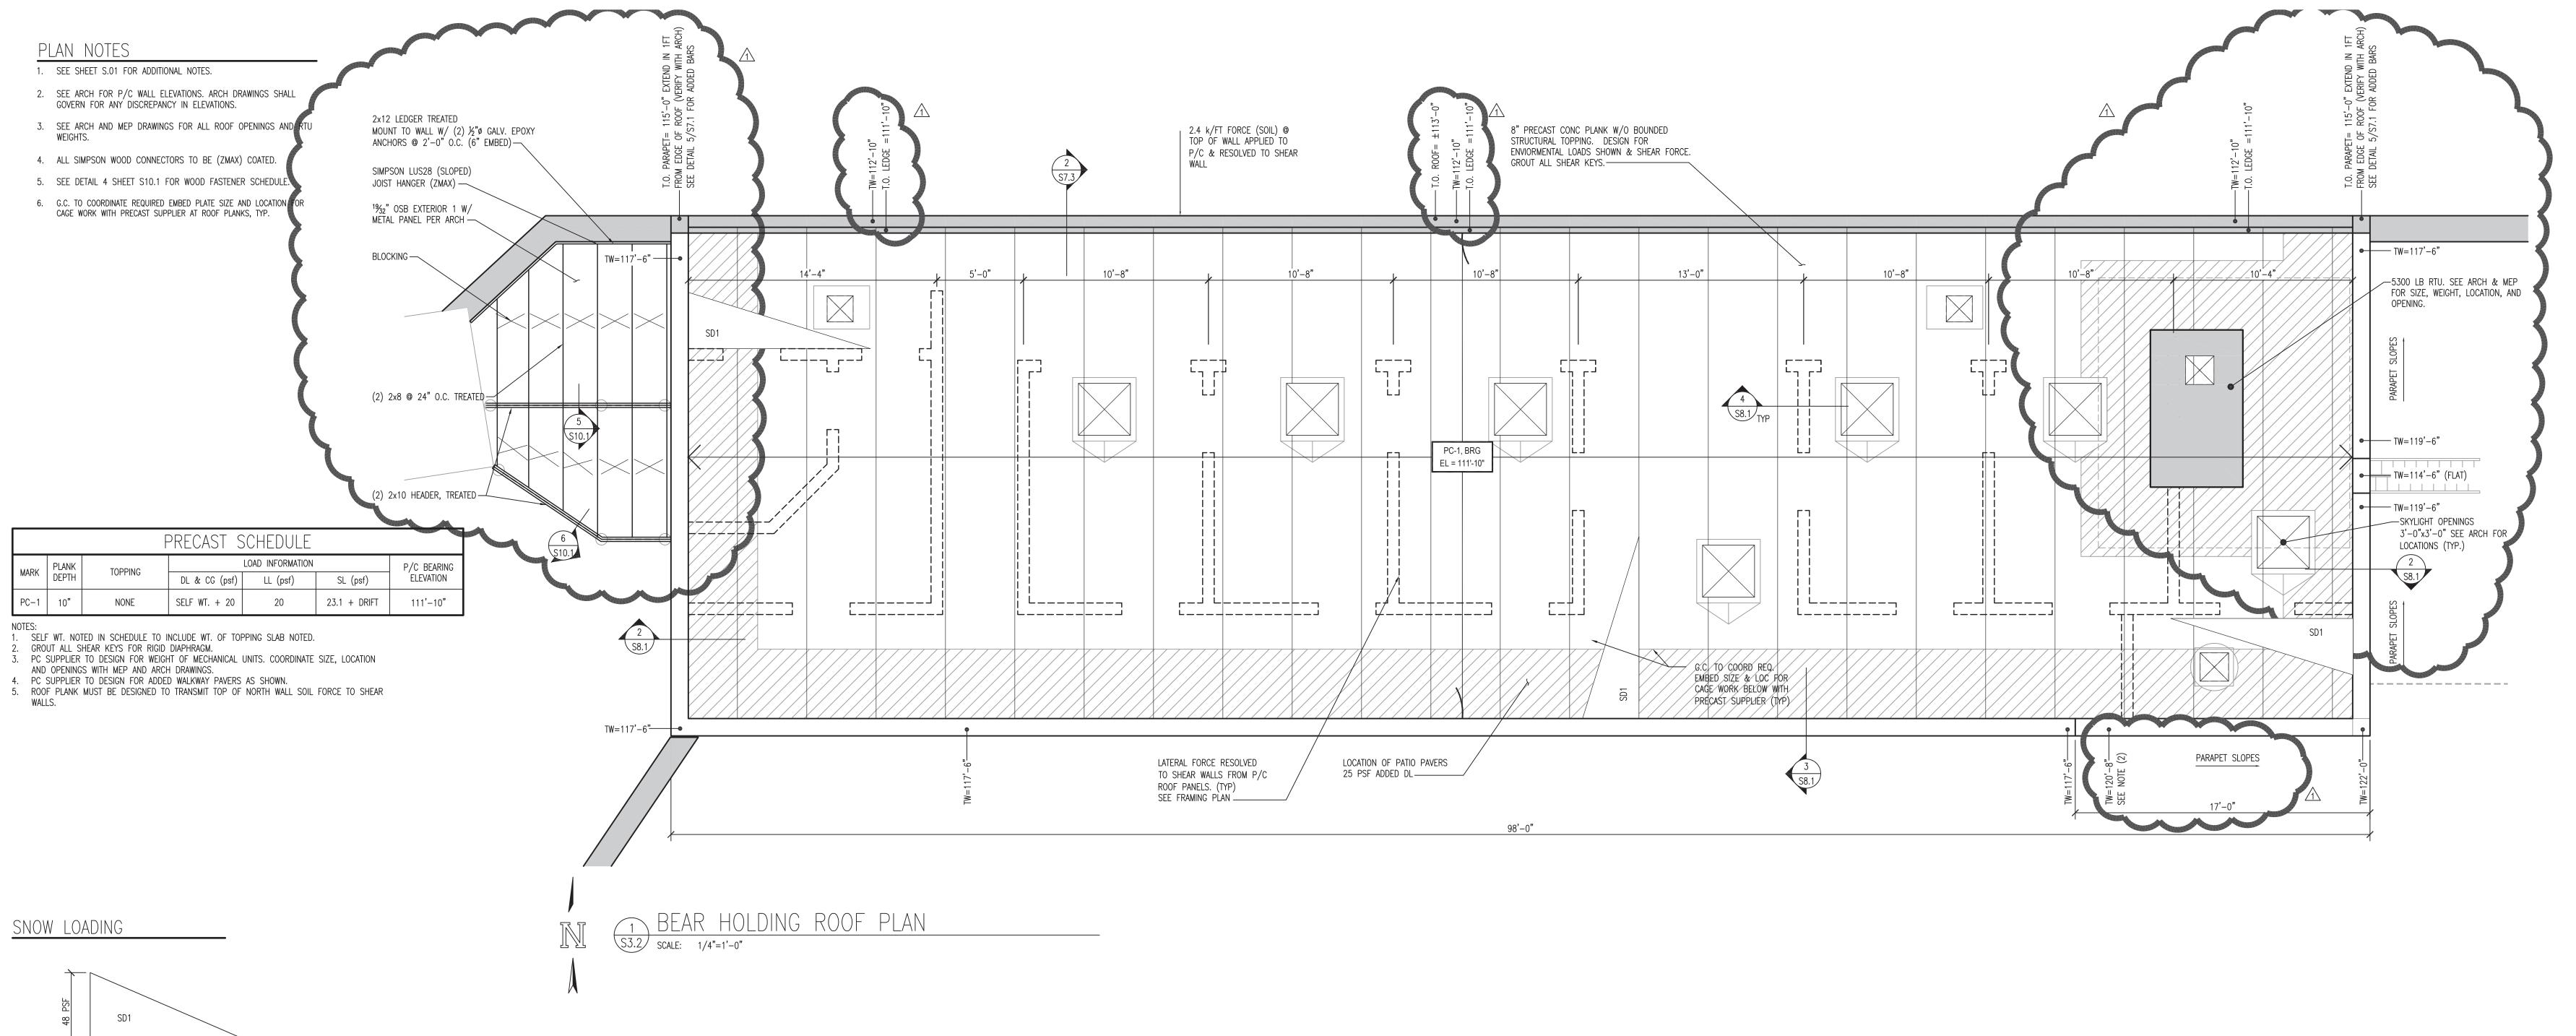
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 checked:
 MP2


BEAR HOLDING
ROOF FRAMING PLAN


S3.2

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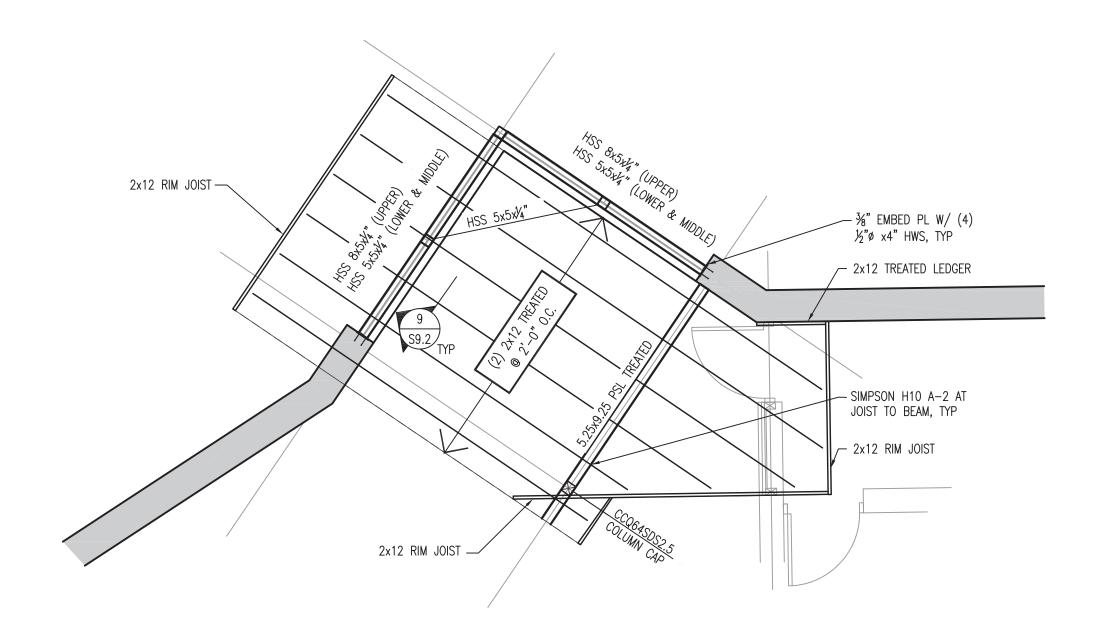


- 1. SEE SHEET S.01 FOR ADDITIONAL NOTES.
- 2. SEE ARCH FOR JOIST BEARING ELEVATION.
- 3. ROOF SHEATHING SHALL BE  $^{1}$ %<sub>2</sub>" APA RATED EXTERIOR GRADE. FASTEN TO FRAMING PER DETAIL 4 ON SHEET S10.1.
- 4. SEE DETAIL 4 SHEET S10.1 FOR WOOD FASTENER SCHEDULE.




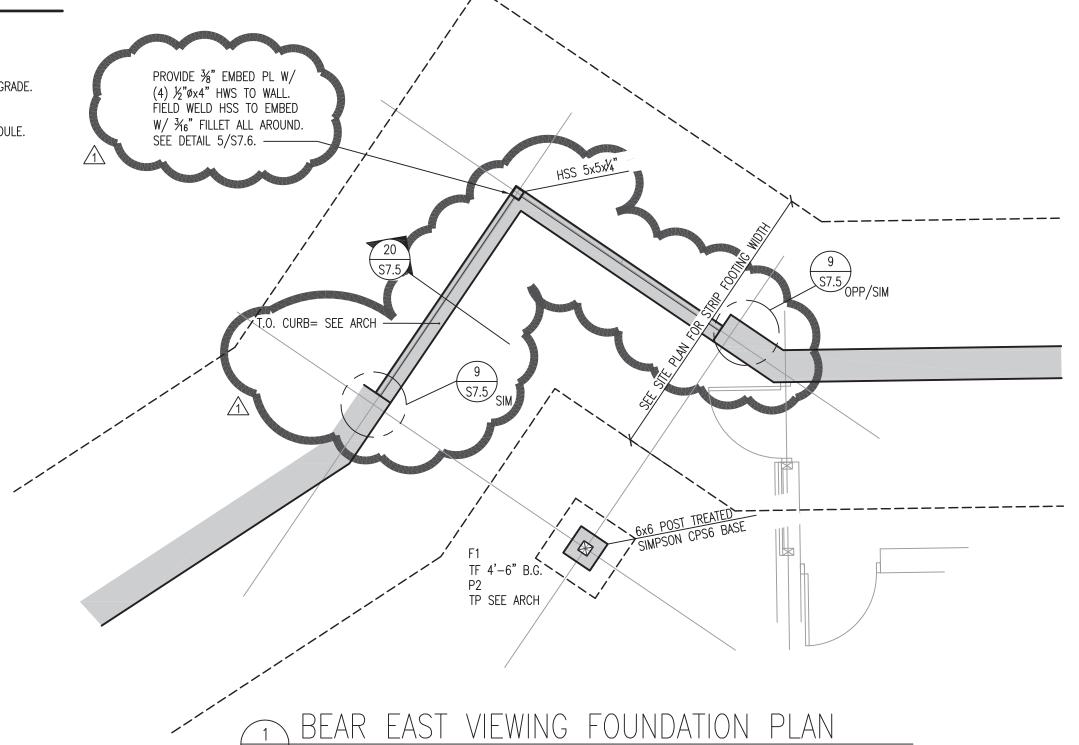

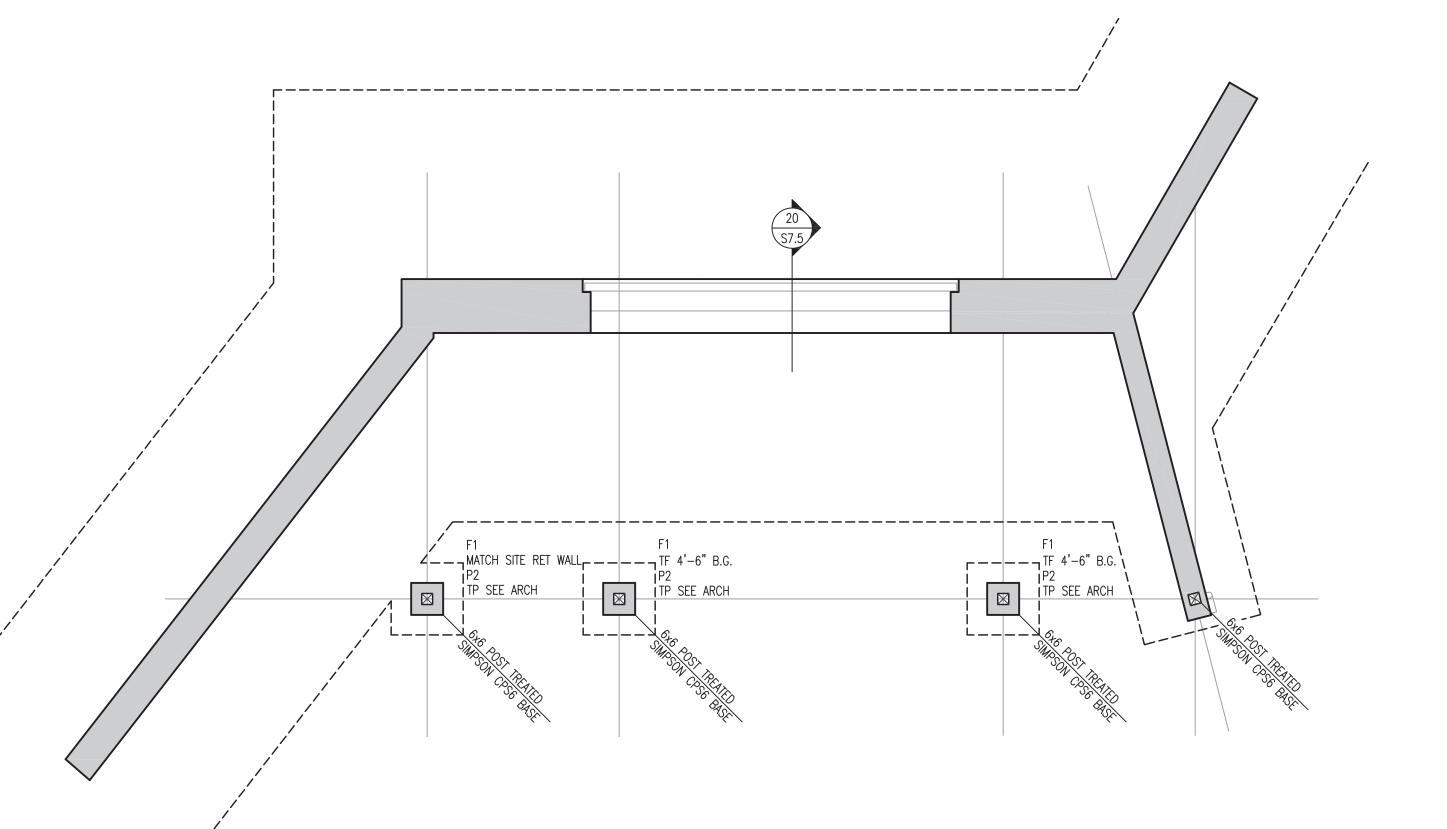
S4.1 SCALE: 1/4"=1'-0"




BEAR EAST VIEWING ROOF FRAMING PLAN

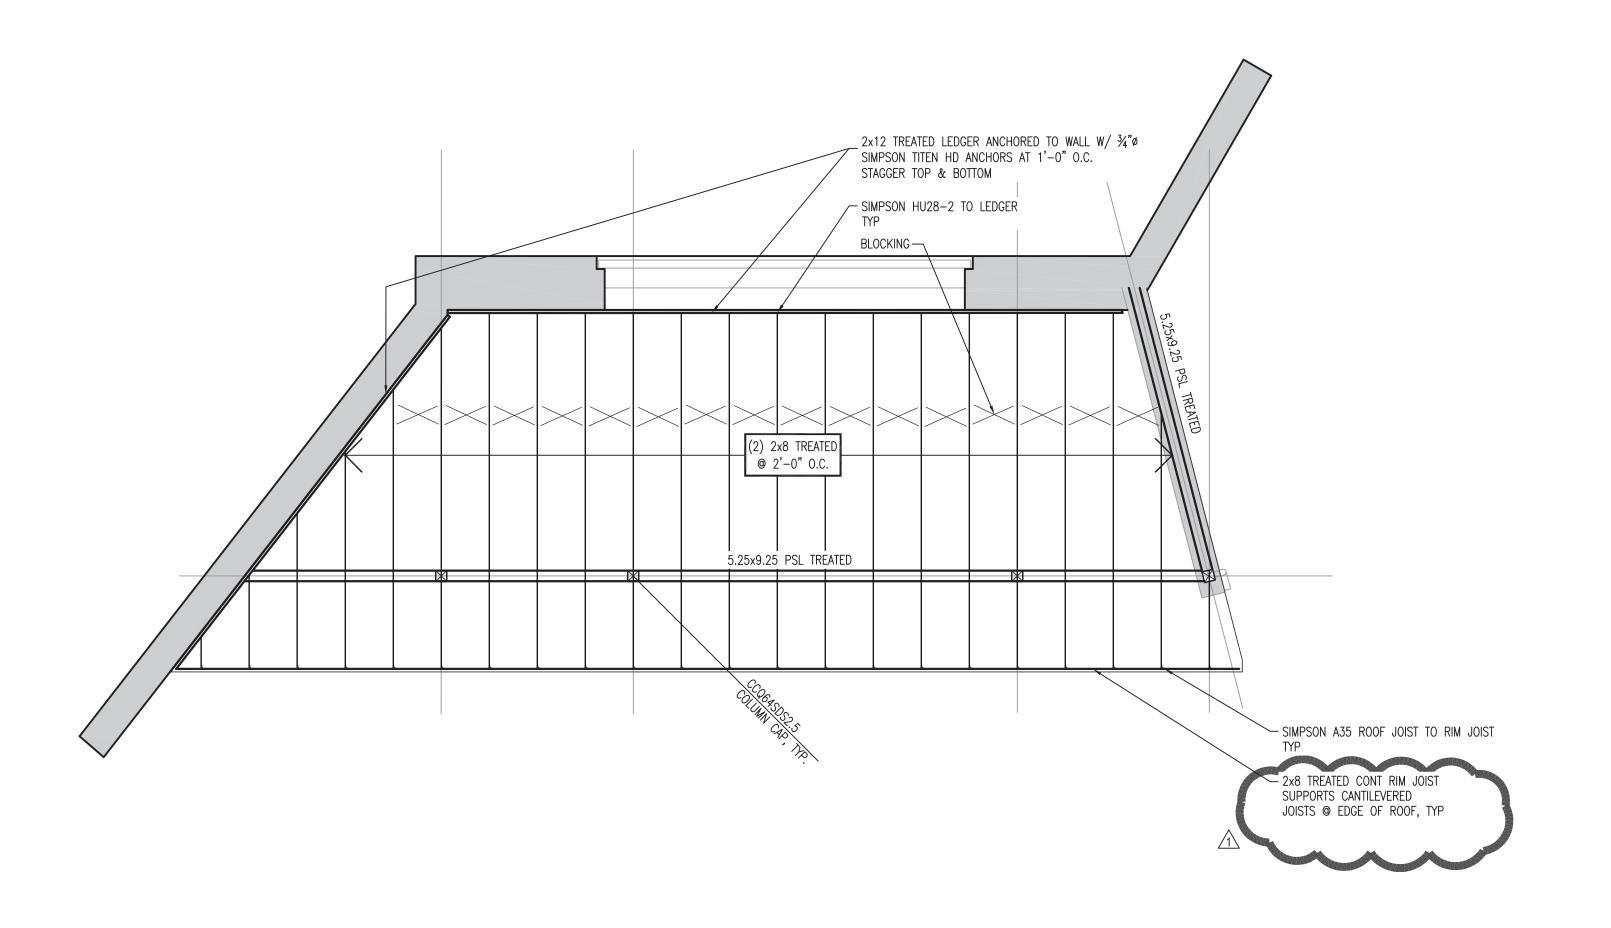


BEAR UNDERWATER VIEWING FOUNDATION PLAN S4.1) SCALE: 1/4"=1'-0" BEAR UNDERWATER VIEWING FOUNDATION PLAN S4.1 SCALE: 1/4"=1'-0"

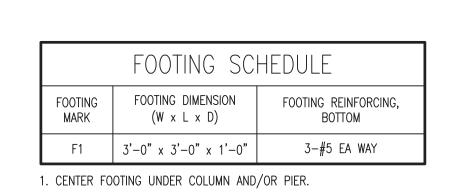

PIER SCHEDULE					
6	A	B	C	D	)
PIER MARK	PIER DIMENSION (W x L)		PIER REINFORCING	G	TYPE
P2	16"x16"	4-#6 W	S VERT W/ #3 TIES 1/ (3) #3 TIES IN TO	@ 10"0C OP 8"	Α

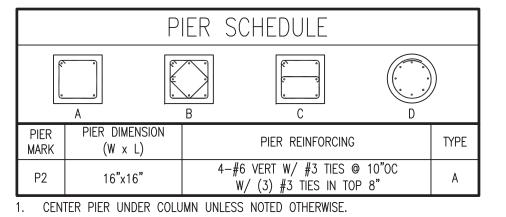


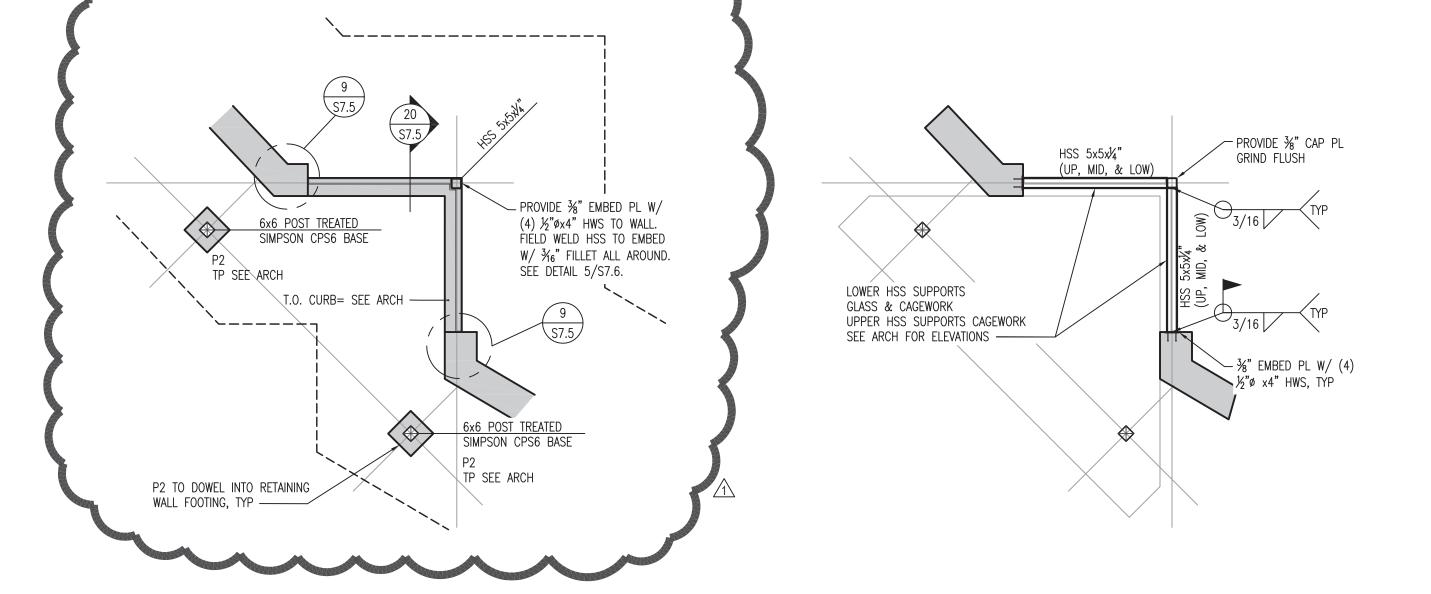

BEAR WEST VIEWING FOUNDATION PLAN

S4.1 SCALE: 1/4"=1'-0"



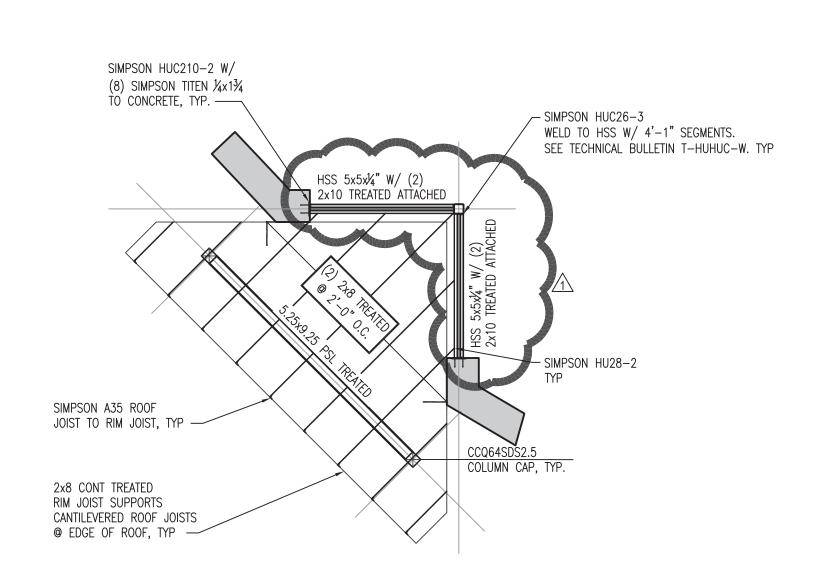

7 BEAR WEST VIEWING ROOF FRAMING PLAN
S4.1 SCALE: 1/4"=1'-0"






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WDM No. drawn: MP2 BEAR VIEWING FOUNDATION PLANS & FRAMING PLANS

**S4.1** 



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BEAR VIEWING & TRAINING FOUNDATION PLANS & FRAMING PLANS

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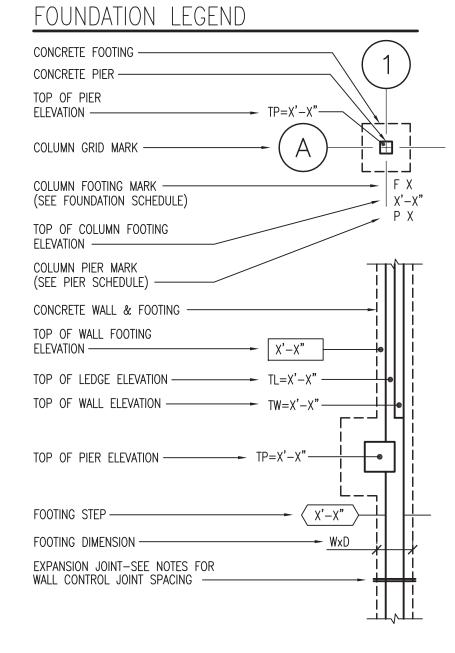
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- 1. SEE SHEET S.01 FOR ADDITIONAL NOTES.
- 2. SEE SHEET S7.1 DETAIL 1 FOR ANCHOR BOLT REQUIREMENTS.
- 3. SEE SHEET S7.1 DETAILS 2 & 3 FOR FOOTING & FOUNDATION WALL CORNER REINFORCING.
- 4. SEE SHEET S7.1 DETAILS 4 & 5 FOR ADDED REINFORCING AT ROUND & RECTANGULAR OPENINGS.
- 5. PROVIDE 2-#4 BARS AT ALL DEAD ENDS & REENTRANT CORNERS. SEE DETAIL 6/S7.1.
- 6. SLAB CONTROL JOINTS SHALL BE AS SHOWN ON PLAN OR SIMILAR. JOINT SPACING SHALL NOT EXCEED 10'-0" O.C. SLAB JOINT ASPECT RATIO SHALL NOT EXCEED 1.5:1. SEE DETAIL 7/S7.1.
- 7. SEE SHEET S7.1 DETAIL 8 FOR WALL JOINT REQUIREMENTS.
- 8. SITE PLAN DATUM ELEVATION: 114.00' = 100'-0"
- 9. SLOPE SLAB TO DRAINS. MAINTAIN SLAB THICKNESS.
- 10. ALL FLOOR BARS AND WWF IN SEAL HOLDING AREA AND ALL WALL REINFORCEMENT SURROUNDING POOLS SHALL BE EPOXY COATED (WHETHER SHOWN OR NOT SHOWN IN DETAILS).

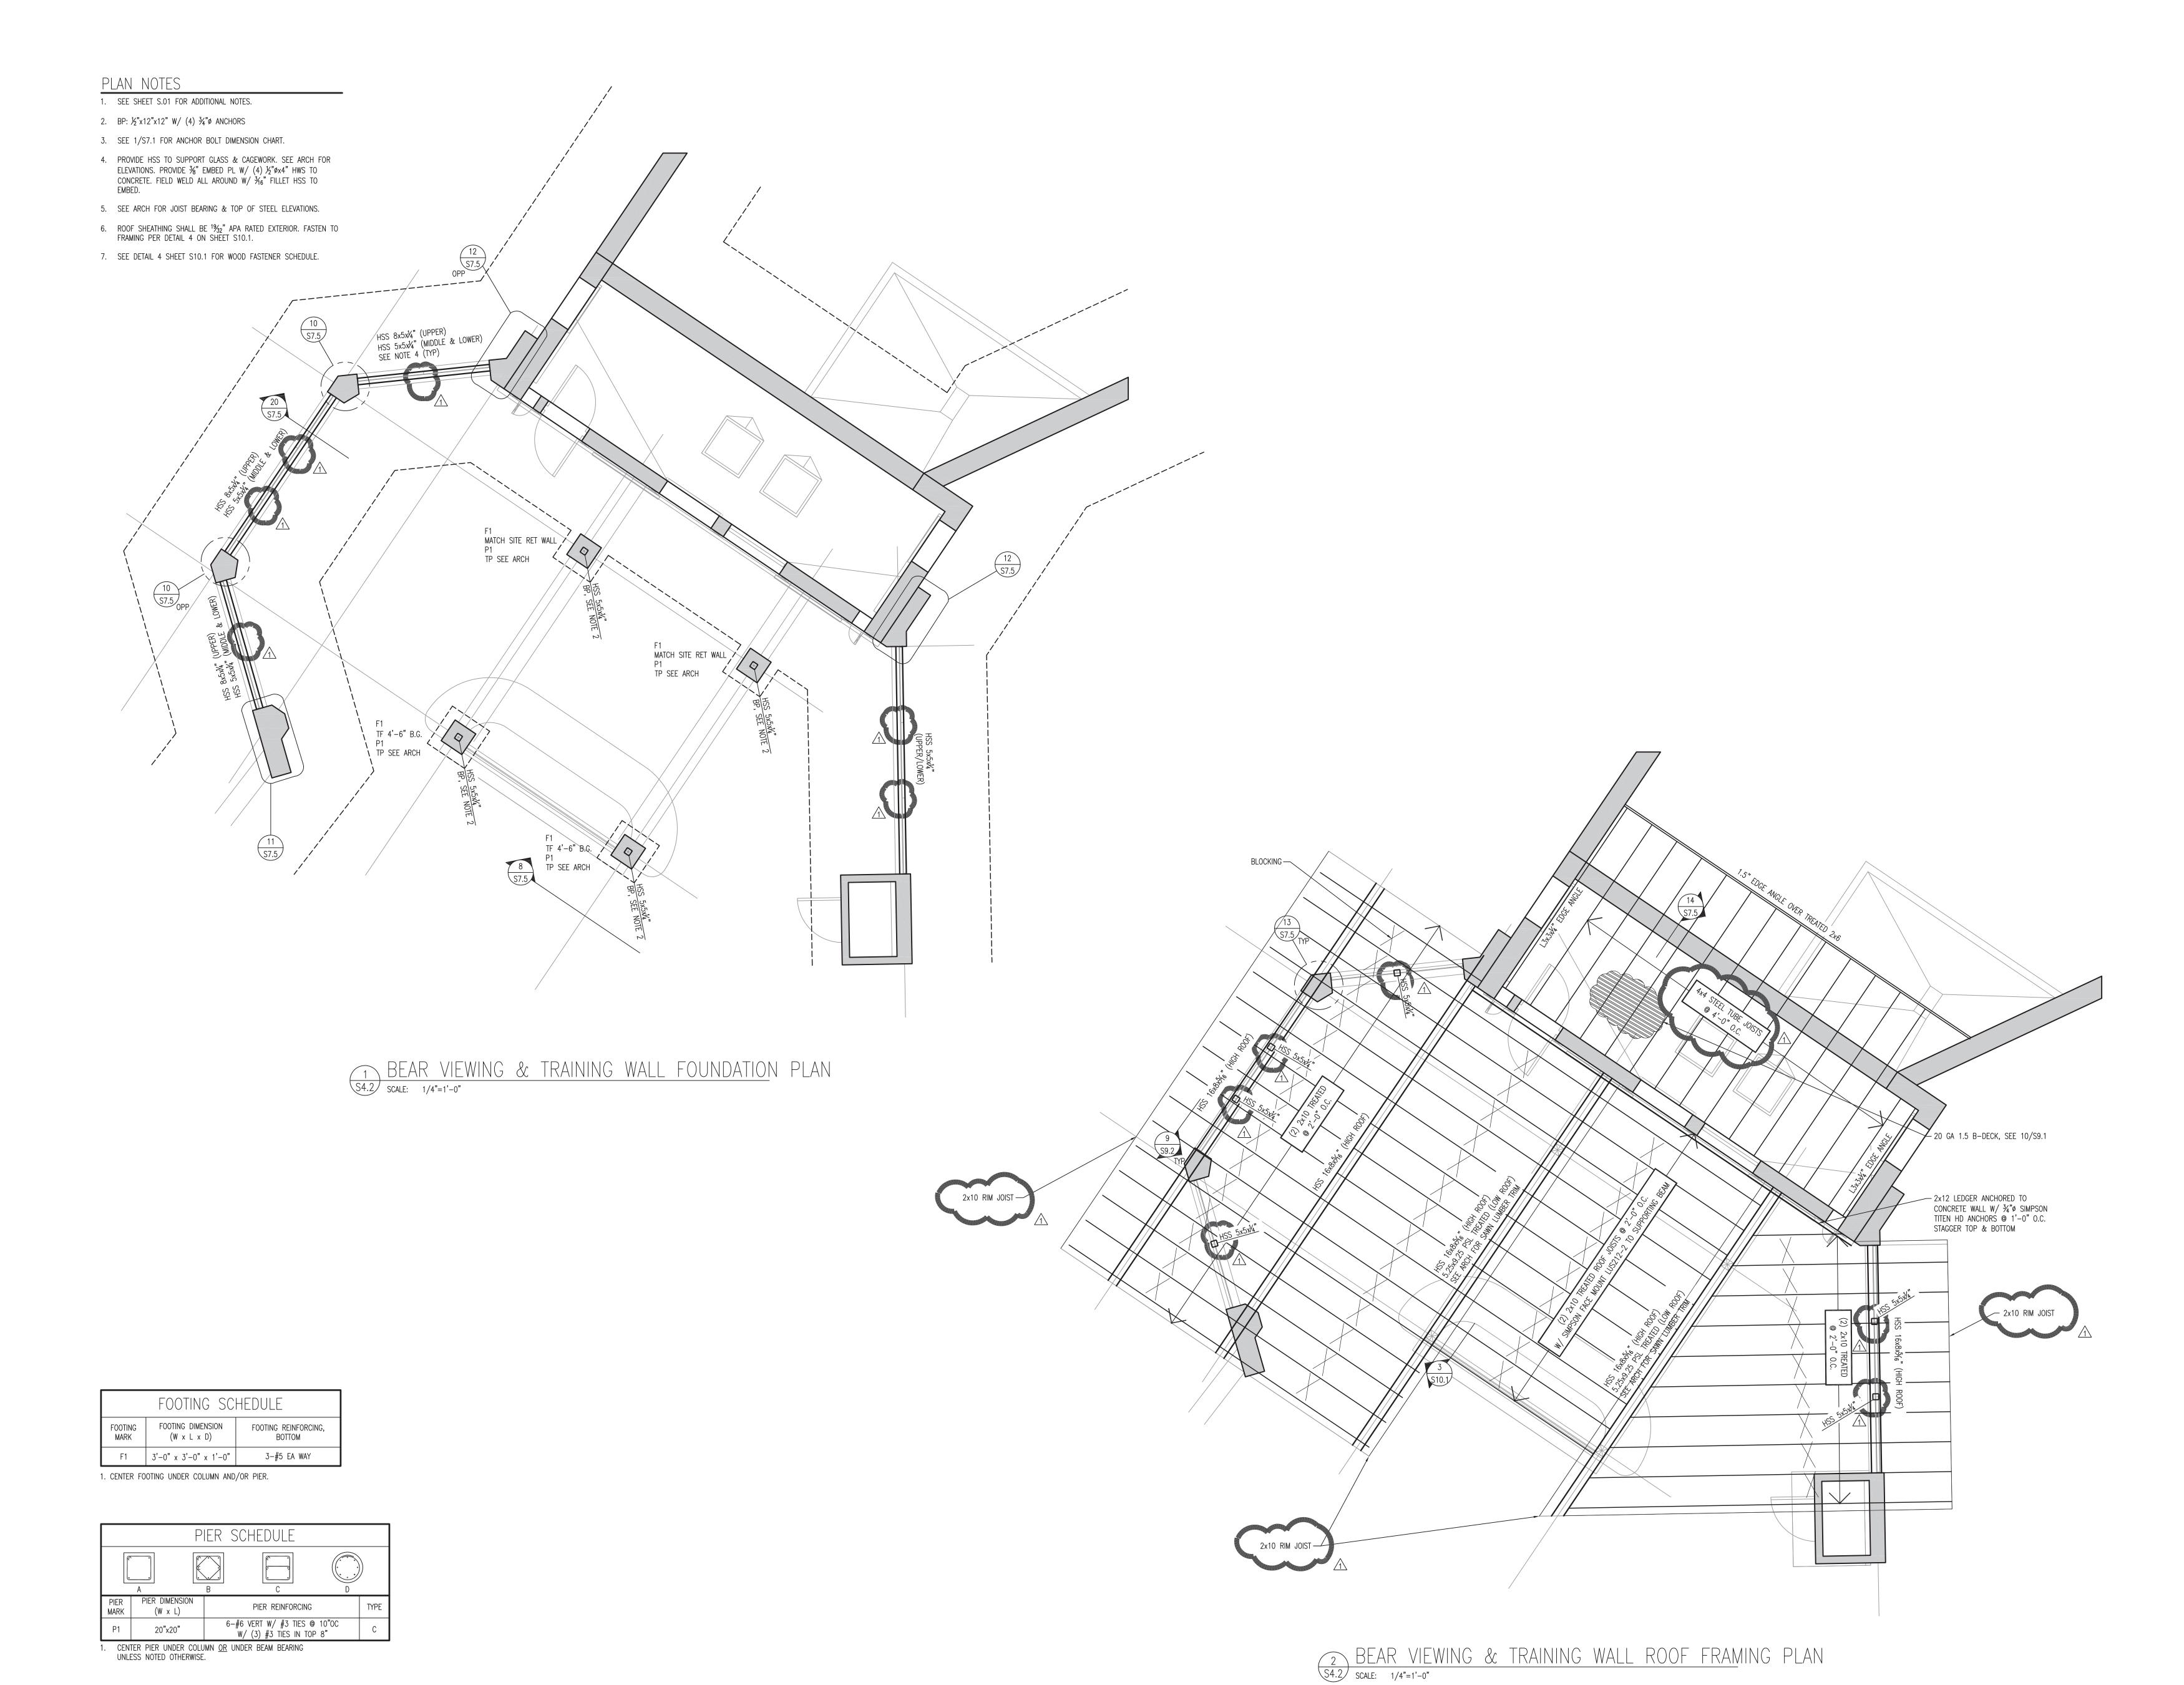SEE A-DRAWINGS FOR ALL DOOR AND INTERIOR WALL DIMENSIONS.
 G.C. TO COORDINATE REQ. EMBED SIZE & LOC FOR CAGE WORK WITH PRECAST SUPPLIER AT ALL NOTED DOORS, TYP.

FOOTING SCHEDULE					
FOOTING FOOTING DIMENSION (W x L x D)		FOOTING REINFORCING, BOTTOM			
F1	3'-0" x 3'-0" x 1'-0"	4-#5 EA WAY			

CENTER FOOTING UNDER COLUMN AND/OR PIER.



	PRECAST SCHEDULE					
IARK	PLANK DEPTH	1 10001816:	LOAD INFORMATION			P/C BEARING
			DL (psf)	LL (psf)	SL (psf)	ELEVATION
PC-1	8"	NONE	SELF WT. + 10	125	NONE	101'-8 ½"


NOTES:


1. SELF WT. NOTED IN SCHEDULE TO INCLUDE WT. OF TOPPING SLAB NOTED.

2. GROUT ALL SHEAR KEYS AND TOOL SMOOTH

PRECAST PLANK LOAD SCHEDULE					
MARK	DEAD LOAD (plf)	LIVE LOAD (plf)	SNOW LOAD (plf)		
LL1	600	NONE	NONE		

NOTES: 1. ALL LOADS ARE SERVICE LOADS.

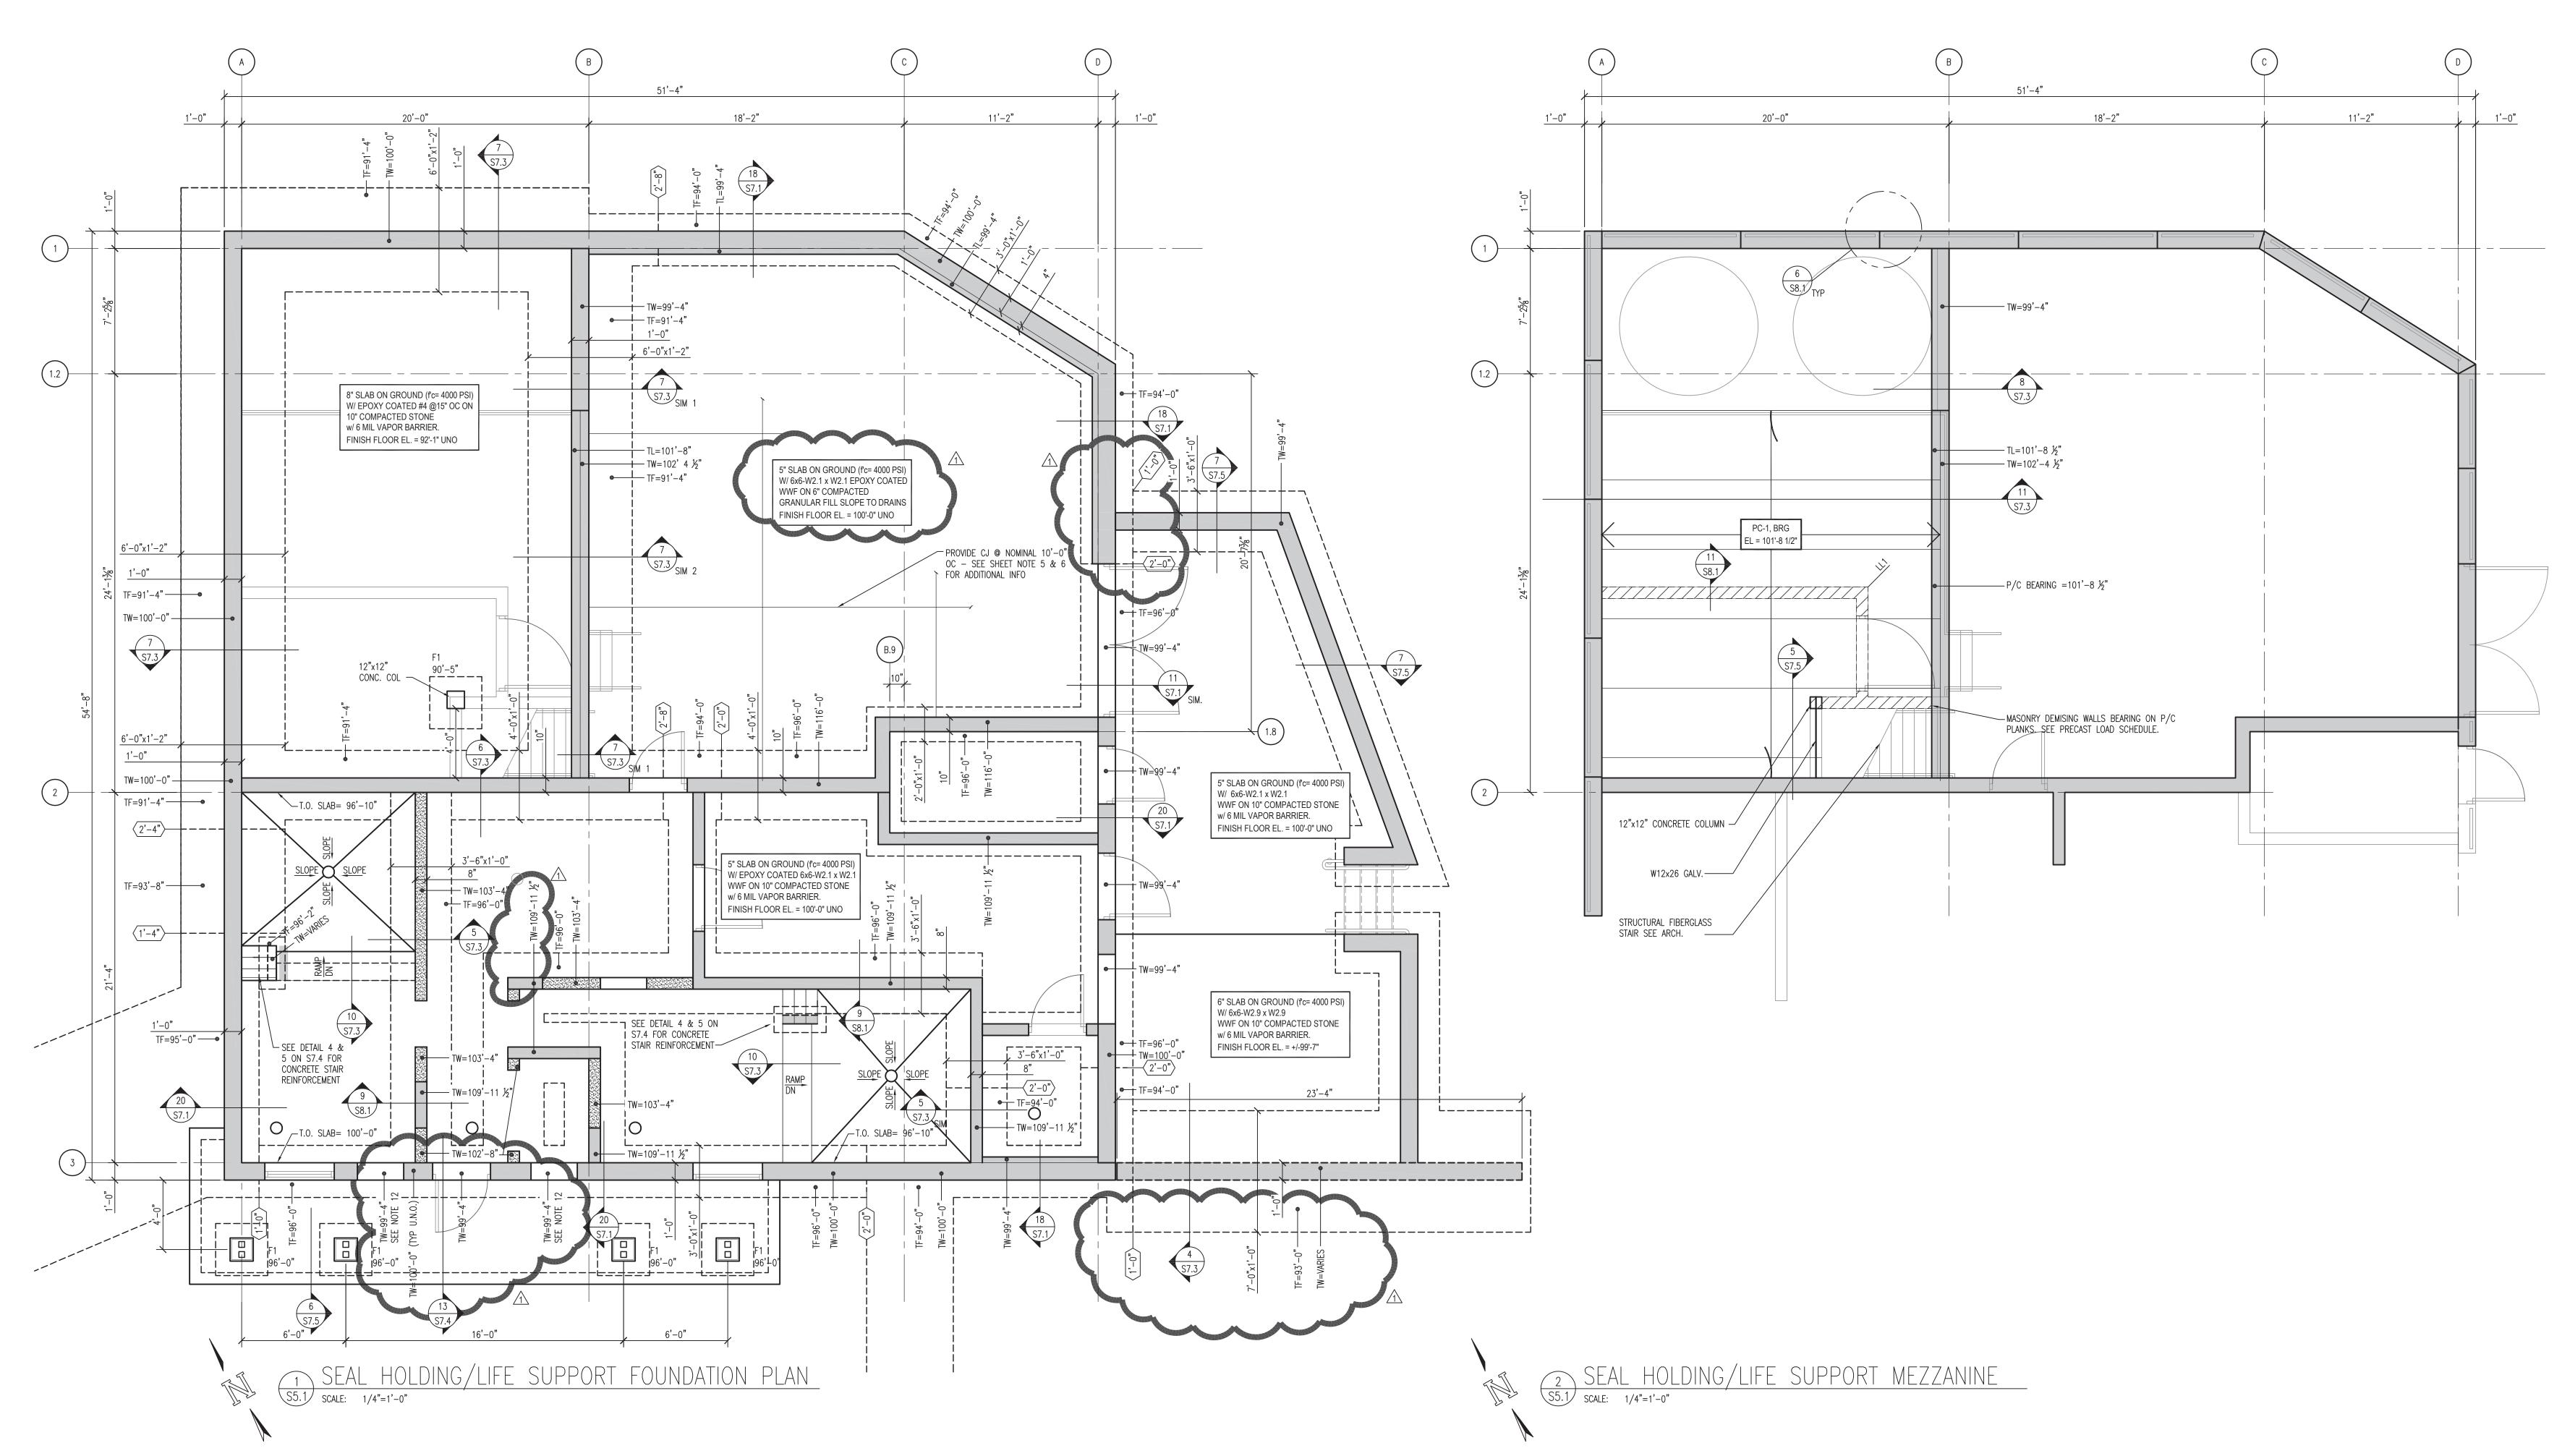

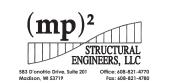

A R C H I T E C T S

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AL EXHIBIT AND CONCESSION
RFB No. 313086
Vilas Zoo - County of Dane
Department of Public Wo

PRINTS ISSUED

07.26.2013 - Schematic Design

08.23.2013 - Design Development

09.23.2013 - 65% CD's

10.07.2013 - Pricing Set

10.21.2013 - 95% CD's

11.13.2013 - Bid Documents

WDM No. drawn: MP2

13046 checked: MP2

SEAL HOLDING / LIFE SUPPORT
FOUNDATION PLAN

MEZZANINE FRAMING PLAN

11.25.2013 - Addendum #3

S5.

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1. SEE SHEET S.01 FOR ADDITIONAL NOTES.


#### PRECAST NOTES


1. ALL PRECAST ROOF PLANKS TO HAVE 2" MIN STRAND COVER.


- 2. ALL PRECAST WALLS AND ROOF TO ACT AS DIAPHRAGM AND SHEAR WALLS. GROUT ALL ROOF PLANK SHEAR KEYS AND PROVIDE WALL PANEL TIES AS REQUIRED TO PREVENT UPLIFT AT PANEL BASE.
- 3. SEE SHEET SO.1 FOR ADDITIONAL PRECAST REQUIREMENTS AND ENVIRONMENTAL LOADING REQUIREMENTS.
- 4. STYLE OF PRECAST WALLS (SANDWICH PANEL OR INSULATED CORES)
  SHOWN AS CONCEPTUAL ONLY. ALL PRECAST WALL PANELS SHALL
  HAVE ARCHITECTURAL FINISH AND "R" INSULATION VALUES AS
  SPECIFIED BY ARCHITECT.
- PRECAST WYTHES EXPOSED TO ANIMAL ACTIVITY SHALL BE RIGID ENOUGH TO NOT CRACK WHEN ANIMAL LOADS ARE APPLIED (SEE NOTE 6 BELOW FOR LOADS). ALL WALLS OF BEAR BUILDING AND WEST & SOUTH WALLS OF SEAL BUILDING.
- 6. ALL PRECAST WALL PANELS EXPOSED TO ANIMAL ACTIVITY SHALL BE DESIGNED FOR ENVIRONMENTAL LOADS SHOWN ON SHEET SO.1 AND FOR (2) 2.0k IMPACT POINT LOADS APPLIED OVER A 0.5 SQ-FT AREA AT 2'-0" APART AT ANY LOCATION IN THE BOTTOM 12'-0" ON THE EXTERIOR FACE OF THE WALL.
- 7. PRECAST WALL SHALL BE DESIGNED AS SHEAR WALLS TO RESIST SOIL, WIND, SEISMIC FORCES PER PLAN.
- 8. PROVIDE FORM LINER PER ARCHITECTURAL PLANS.
- 9. SEE A-DRAWINGS FOR WALL ELEVATION REQUIREMENTS & WALL OPENINGS. A-DRAWINGS SHALL GOVERN OVER STRUCTURAL DRAWINGS FOR ALL DIMENSIONS AND ELEVATIONS.

PRECAST SCHEDULE							
MARK	ADIC PLANK TOPPING			P/C BEARING			
MARK	DEPTH	DEPTH TOPPING	DL (psf)	LL (psf)	SL (psf)	ÉLEVATION	
PC-2	8"	NONE	SELF WT. + 10	20	23.1 + DRIFT	110'-0"	
PC-3	10"	NONE	SELF WT. + 10	20	23.1 + DRIFT	112'-0"	

NOTES:
1. SELF WT. NOTED IN SCHEDULE TO INCLUDE WT. OF TOPPING SLAB NOTED.
2. GROUT ALL SHEAR KEYS AND TOOL SMOOTH

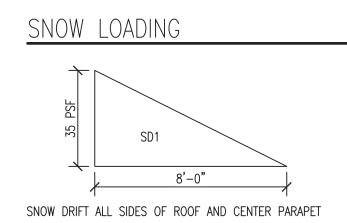

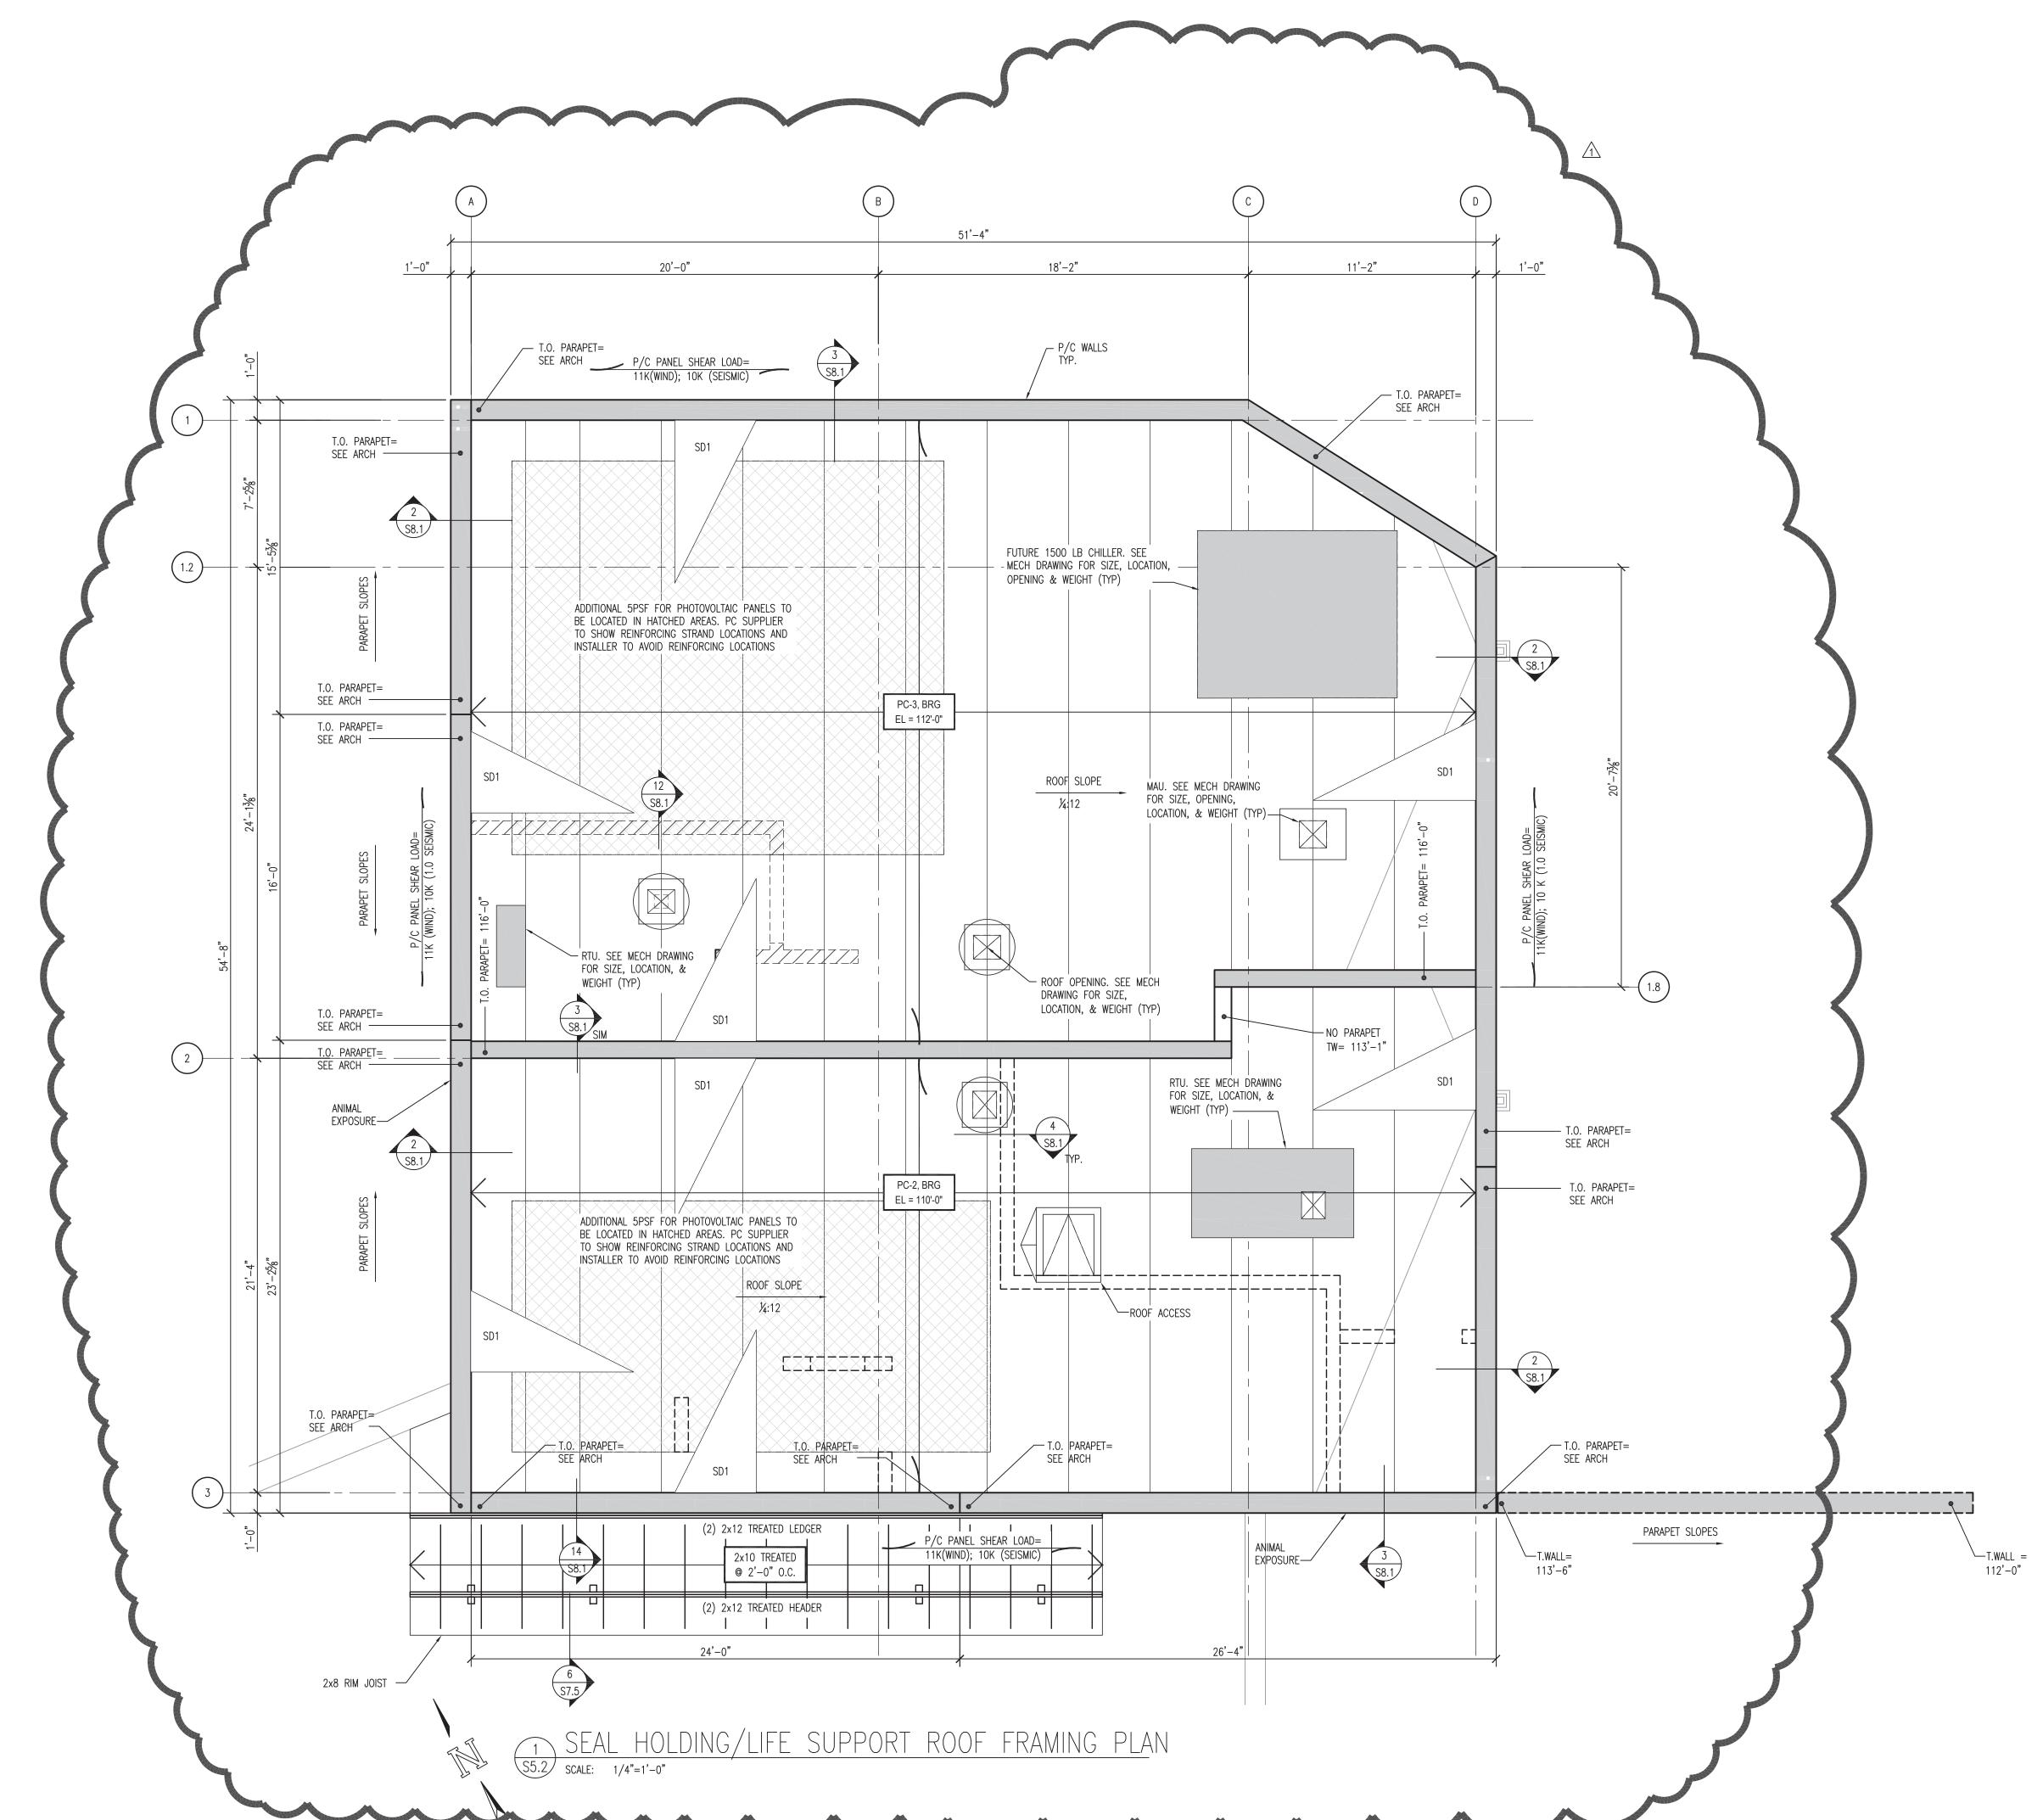

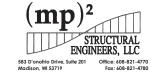



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Henry Vilas Zo Henry Vilas Zoo 702 S Randall Ave

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13046 checked: MP2

SEAL HOLDING / LIFE SUPPORT

ROOF FRAMING PLAN

**S5.2** 


- 1. SEE SHEET S.01 FOR ADDITIONAL NOTES.
- 2. SEE ARCH FOR JOIST BEARING ELEVATION.
- 3. ROOF SHEATHING SHALL BE  $^{1}$ %<sub>2</sub>" APA RATED EXTERIOR GRADE. FASTEN TO FRAMING PER DETAIL 4 ON SHEET 10.1.


4. SEE DETAIL 4 SHEET S10.1 FOR WOOD FASTENER SCHEDULE.

1. CENTE


FOOTING SCHEDULE				
FOOTING MARK	FOOTING DIMENSION (W x L x D)	FOOTING REINFORCING, BOTTOM		
F1	3'-0" x 3'-0" x 1'-0"	3-#5 EA WAY		


ENTER	FOOTING	UNDER	COLUMN	AND/OR	PIER.	

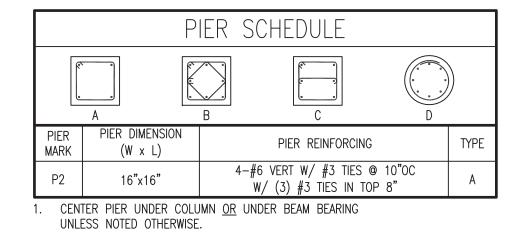

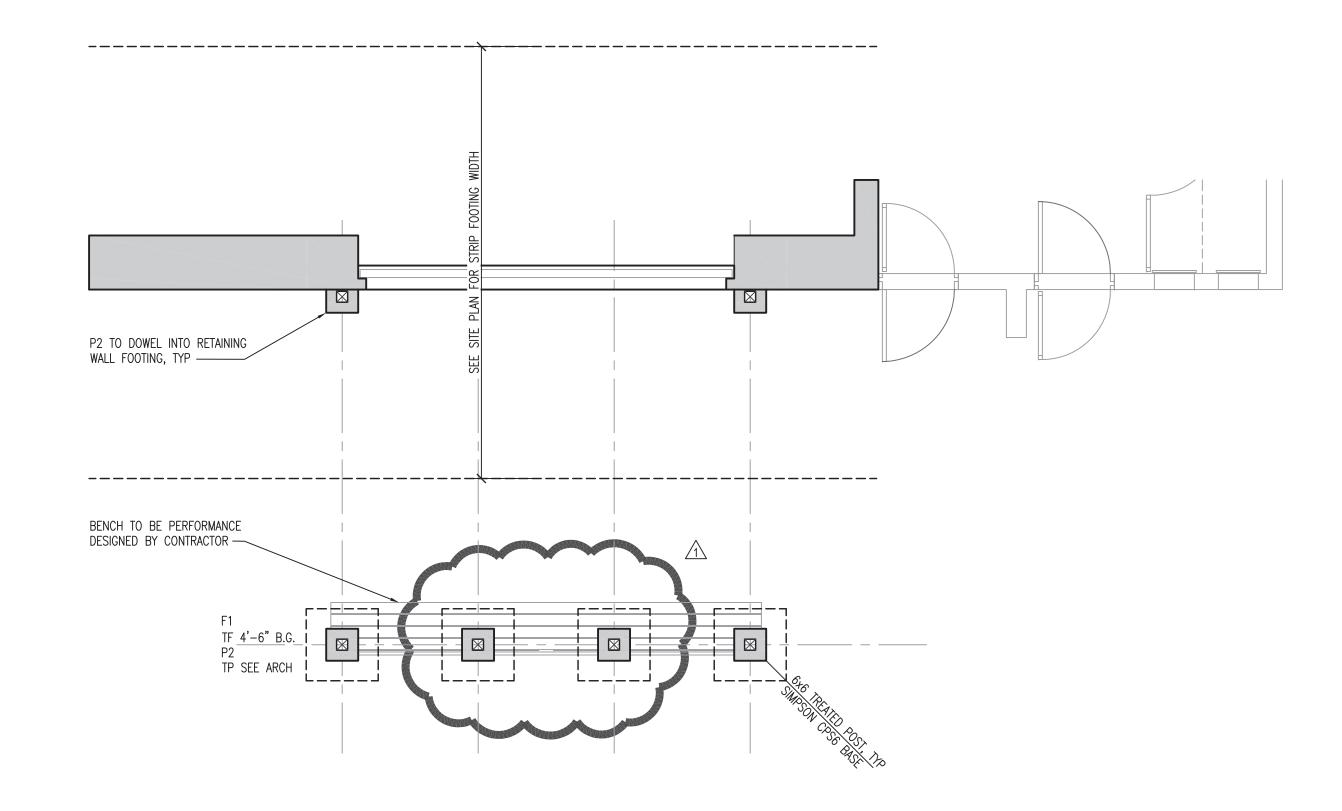




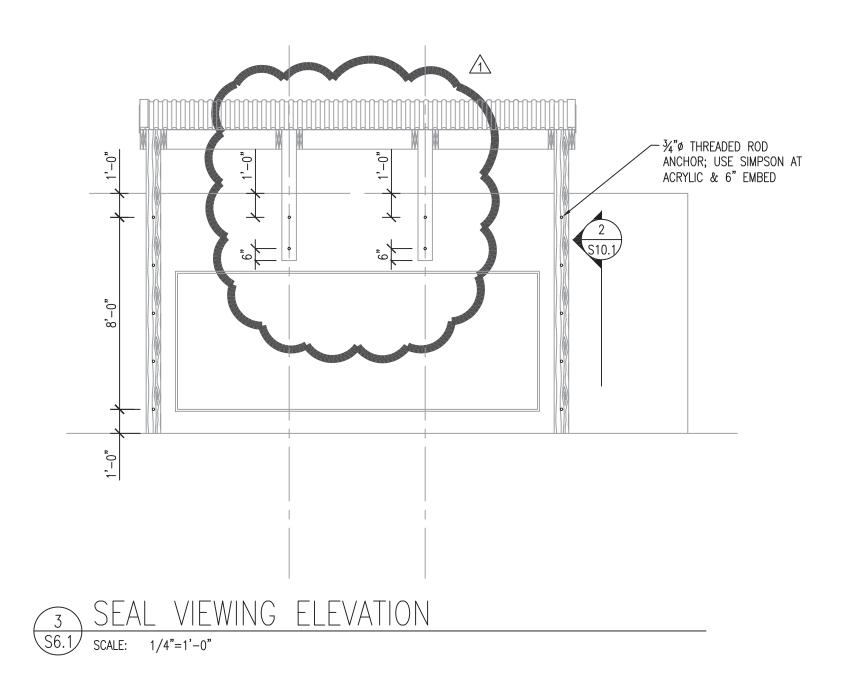

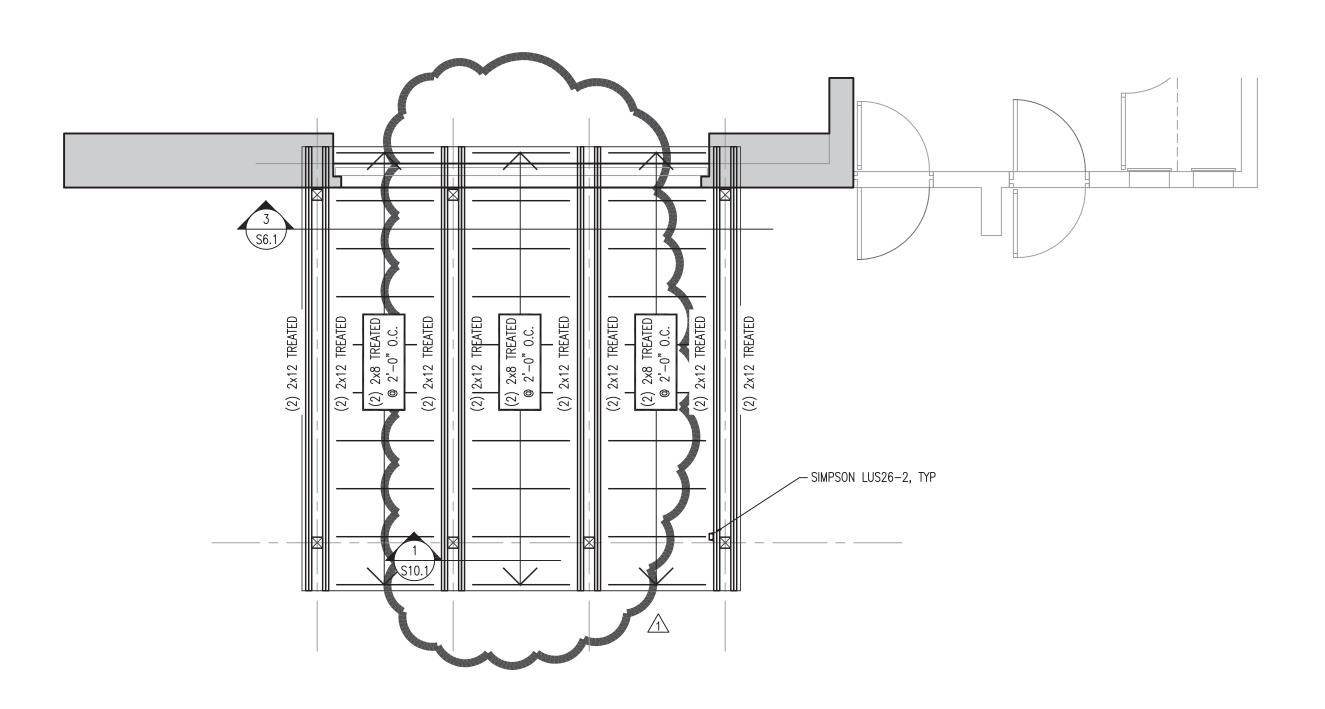

SEAL VIEWING ROOF FRAMING PLAN
S6.1 SCALE: 1/4"=1'-0"

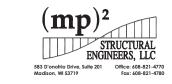



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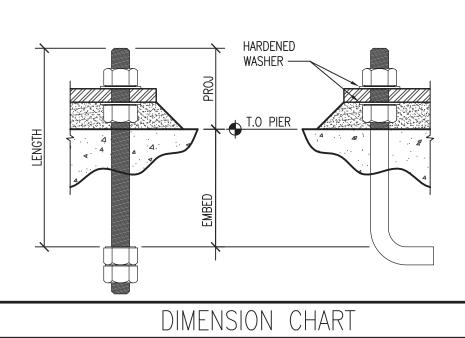


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WDM No. drawn: MP2 **13046** checked: MP2


SEAL VIEWING FOUNDATION PLAN & ROOF FRAMING PLAN




DIMENSION CHART							
DIAMETER	LENGTH	EMBED	HOOK	PROJECTION	NOTES		
1/2	12	8	2	4	1,2		
3/4	16	12	3	4	1,2		
1	19	15	4	4	1,2		


1. ALL ANCHORS F1554, GRADE 36. 2. LENGTH = 1'-0" AT INTERIOR COLUMN FOOTINGS WITH 12" DEPTH.

ANCHOR BOLT DIMENSION CHART
S7.1 SCALE: NTS

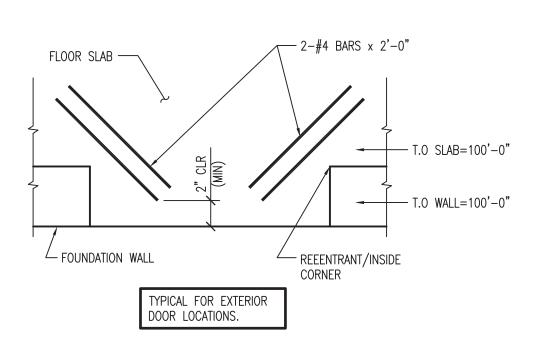


SLAB REINF AT REENTRANT 6 CORNERS W/O CONTROL JTS
S7.1 SCALE: 3/4"=1'-0"

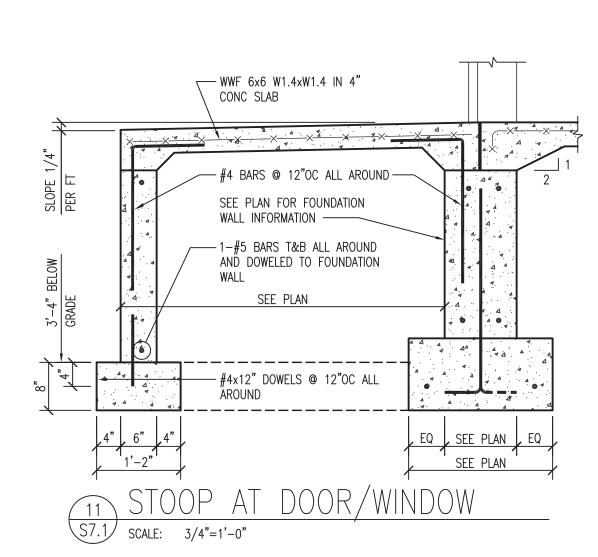


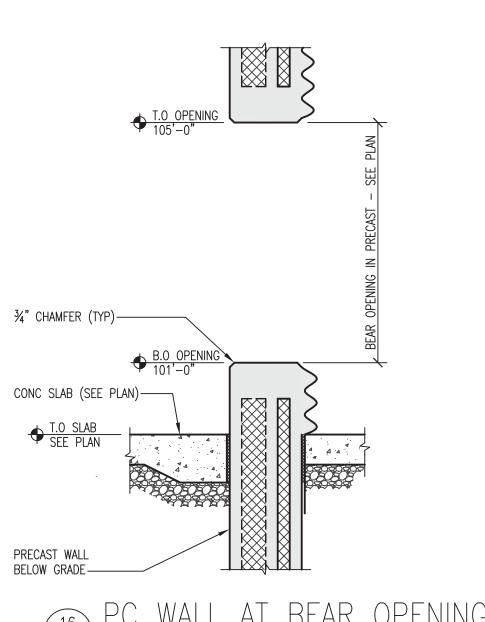



16 PC WALL AT BEAR OPENING \$7.1 SCALE: 3/4"=1'-0"

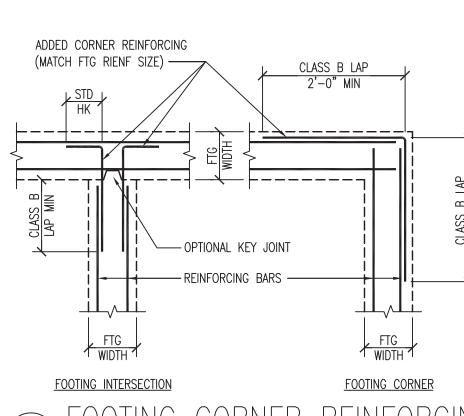




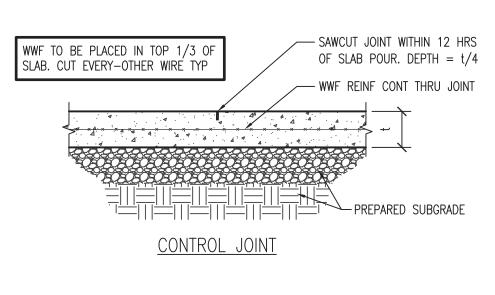

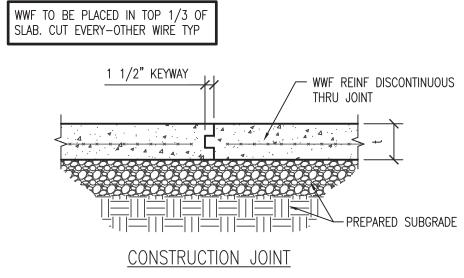


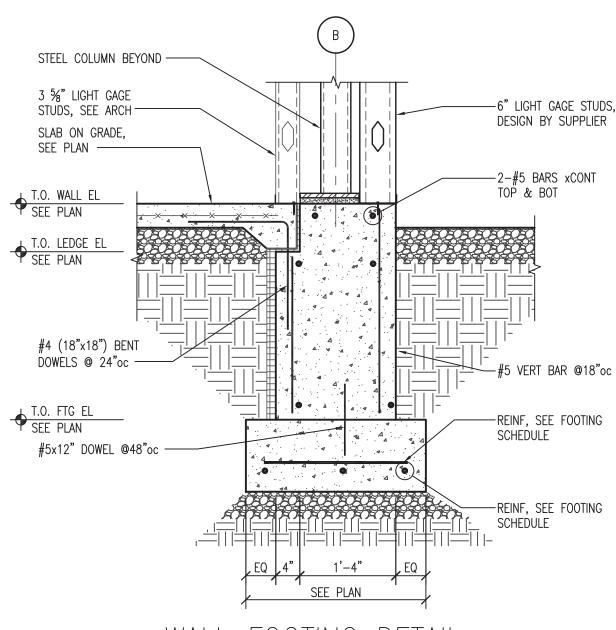


7 SLAB JOINTS S7.1 SCALE: 3/4"=1'-0"

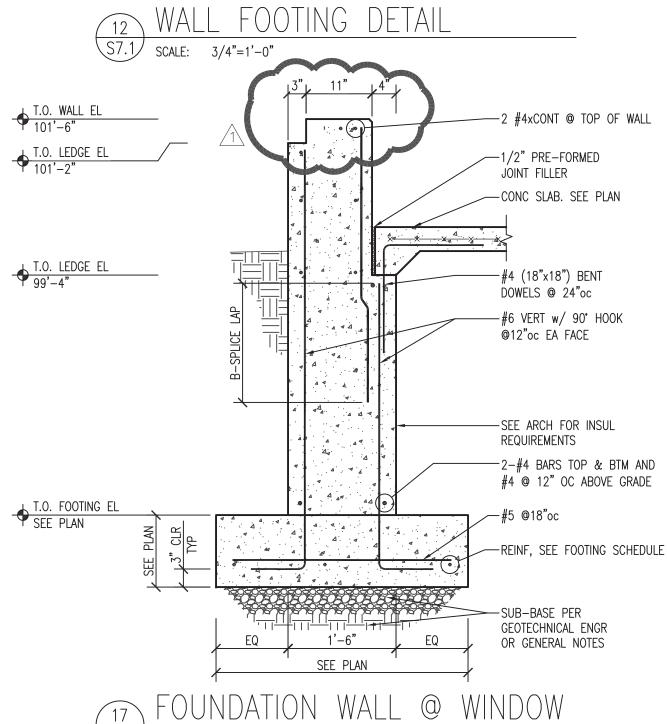


\$7.1 SCALE: 3/4"=1'-0"

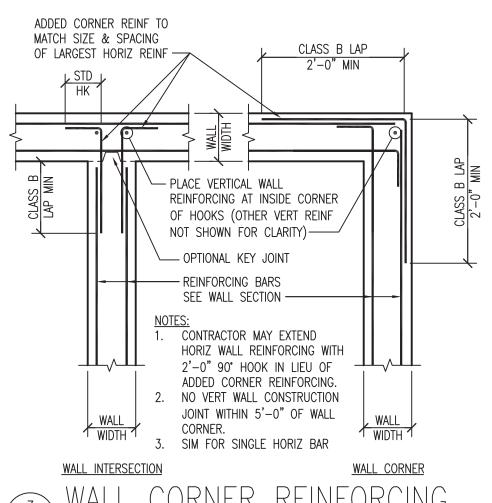


WALL CORNER REINFORCING
S7.1 SCALE: 3/4"=1'-0"

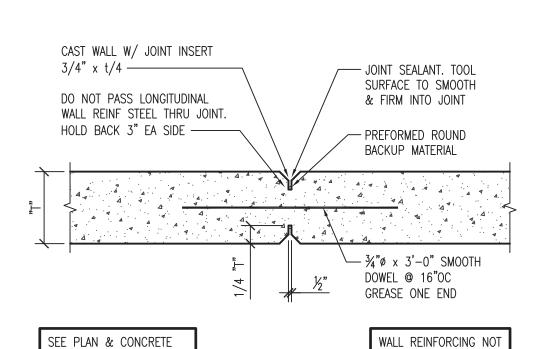


WALL REINFORCING NOT SHOWN. SEE SECTIONS CONSTRUCTION NOTES FOR LOCATION REQUIREMENTS. 8 WALL CONTROL JOINT S7.1 SCALE: 3/4"=1'-0"

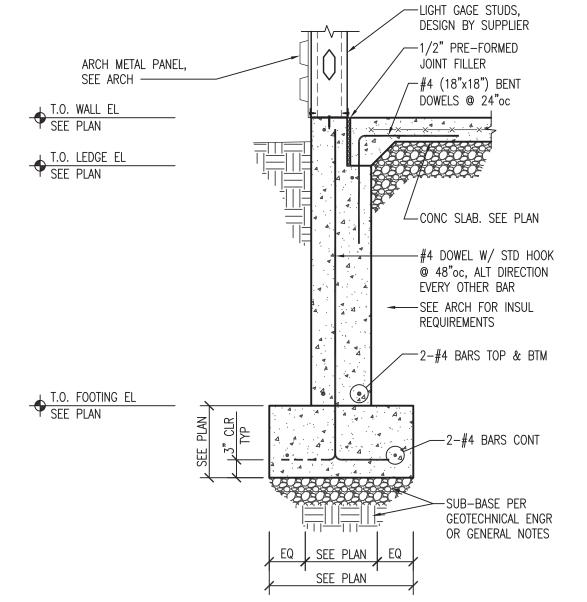



13 TYPICAL FOUNDATION WALL \$7.1\ \text{SCALE:} \ 3/4"=1'-0"

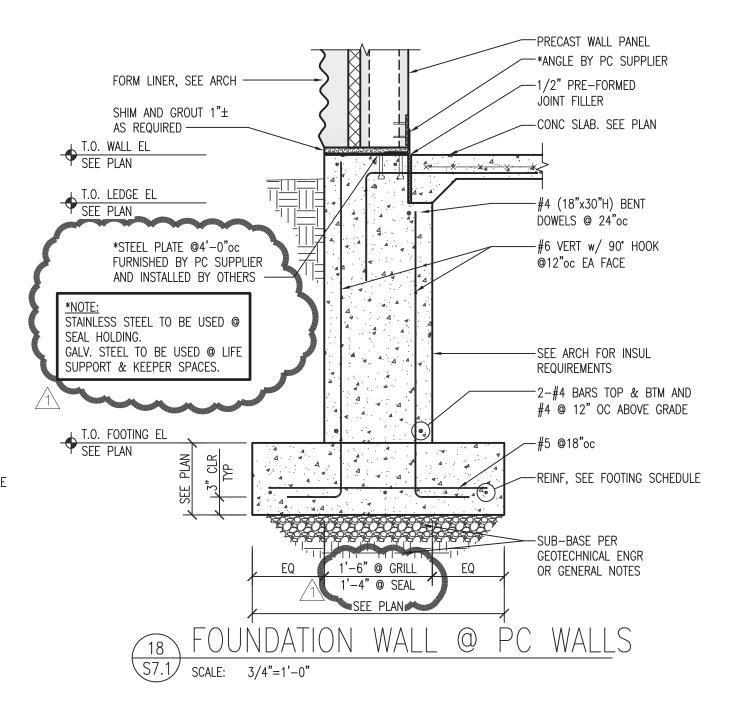


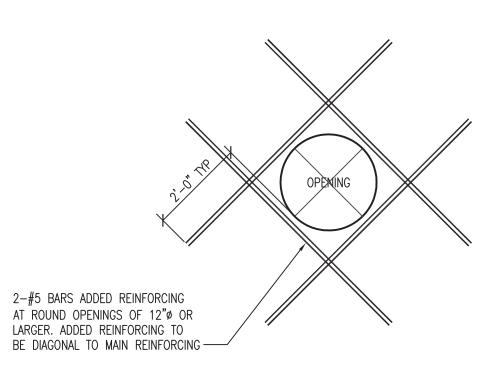


ADDED REINFORCING 4 AT ROUND OPENINGS \$7.1 SCALE: 1/2"=1'-0"

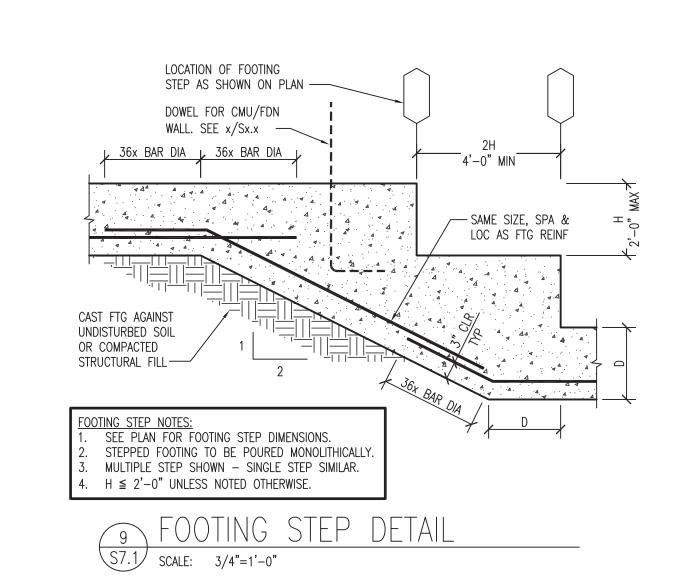


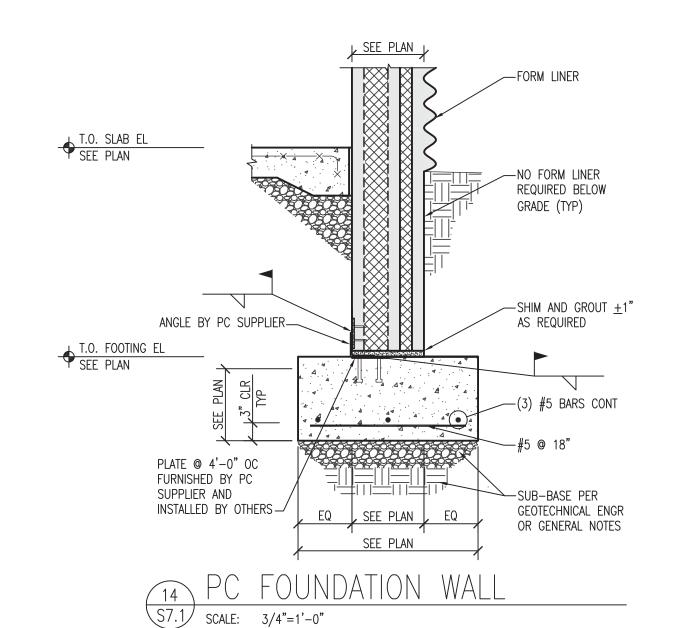


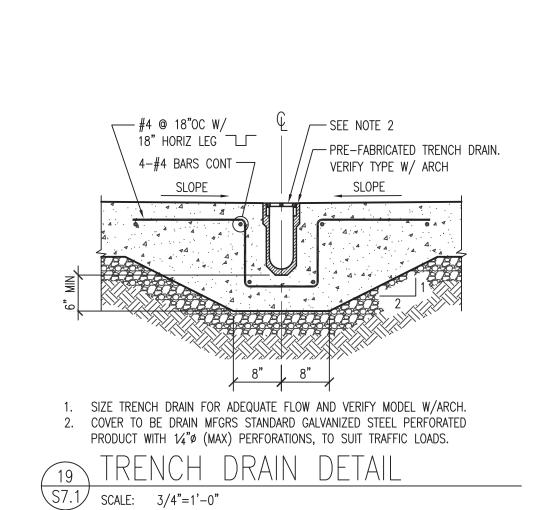

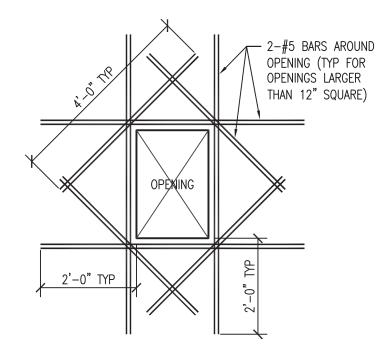


ADDED REINFORCING AT 5 RECTANGULAR OPENINGS \$7.1 SCALE: 1/2"=1'-0"

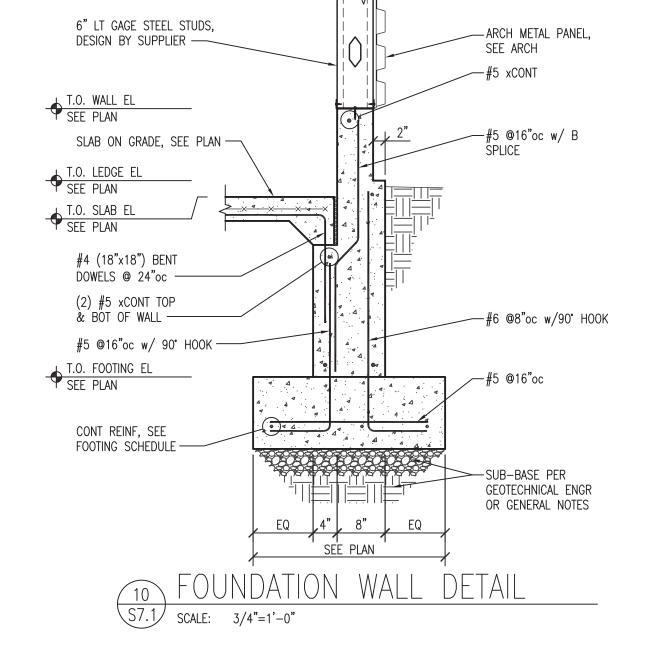

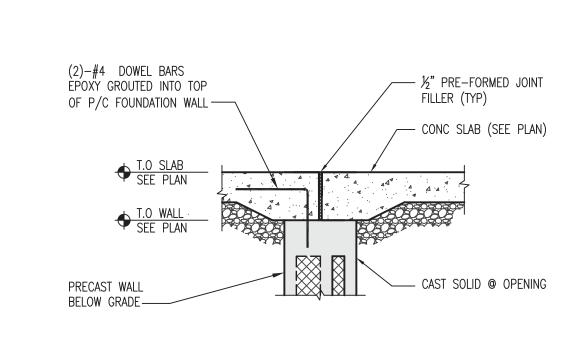




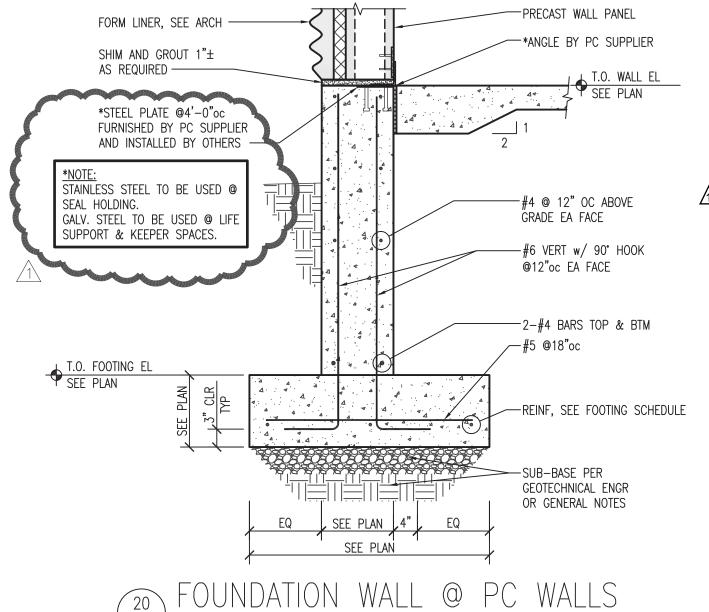

\$7.1 SCALE: 3/4"=1'-0"






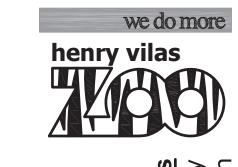



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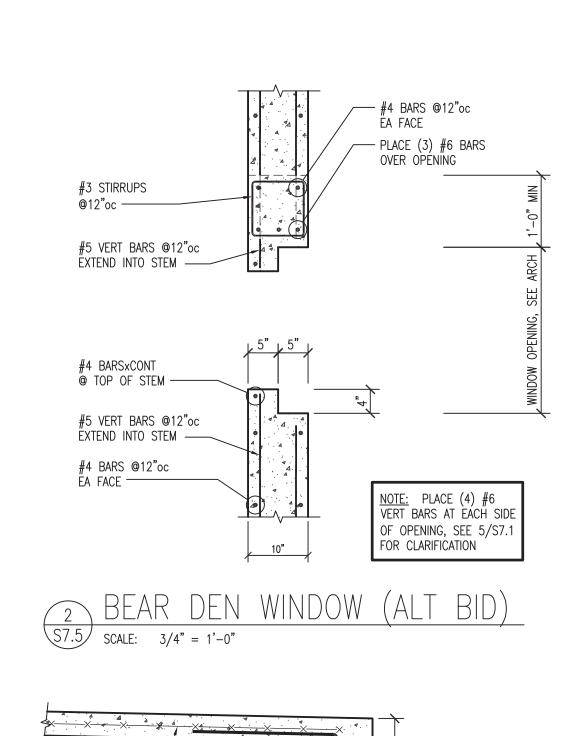
PRINTS ISSUED 07.26.2013 - Schematic Design 08.23.2013 - Design Development 09.23.2013 - 65% CD's 10.07.2013 - Pricing Set 10.21.2013 - 95% CD's 11.13.2013 - Bid Documents 11.25.2013 - Addendum #3

WDM No. drawn: MP2 13046 FOUNDATION DETAILS



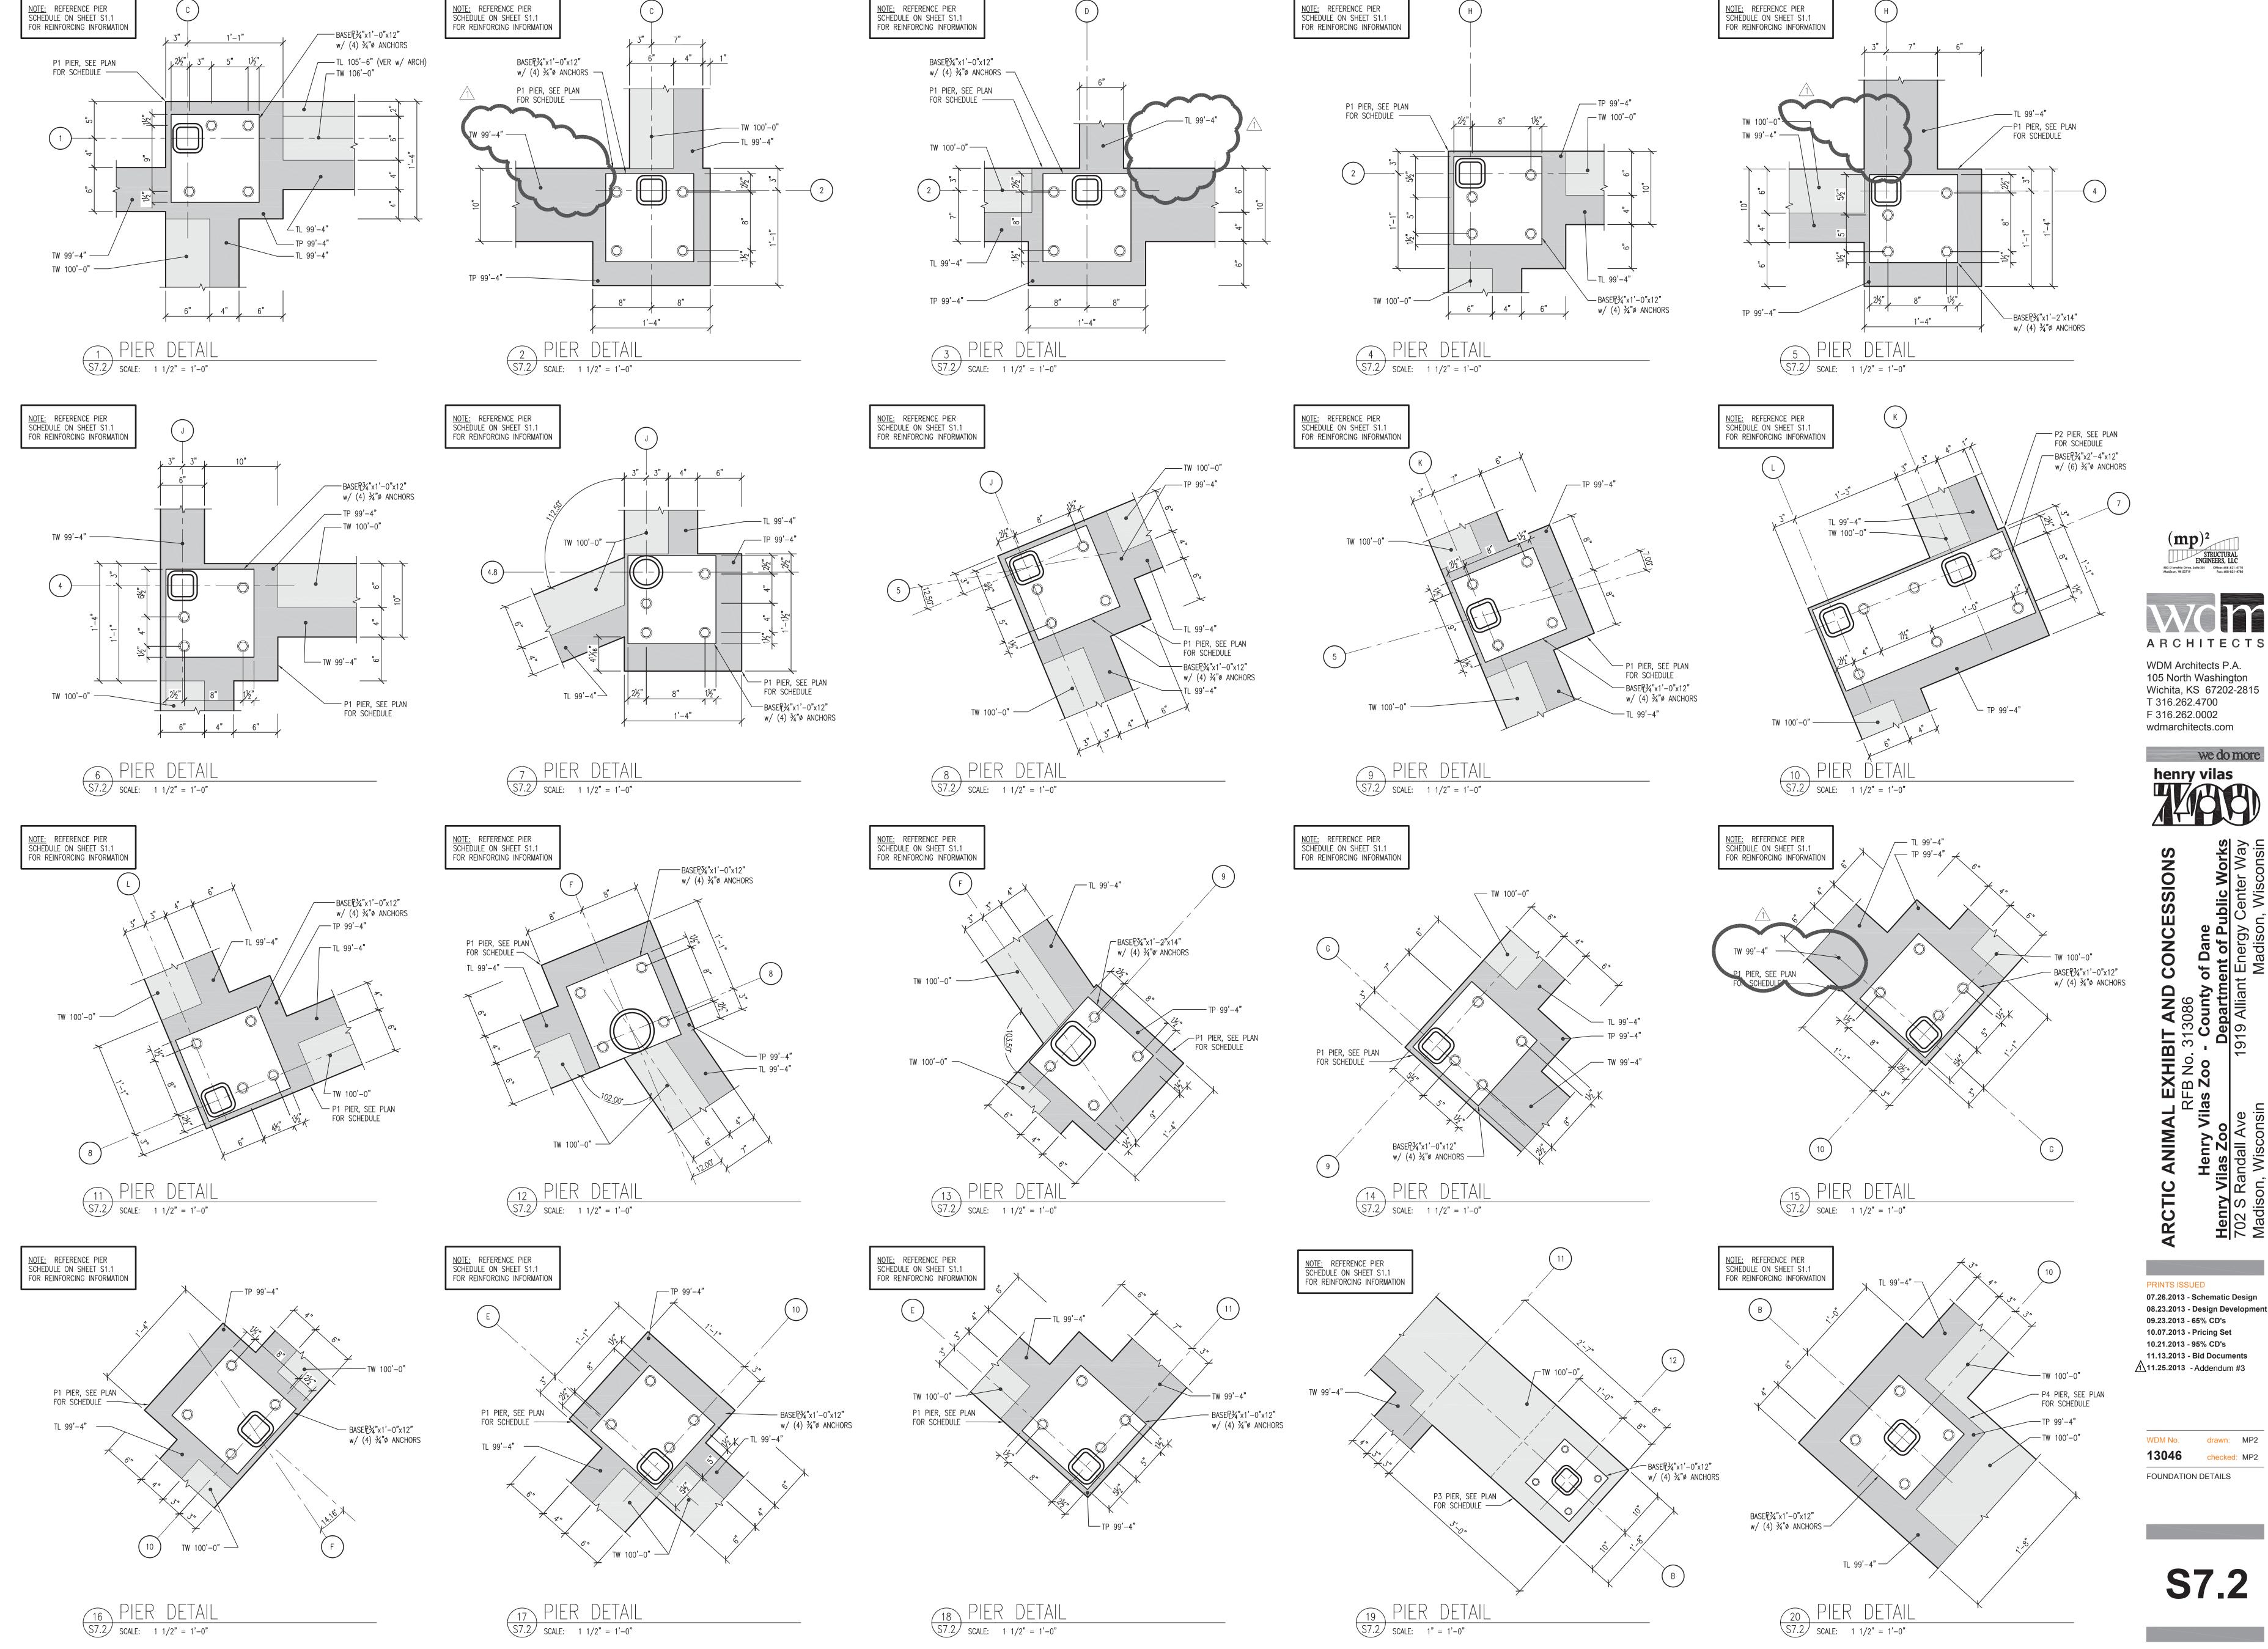

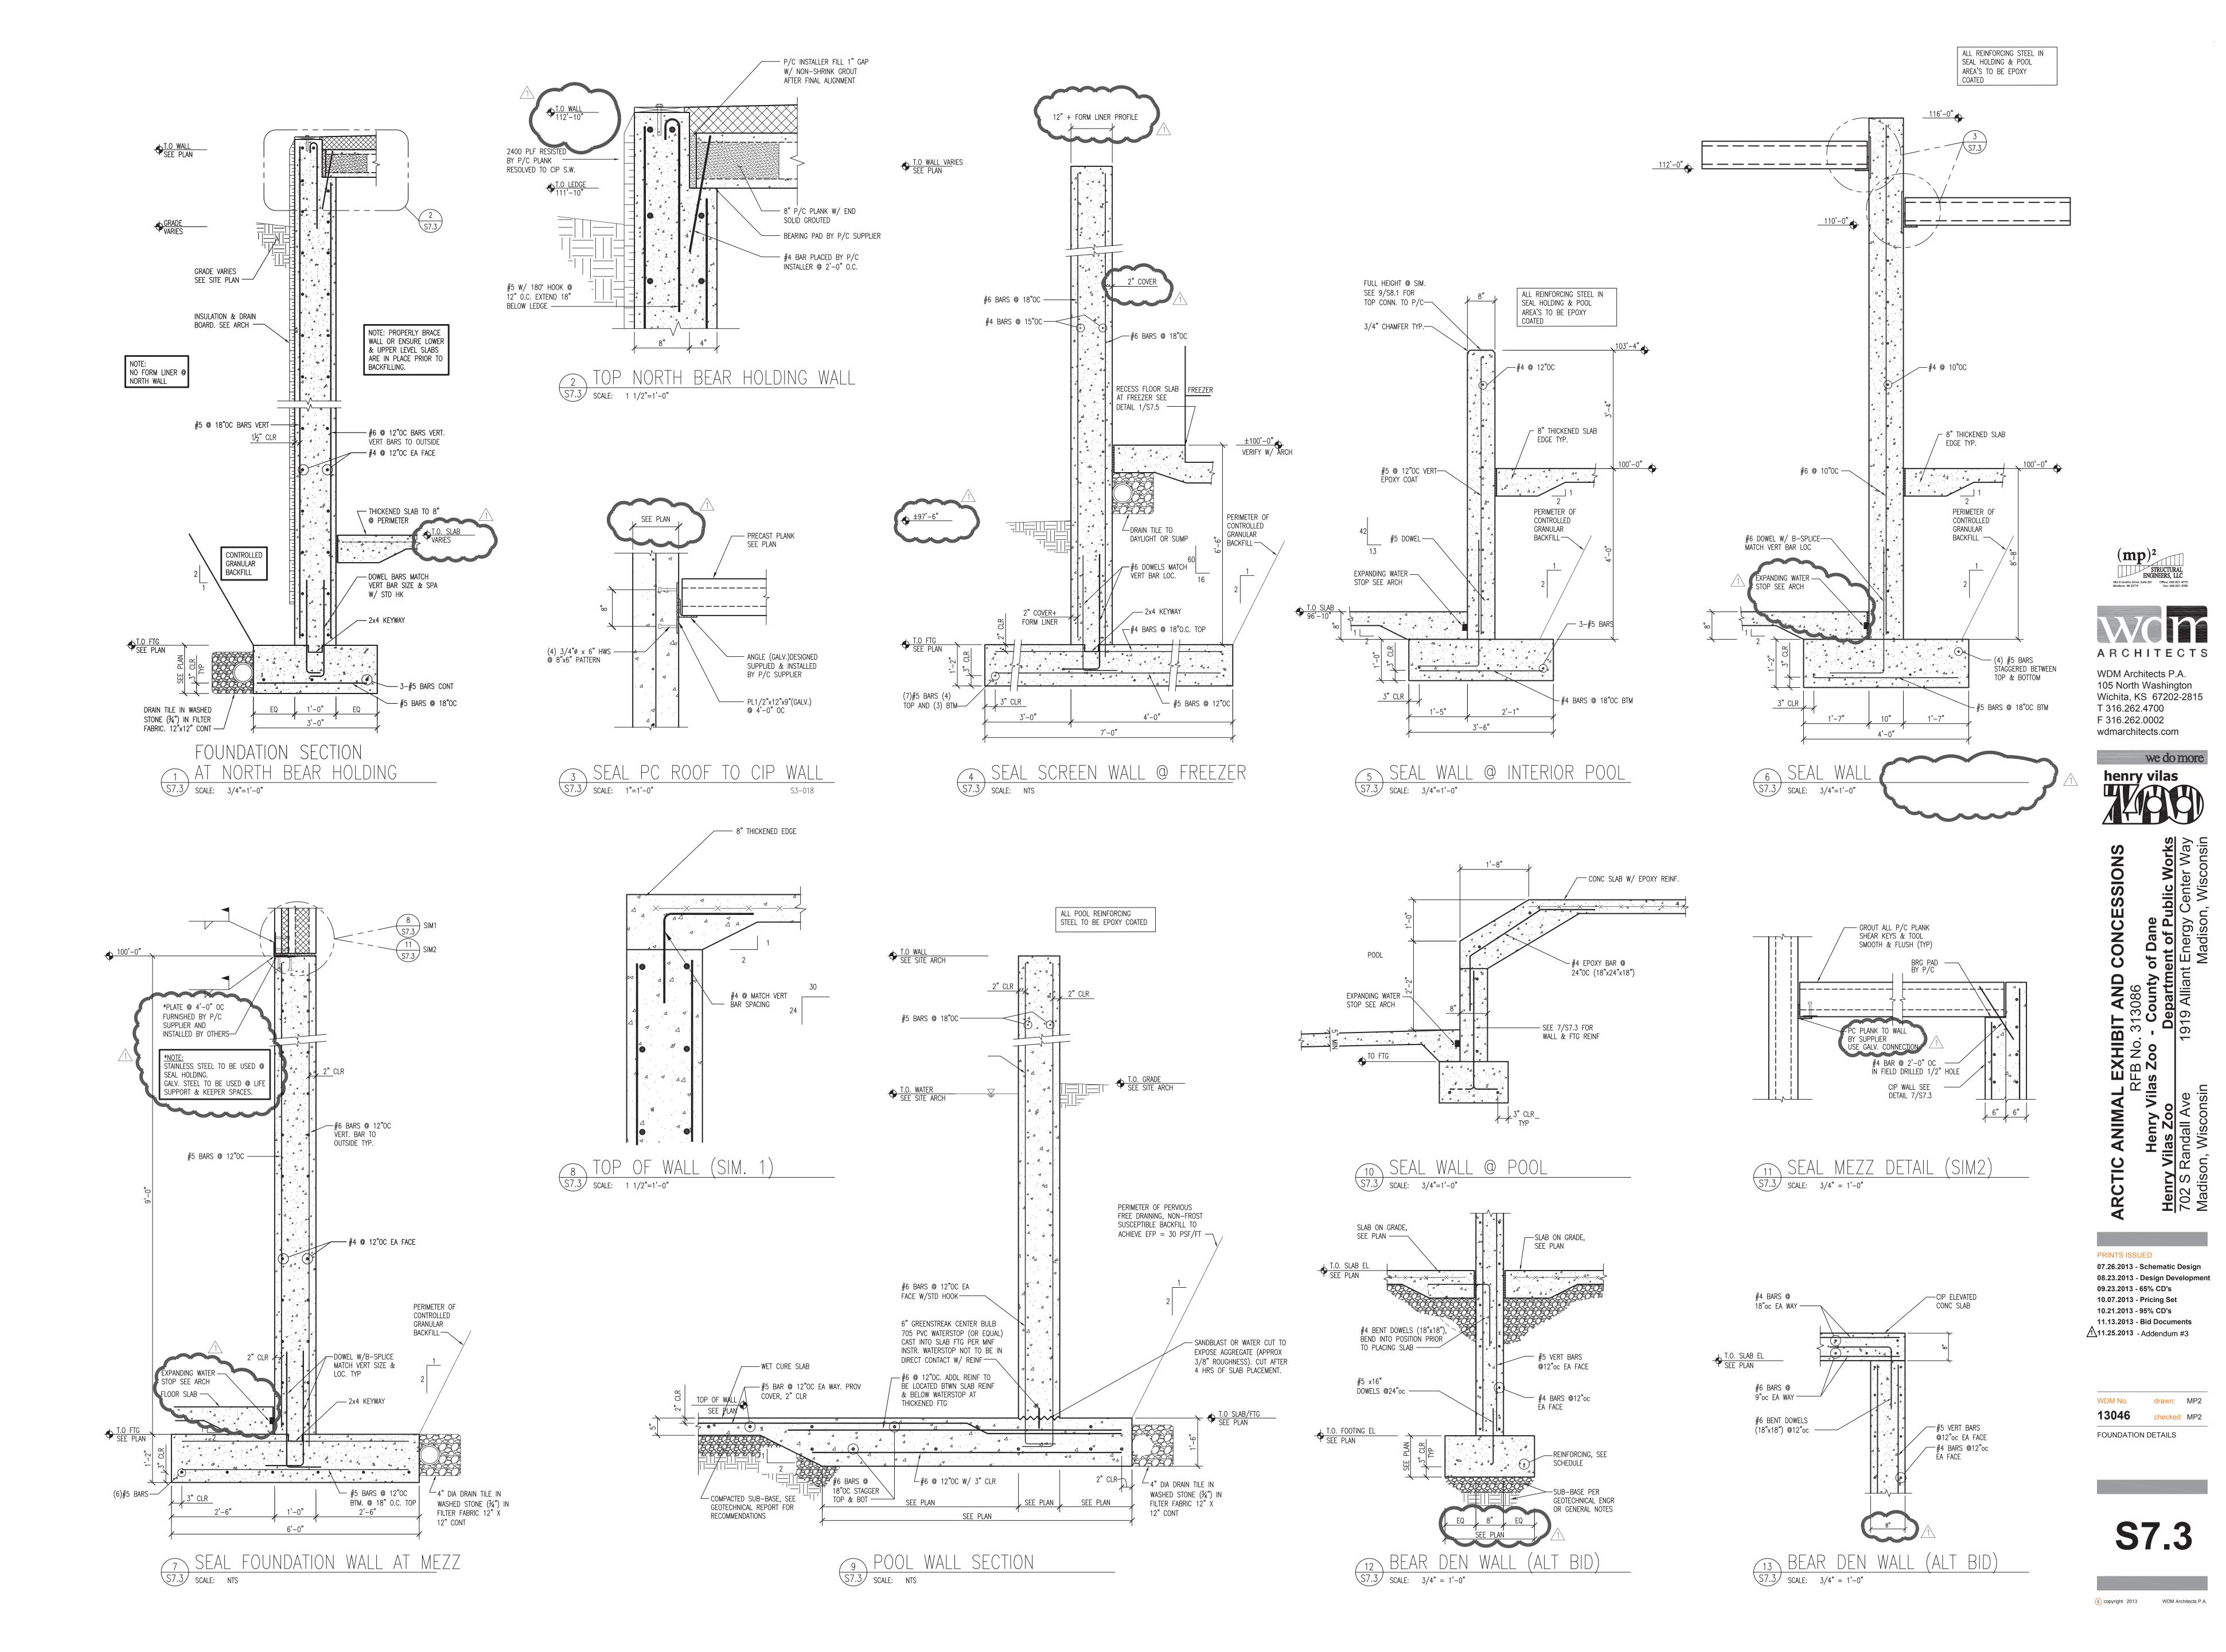

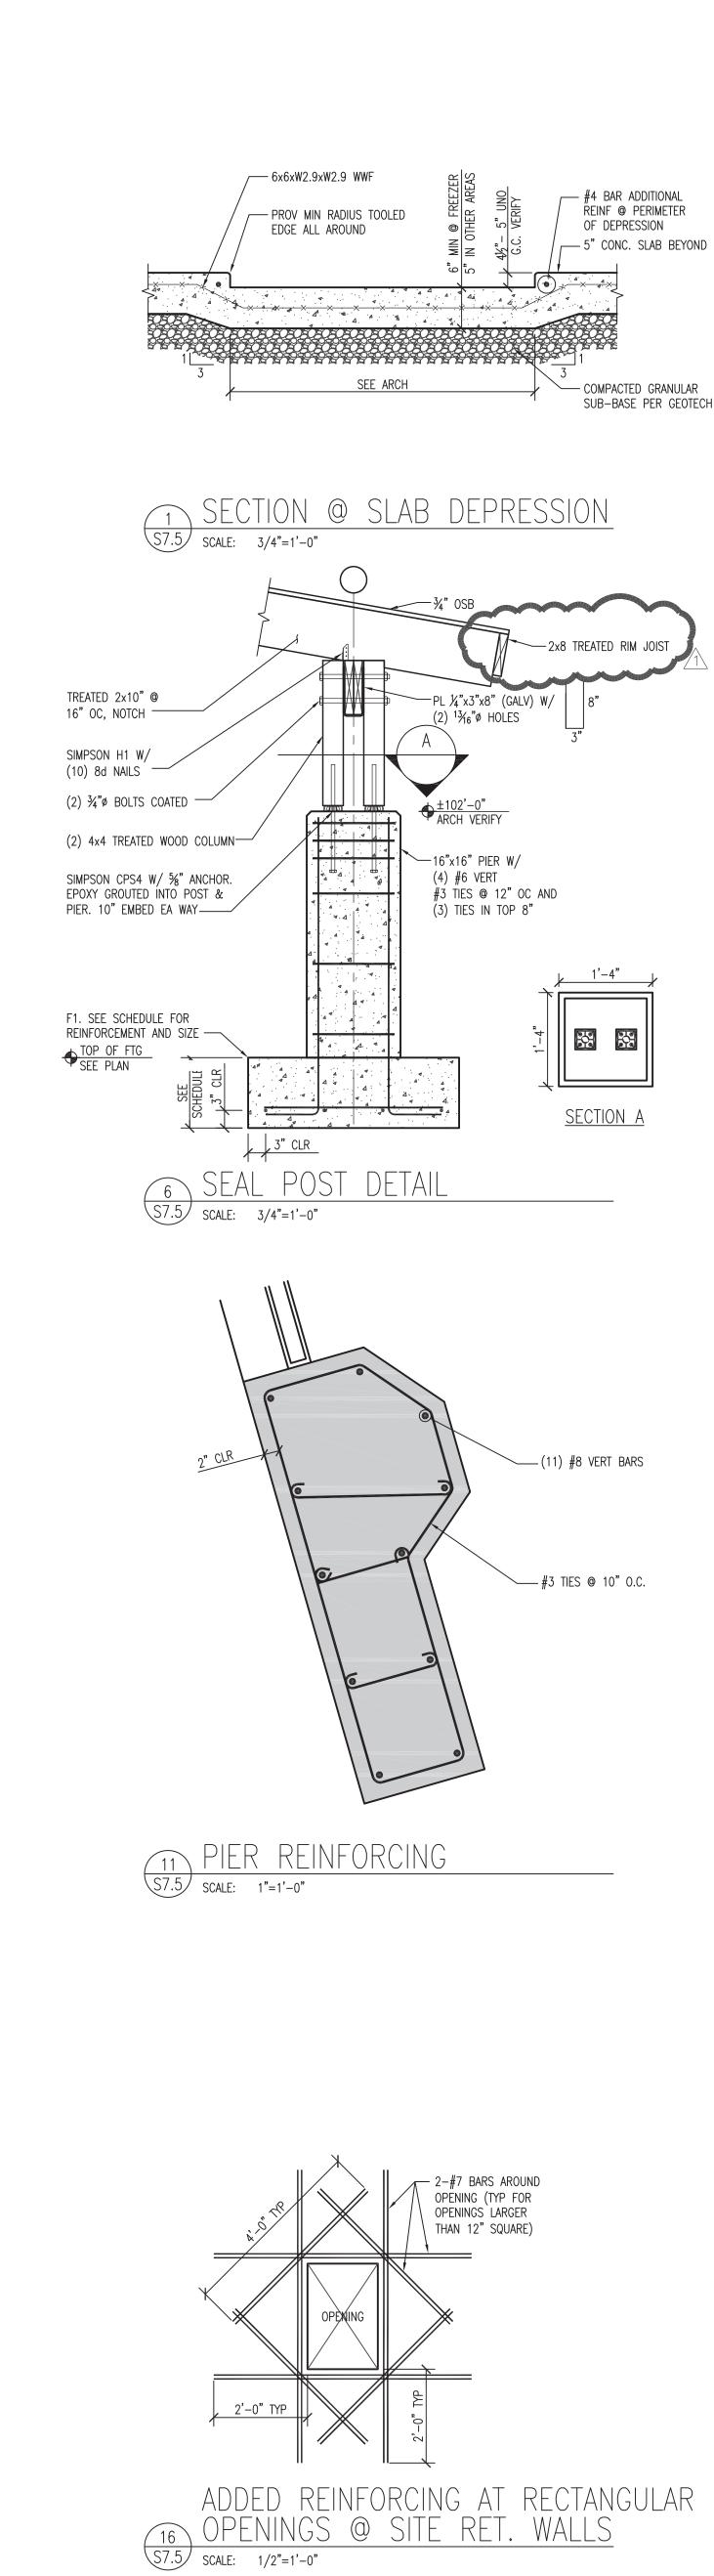

#4 BAR ADDITIONAL REINF @ PERIMETER

OF DEPRESSION

— 5" CONC. SLAB BEYOND


- COMPACTED GRANULAR SUB-BASE PER GEOTECH


SECTION A

CONC SLAB SEE PLAN-

2-#4 BARS TOP & BTM ——


#4 (24"X24") @ 16" OC ALL AROUND

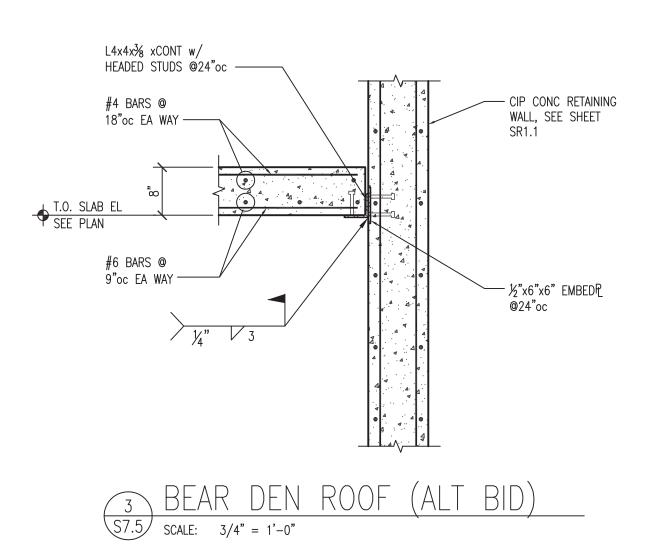


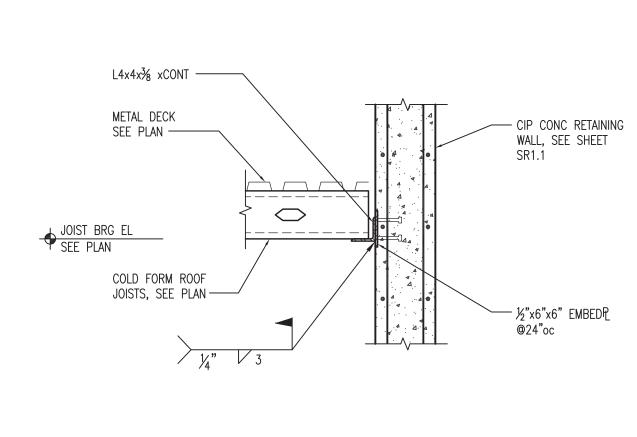



BEAR DEN ROOF (ALT BID)


S7.5 SCALE: 3/4" = 1'-0"

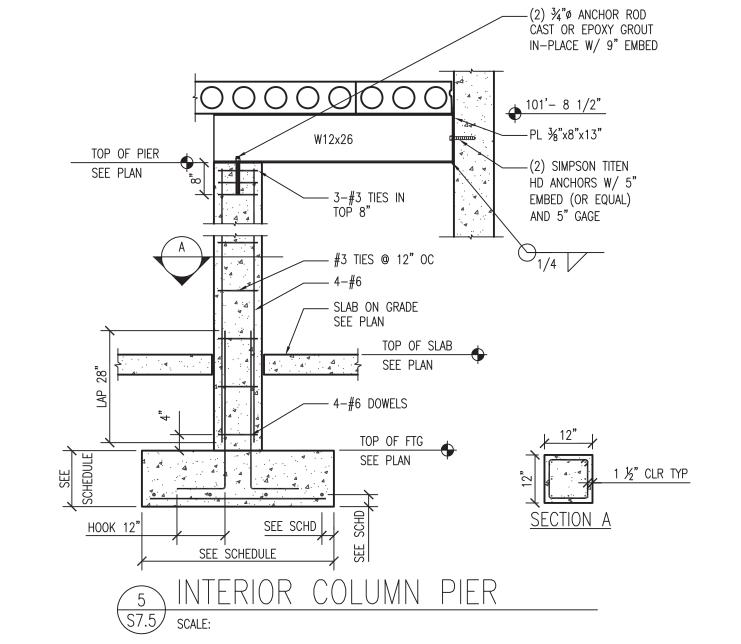


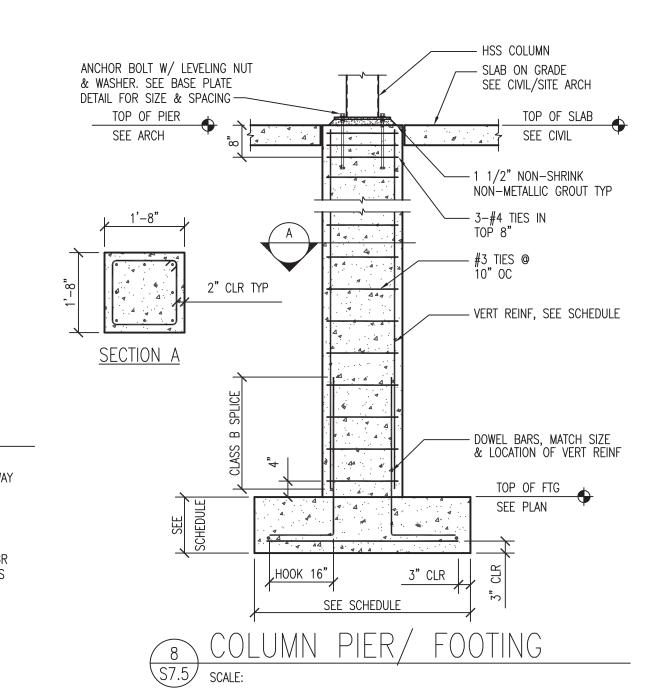


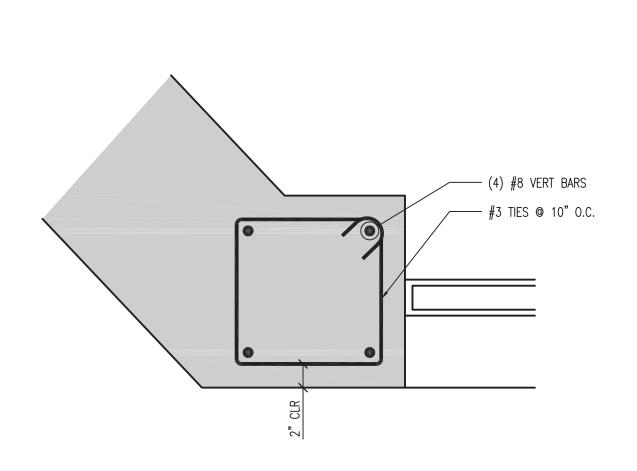


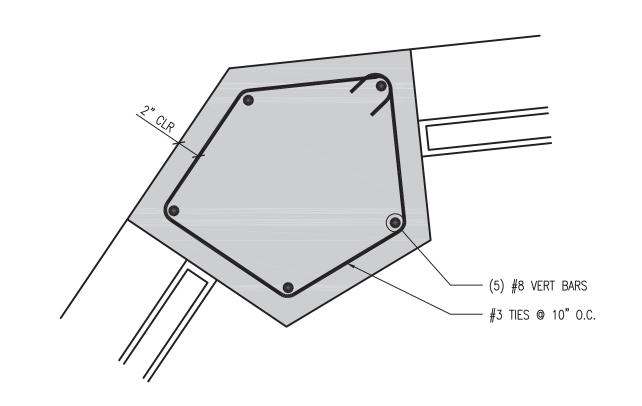


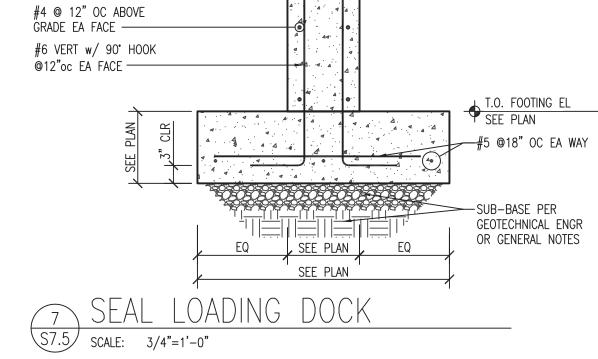


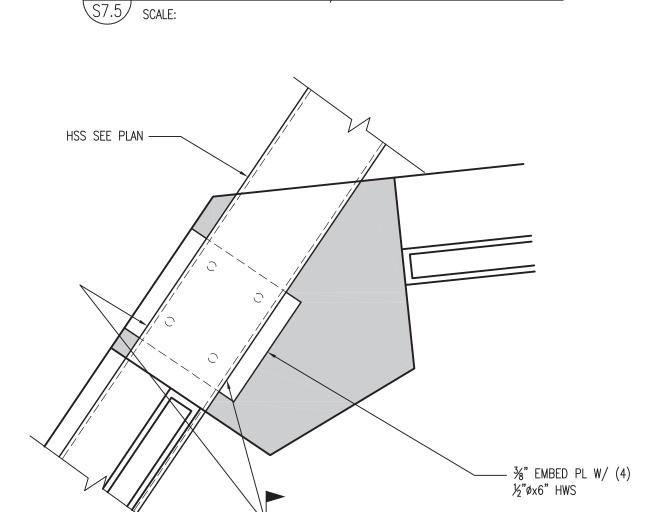


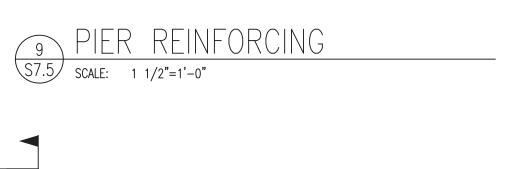

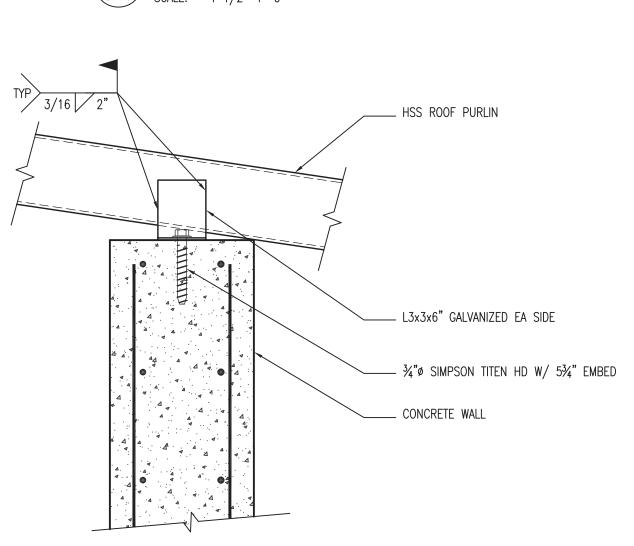

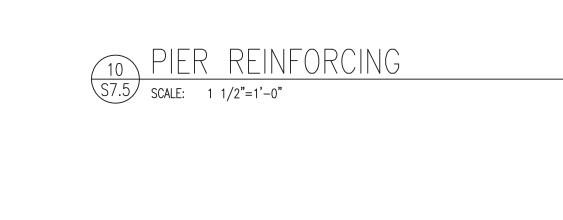


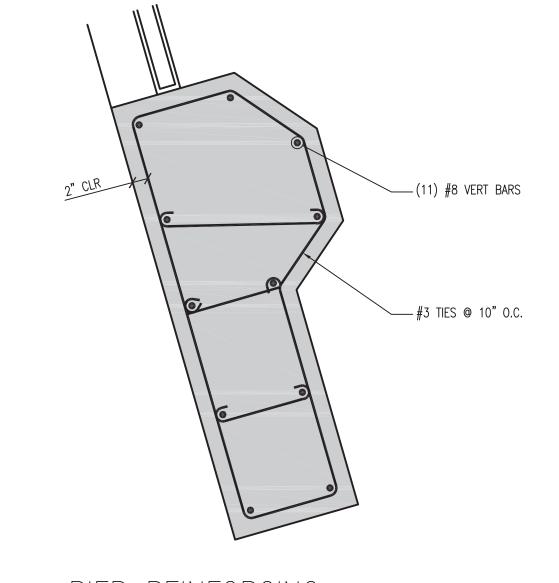


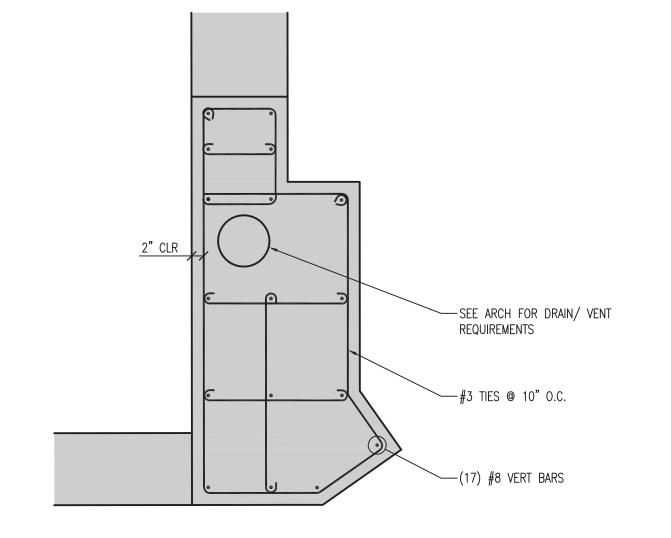


PIER REINFORCING

S7.5 SCALE: 3/4"=1'-0"

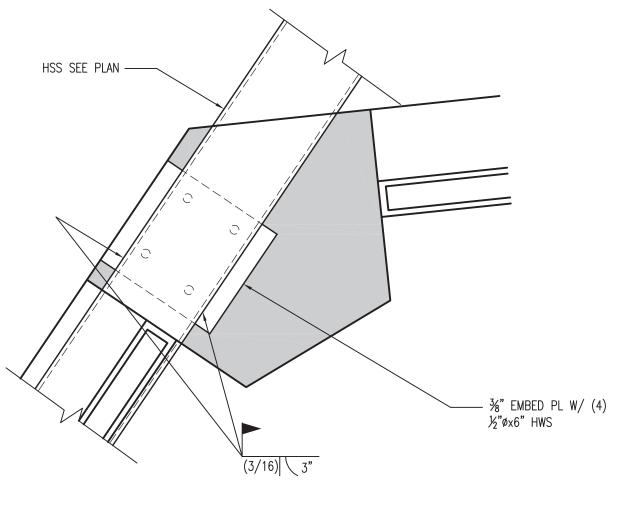

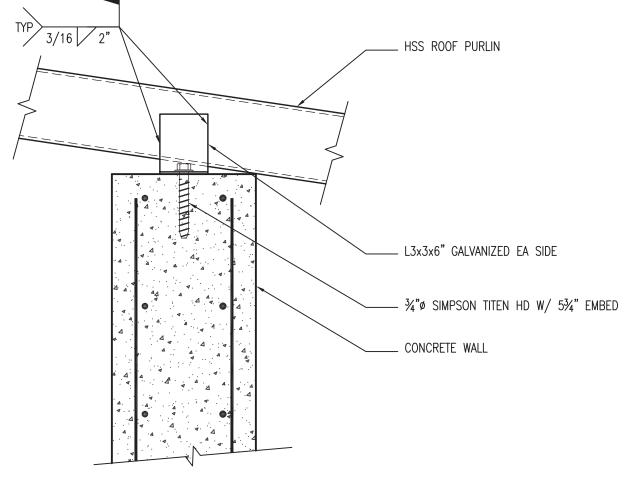

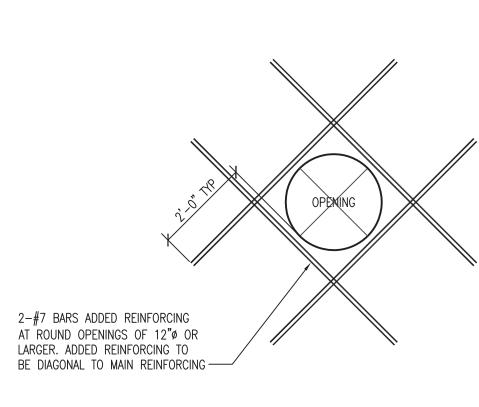


HSS TO CONCRETE PIER


S7.5 SCALE: 1 1/2"=1'-0"




ADDED REINFORCING AT ROUND
OPENINGS @ SITE RET. WALLS


S7.5 SCALE: 1/2"=1'-0"

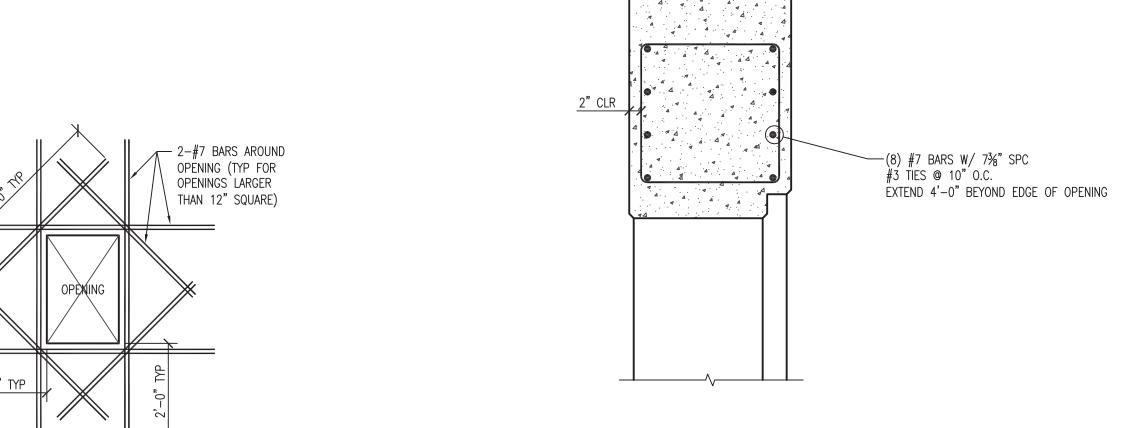

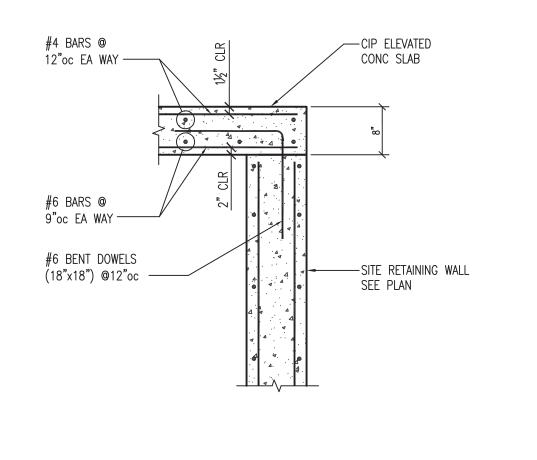

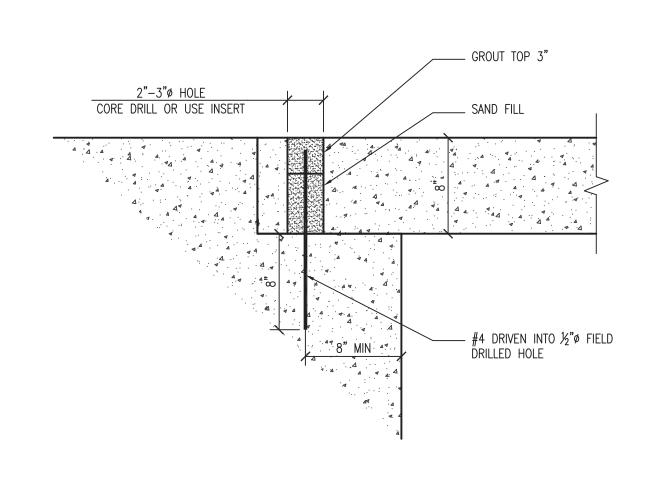

19 BRIDGE AT "ROCK" \$7.5 SCALE: 1 1/2"=1'-0"

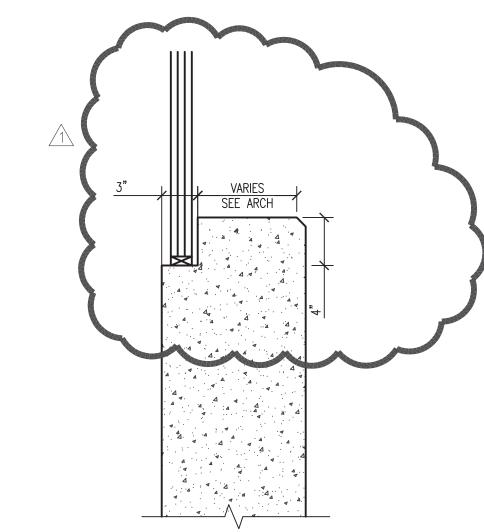

20 DETAIL BELOW VIEWING
S7.5 SCALE: 1 1/2"=1'-0"







WDM No. drawn: MP2 FOUNDATION DETAILS

ARCTIC ANIMAL

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07.26.2013 - Schematic Design

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**S7.5** 

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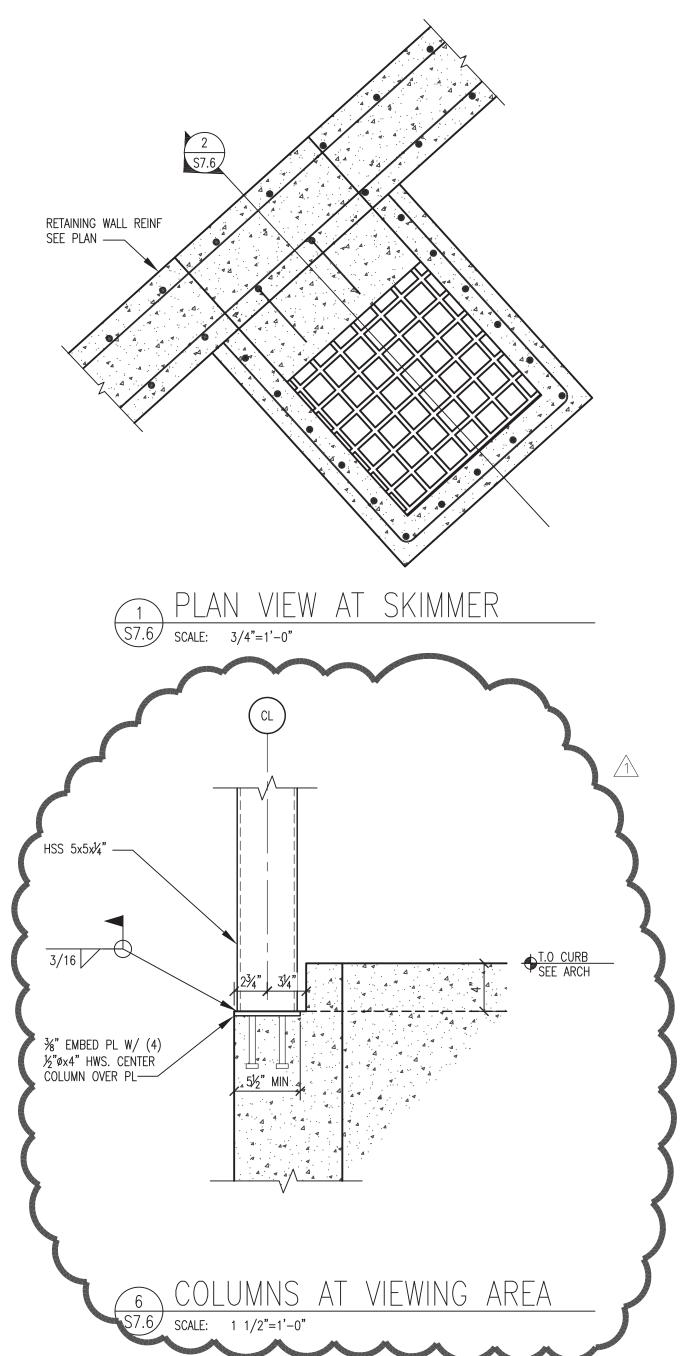
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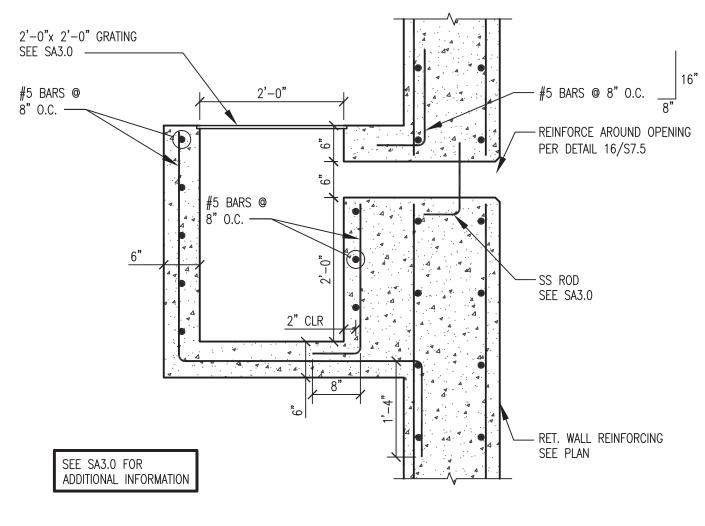
henry vilas

we do more

WDM Architects P.A.


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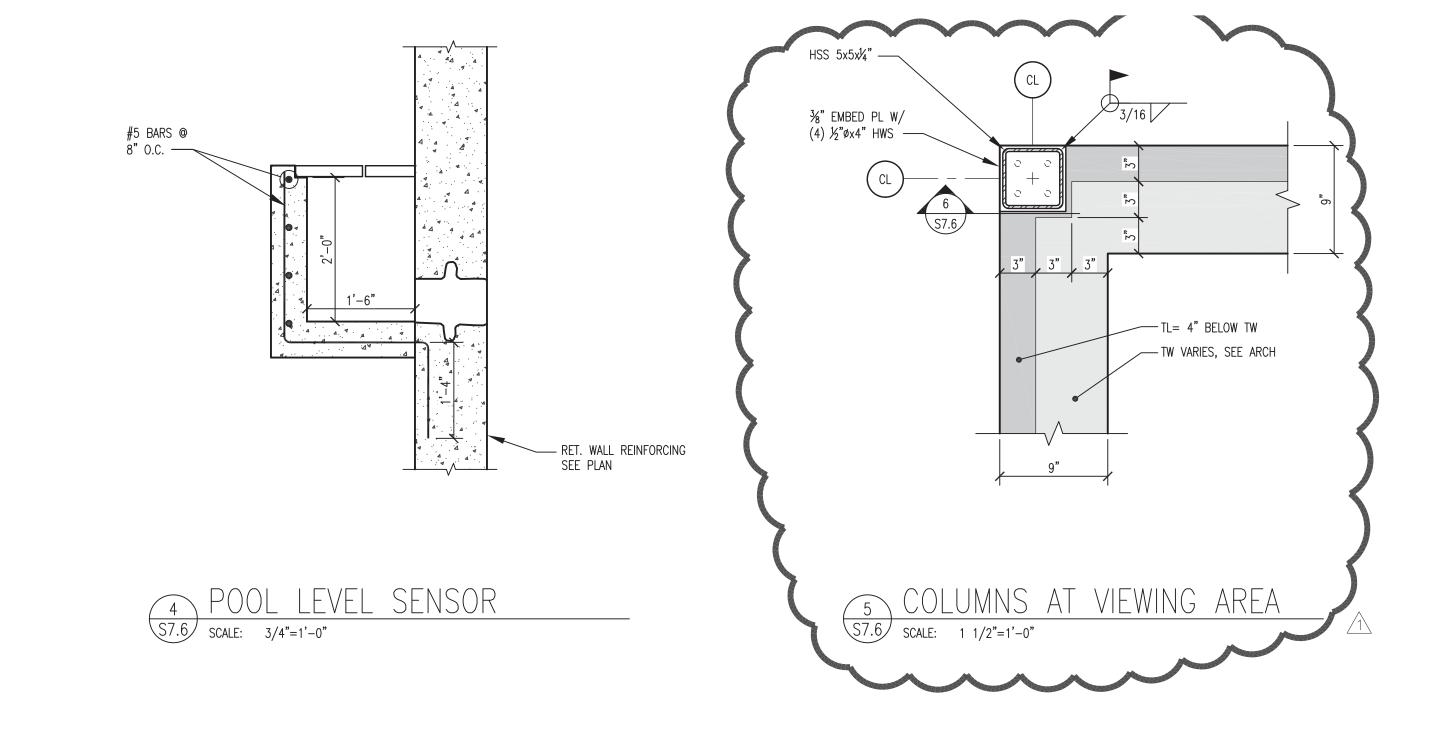



TYPICAL SKIMMER SECTION

S7.6 SCALE: 3/4"=1'-0"



3 POOL DRAIN S7.6 SCALE: 3/4"=1'-0"

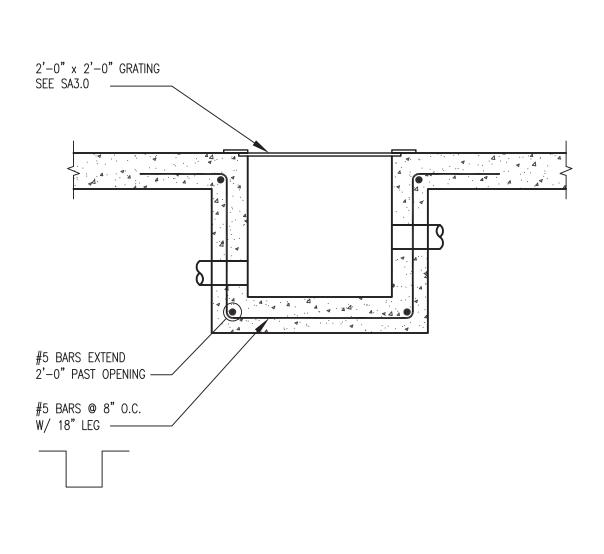

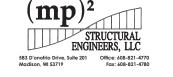



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RFB No. 313086

las Zoo - County of Dane

Department of Public Works

1919 Alliant Energy Center Way

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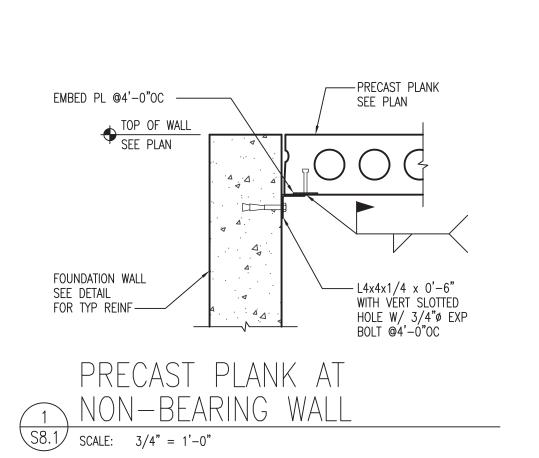
13046 checked: MP2


10.07.2013 - Pricing Set
10.21.2013 - 95% CD's
11.13.2013 - Bid Documents
11.25.2013 - Addendum #3

FOUNDATION DETAILS

**S7.6** 


ovright 2013 WDM Architec




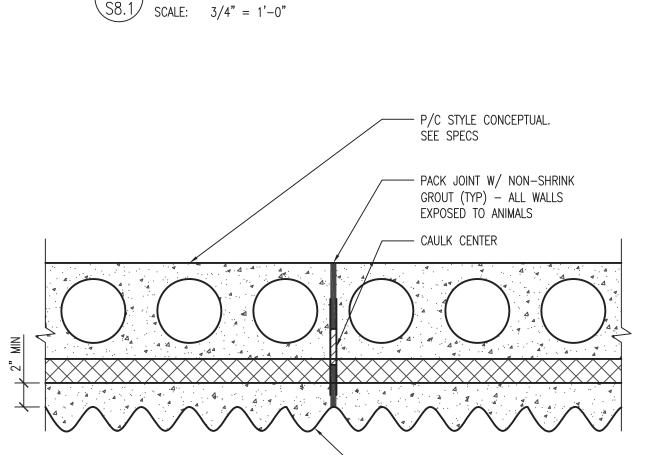


PRECAST JOINT 6 DETAIL @ ANIMAL EXPOSURE
S8.1 SCALE: 1 1/2"=1'-0"

SEE ARCH

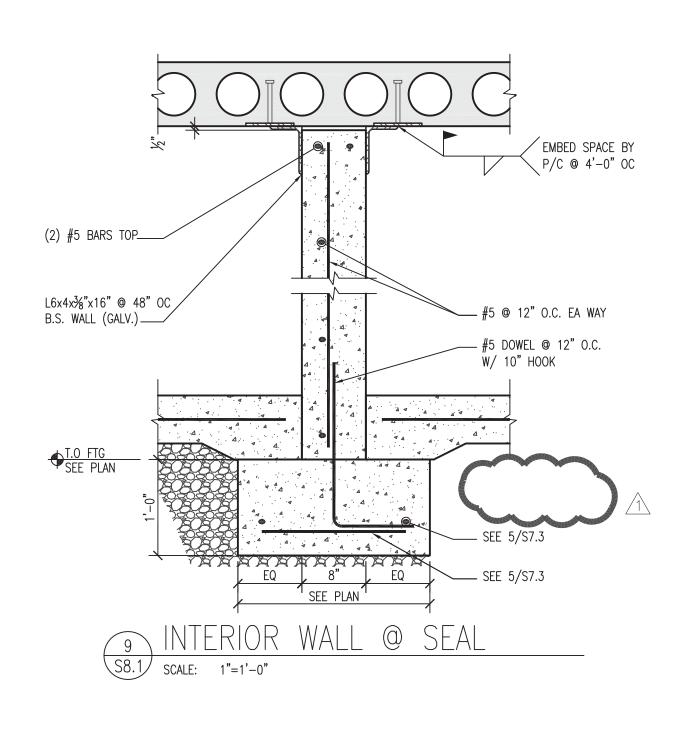


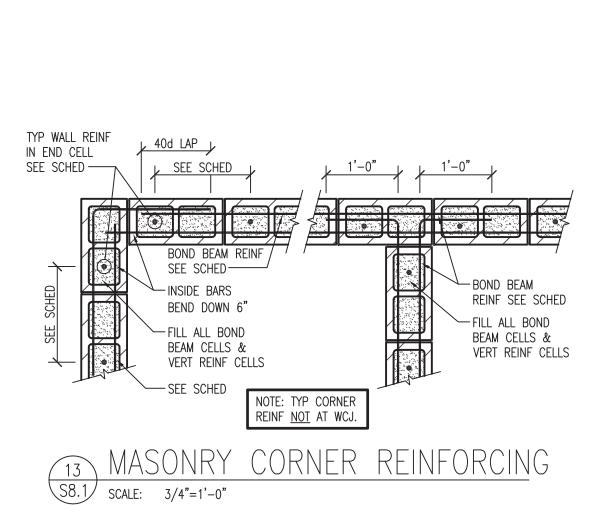


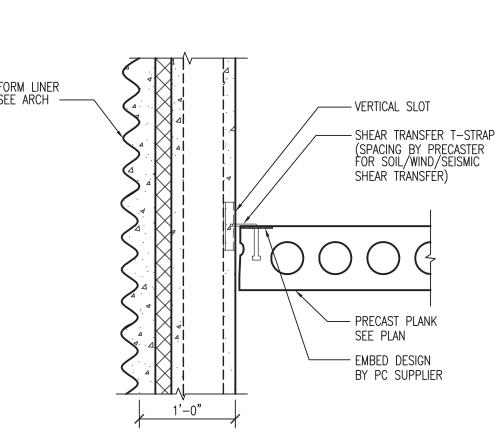


PRECAST DETAIL


S8.1 SCALE: 1" = 1'-0"

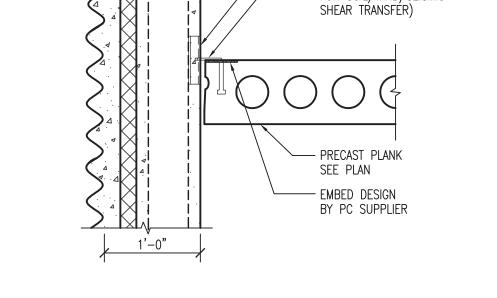

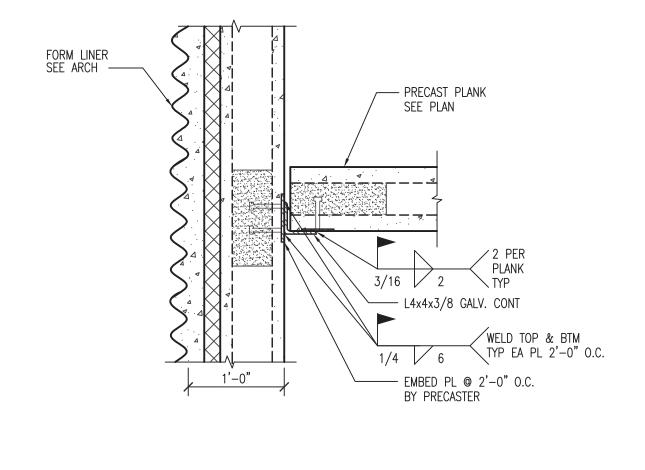


3 PRECAST DETAIL
S8.1 SCALE: 1" = 1'-0"

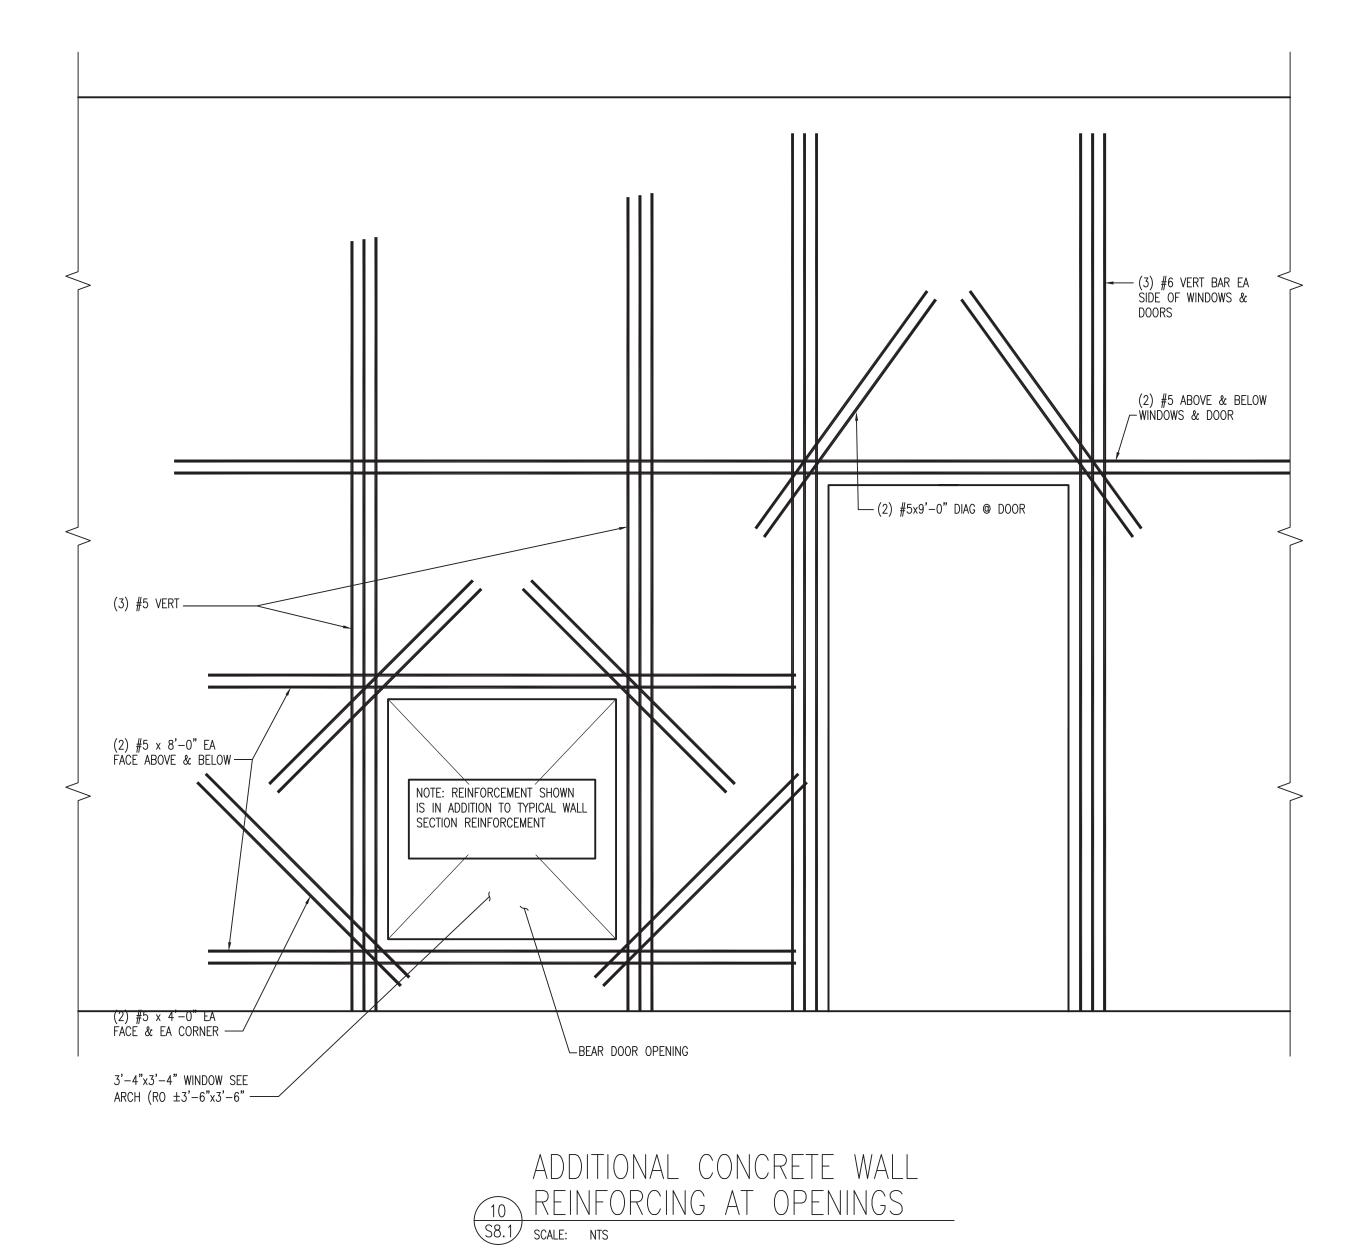


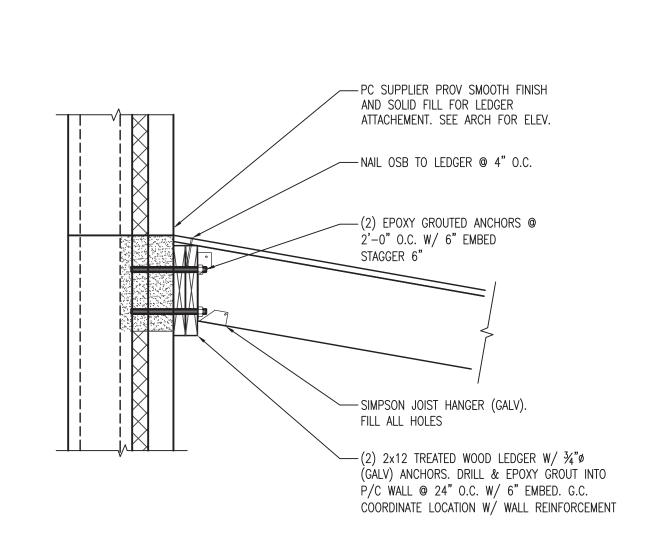



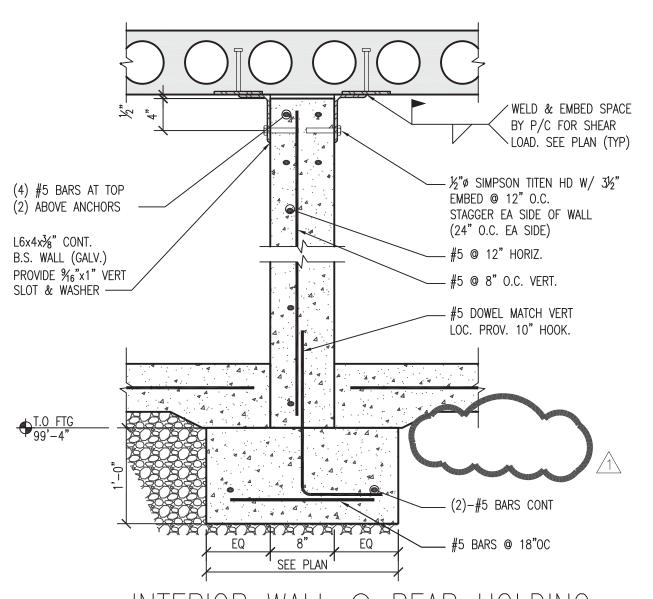





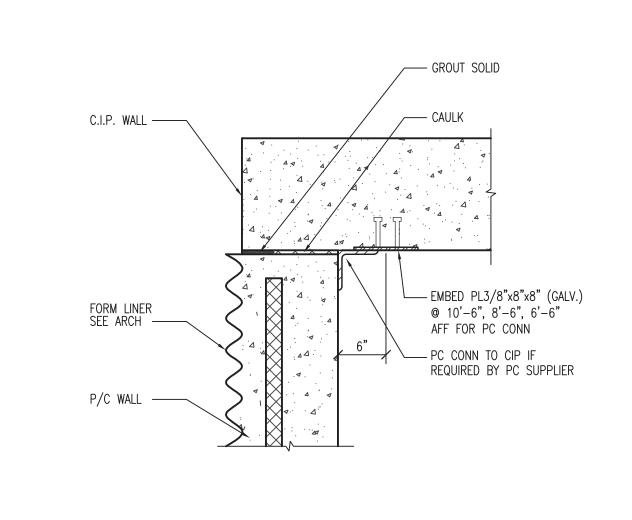


5 CIP TO PC AT BEAR HOLDING


S8.1 SCALE: 1" = 1'-0"

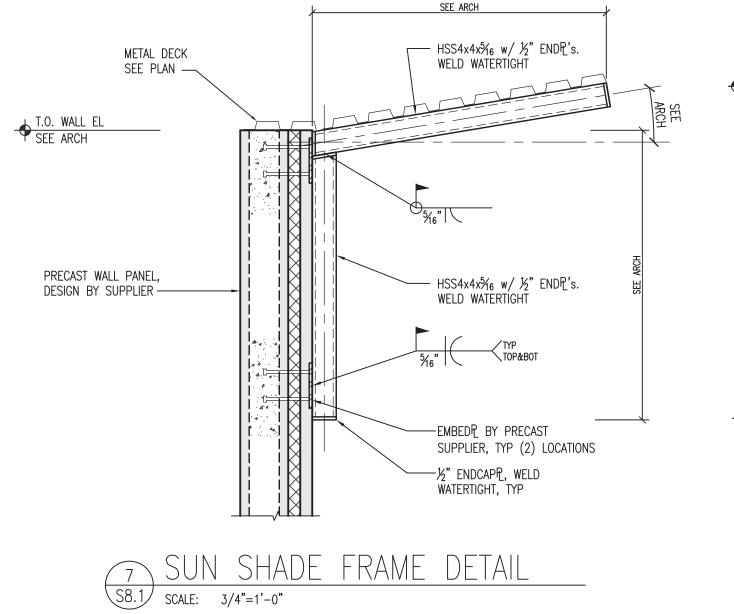


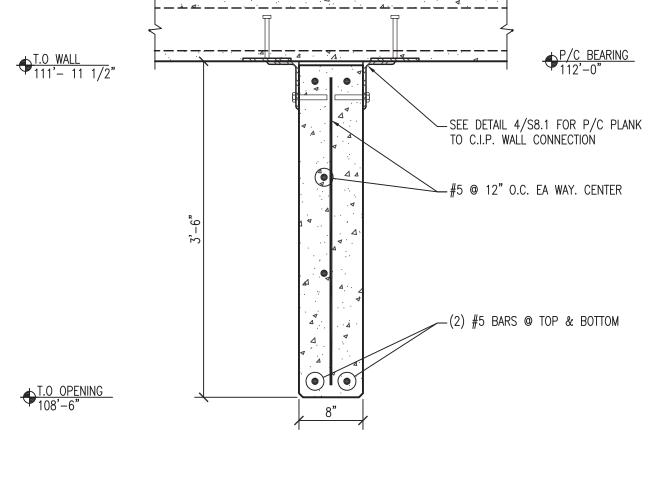



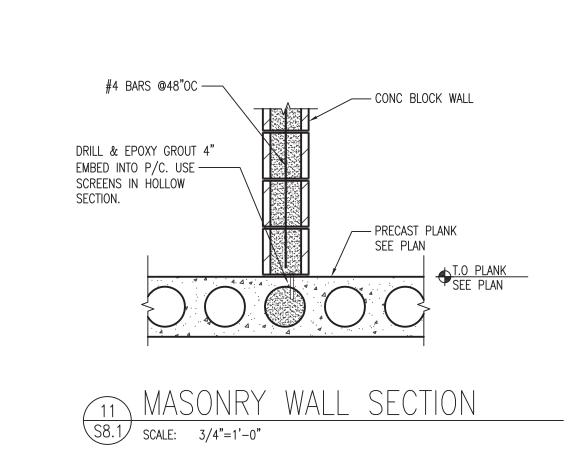

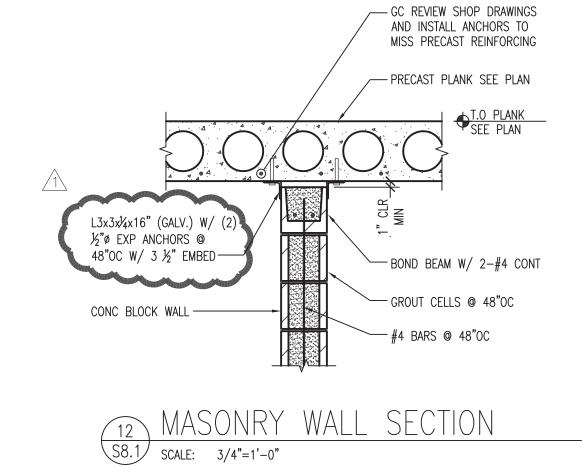

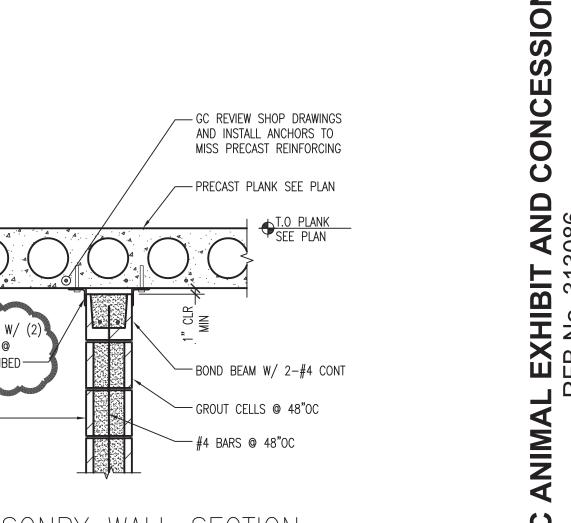

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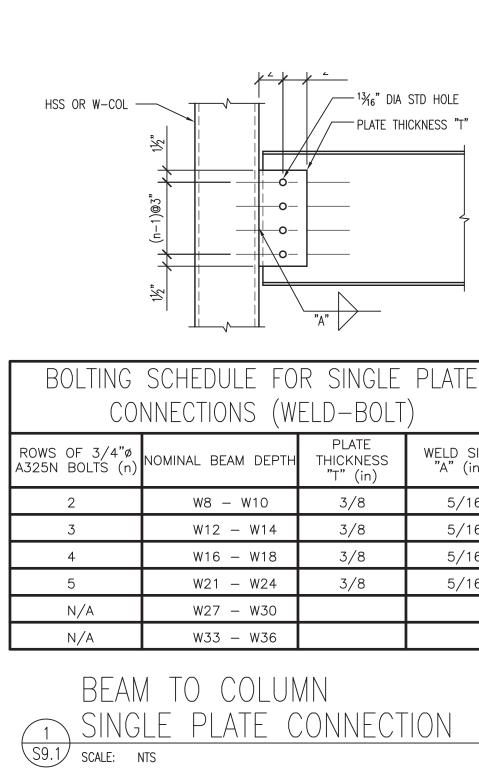
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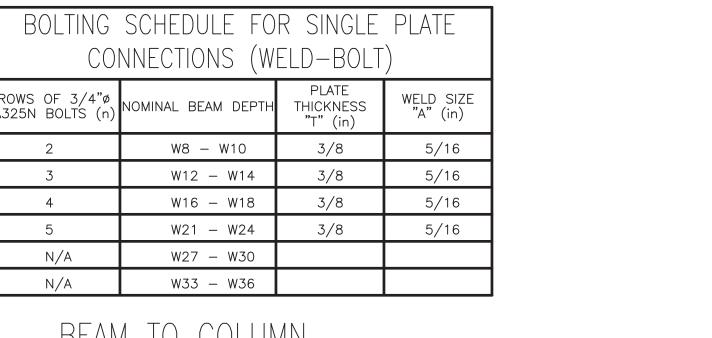
wdmarchitects.com

henry vilas



**S8.1** 





6 RIBS @ 6" = 36"

TYPICAL FASTENER LAYOUT

OF SPANS

SUPPORT CONN PATTERN

36/5

OR WELD | SCREWS

TYPE B-36, F-36

ROOF DECK

DECK TYPE (DEPTH) Sx pos Sx neg

ALL DECK PROPERTIES SHOWN SHALL BE WITHIN ± 3%
 SEE ARCHITECTURAL PLAN FOR PITCH CHANGES & FINISH.

4. ENDLAPS SHALL OCCUR AT SUPPORT POINTS.


S9.1 SCALE: NTS

병 MIN SECTION PROPERTIES DESIGN #

PROVIDE BUILDEX SCREW PER BUILDEX REPORT NO. 845 FOR SELF-DRILLING SCREWS.

10 AND DECK ATTACHMENT

METAL DECK SCHEDULE

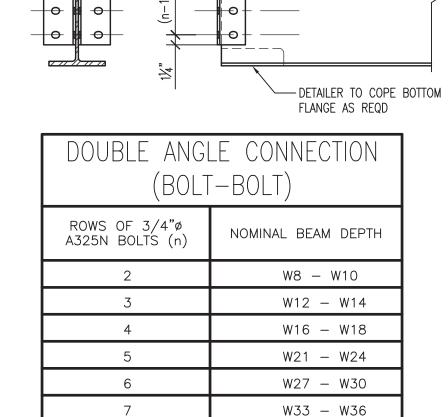

BEAM TO BEAM


HSS COLUMN SEE PLAN ----


6 STEEL SECTION

S9.1 SCALE: 1"=1'-0"

\$9.1 SCALE: 3/4"=1'-0"

/—(2) L4x3½x $\frac{1}{2}$ 6 A36 W/  $\frac{13}{6}$ "x1" HORIZ SLOTS
IN O.S.L. GAGE=5½"

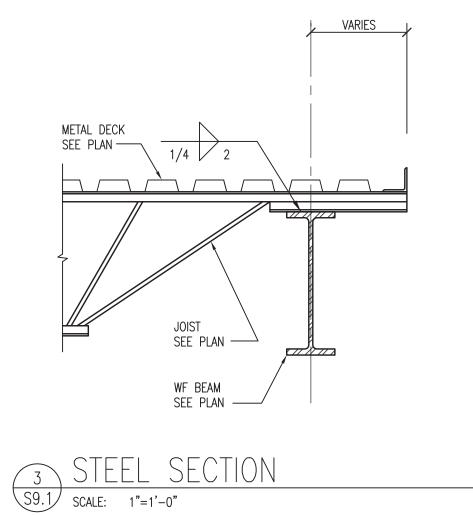


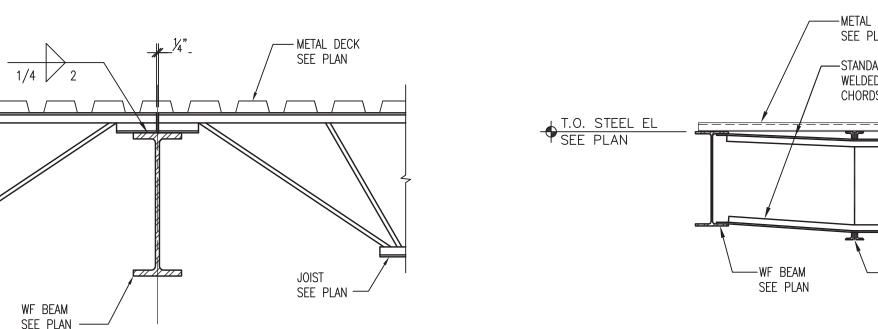


—PRECAST WALL PANEL, DESIGN BY SUPPLIER

\_\_\_\_L6x6x¾ xCONT


---JOIST SEE PLAN

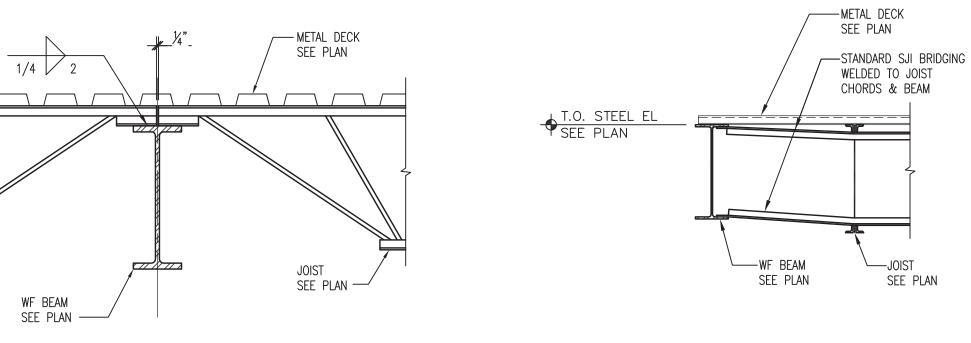


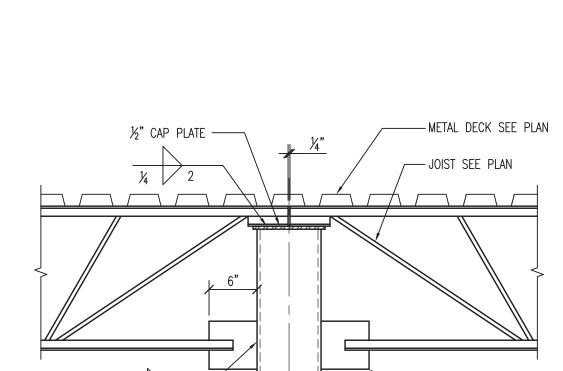


— PL¾"x6"x6" STABILIZER PLATE ON COLUMN CENTER LINE TYP DO NOT WELD DO NOT BOLT

2 DOUBLE ANGLE CONNECTION
S9.1 SCALE: NTS

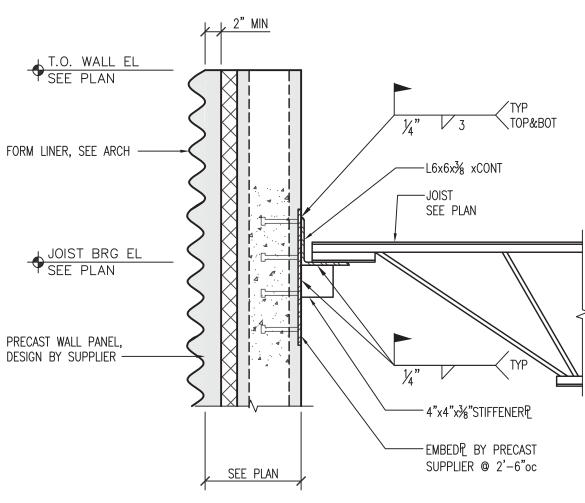


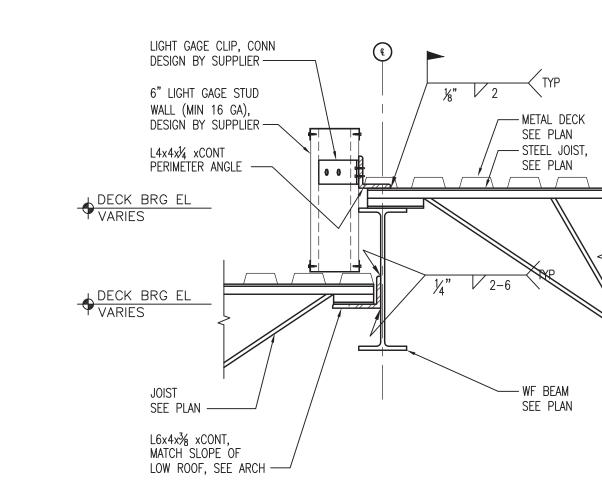

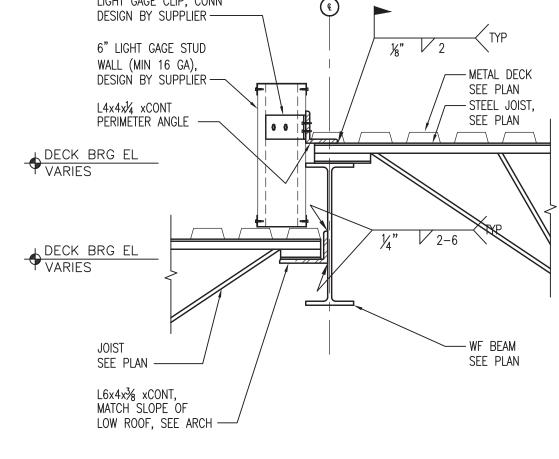

5 BRIDGING ANCHORAGE DETAIL

S9.1 SCALE: 3/4"=1'-0"

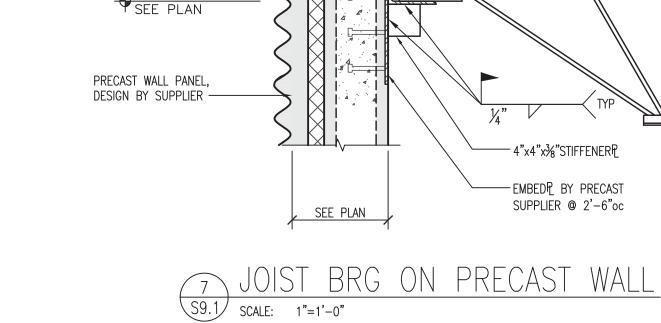

\$9.1 SCALE: 1"=1'-0"




4"x4"x%"STIFFENERP


-EMBED₽ BY PRECAST


SUPPLIER @ 2'-6"oc


STEEL SECTION
S9.1 SCALE: 1"=1'-0"




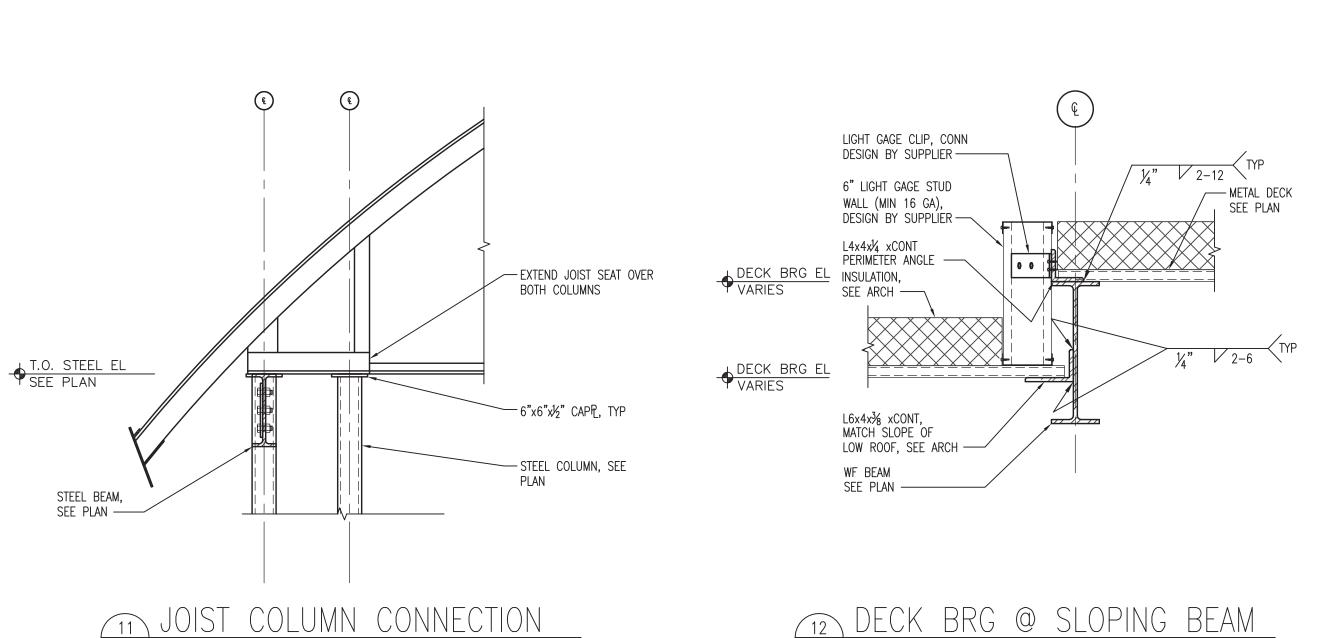

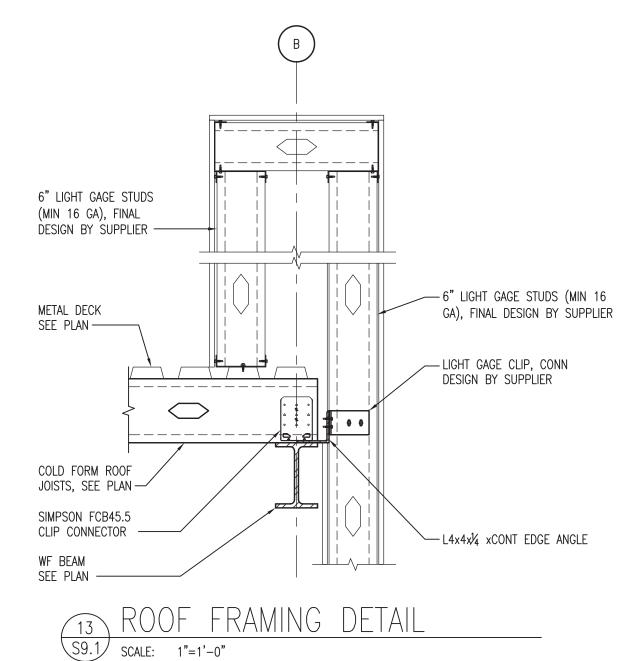

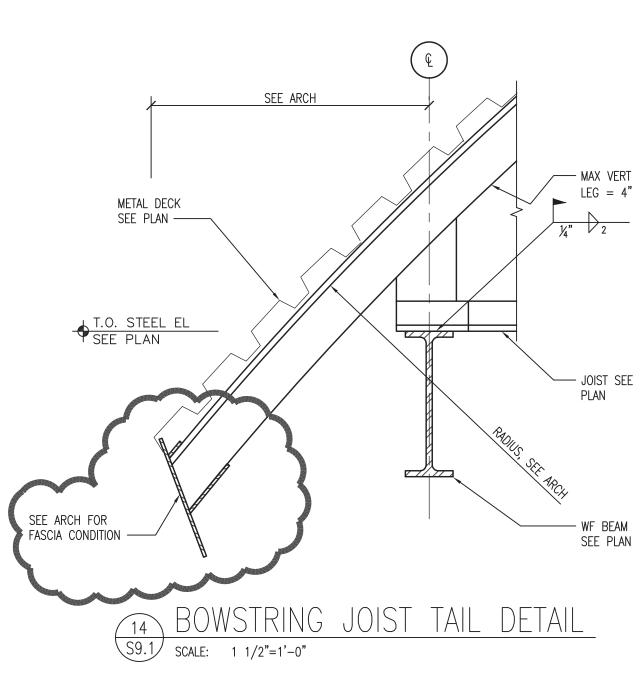

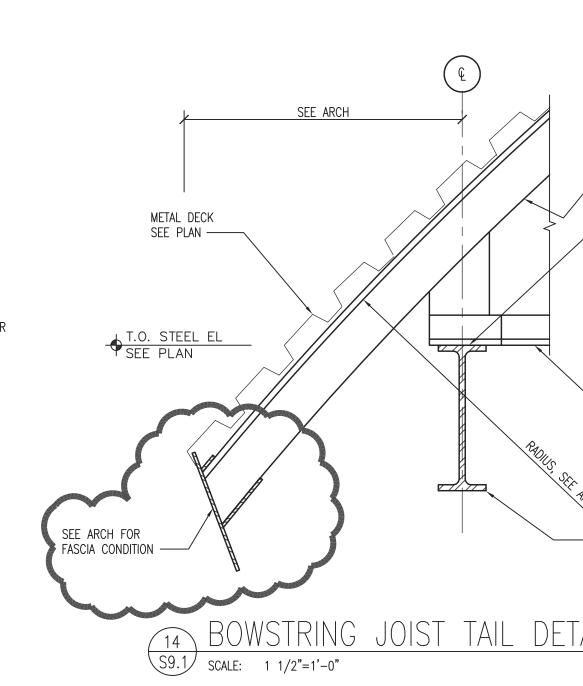


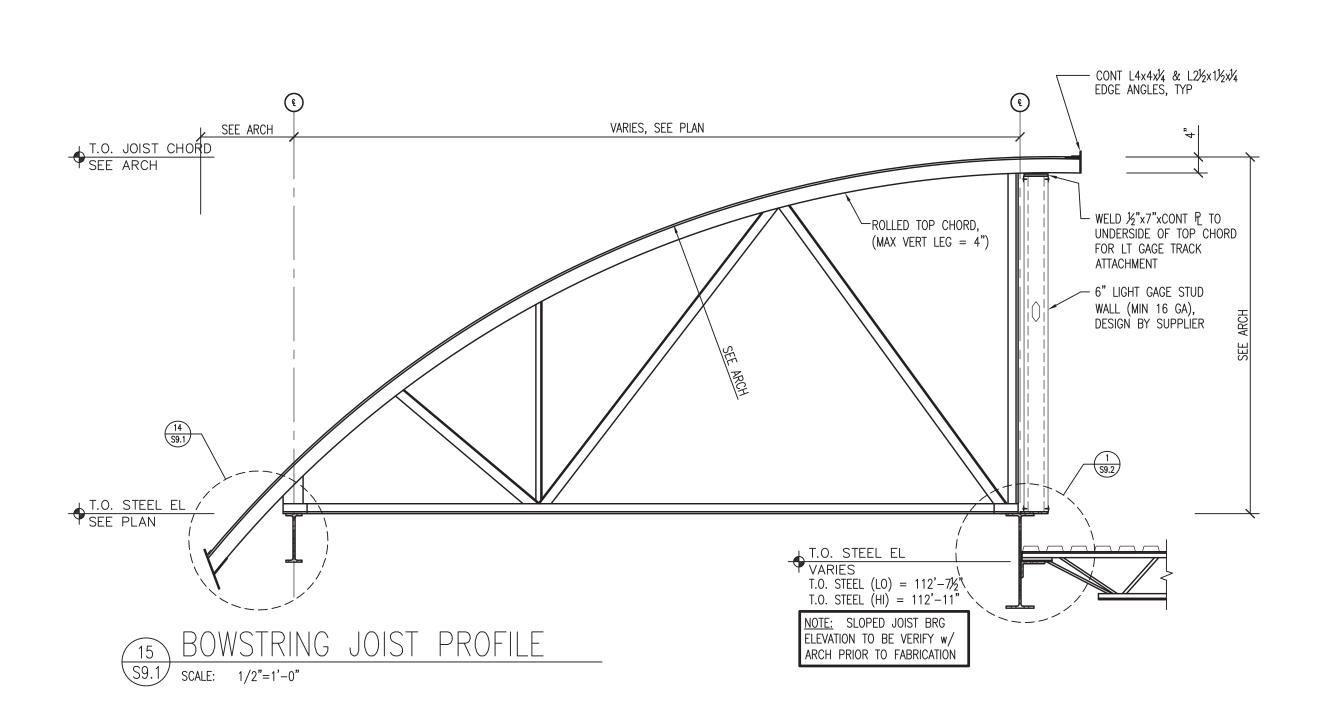



G H

SIDELAP CONN (PER SPAN)

2-#12 #12 SCREWS | SELF-DRILLING | 1,3

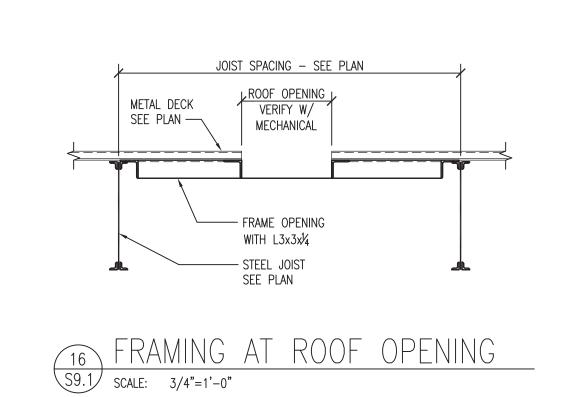

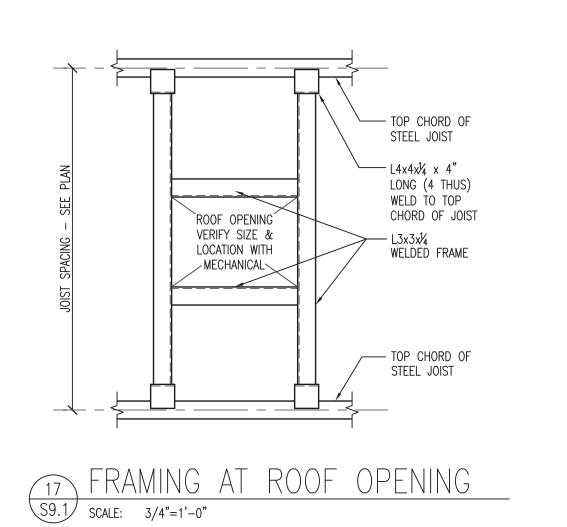

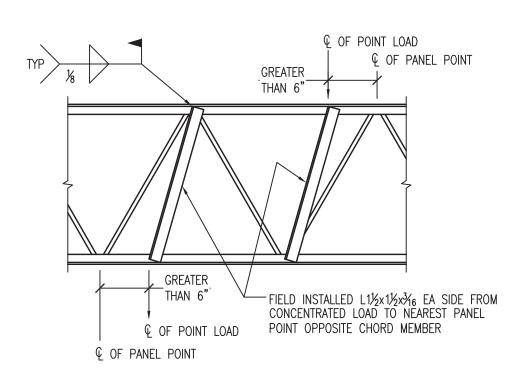



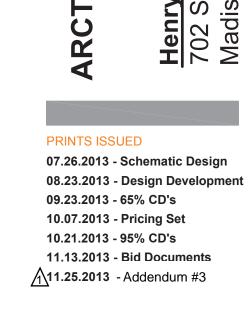


EXHIBIT
REB No. 313
SS Zoo - Co

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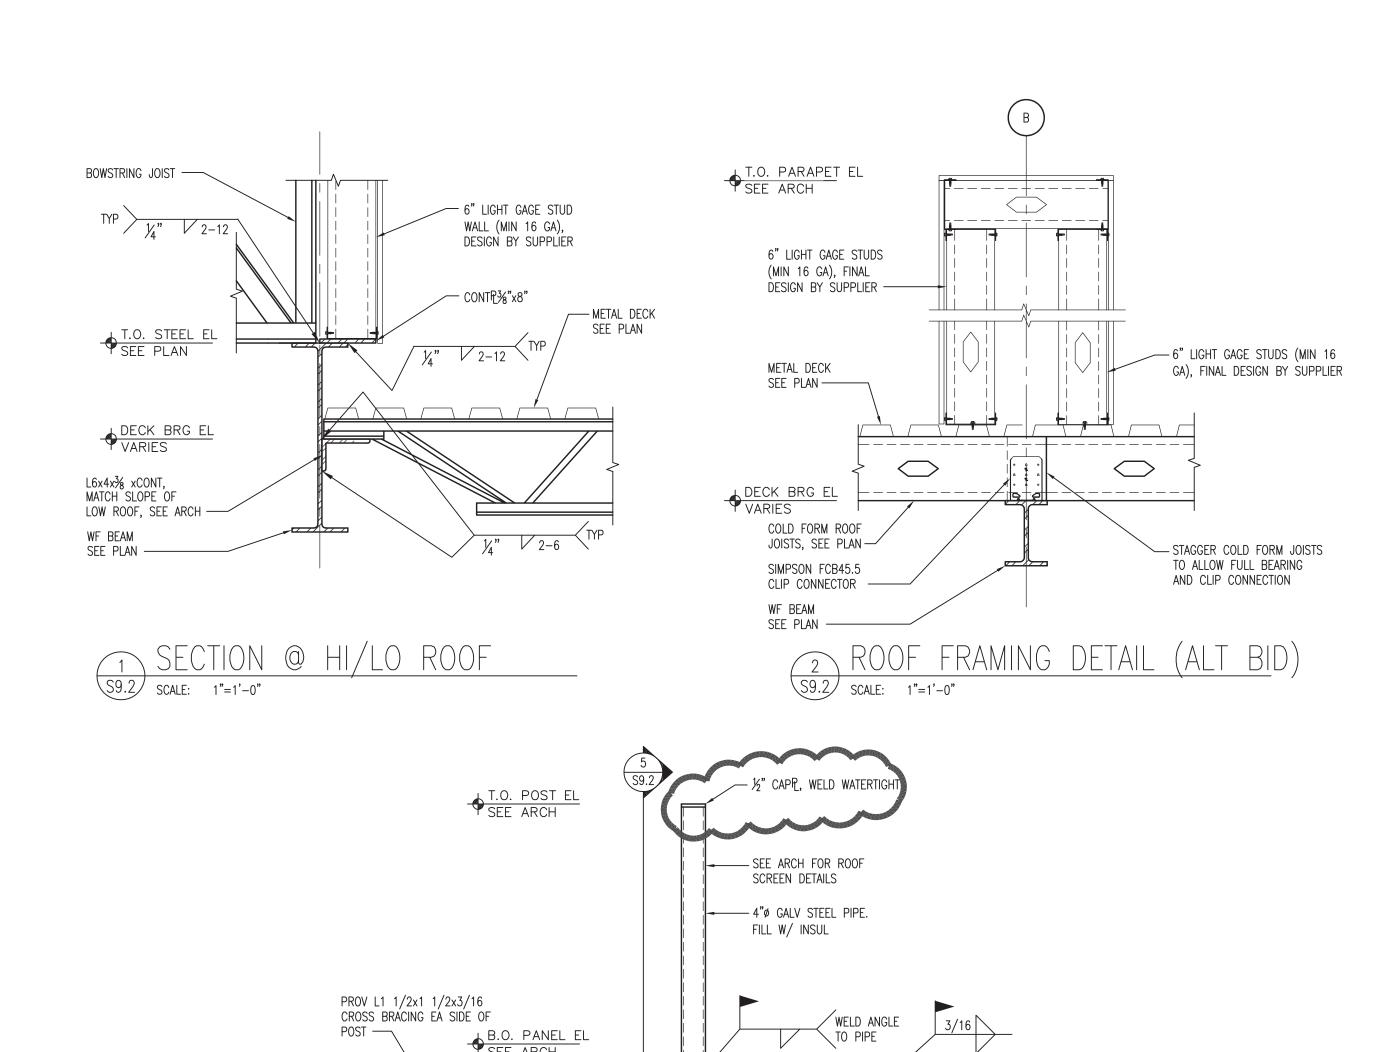
henry vilas

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**S9.1** 



NOTCH ANGLE (TYP FRAMED OPENING)

INSTALL VERT LATTICE
INLINE W/ CHANNEL
CONNECTION TYP EA JOIST


JOIST BRG EL VARIES, SEE PLAN


B.O. PANEL EL SEE ARCH


0.4k EA POST ——

C9x13.4 —

6 SHELF ANGLE BRACKET
S9.2 SCALE: 3/4"=1'-0"

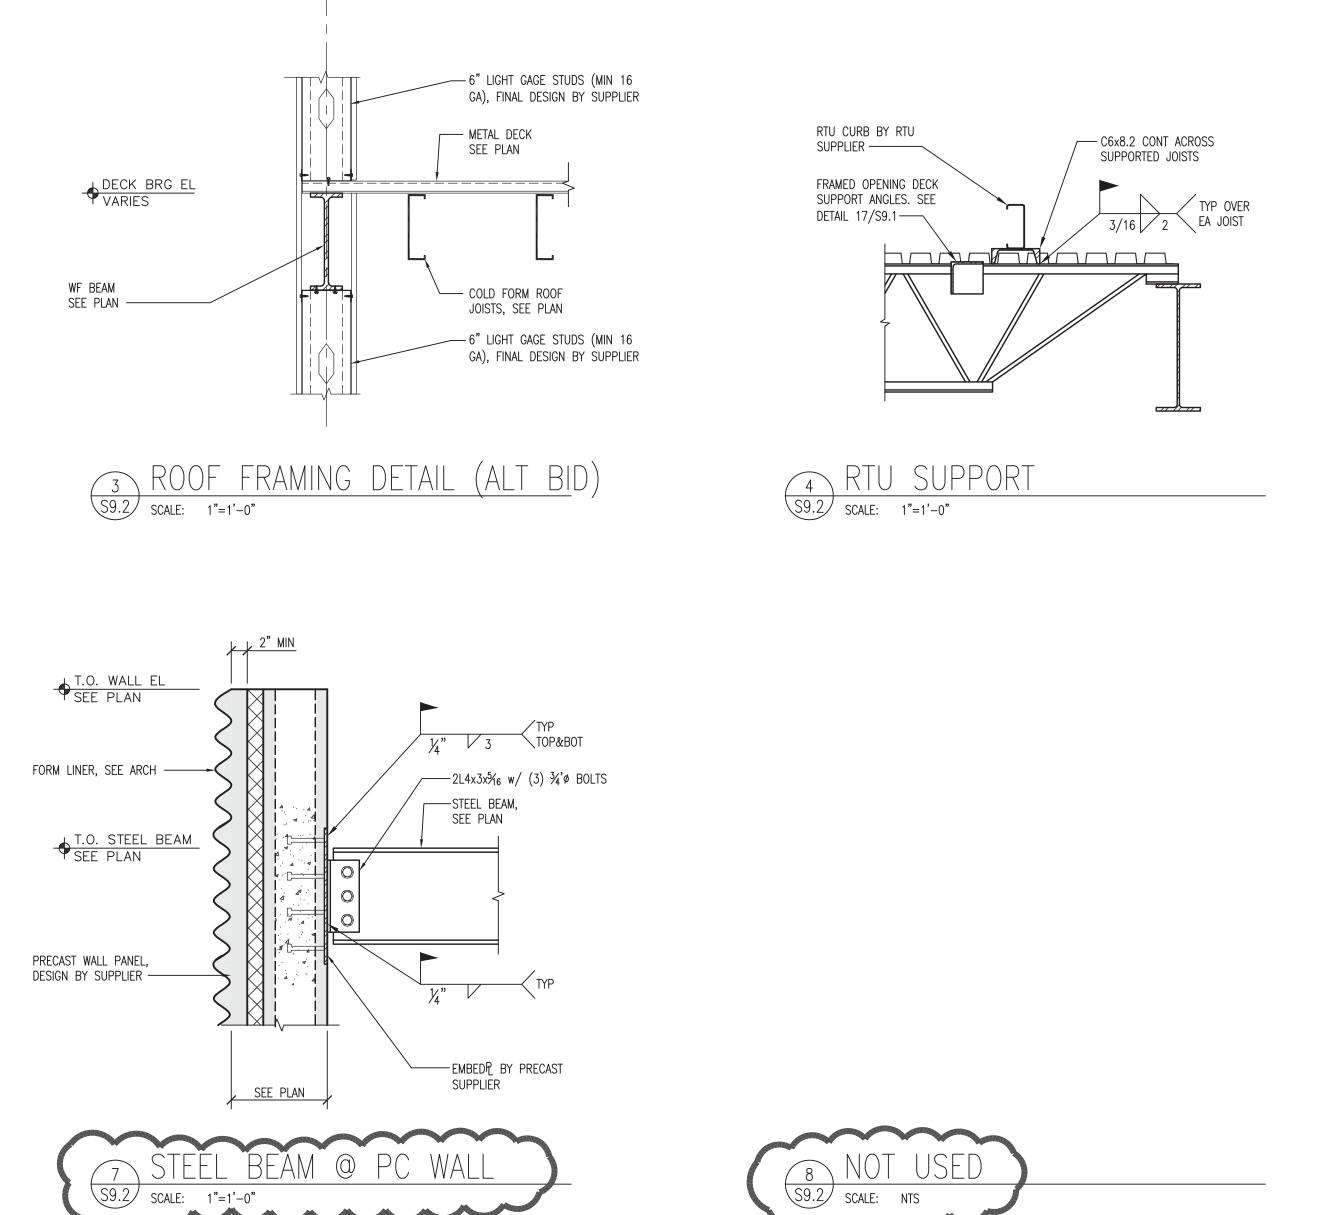

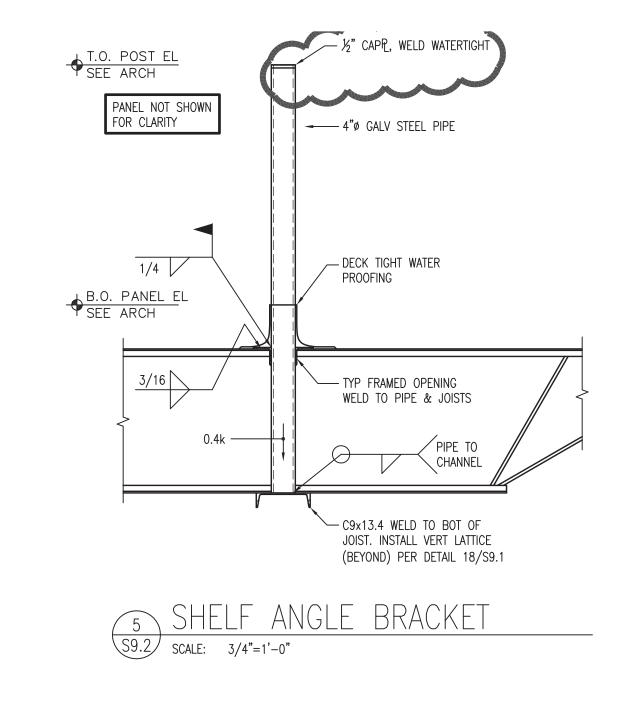


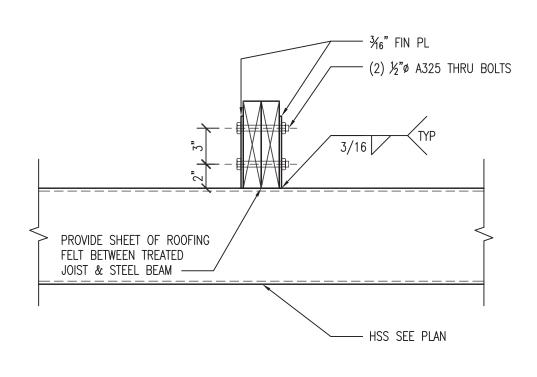






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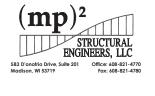
WDM No. drawn: MP2 STEEL FRAMING DETAILS

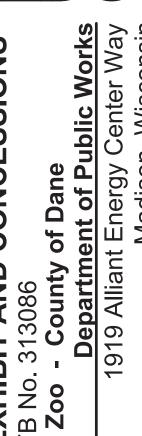




RETAINING WALLS SIZED USING THE FOLLOWING PRESUMPTIVE PARAMETERS:
 ALLOWABLE BEARING PRESSURE= 2,000 PSF EFP (ACTIVE) = 30 PSF

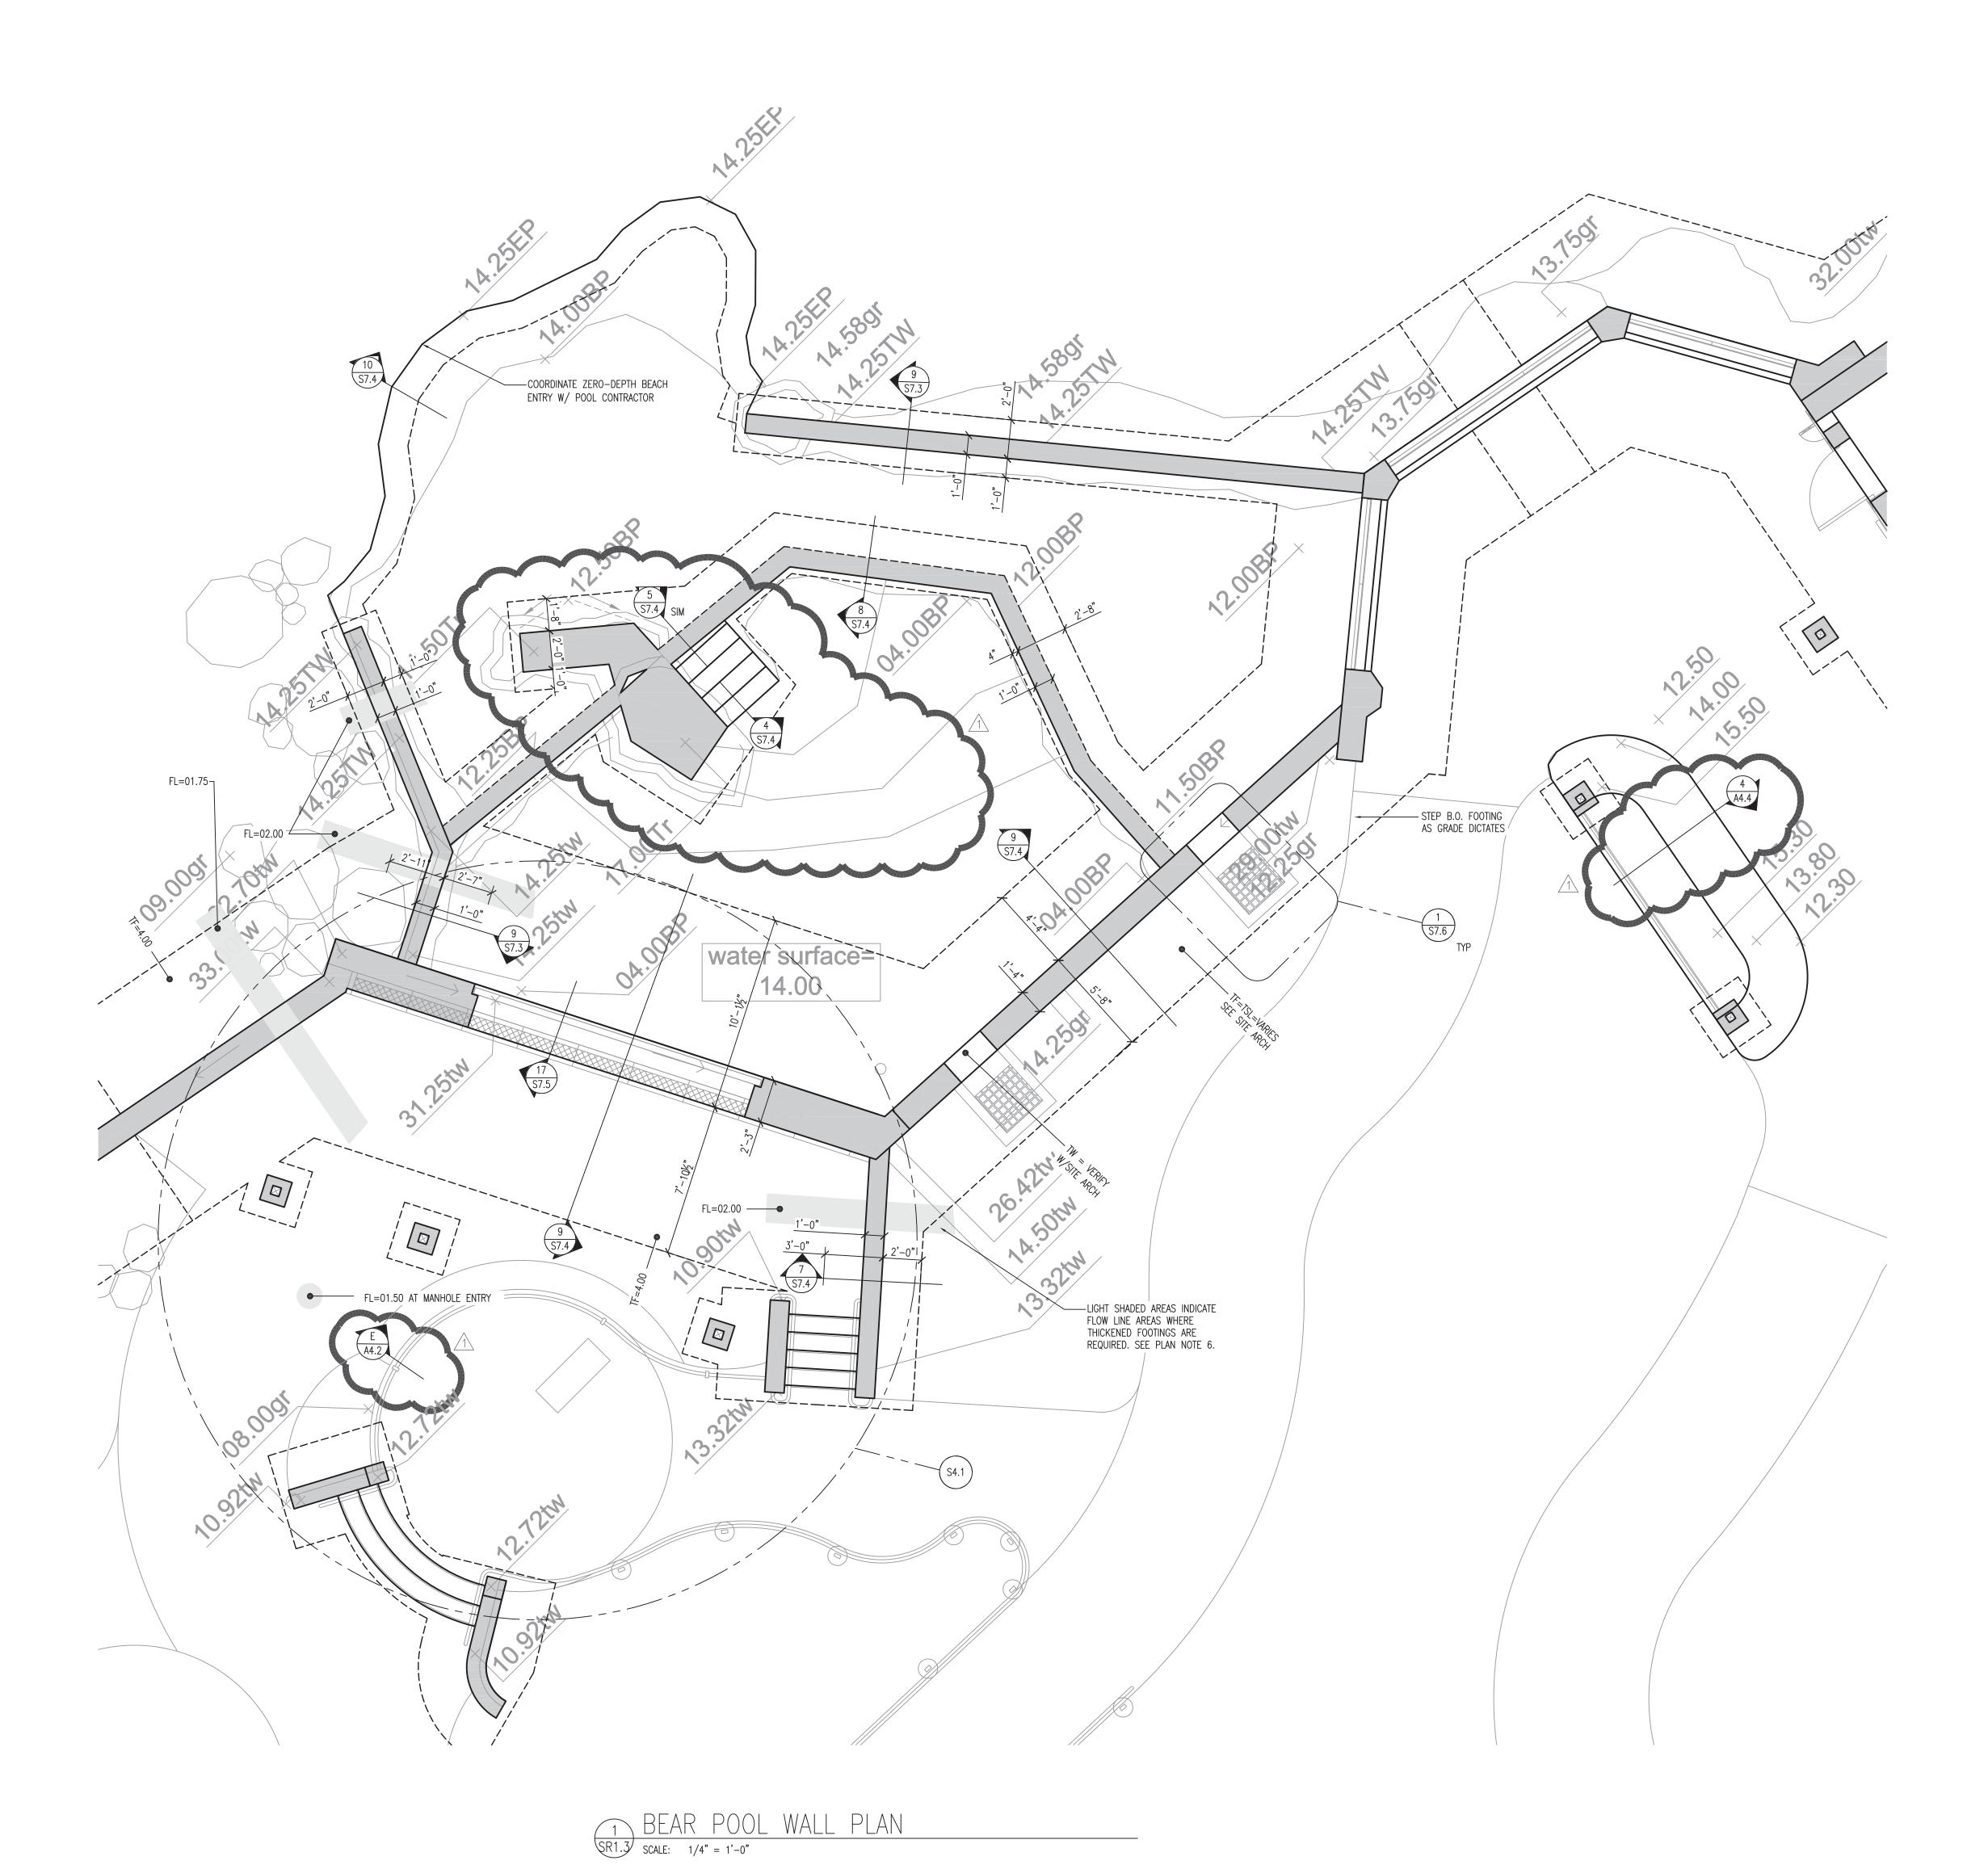- 2. WALL THICKNESS SHOWN ON THE PLANS IS THE MINIMUM THICKNESS REQUIRED & DOES NOT INCLUDE FORM LINER PROFILE. INCREASE WALL THICKNESS AS REQUIRED TO ACCOMMODATE FORM LINER. SEE ARCH FOR FORM LINER SPECIFICATION.
- 3. GEOTECHNICAL INFORMATION TAKEN FROM CGC EXPLORATION REPORT. SEE SO.1.
- 4. SEE SHEET S7.4 DETAIL 11 FOR EXTENSION AT EXISTING SITE RETAINING WALLS.
- 5. SEE SHEET S7.4 DETAIL 12 FOR TYPICAL EXISTING CAST—IN—PLACE WALL OPENING INFILL REQUIREMENTS.
- 6. THICKEN FOOTING IN LOCATIONS INDICATED TO ACHIEVE 6"
  CONCRETE BELOW FLOW LINE ELEVATIONS PER SA6.0 UNDERSLAB
  DRAINAGE PLAN.
- 7. SEE SHEET S7.5 DETAILS 15 & 16 FOR ADDED REINFORCING AT ROUND & RECTANGULAR OPENINGS, UNLESS NOTED OTHERWISE.
- 8. REFERENCE SITE ARCH FOR ALL WALL OPENING LOCATIONS & SIZES.
- 9. SEE SHEET S7.4 DETAIL 1 FOR CONTROL JOINT & EXPANSION JOINT REQUIREMENTS.
- 10. SEE SHEET S7.1 DETAILS 2 & 3 FOR FOOTING & WALL CORNER REINFORCING.
- 11. SEE SHEET S7.6 DETAIL 4 FOR REINFORCEMENT AT POOL LEVEL SENSOR.





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10.07.2013 - Pricing Set
10.21.2013 - 95% CD's
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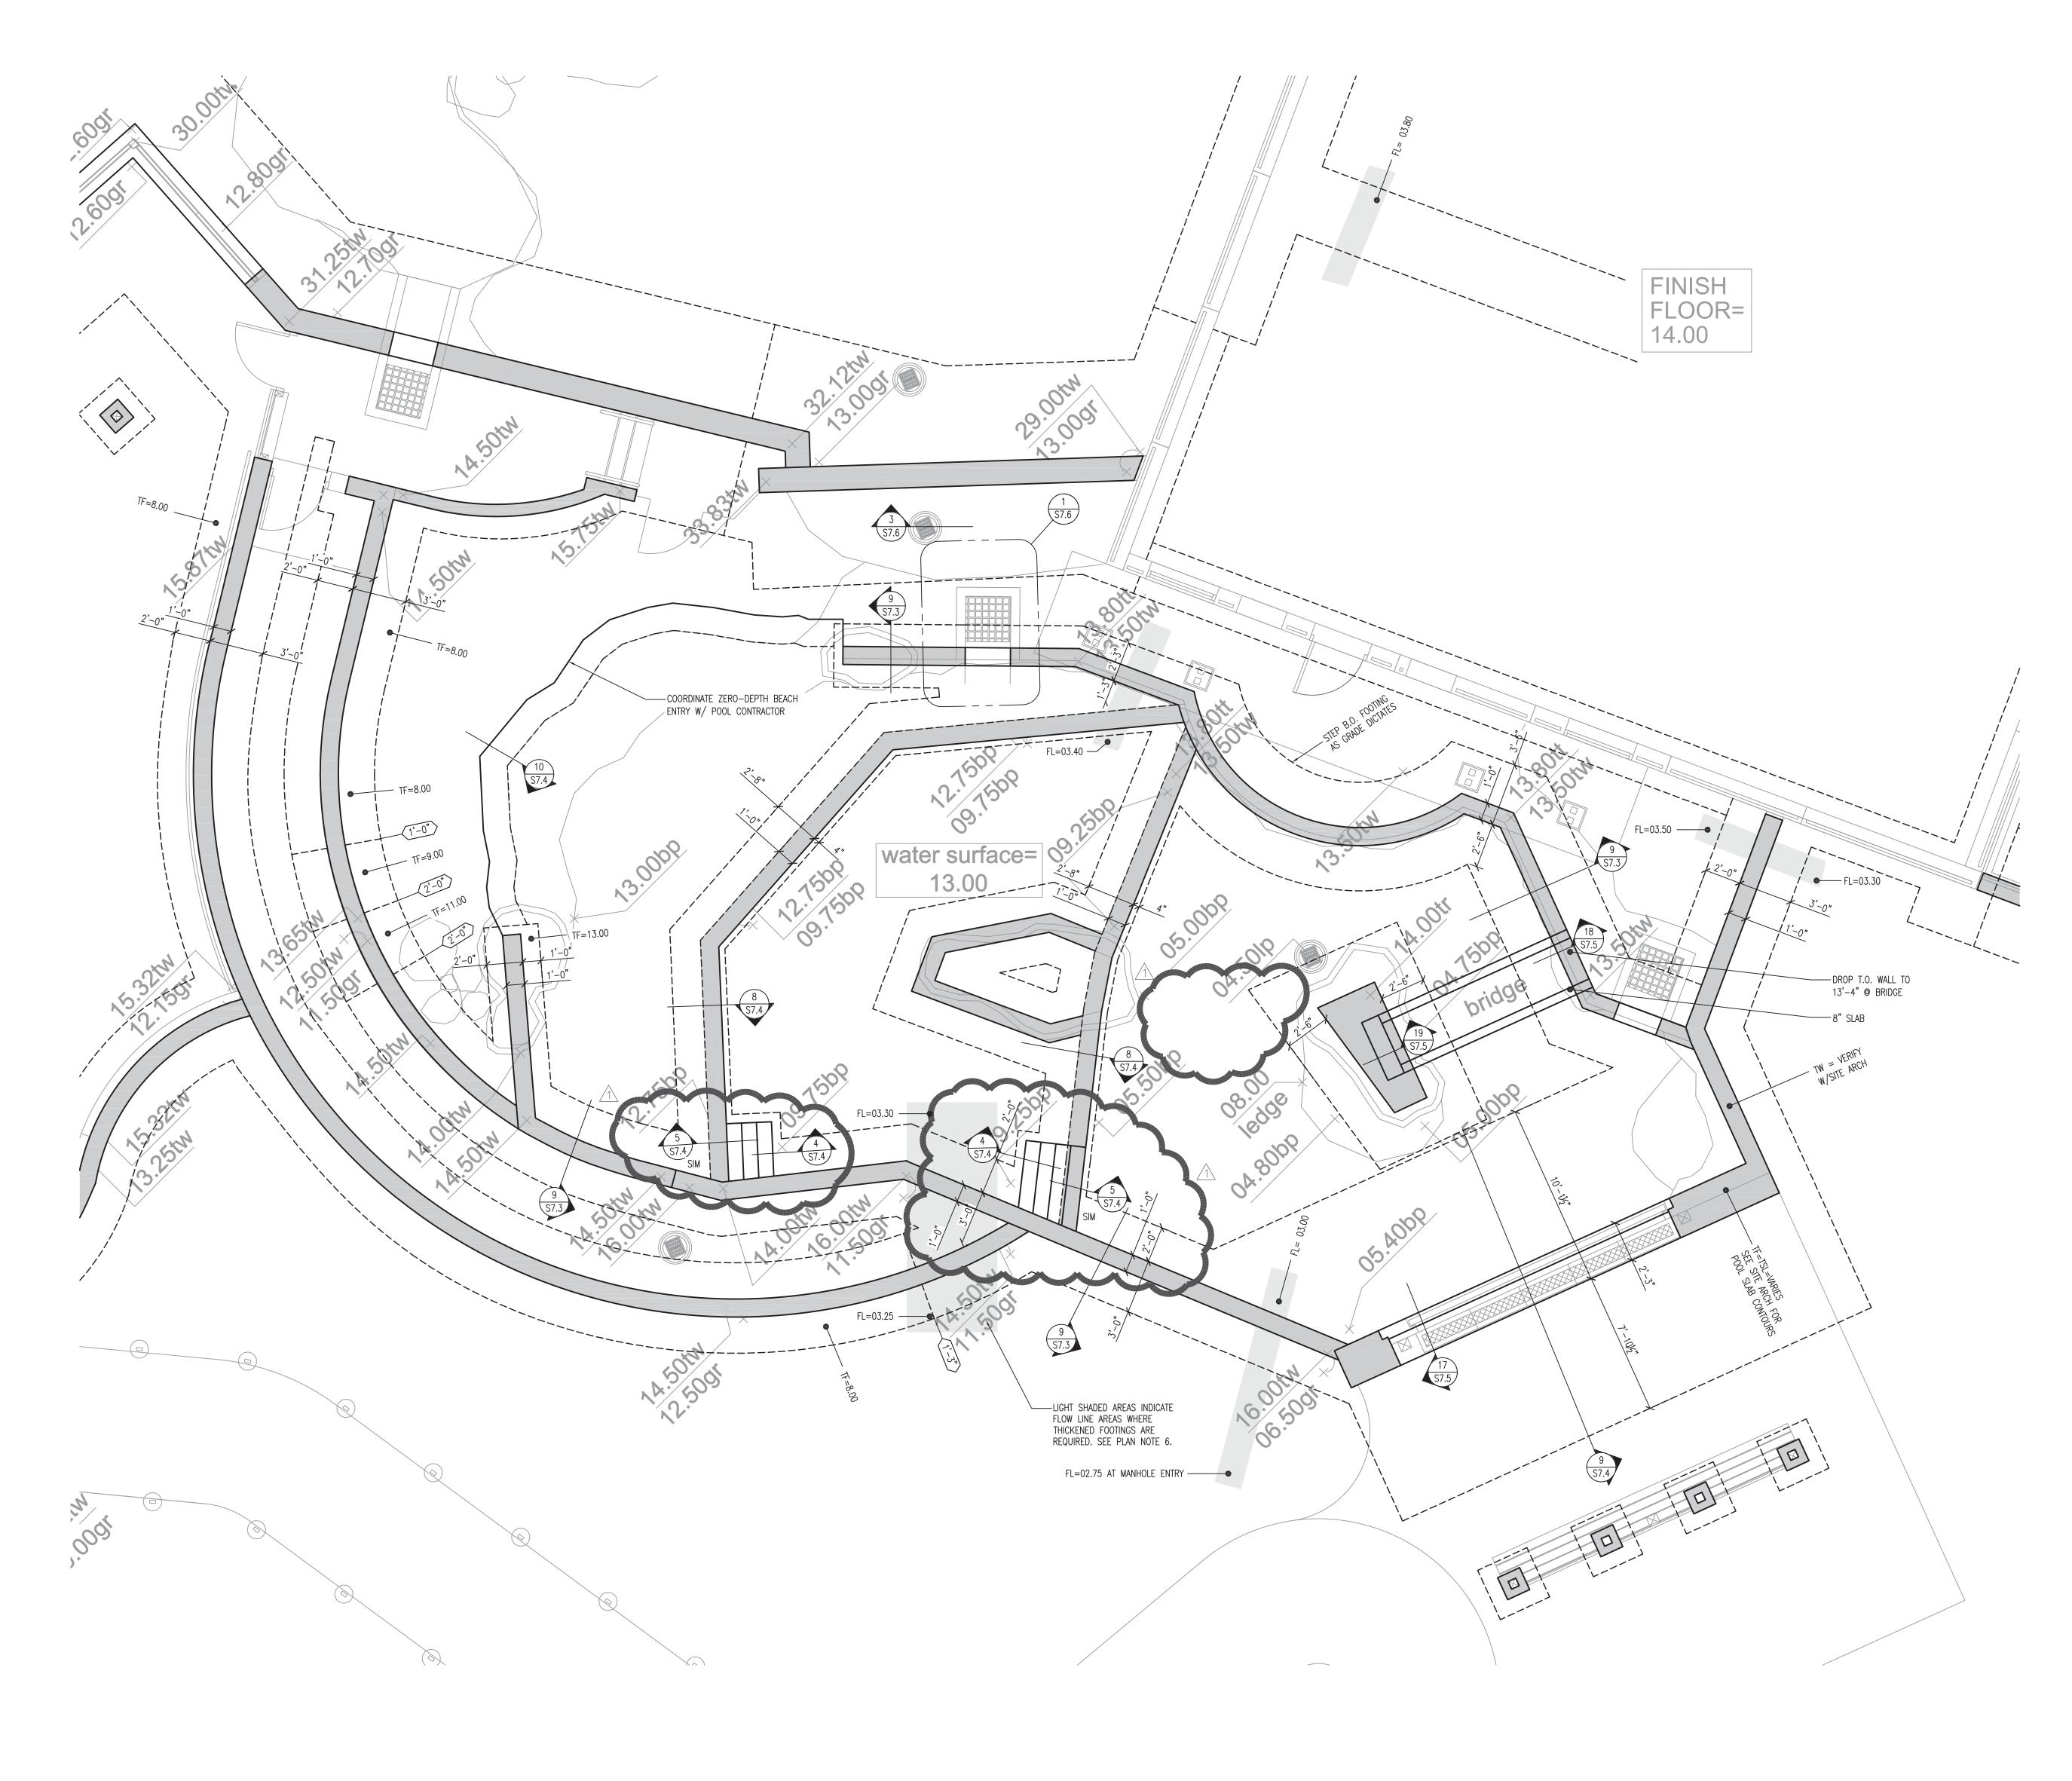
↑11.25.2013 - Addendum #3

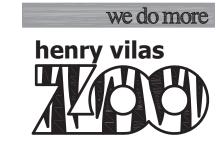MDM No. drawn: MP2

13046 checked: MP2

BEAR POOL WALL PLAN

SR1.3





PLAN NOTES

1. RETAINING WALLS SIZED USING THE FOLLOWING PRESUMPTIVE PARAMETERS:


ALLOWABLE BEARING PRESSURE= 2,000 PSF EFP (ACTIVE) = 30 PSF

- 2. WALL THICKNESS SHOWN ON THE PLANS IS THE MINIMUM THICKNESS REQUIRED & DOES NOT INCLUDE FORM LINER PROFILE. INCREASE WALL THICKNESS AS REQUIRED TO ACCOMMODATE FORM LINER. SEE ARCH FOR FORM LINER SPECIFICATION.
- 3. GEOTECHNICAL INFORMATION TAKEN FROM CGC EXPLORATION REPORT. SEE S0.1.
- 4. SEE SHEET S7.4 DETAIL 11 FOR EXTENSION AT EXISTING SITE RETAINING WALLS.
- 5. SEE SHEET S7.4 DETAIL 12 FOR TYPICAL EXISTING CAST—IN—PLACE WALL OPENING INFILL REQUIREMENTS.
- 6. THICKEN FOOTING IN LOCATIONS INDICATED TO ACHIEVE 6"
  CONCRETE BELOW FLOW LINE ELEVATIONS PER SA6.0 UNDERSLAB
  DRAINAGE PLAN.
- 7. SEE SHEET S7.5 DETAILS 15 & 16 FOR ADDED REINFORCING AT ROUND & RECTANGULAR OPENINGS, UNLESS NOTED OTHERWISE.
- 8. REFERENCE SITE ARCH FOR ALL WALL OPENING LOCATIONS & SIZES.
- 9. SEE SHEET S7.4 DETAIL 1 FOR CONTROL JOINT & EXPANSION JOINT REQUIREMENTS.

10. SEE SHEET S7.1 DETAILS 2 & 3 FOR FOOTING & WALL CORNER

11. SEE SHEET S7.6 DETAIL 4 FOR REINFORCEMENT AT POOL LEVEL

1 SEAL POOL WALL PLAN
SR1.4 SCALE: 1/4" = 1'-0"

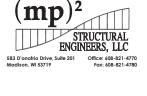

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o. 313086

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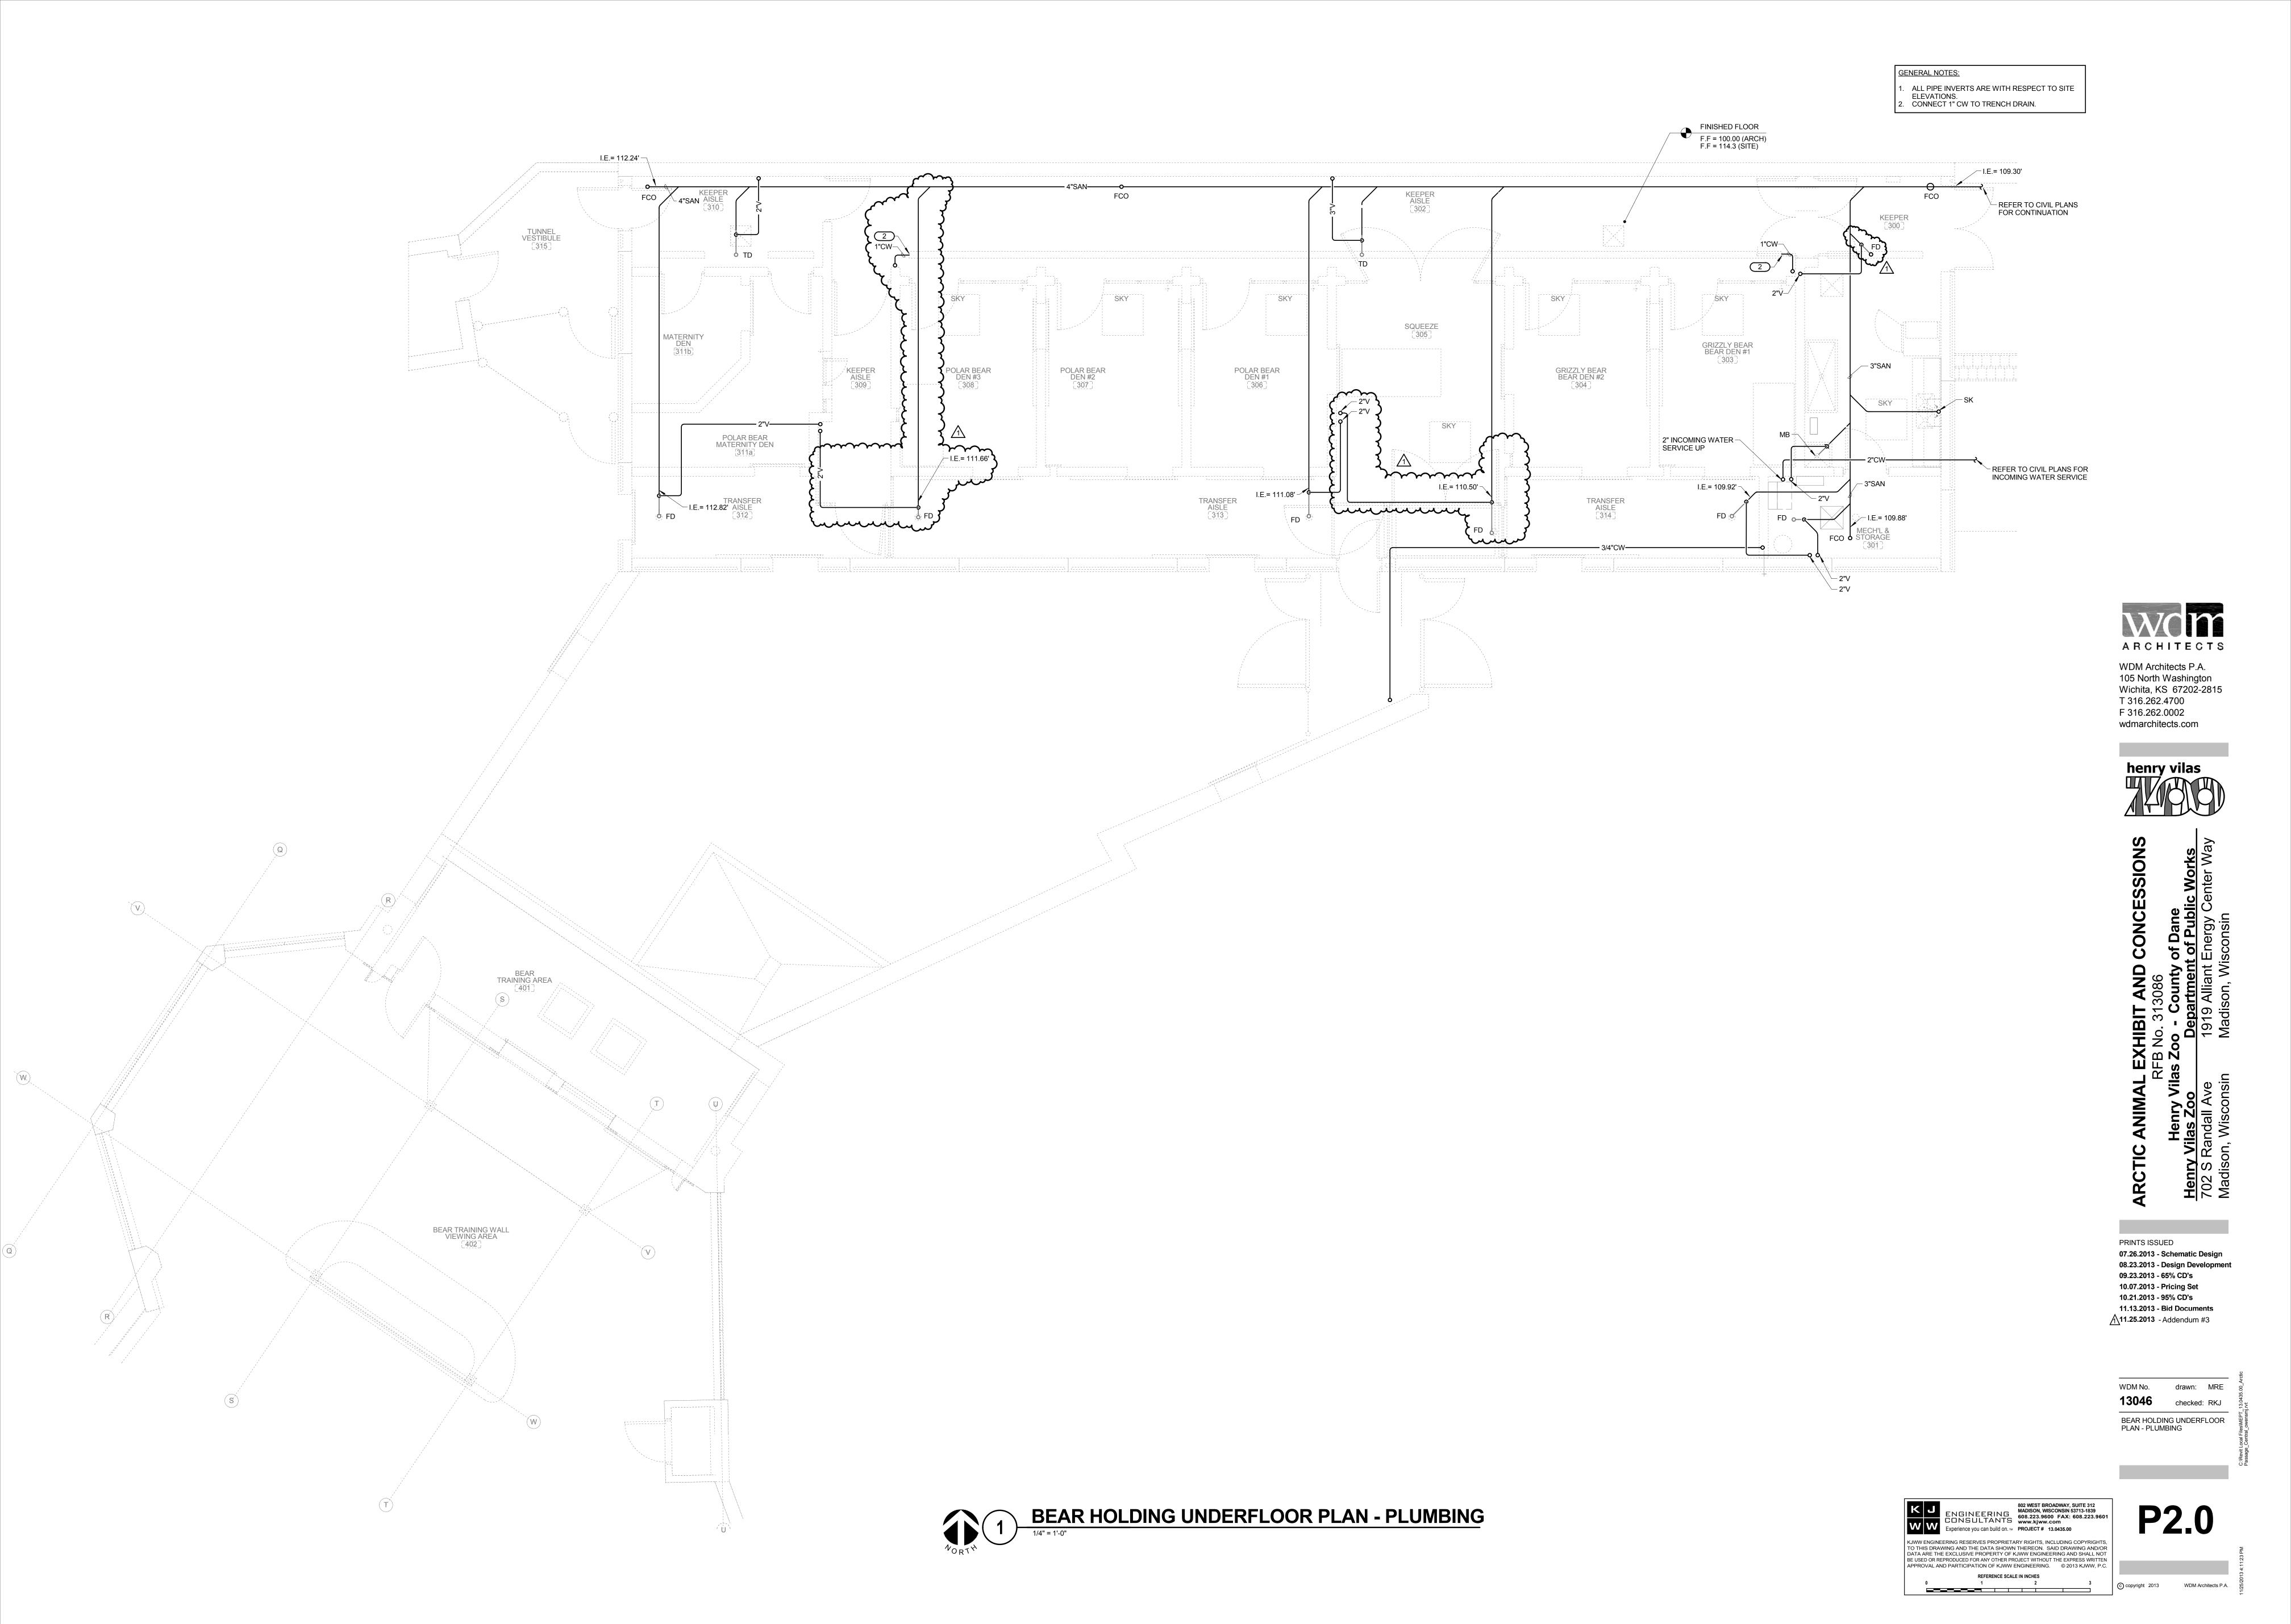
11.25.2013 - Addendum #3


MDM No. drawn: MP2

13046 checked: MP2

SEAL POOL WALL PLAN

SR1.4



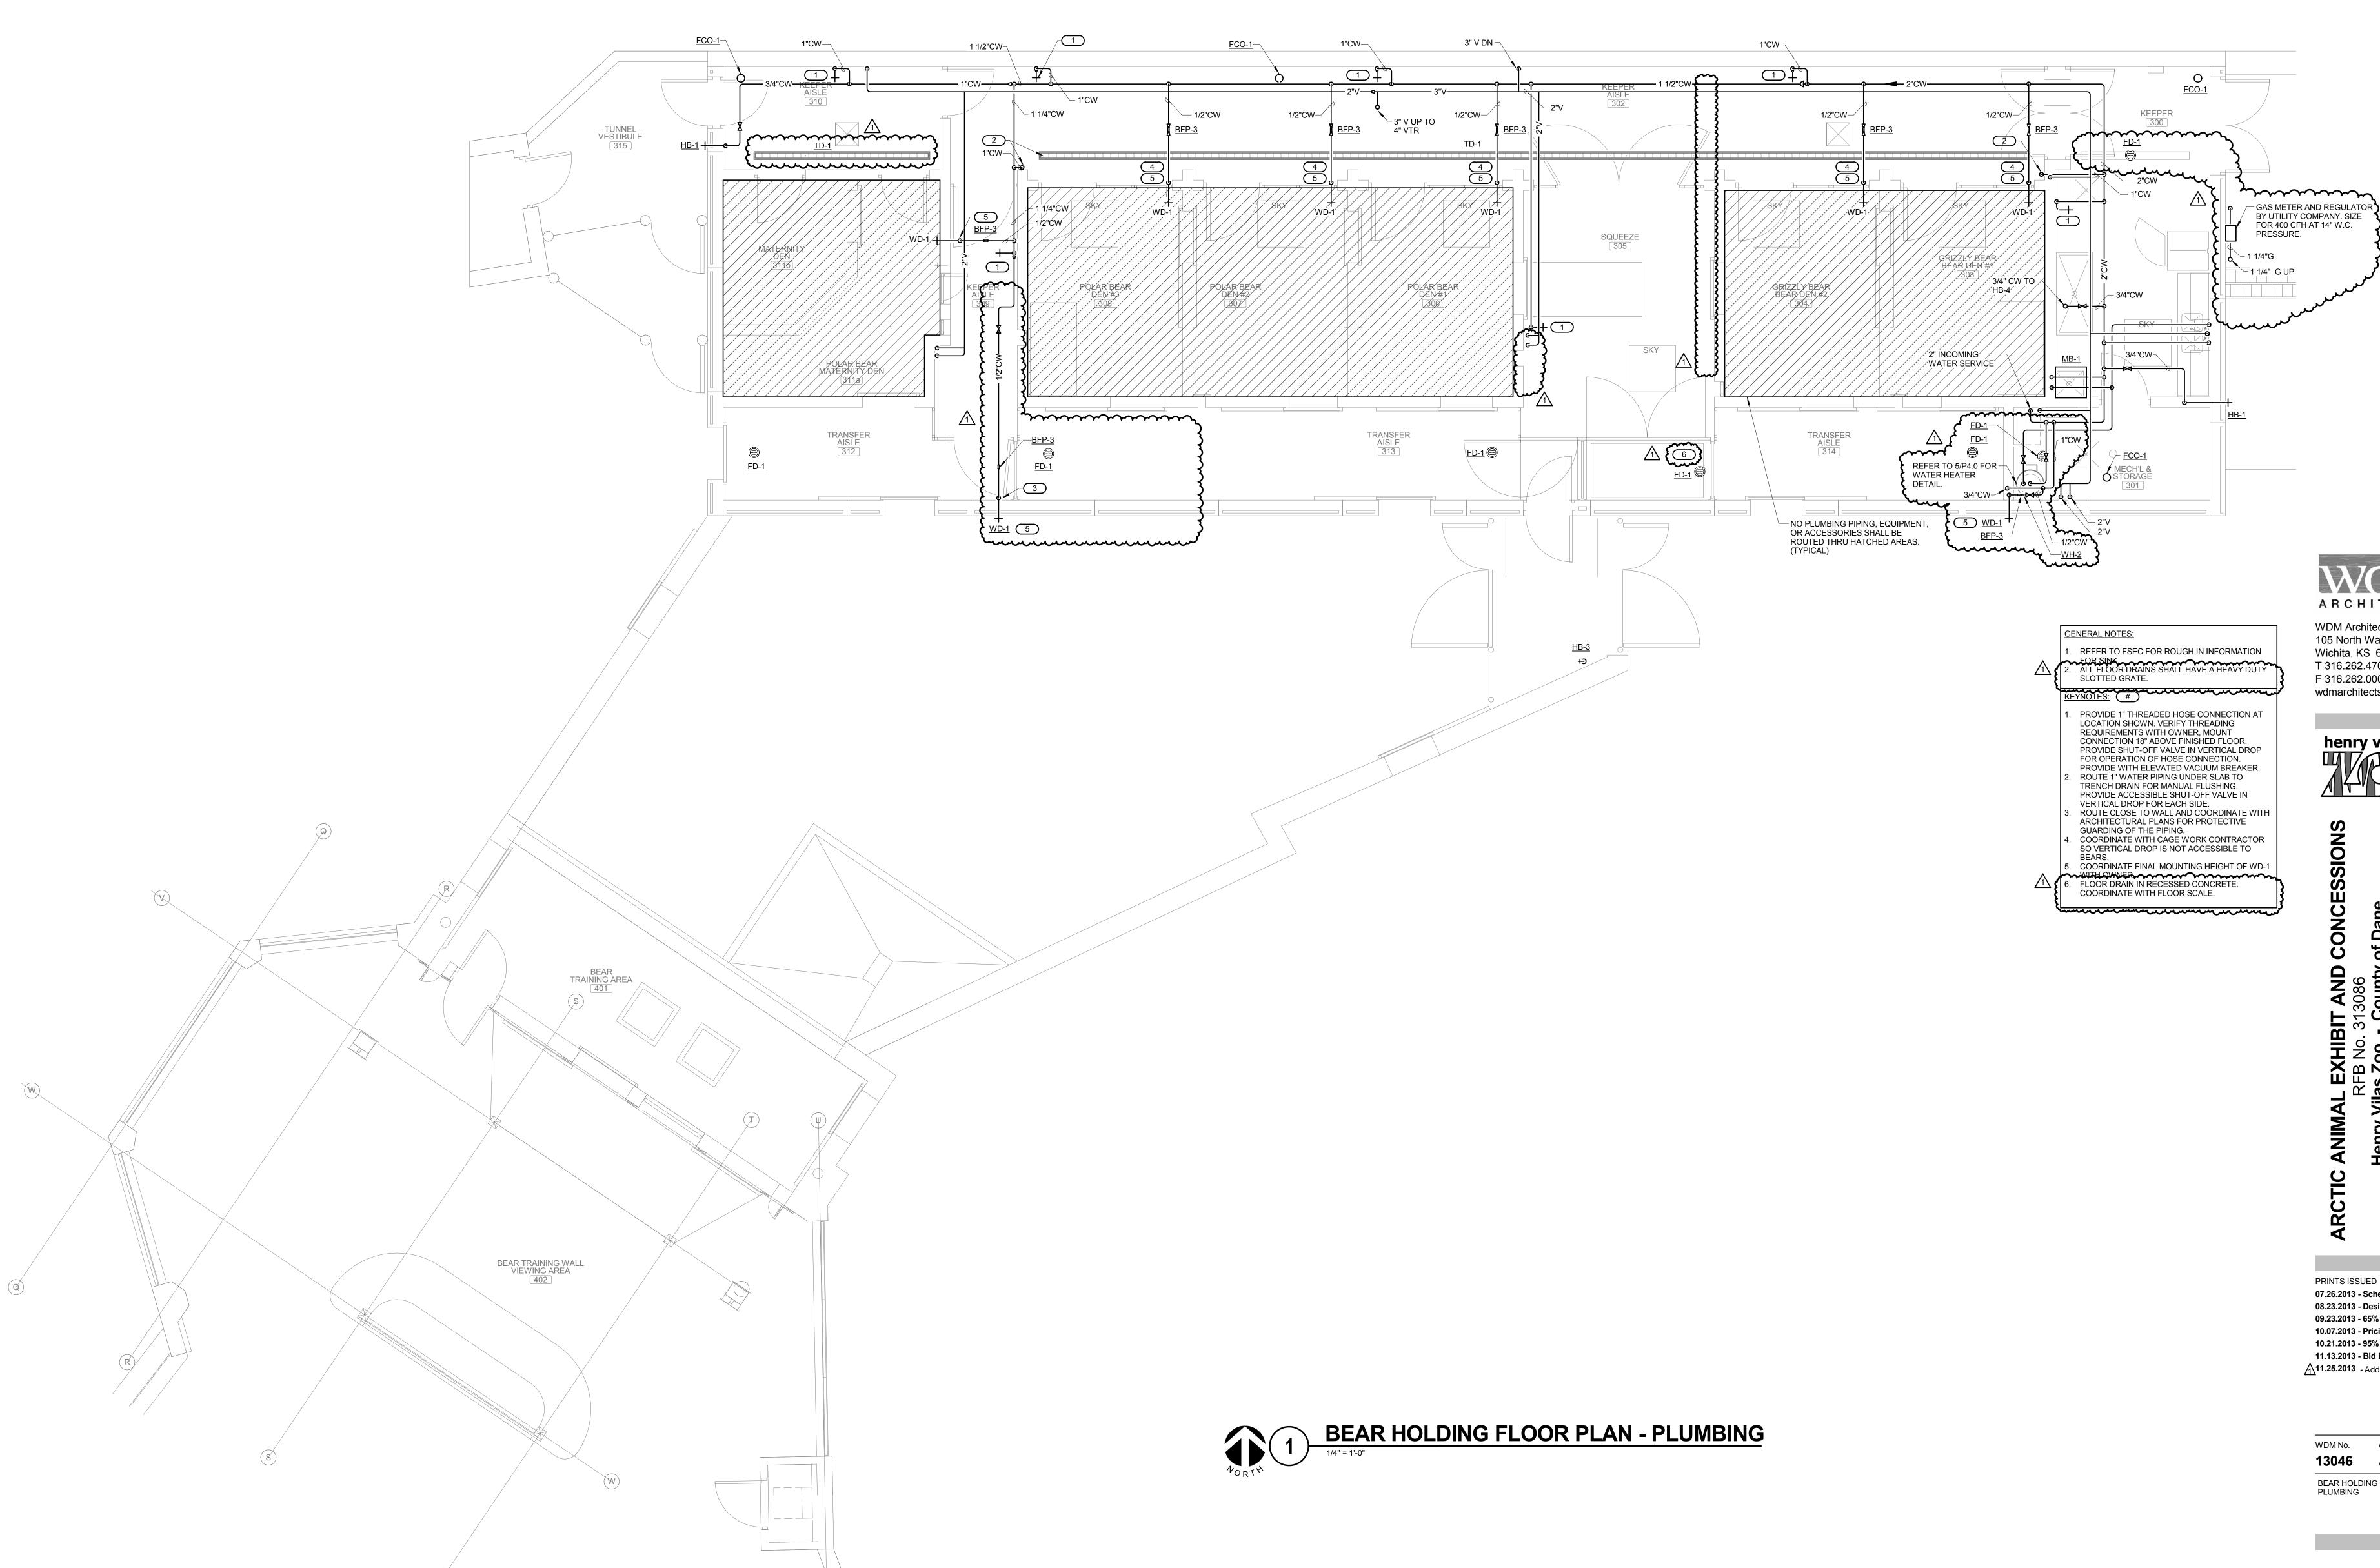

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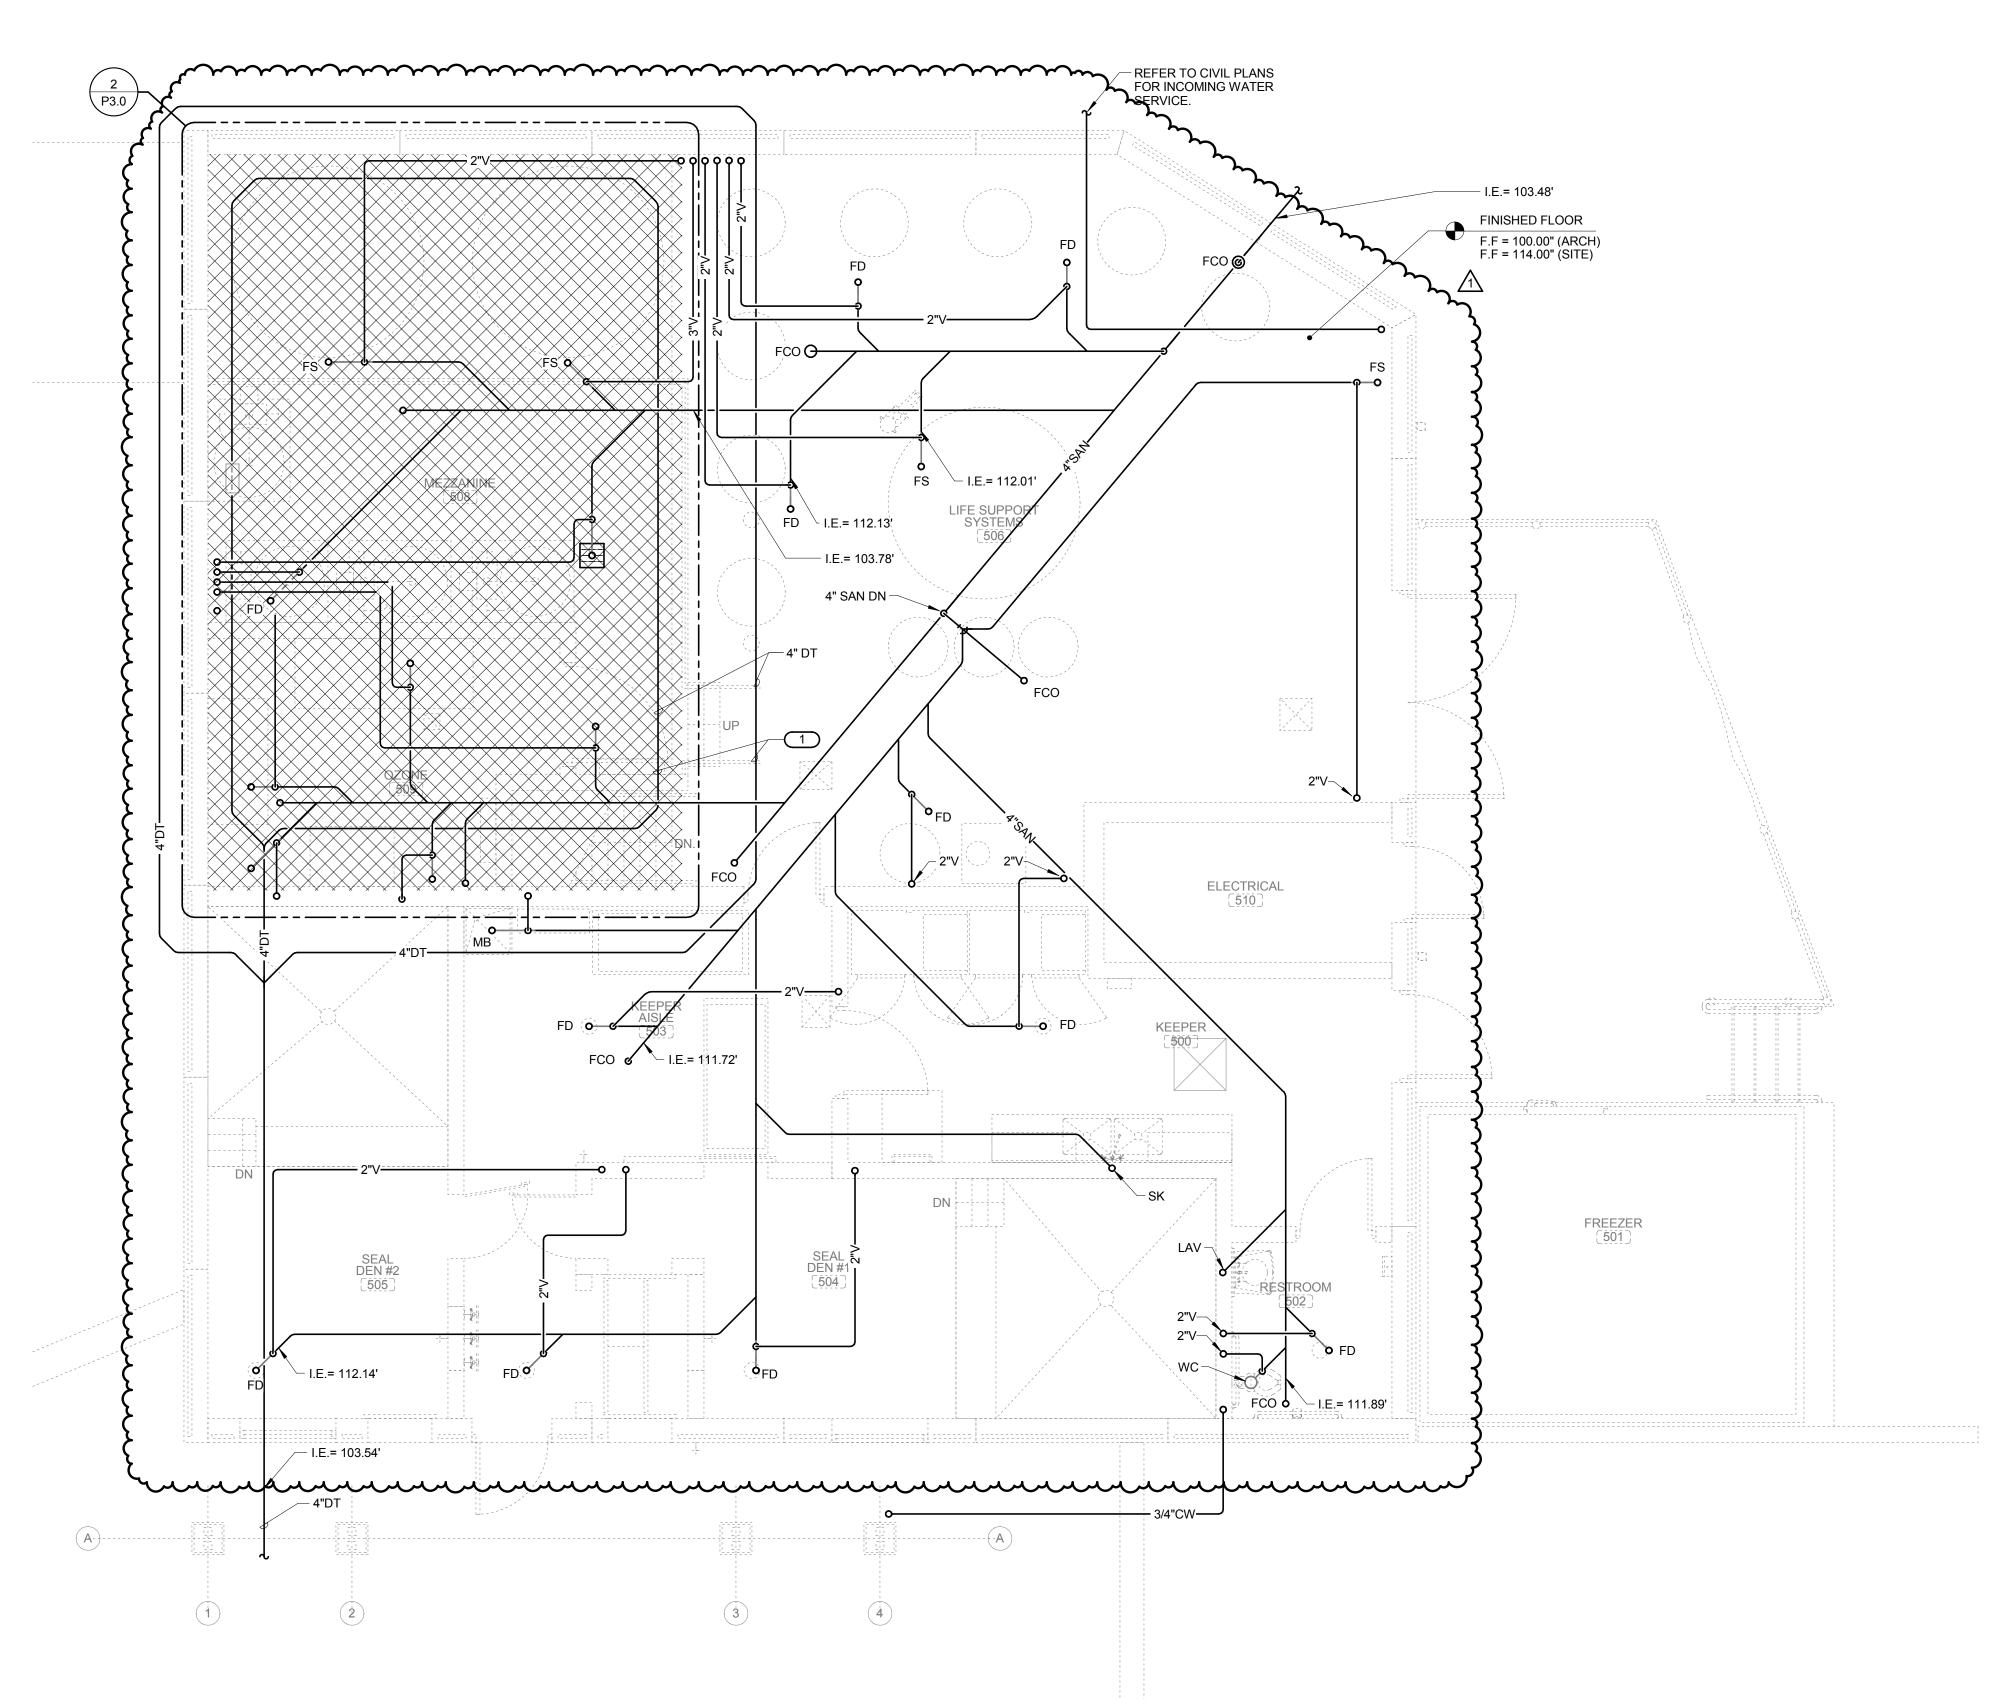


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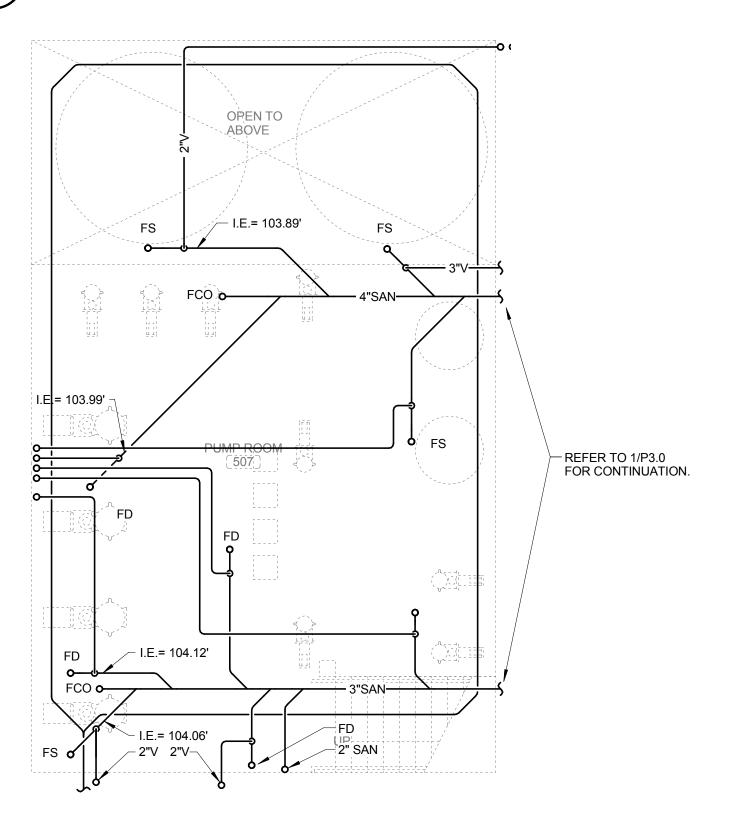
13046 checked: RKJ

BEAR HOLDING FLOOR PLAN -PLUMBING

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# SEAL HOLDING UNDERFLOOR PLAN - PLUMBING



SEAL UNDERFLOOR LOWER LEVEL PLAN - PLUMBING

GENERAL NOTES:

ALL PIPE INVERTS ARE WITH RESPECT TO SITE ELEVATIONS.

KEYNOTES: #

PROVIDE 4" DRAINTILE AROUND BUILDING ON INSIDE AND OUTSIDE OF FOOTING COORDINATE FINAL BURY DEPTH WITH STRUCTURAL PLANS.



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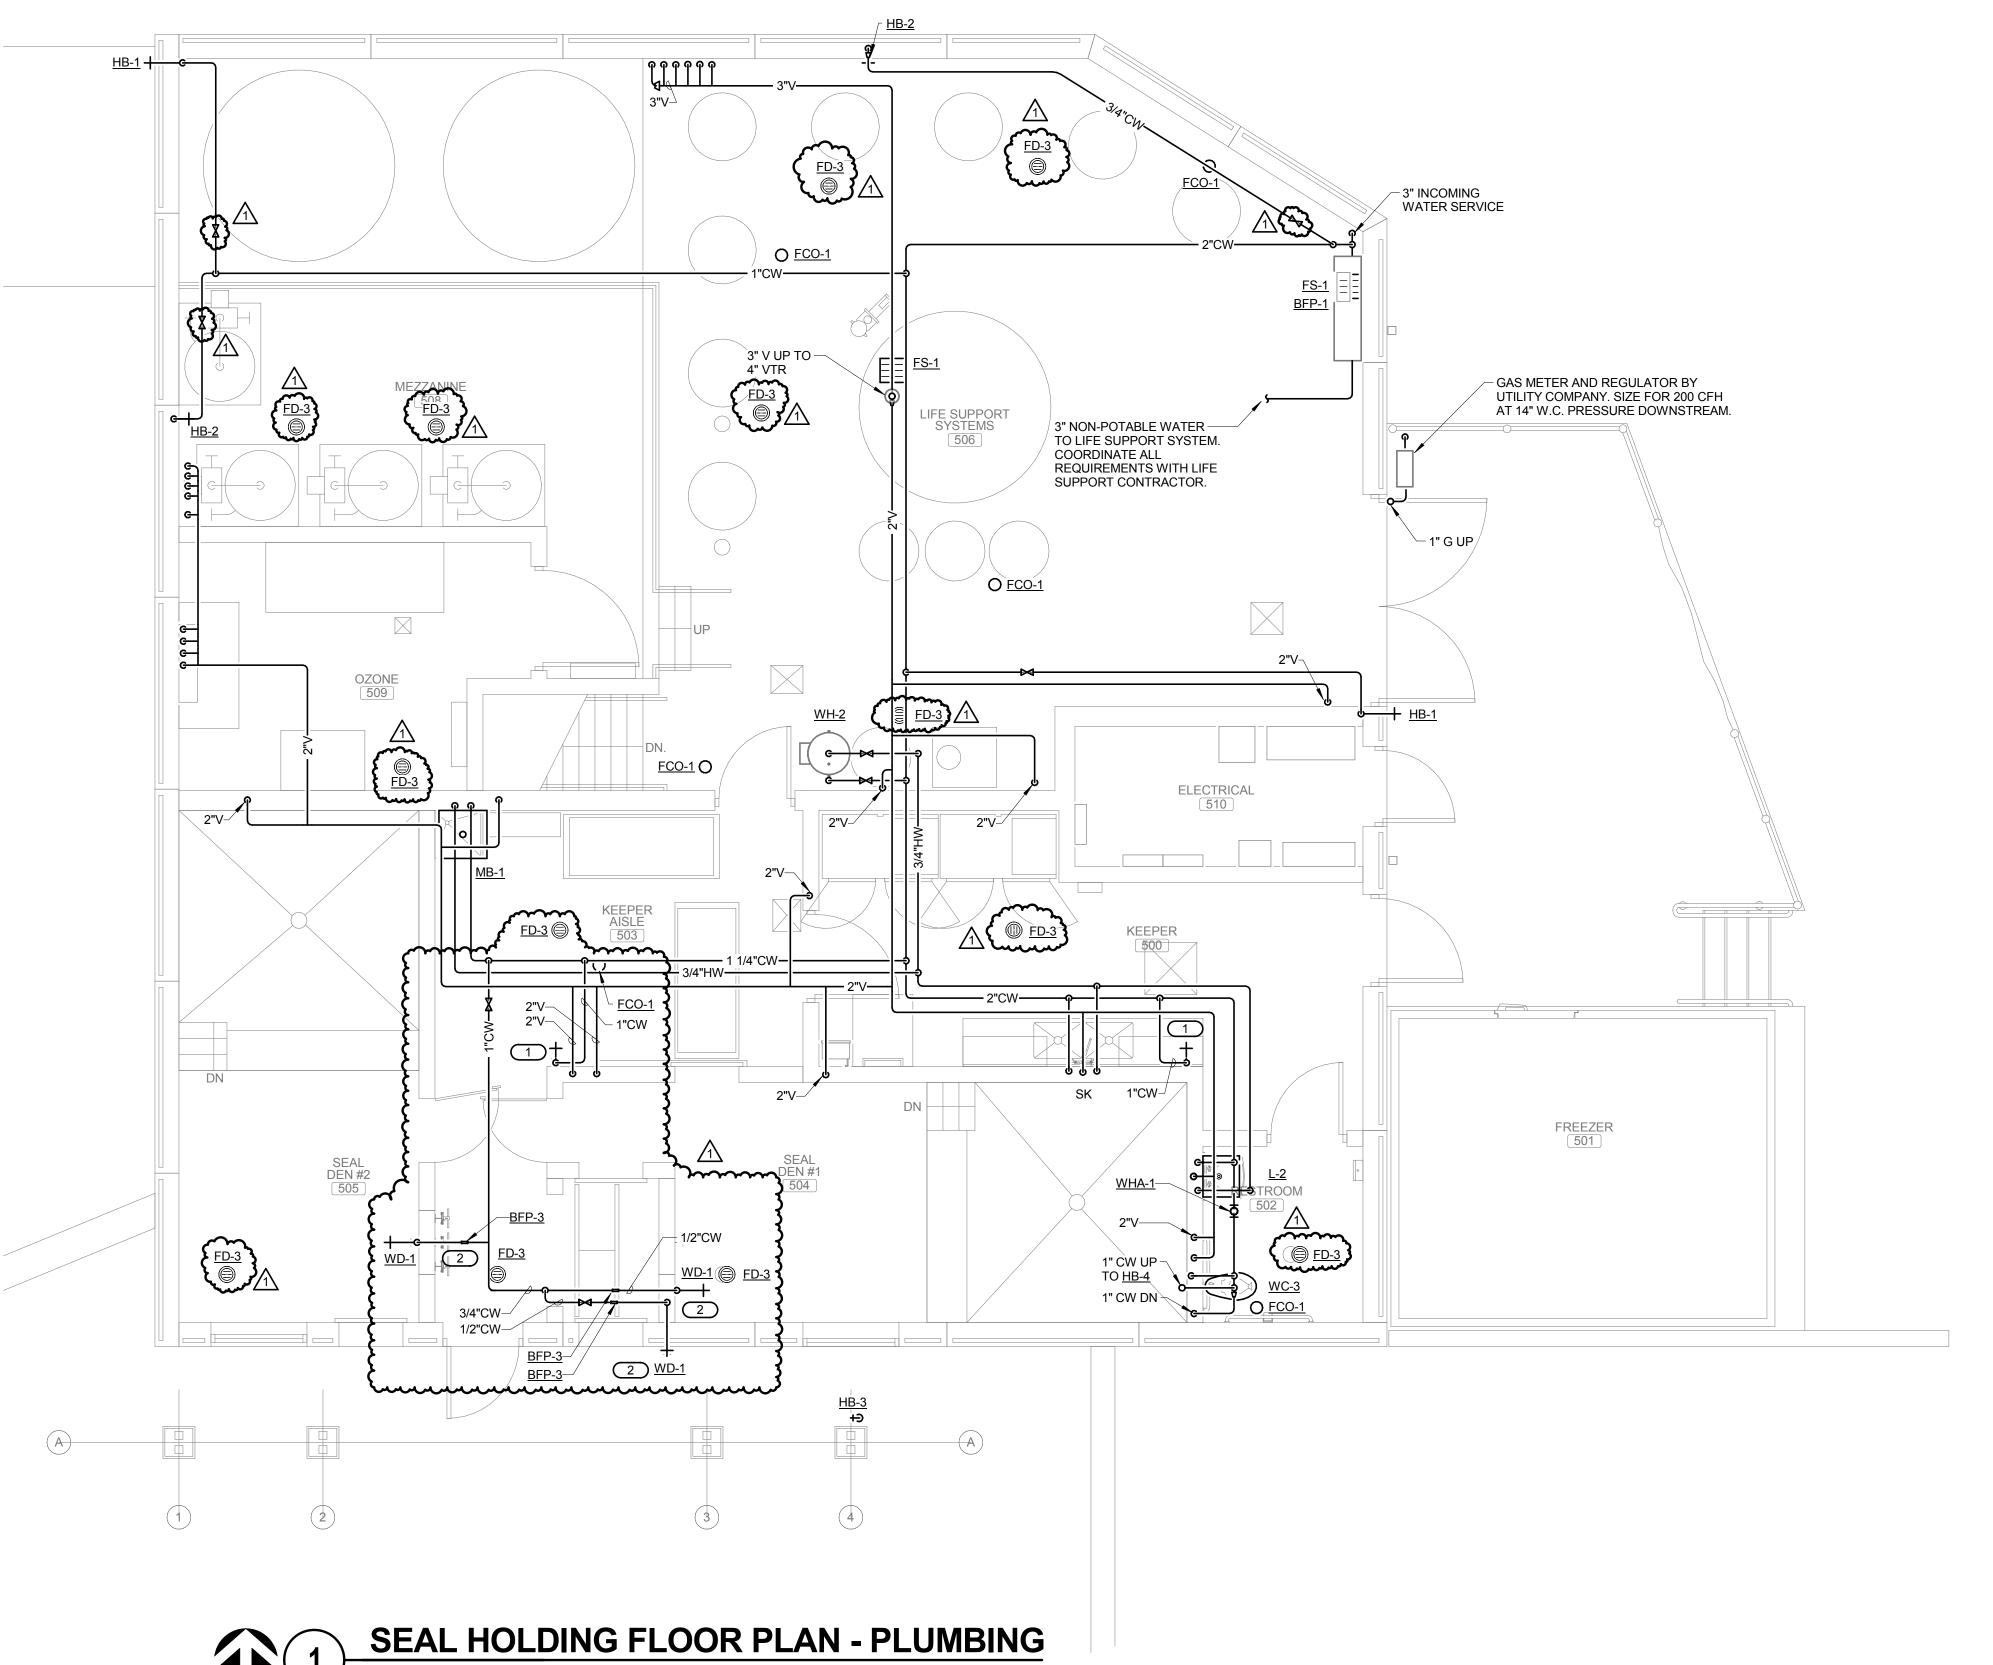
WDM No. checked: RKJ

SEAL HOLDING UNDERFLOOR PLAN - PLUMBING


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SEAL HOLDING FLOOR PLAN - PLUMBING
1/4" = 1'-0"




SEAL LOWER LEVEL PLAN - PLUMBING

GENERAL NOTES: REFER TO FSEC FOR ROUGH IN INFORMATION FOR SINK.
 ALL HANGERS SHALL BE SUITABLE FOR SALT WATER ENVIRONMENT. REFER TO SPECFICIATION FOR PETALL OF THE PROPERTY OF THE FOR DETAILS. KEYNOTES: # . PROVIDE 1" THREADED HOSE CONNECTION AT LOCATION SHOWN. VERIFY THREADING REQUIREMENTS WITH OWNER, MOUNT CONNECTION 18" ABOVE FINISHED FLOOR. PROVIDE SHUT-OFF VALVE IN VERTICAL DROP FOR OPERATION OF HOSE BIBB. PROVIDE WITH ELEVATED VACUUM BREAKER. 2. COORDINATE FINAL MOUNTING HEIGHT OF WD-1 . REFER TO THE FINISHED FLOOR OF THE

MEZZANINE.

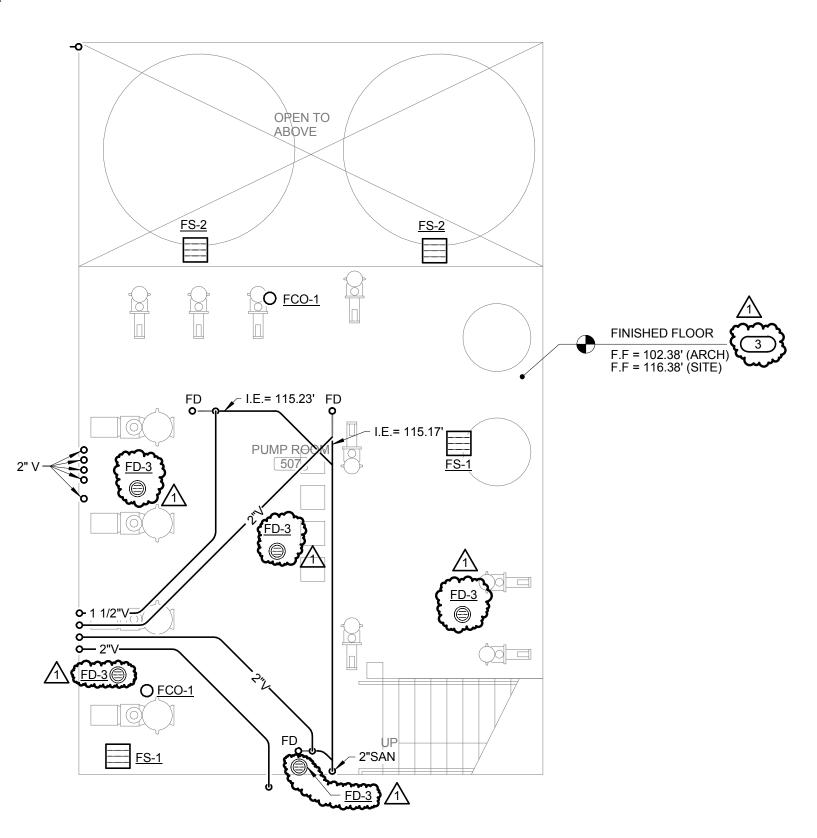

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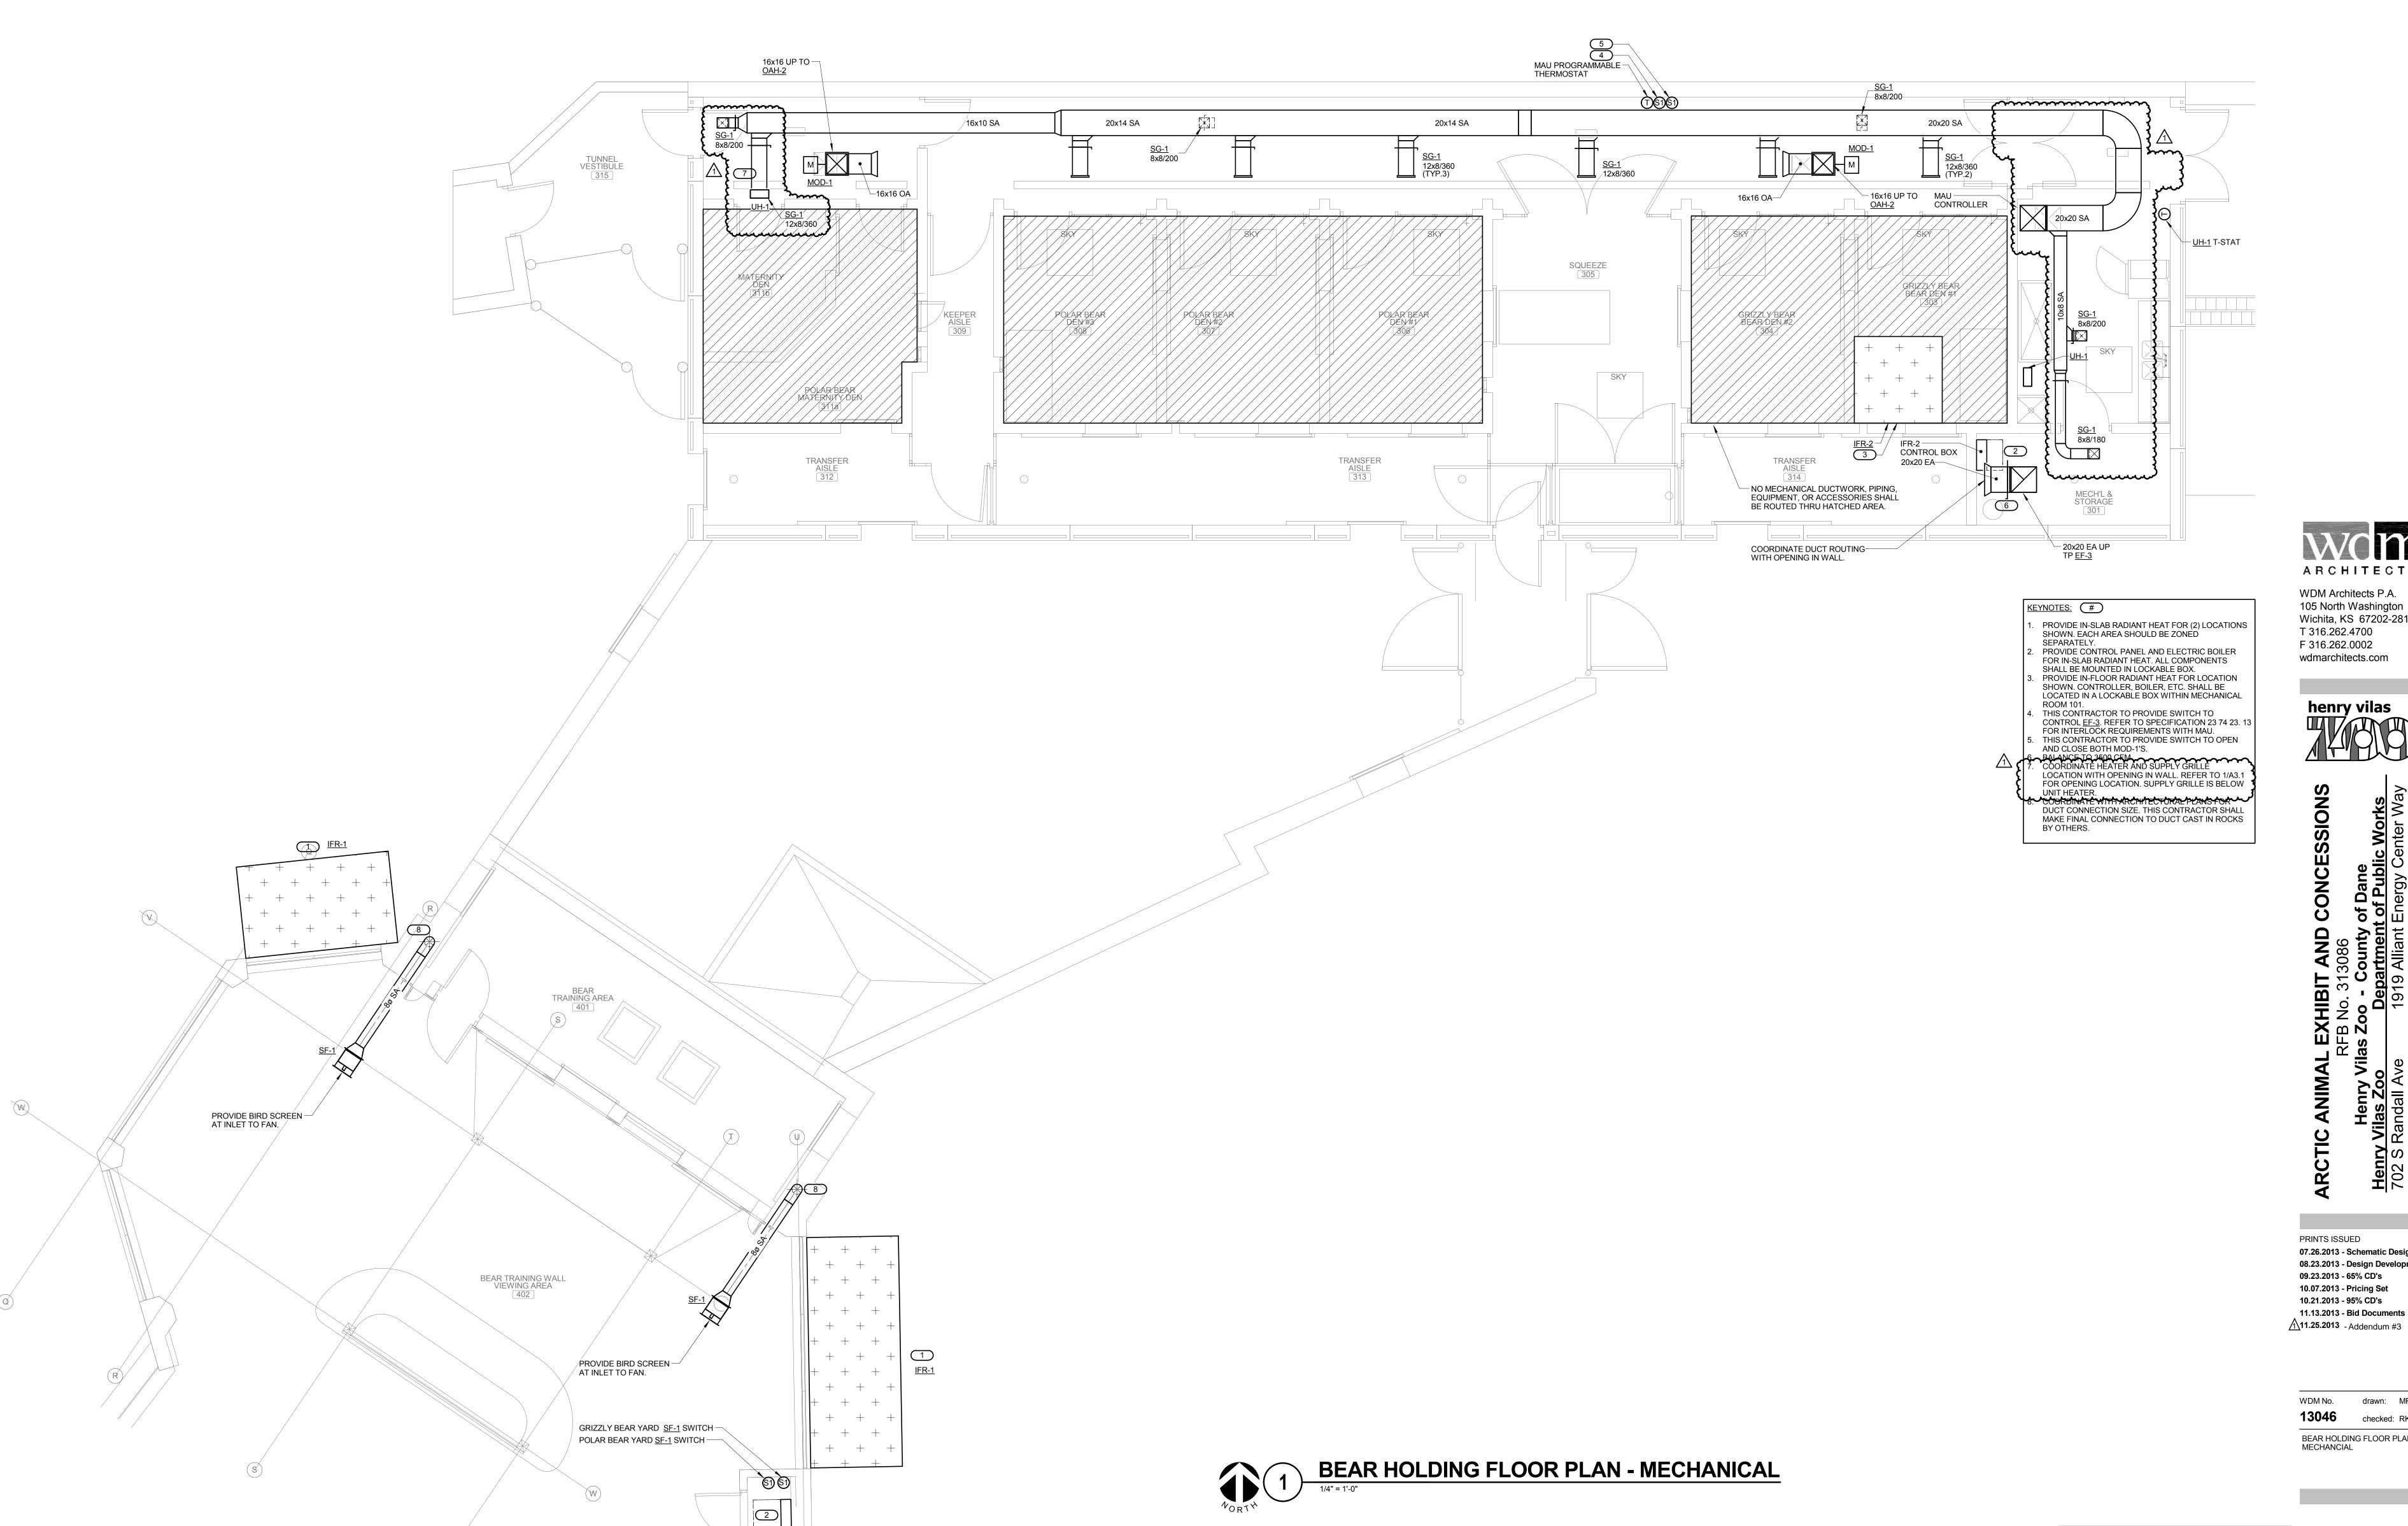
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WDM No. checked: RKJ SEAL HOLDING FLOOR PLAN -PLUMBING
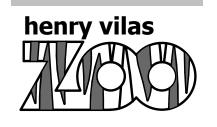
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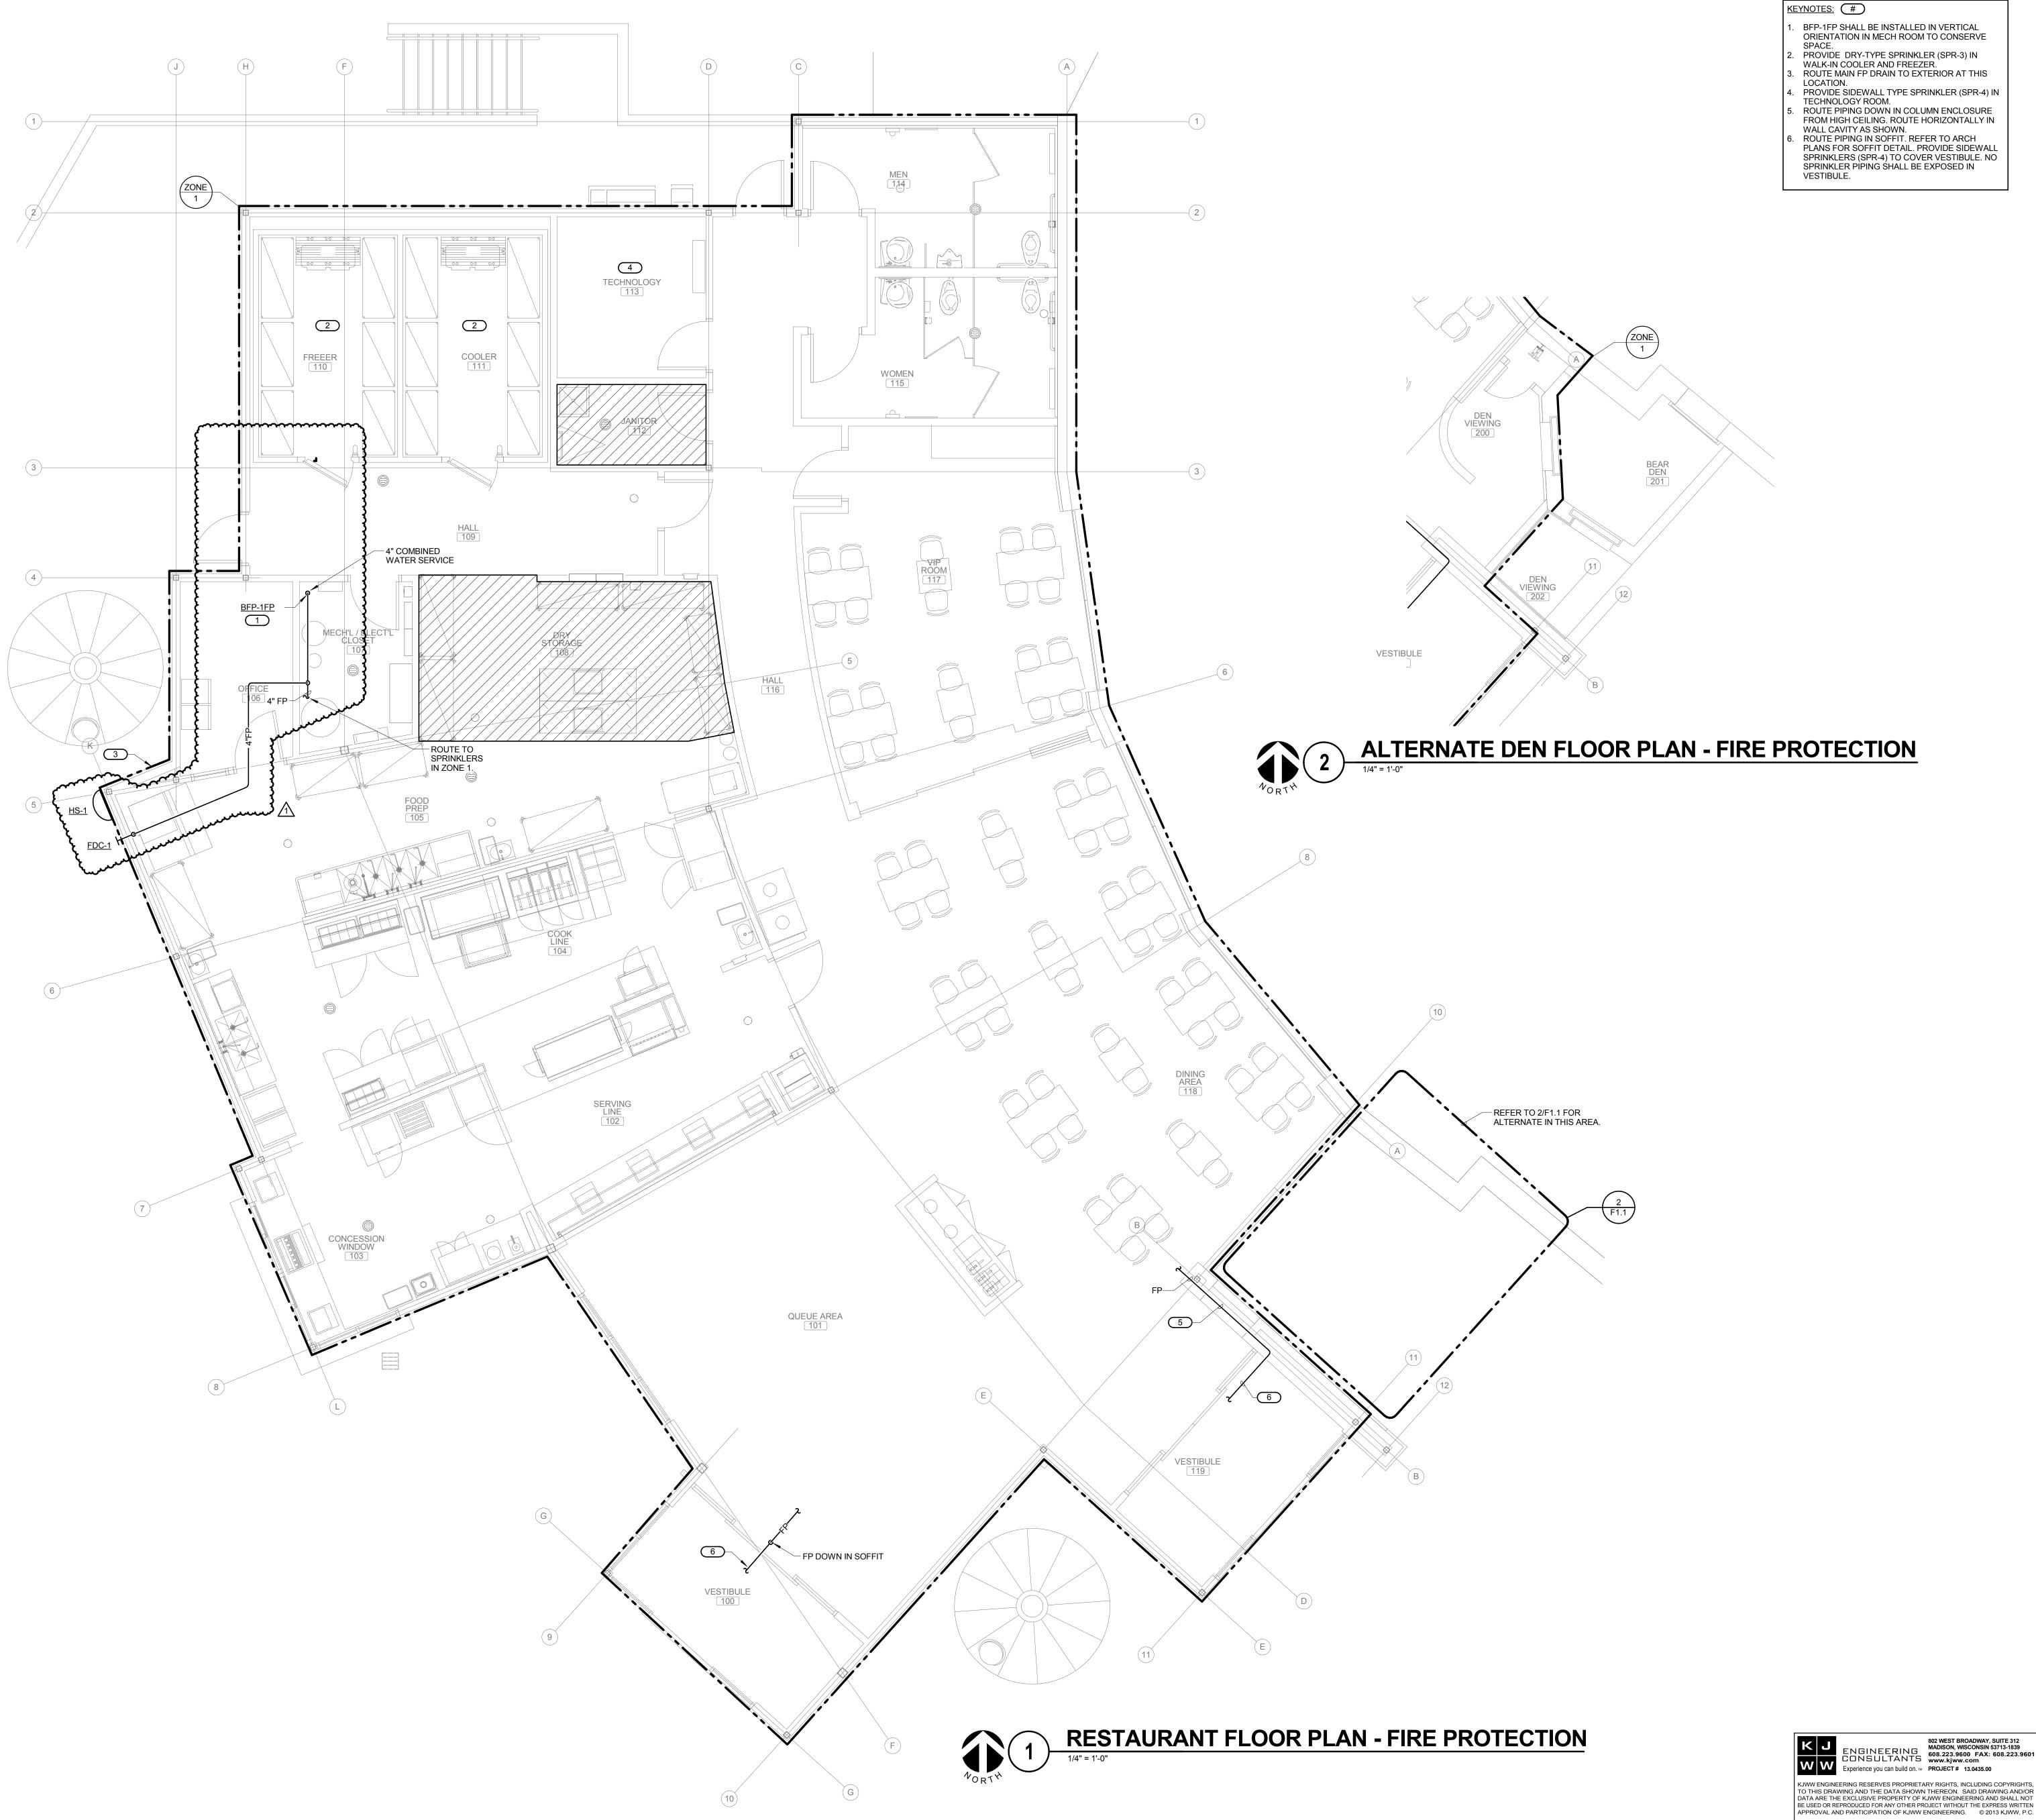
WDM No. drawn: MRE checked: RKJ

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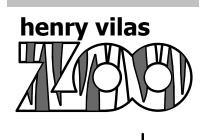
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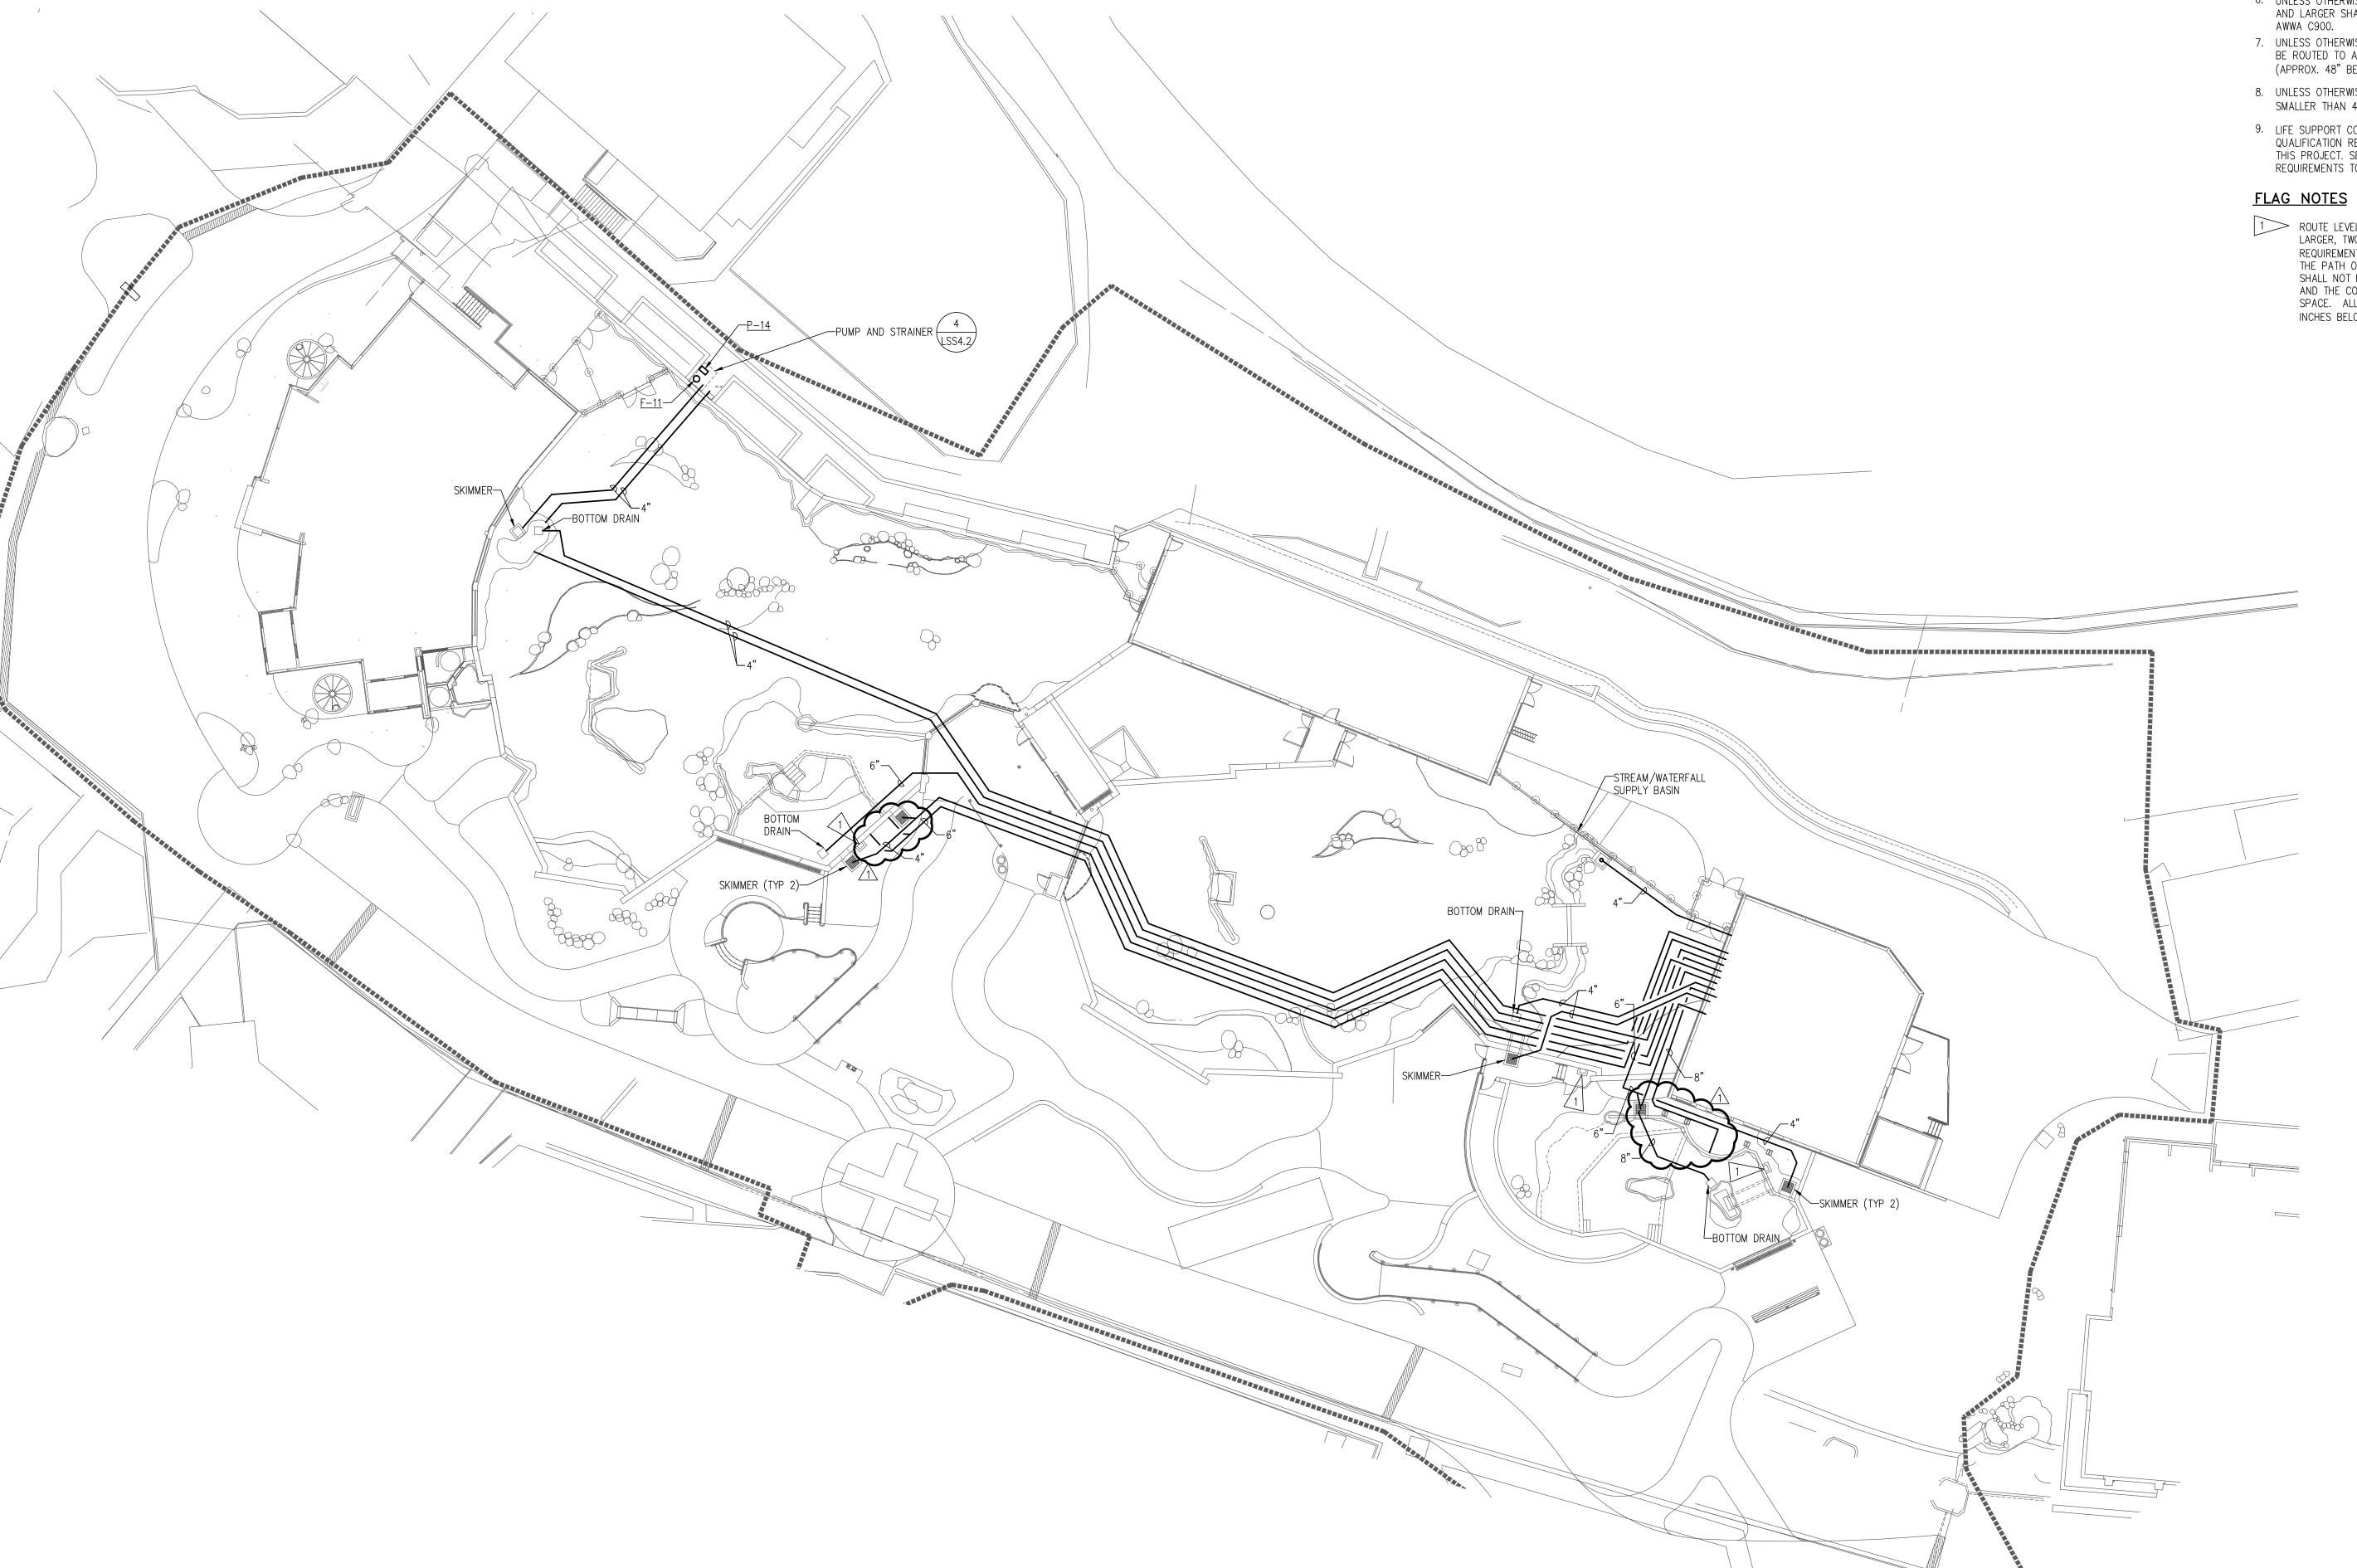
checked: RKJ

RESTAURANT FLOOR PLAN -FIRE PROTECTION

10.21.2013 - 95% CD's 11.13.2013 - Bid Documents 11.25.2013 - Addendum #3

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LIFE SUPPORT SYSTEM SITE PIPING PLAN

(NORTH)

- GENERAL NOTES:

  1. ENLARGED POOL PIPING PLANS ARE SHOWN ON LSS2.0 2. ANGLES OF POOL PIPING ARE APPROXIMATE. POOL PIPING SHALL BE INSTALLED WITH MANUFACTURED FITTINGS HAVING STANDARD ANGLES. PIPING SHALL NOT BE TORQUED INTO NON-STANDARD
- 3. CHANGES IN DIRECTION OF HORIZONTAL PIPE SHALL BE MADE WITH FITTINGS OF 45° OR LESS.
- 4. LINK-SEALS SHALL BE INSTALLED AT ALL LIFE SUPPORT PIPING PENETRATIONS THROUGH FORMED CONCRETE WITH WATER ON ONE OR BOTH SIDES. SEE DETAIL 5/LSS4.0.
- 5. LS CONTRACTOR IS RESPONSIBLE FOR ALL LOW VOLTAGE WIRING REQUIRED TO MAKE LS SYSTEM COMPLETE AND FULLY OPERATIONAL.
- 6. UNLESS OTHERWISE NOTED, ALL LIFE SUPPORT SITE PIPING 4" AND LARGER SHALL BE PRESSURE PIPE CLASS 150, SDR 18,
- 7. UNLESS OTHERWISE NOTED, ALL LIFE SUPPORT SITE PIPING SHALL BE ROUTED TO AND FROM THE POOLS BELOW THE FROST LINE (APPROX. 48" BELOW GRADE).
- 8. UNLESS OTHERWISE NOTED, ALL LIFE SUPPORT SITE PIPING SMALLER THAN 4" SHALL BE SCHEDULE 80 PVC.
- 9. LIFE SUPPORT CONTRACTOR (LSC) MUST SUBMIT ON AND MEET QUALIFICATION REQUIREMENTS TO BE A VALID SUBCONTRACTOR ON THIS PROJECT. SEE LS SPECIFICATION SECTION 225300, 1.5 FOR REQUIREMENTS TO QUALIFY AS LSC ON THIS PROJECT.

1 ROUTE LEVEL SENSOR CONTROL WIRING (22 GAUGE OR LARGER, TWO-WIRE PER LEVEL SENSOR MANUFACTURER REQUIREMENTS) IN WATERTIGHT NONMETALLIC CONDUIT ALONG THE PATH OF THE SKIMMER RETURN PIPING. THE WIRING SHALL NOT EXCEED 1000 FEET BETWEEN THE LEVEL SENSOR AND THE CONTROLLER IN THE SEAL BUILDING LIFE SUPPORT SPACE. ALL SENSOR CONDUIT SHALL BE AT LEAST 48 INCHES BELOW GRADE. SEE DETAIL 1/LSS4.3.



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PRINTS ISSUED 07.26.2013 - Schematic Design 09.23.2013 - 65% CD's 10.07.2013 - Pricing Set 10.21.2013 - 95% CD's 11.13.2013 - Bid Documents 11.25.2013 - Addendum #3

WDM No. drawn: CPJ 13046 checked: STA LIFE SUPPORT SYSTEM SITE

LSS1.0

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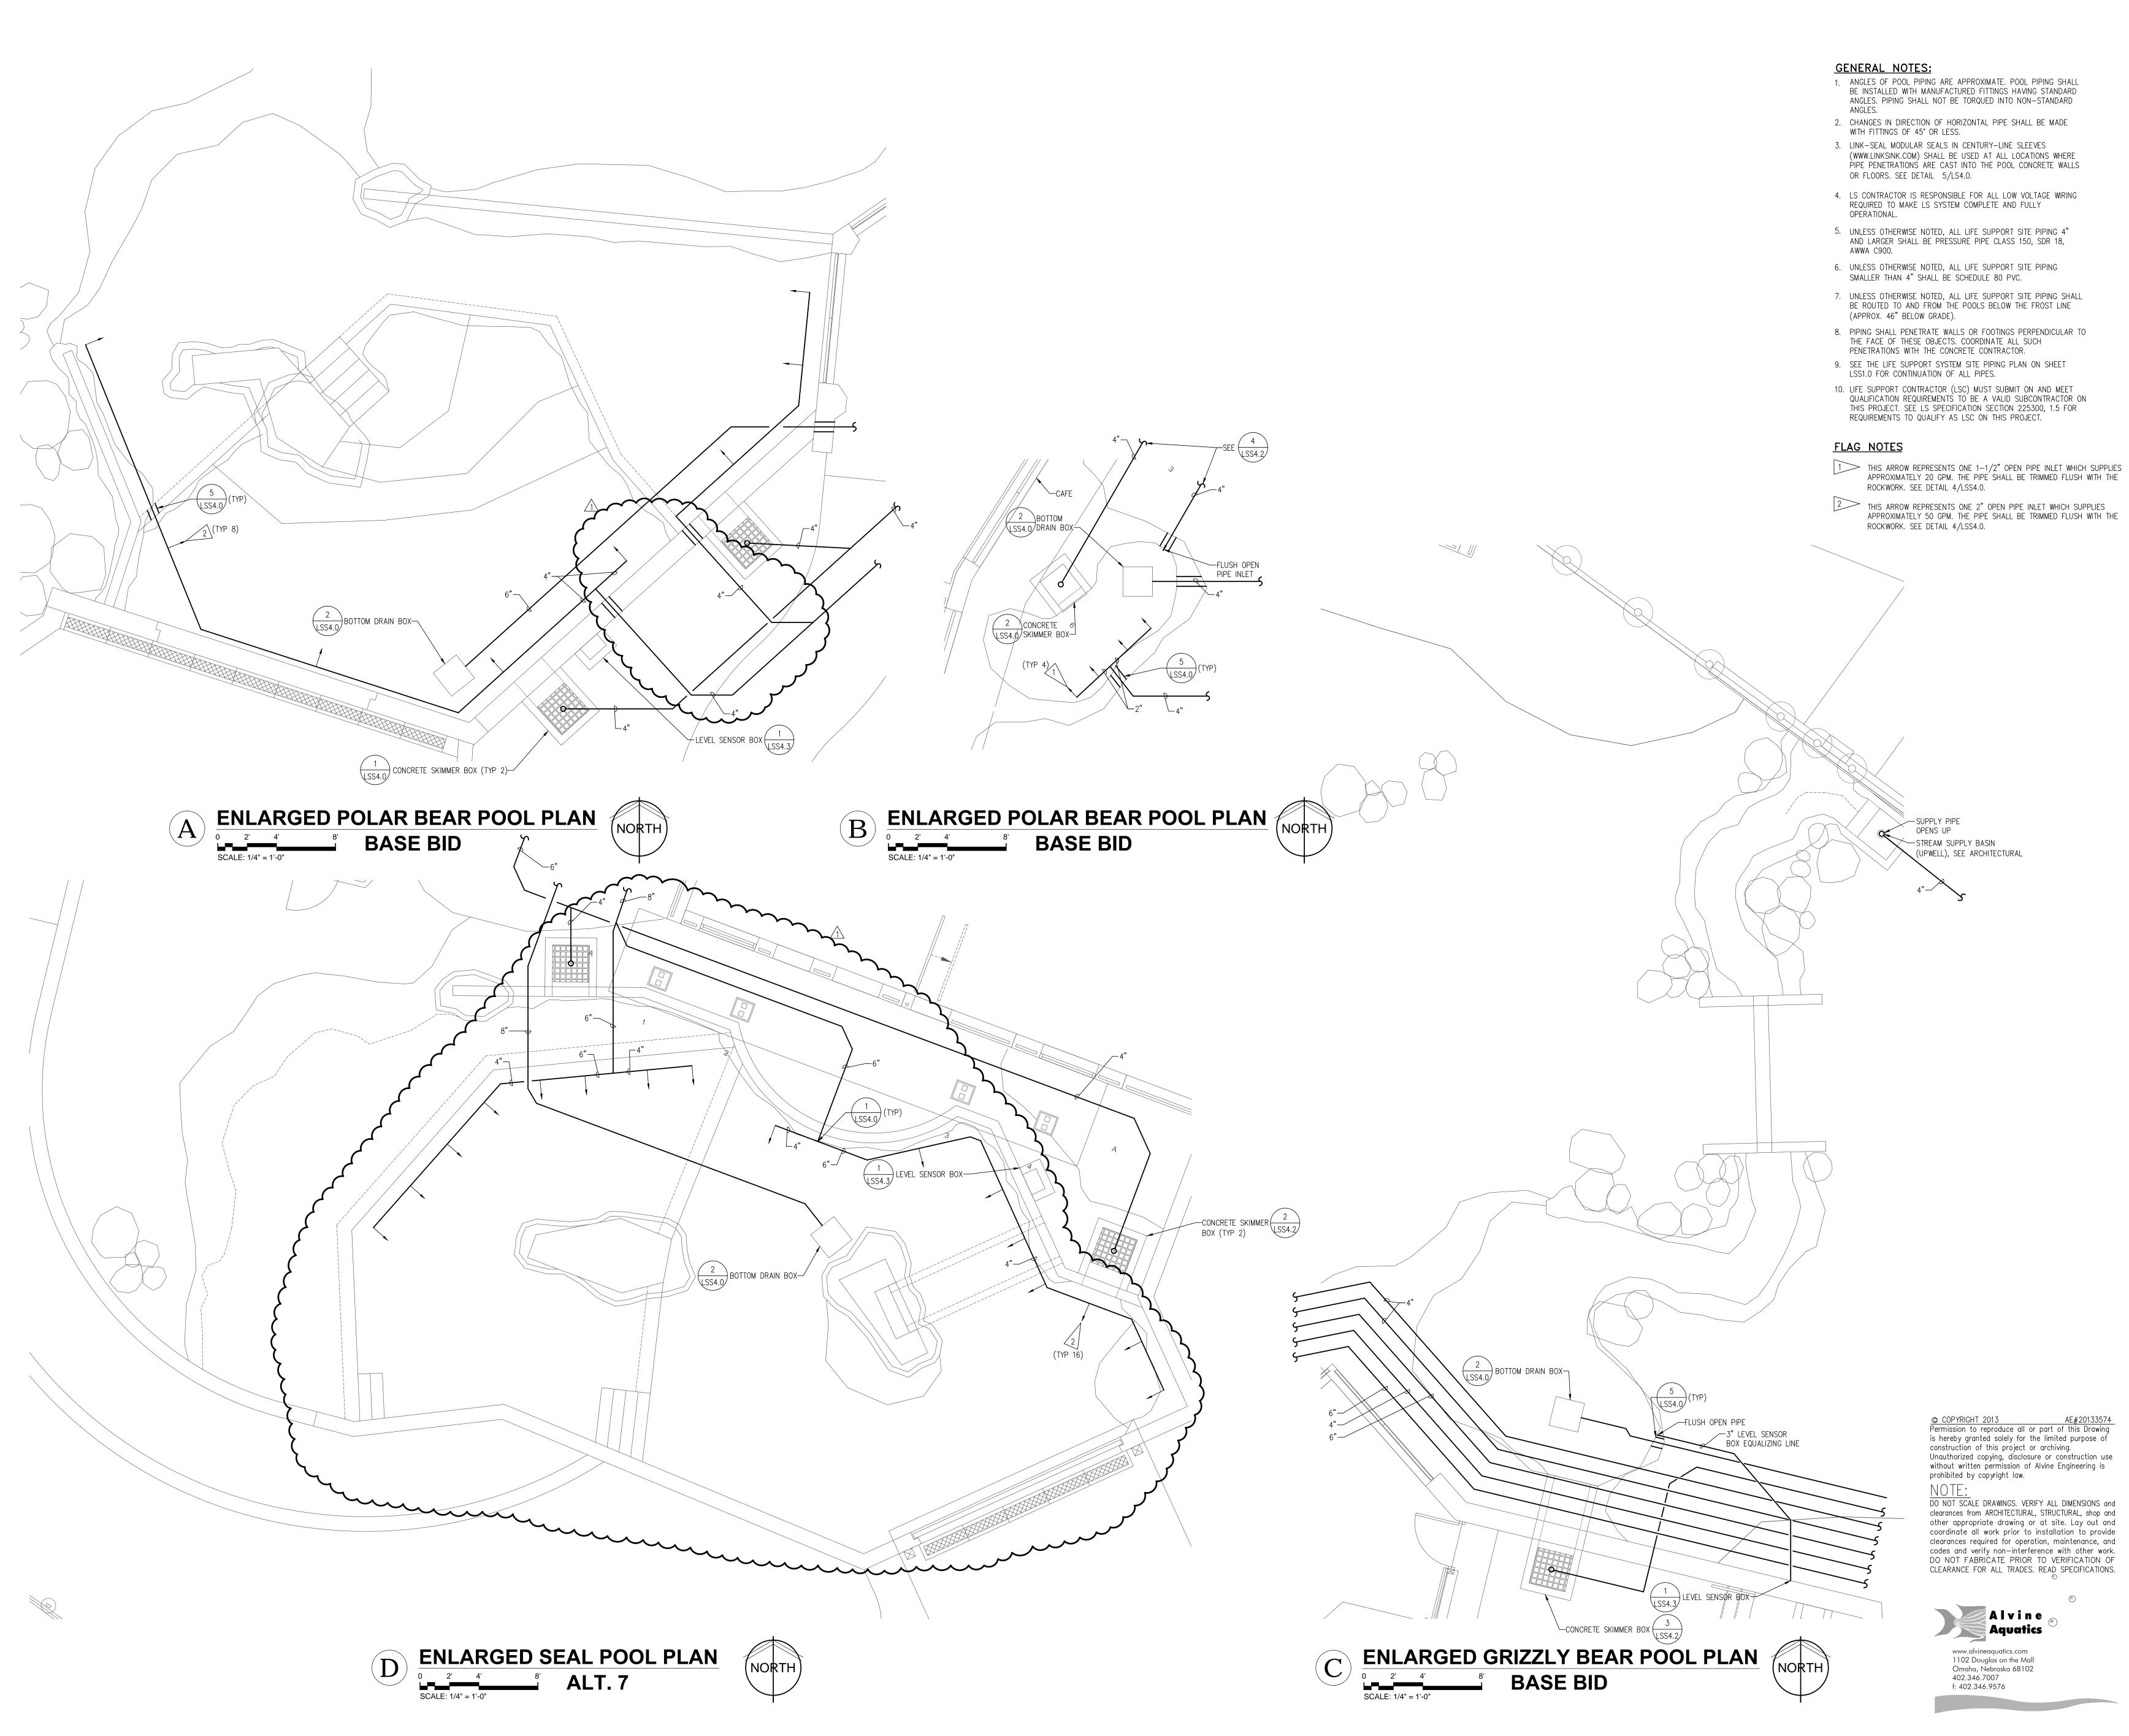
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WDM No. drawn: CPJ

13046 checked: STA

LIFE SUPPORT ENLARGED
POOL PLANS

LSS2.0