


ELECTRICAL SYMBOLS AND ABBREVIATIONS

NOTE: NOT ALL SYMBOLS AND ABBREVIATIONS INDICATED HERE ARE USED IN DRAWINGS AND MAY NOT APPLY TO CURRENT PROJECT. ADDITIONAL SYMBOLS MAY BE INDICATED ON DRAWINGS.

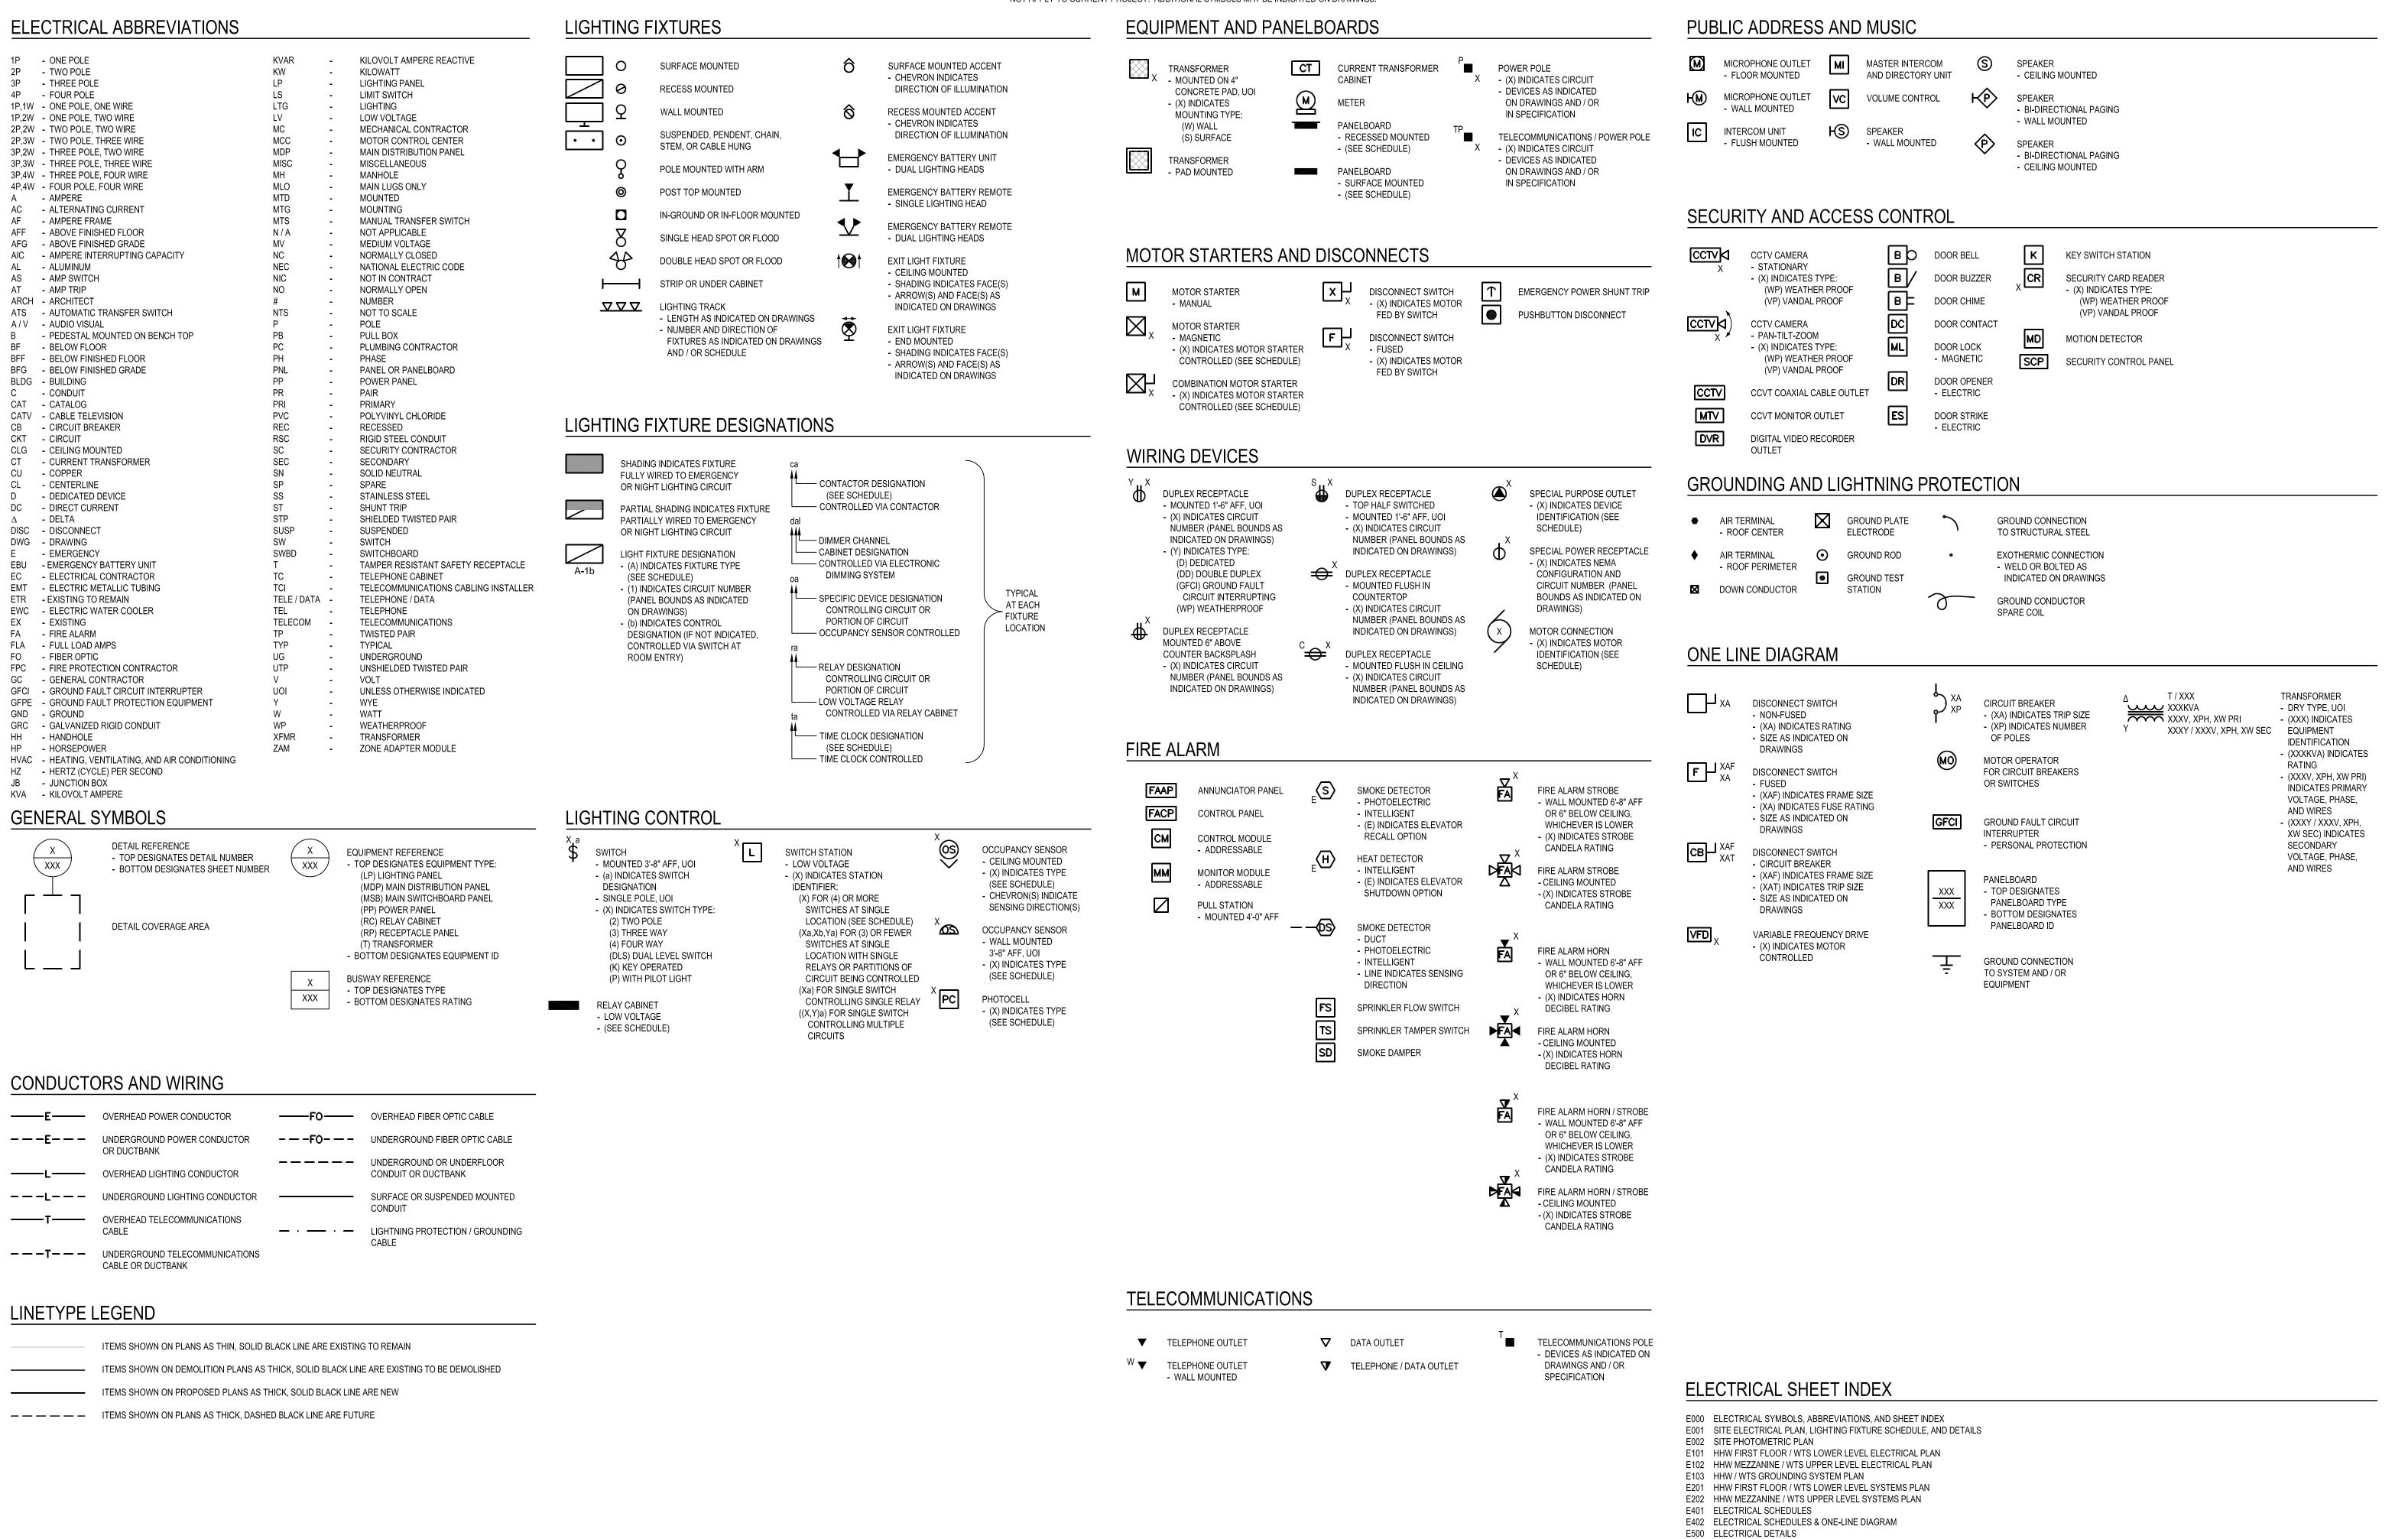

One Honey Creek Corporate Center 125 South 84th Street, Suite 401 Milwaukee, WI 53214-1469 414 / 259 1500 414 / 259 0037 fax

www.graef-usa.com

CONSULTANTS:

PROJECT TITLE:

DANE COUNTY
WASTE TRANSFER STATION
AND HOUSEHOLD HAZARDOUS
WASTE FACILITY
RODEFELD LANDFILL

ISSUE:

PROJECT INFORMATION: PROJECT NUMBER: 2009-0328.00

DATE: 05-11-2010
DRAWN BY: JAH
CHECKED BY: AAS

CHECKED BY: AAS

APPROVED BY: JHK


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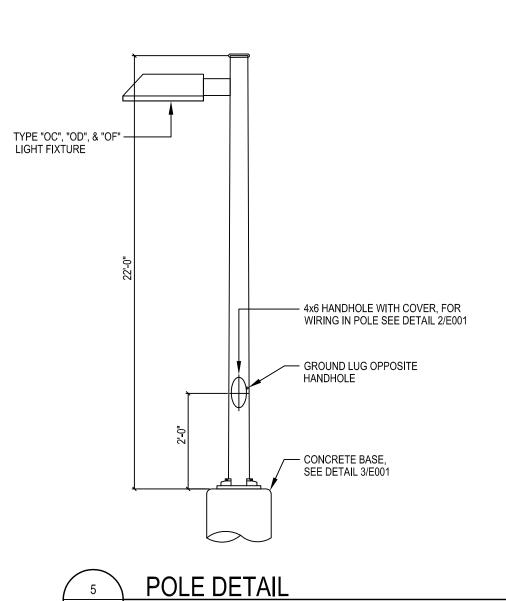
ELECTRICAL SYMBOLS, ABBREVIATIONS AND SHEET INDEX





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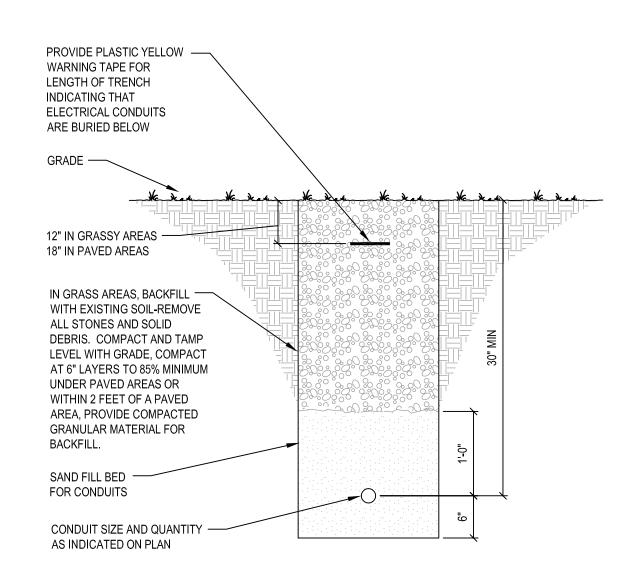


POLE WIRING DETAIL



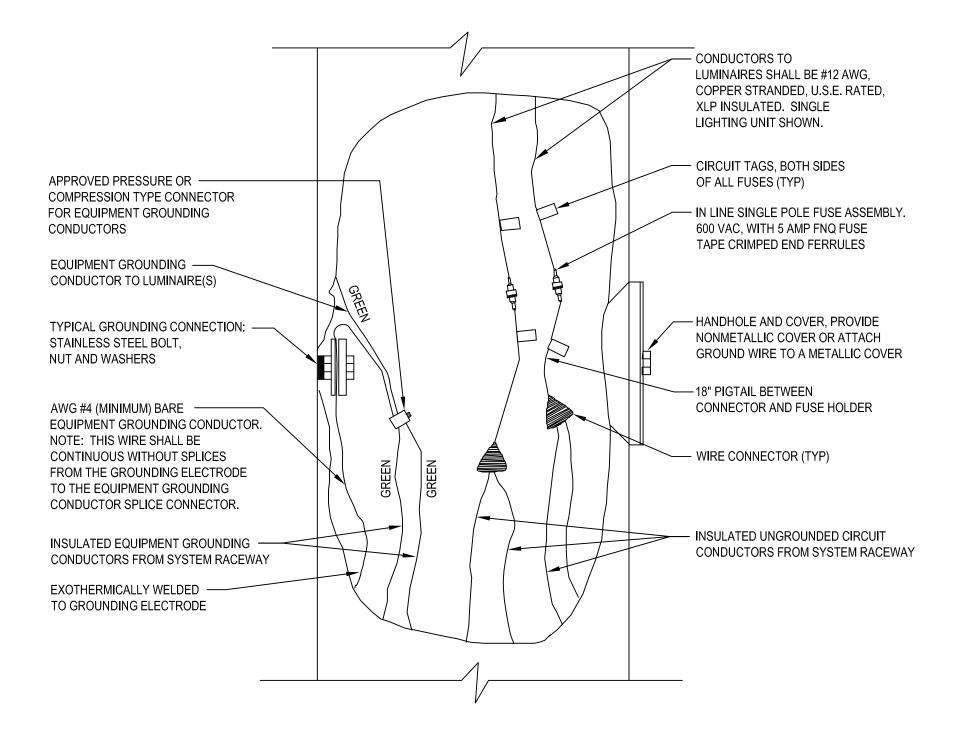

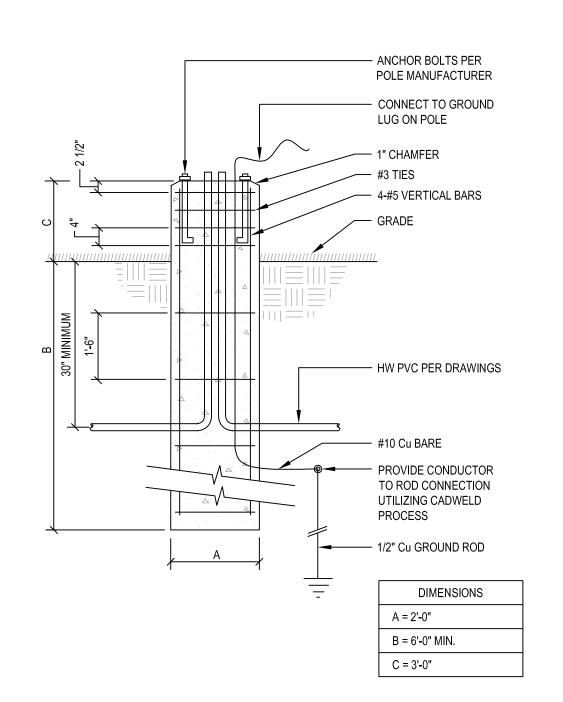

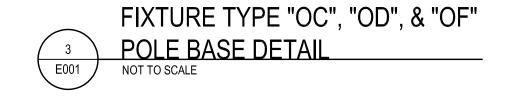




SITE LIGHTING FIXTURE SCHEDULE

NOTE: SEE SPECIFICATIONS SECTIONS FOR ADDITIONAL INFORMATION REGARDING LIGHTING FIXTURE AND INSTALLATION REQUIREMENTS. PROVIDE OPTIONS AND ACCESSORIES REFERENCED BY THE COLUMN TITLED "OPTIONS/ACCESSORIES". MANUFACTURERS LISTED AS ACCEPTABLE SHALL MEET ALL REQUIREMENTS AND FEATURES INDICATED. ACCEPTABLE MANUFACTURERS MUST MEET THE PHOTOMETRIC PERFORMANCE OF THE LISTED UNIT.

		ABBREVIATIO	DNS: DW = DRY WALL ES = EXPOSED STRUCTURE LG = LAY-IN GRID	P = PENDANT PL = PLASTER PO = POLE	R = RECESS V S = SURFACE W = WALL MOUNTED	= VARIES						
DES		LAMP DATA	DESCRIPTION	LIGHTIN	G FIXTURE	VOLT	MOUNT	CEILING	FIXTURE	OPTIONS/ ACCESSORIES	ACCEPTABLE MANUFACTURERS	SEE NOTE
DES	#	TYPE	DESCRIPTION	MANUFACTURER	CATALOF SERIES	VOLI	WOONT	TYPE	DEPTH	OF HONS/ ACCESSORIES	ACCEPTABLE WANGFACTURERS	SEENOTE
OA	1	F54T5HO	EXTERIOR WALL FLUORESCENT FIXTURE	LUMINAIRE LIGHTING	AEL48-CL-BKH-EMB	277	W	-	-	-	LITHONIA, DAYBRITE, LSI	-
ОВ	1	320W PSMH	EXTERIOR FLOOD	COOPER	AMF-F-76-BK	277	W	•	-	-	LITHONIA, DAYBRITE, LSI	-
ОС	1	320W PSMH	PARKING LOT - 22FT POLE - TYPE III	COOPER	CLM-3F-FG-BK	277	PO	-	-	22FT POLE COOPER 'SSS' SERIES	LITHONIA, DAYBRITE, LSI	1,2
OD	1	320W PSMH	PARKING LOT - 22FT POLE - TYPE IV WITH SHIELD	COOPER	CLM-4F-FG-BK	277	PO	-	-	22FT POLE COOPER 'SSS' SERIES	LITHONIA, DAYBRITE, LSI	1,2
OF	1	320W PSMH	PARKING LOT - 22FT POLE - TYPE IV	COOPER	CLM-4F-FG-BK-HS	277	PO	-	-	22FT POLE COOPER 'SSS' SERIES	LITHONIA, DAYBRITE, LSI	1,2

LIGHTING FIXTURE SCHEDULE NOTES:

EC SHALL PROVIDE 22'-0", 4-INCH SQUARE STEEL POLE. EC SHALL PROVIDE CONCRETE BASES. SEE DETAIL 3/E100.

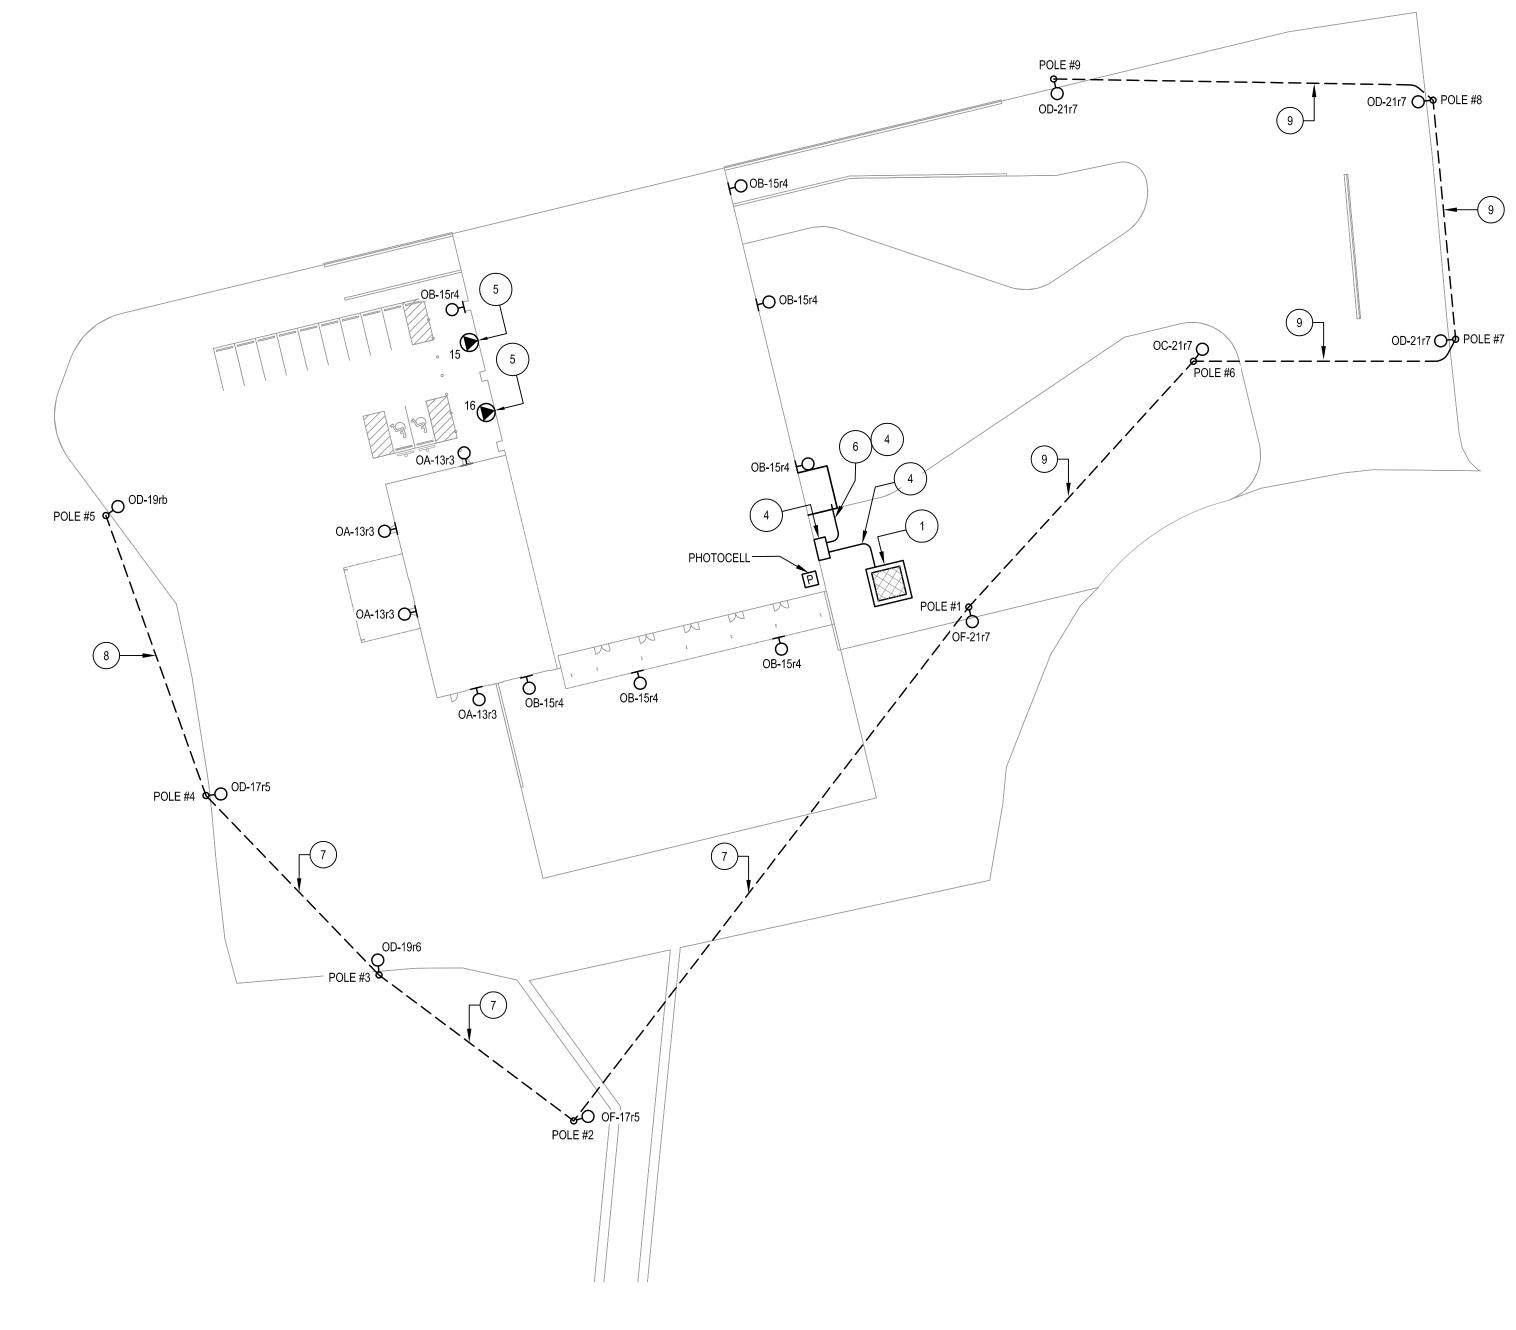



SHEET NOTES:

1 MADISON GAS AND ELECTRIC COMPANY UTILITY TRANSFORMER. EC TO PROVIDE CONCRETE

SHEET NOTES:

REFER TO SHEETS A300 AND A301 FOR EXACT

LOCATIONS OF BUILDING MOUNTED LIGHT FIXTURES.

- 2 EC TO PROVIDE 1600A,480V, 3-PHASE, 4-WIRE TRANSOCKET WITH METER SOCKET.
- 3 EC TO PROVIDE (4) 4" CONDUIT STUBS 36"
 BELOW FINISH GRADE TO TRANSOCKET AND
 UTILITY TRANSFORMER FROM BUILDING. EC TO
 COORDINATE ALL REQUIREMENTS WITH
 ELECTRIC UTILITY.
- EC TO COORDINATE ALL REQUIREMENTS WITH ELECTRIC UTILITY.
- 5 EC TO PROVIDE ELECTRICAL CONNECTIONS TO HAZARDOUS MATERIAL STORAGE CONTAINERS. SEE SPECIAL OUTLET SCHEDULE FOR FURTHER REQUIREMENTS. EC TO COORDINATE EXACT
- REQUIREMENTS WITH MANUFACTURE.

 6 ROUTE CONDUITS TO UNDERGROUND ELECTRICAL ROOM.
- 7 FC TO PROVIDE (3) #10 AWG AND (1) #10 GRD IN
- 7 EC TO PROVIDE (3) #10 AWG, AND (1) #10 GRD IN 1" CONDUIT.
- 8 EC TO PROVIDE (2) #10 AWG, AND (1) #10 GRD IN 1" CONDUIT.

 9 EC TO PROVIDE (2) #8 AWG, AND (1) #10 GRD IN 1" CONDUIT.

GREF

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RODEFELD LANDFILL

ISS

PROJECT INFORMATION:

PROJECT INFORMATI
PROJECT NUMBER: 2009-0328.00

DATE: 05-11-2010
DRAWN BY: TKA

CHECKED BY: AAS
APPROVED BY: JHK

SCALE: AS NOTED

SHEET TITLE: SITE ELECTRICAL PLAN, LIGHTING FIXTURE SCHEDULE, AND DETAILS

SHEET NUMBER:

SITI	E LIGHTING CAI	CULATIO	ON SUN	//MARY	,		
LABEL	CALC TYPE	UNITS	AVG	MAX	MIN	AVG/MIN	MAX/MIN
SITE LIGHTING	ILLUMINANCE	FC	0.98	3.8	0.1	9.80	38.00

```
0.0 0.1 0.1 0.2 0.2 0.2 0.1 0.1 0.1 0.1 0.1 0.1 0.2 0.2 0.2 0.2 0.2 0.2 0.2 0.2 0.1 0.2 0.2 0.3 0.4 0.5 0.8 1.2 1.6 1.5 0.3 0.1 0.1 0.0
                                                                                                  0.0 0.3 0.4 0.4 0.3 0.3 0.3 0.3 0.3 0.3 0.3 0.4 0.6 1.2 q1.8 <del>2.0</del> 1.9 1.9 1.0 0.5 0.3 0.2 0.3 0.3 0.4 0.6 1.2 1.5 1.8 2.5 1.0 0.3 0.1 0.0
                                                                                            0.0 0.0 0.0 0.5 0.6 0.6 0.5 0.5 0.5 0.4 0.4 0.5 0.9 1.6 2.0 2 OD-21r7 2.3 1.8 2.2 1.2 0.5 0.3 0.3 0.3 0.3 0.4 0.6 0.9 OD-21r7 O POLE #8 0.1 0.1
                                                                                            0.0 0.0 0.0 1.0 1.1 1.0 0.9 0.9 0.8 0.7 0.7 0.8 1.1 1.9 2.2 2.0 1.7 1.5 1.9 2.9 1.1 0.4 0.4 0.4 0.3 0.3 0.3 0.4 0.9 1.2 1.6 2.3 1.6 0.3 0.1 0.1
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                                                                                            0 0.0 0.0 0.0 1.9 1.8 1.8 1.8 1.5 1.2 0.9 0.8 0.8 1.0 1.6 2.7 1.8 1.2 1.3 1.3 1.4 0.9 0.6 0.5 0.4 0.3 0.3 0.4 0.6 1.0 1.4 1.7 2.1 1.5 0.3 0.1 0.1
                                                                                                    OB-15r4 3.1 2.8 2.0 1.5 1.1 0.9 0.8 0.8 1.1 1.8 1.5 1.1 1.0
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             0.0 0.0 0.0 0.0 0.1 0.1 0.1 0.1 0.1 0.2 0.2 0.3 0.3 0.0 0.0 0.0 0.0
         0.0 0.0 0.0 0.1 0.1 0.1 0.1 0.1 0.2 0.2 0.3 0.3 0.5 0.7 0.4
                                                                                                         2.5 2.2 1.8 1.6 1.4
                                                                                                                                                           0.6 0.6 0.5 0.4 0.4 0.4 0.5 0.8 1.1 1.0 0.8 0.8 1.0 1.0 0.4 0.1 0.1
      0.0 0.0 0.1 0.1 0.1 0.1 0.1 0.1 0.1 0.2 0.2 0.3 0.4 0.5 0.7 1.1 1.5 0.1
                                                                                                         2.4 2.6 2.5 2.5 2.0 1.5 1.1 1.0
                                                                                                                                                   0.8 0.7 0.8 0.9 0.8 0.6 0.5 0.6 0.6 0.7 0.9 1.0 1.2 1.6 1.8 1.7 0.4 0.2 0.1
   0.0 0.1 0.1 0.1 0.1 0.1 0.1 0.2 0.2 0.2 0.2 0.3 0.4 0.6 0.8 1.2 1.6 OB-15r4 5
   0.0 0.1 0.1 0.1 0.2 0.2 0.2 0.3 0.2 0.3 0.3 0.4 0.6 0.9 1.4 2.2 2.7 2.3 1.0
                                                                                                         0.2 2.3 1.8 1.5 1.2 0.9 0.8 0.6 0.5 0.5 0.5 0.5 0.6 0.8 1.4 OC-21r7 O 2.6 1.8 1.4 1.1 1.2 1.2 OD-21r7 OP POLE#7 0.1
   0.1 0.1 0.1 0.1 0.2 0.3 0.4 0.5 0.4 0.5 0.4 0.5 0.7 1.1 1.7 2.6 2.9 2.4 2.2
                                                                                                                                                                    O POLE #6 \ 3.3 2.0 1.3 1.0 0.9 1.3 1.3 1.6 2.4 1.5 0.3 0.1
0.0 0.1 0.1 / 0.2 0.2 0.3 0.4 0.6 0.6 0.5 0.4 / 0.4 / 0.5 / 0.7 1.0 1.4 1.8 1.8 1.6 1.9 0.1
                                                                                                            1.1 1.5 1.1 1.0 0.8 0.7 0.6 0.5 0.5 0.4 0.5 0.6 0.7
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0.0 0.1 \(\rightarrow\text{POLE}\)\(\frac{\text{#5}}{\text{1}}\)\(\frac{\text{OD-19rb}}{\text{5}}\)\(\frac{\text{OD-19rb}}{\text{1.2}}\)\(\text{0.8}\)\(\text{0.8}\)\(\text{0.8}\)\(\text{0.3}\)\(\text{0.3}\)\(\text{0.3}\)\(\text{0.3}\)\(\text{0.7}\)\(\text{1.5}\)
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                                                                                                                                                                    0.1 0.1 0.1 0.1 0.1 0.1 0.2 0.2 0.2 0.1 0.1 0.1 0.1 0.0
   0.0 0.1 0.2 0.4 1.5 1.9 2.1 2.2 0.8 0.4 0.3 0.3 0.2 0.2 0.6 1.9
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                 0.0 0. POLE #4.0 \bigcirc 1.9 1.2 1.1 0.8 0.5 0.3 0.3 0.3 0.3 0.3 0.3 0.4 \bigcirc 0.4 0.6 0.9 1.5 1.7 1.4 1.0 0.6 0.5 0.6 0.7 0.8 0.9 0.8 0.6 0.5 0.4 0.4 0.4 0.4 0.3 \bigcirc 0.3 0.3 0.3 0.2 0.2 0.2 0.1 0.1 0.1 0.1 0.0
                 0.0 0.1 0.2 0.7 2.2 2.5 1.5 1.4 0.9 0.6 0.4 0.4 0.3 0.3 0.3 0.3 0.4 0.4 0.5 0.5 0.7 1.0 1.2 1.0 0.8 0.6 0.5 0.4 0.5 0.6 0.6 0.6 0.6 0.5 0.4 0.3 0.3 0.3 0.2 0.2 0.2 0.2 0.2 0.1 0.1 0.1 0.1 0.1 0.1 0.0
                 0.0 0.1 0.2 0.4 1.7 2.3 2.6 2.1 0.9 0.6 0.5 0.4 0.5 0.4 0.5 0.4 0.5 0.6 0.6 0.5 0.5 0.7 0.8 0.8 0.6 0.5 0.4 0.4 0.4 0.4 0.4 0.4 0.4 0.5 0.4 0.4 0.3 0.3 0.2 0.2 0.2 0.2 0.2 0.2 0.1 0.1 0.1 0.1 0.1 0.1 0.0 0.0
                   0.0 0.0 0.1 0.1 0.2 0.4 0.6 1.0 1.8 4.3 5.0 2.7 1.4 0.7 0.4 0.3 0.2 0.1 0.1 0.1 0.1 0.1 0.1 0.1 0.0 0.0
                                                 0.0 0.1 0.1 0.2 0.4 0.6 1.0 2.1 4.6 76 0F-17\hat{r}5 12 0.6 0.3 0.2 0.2 0.1 0.1 0.1 0.1 0.1 0.0 0.0
                                                    0.0 0.1 0.2 0.4 0.7 0.9 1.8 POLE #2 5.6 3.0 1.3 0.8 0.5 0.3 0.2 0.1 0.1 0.1 0.1 0.1 0.0 0.0
                                                     0.0 0.1 0.1 0.3 0.6 1.0 1.4 2.4 4.3 49 2.6 1.4 0.9 0.5 0.3 0.2 0.1 0.1 0.1 0.1 0.1 0.0
                                                        0.1 0.1 0.2 0.5 0.7 0.9 1.3 1.9 1.9 1.6 0.9 0.5 0.3 0.2 0.2 0.1 0.1 0.1 0.0 0.0
                                                        0.0 0.1 0.1 0.3 0.5 0.7 0.8 1.0 1.2 1.2 1.0 0.9 0.5 0.3 0.2 0.1 0.1 0.1 0.1 0.0 0.0
                                                           0.0 0.1 0.2 0.3 0.4 0.5 0.6 0.6 0.6 0.6 0.6 0.5 0.3 0.2 0.1 0.1 0.1 0.1 0.0
                                                           0.0 0.1 0.1 0.2 0.3 0.3 0.4 04 0.4 0.4 0.3 0.2 0.2 0.1 0.1 0.1 0.0 0.0
```





GENERAL NOTES:

1.) FOOT CANDLE CALCULATIONS POINTS AT GROUND

2.) ILLUMINATION LEVEL ASSUMED TO BE ON FLAT

GREF

One Honey Creek Corporate Center 125 South 84th Street, Suite 401 Milwaukee, WI 53214-1469 414 / 259 1500 414 / 259 0037 fax

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CONSULTANTS:

PROJECT TITLE:

DANE COUNTY
WASTE TRANSFER STATION
AND HOUSEHOLD HAZARDOUS
WASTE FACILITY
RODEFELD LANDFILL

ISSUE:

PROJECT INFORMATION:

PROJECT NUMBER: 2009-0328.00

DATE: 05-11-2010

DRAWN BY: TKA


CHECKED BY: AAS

APPROVED BY: JHK


SCALE: AS NOTED

SHEET TITLE:

SITE PHOTOMETRIC PLAN

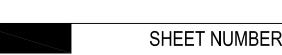



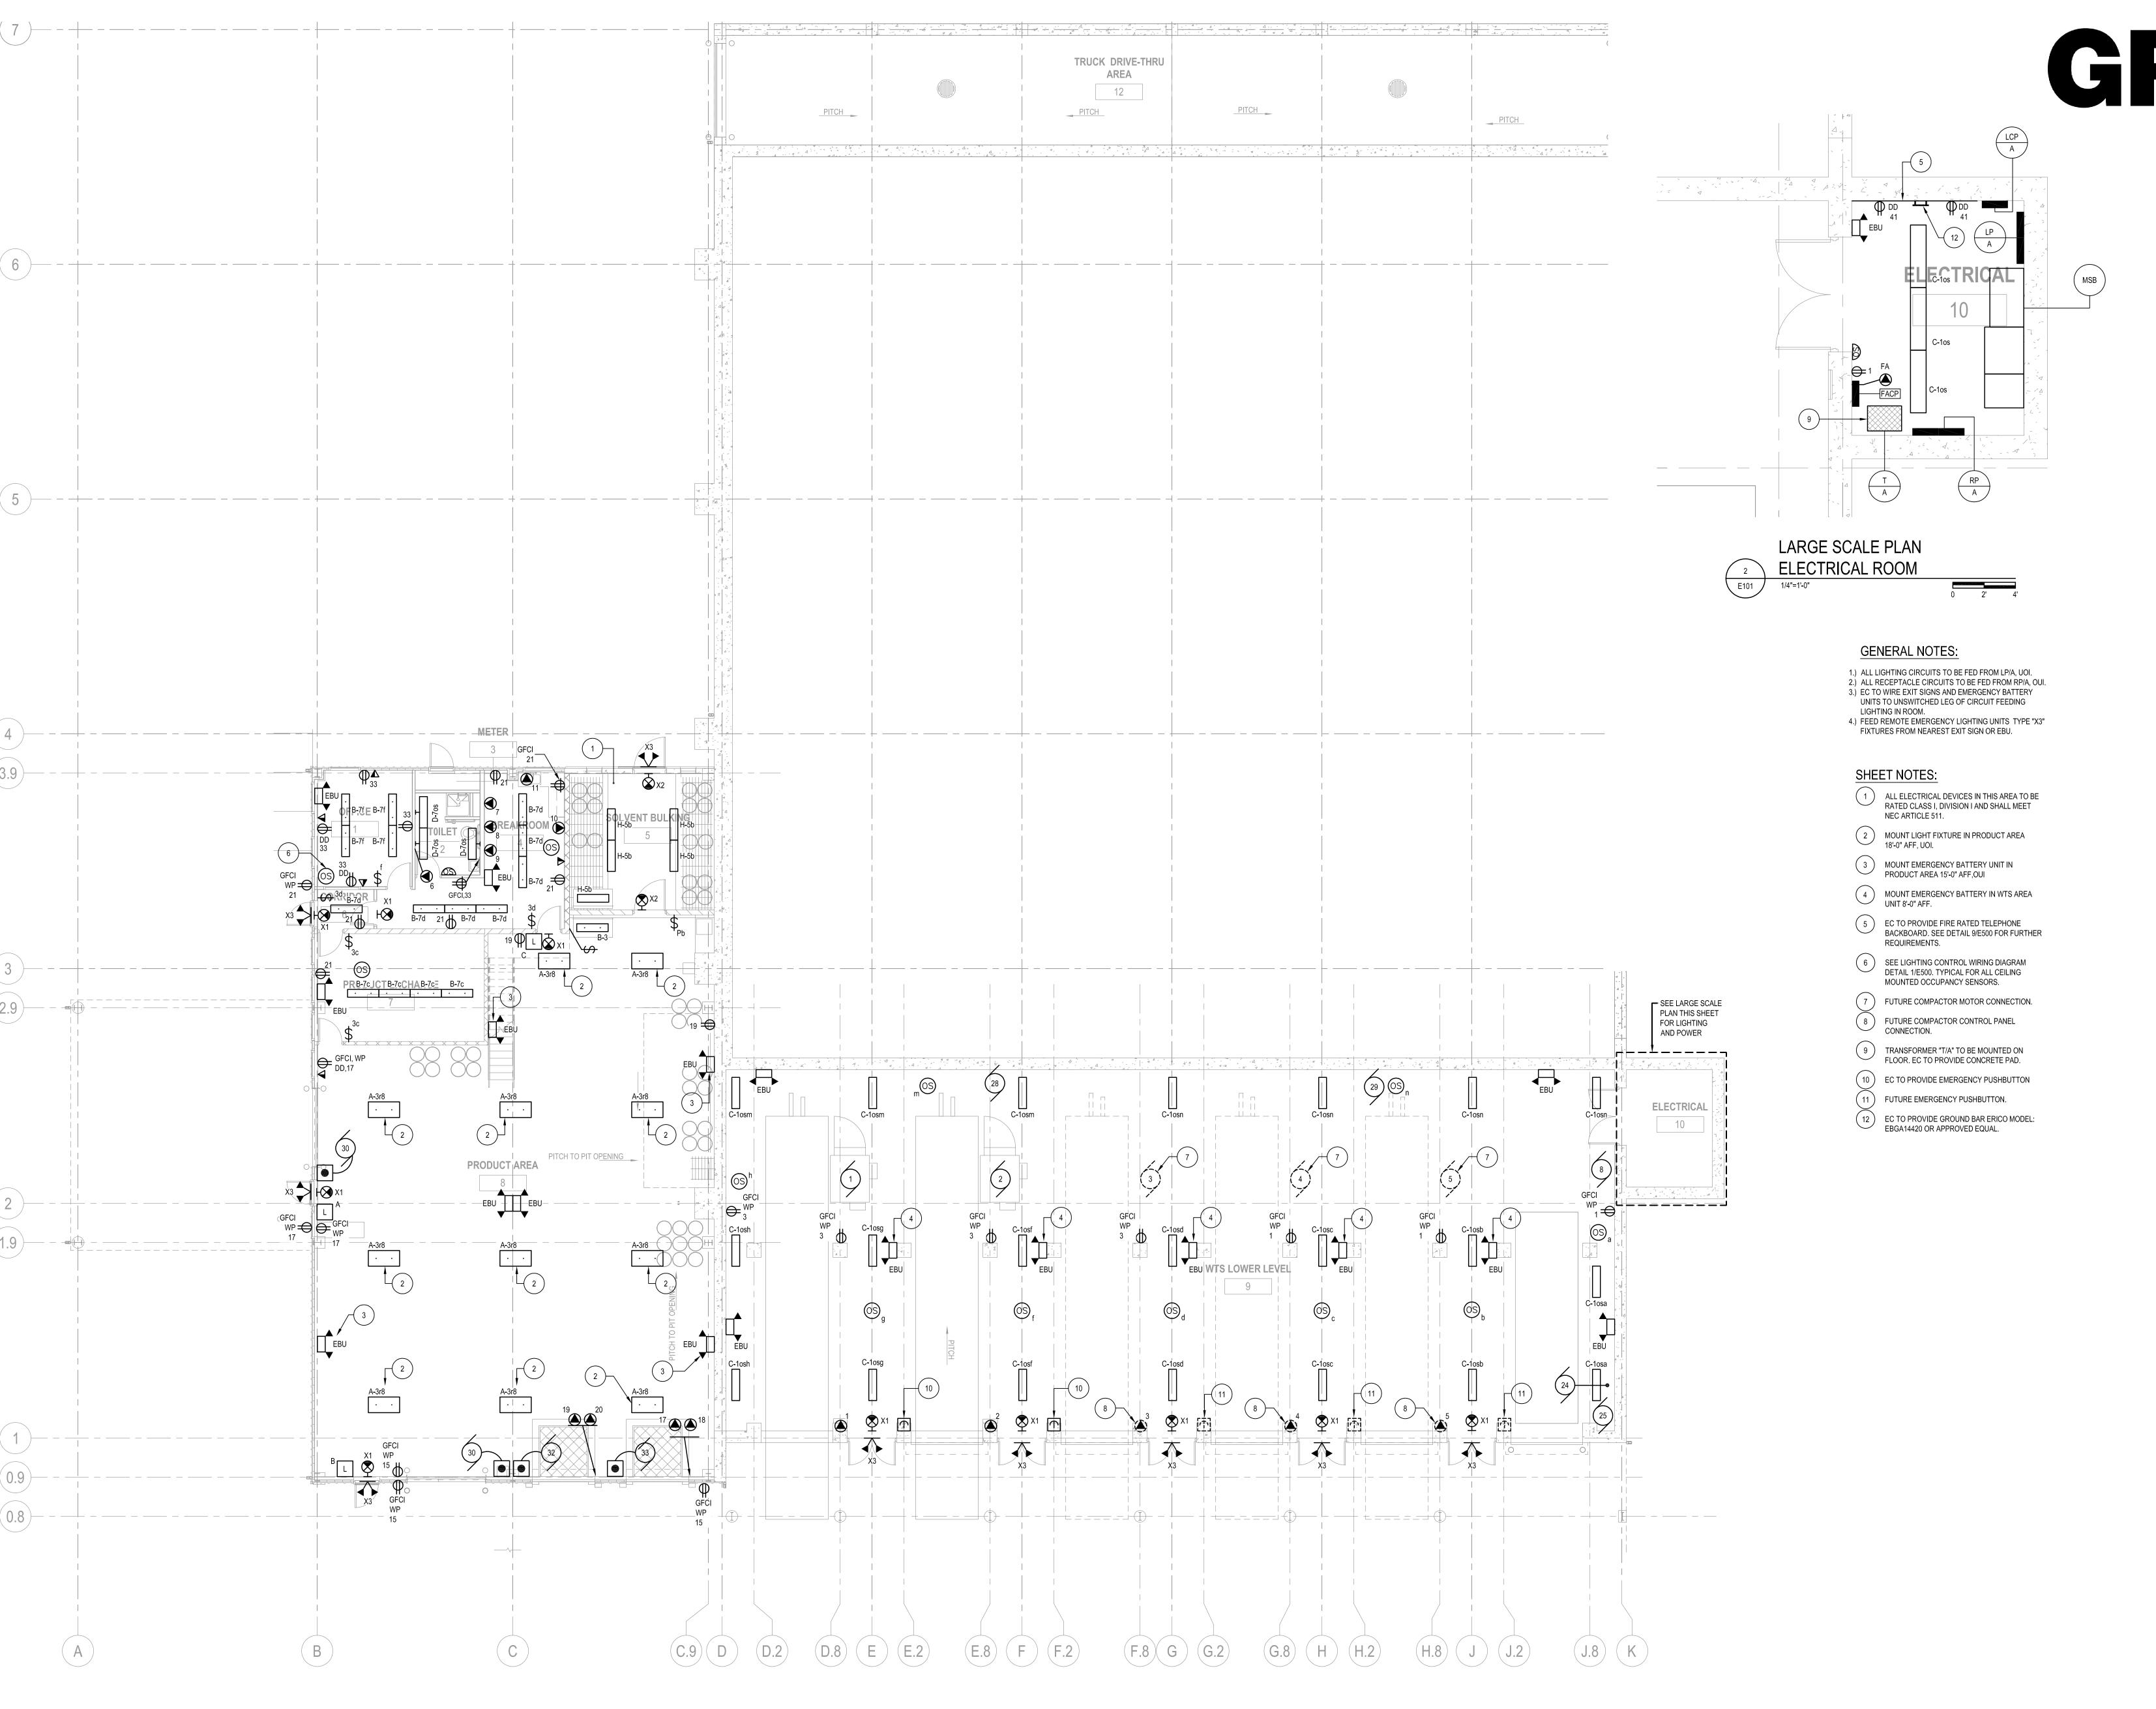

HHW FIRST FLOOR / WTS LOWER LEVEL ELECTRICAL PLAN

1/8"=1'-0"

GRAEF

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PROJECT NUMBER: 2009-0328.00
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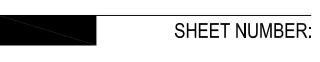
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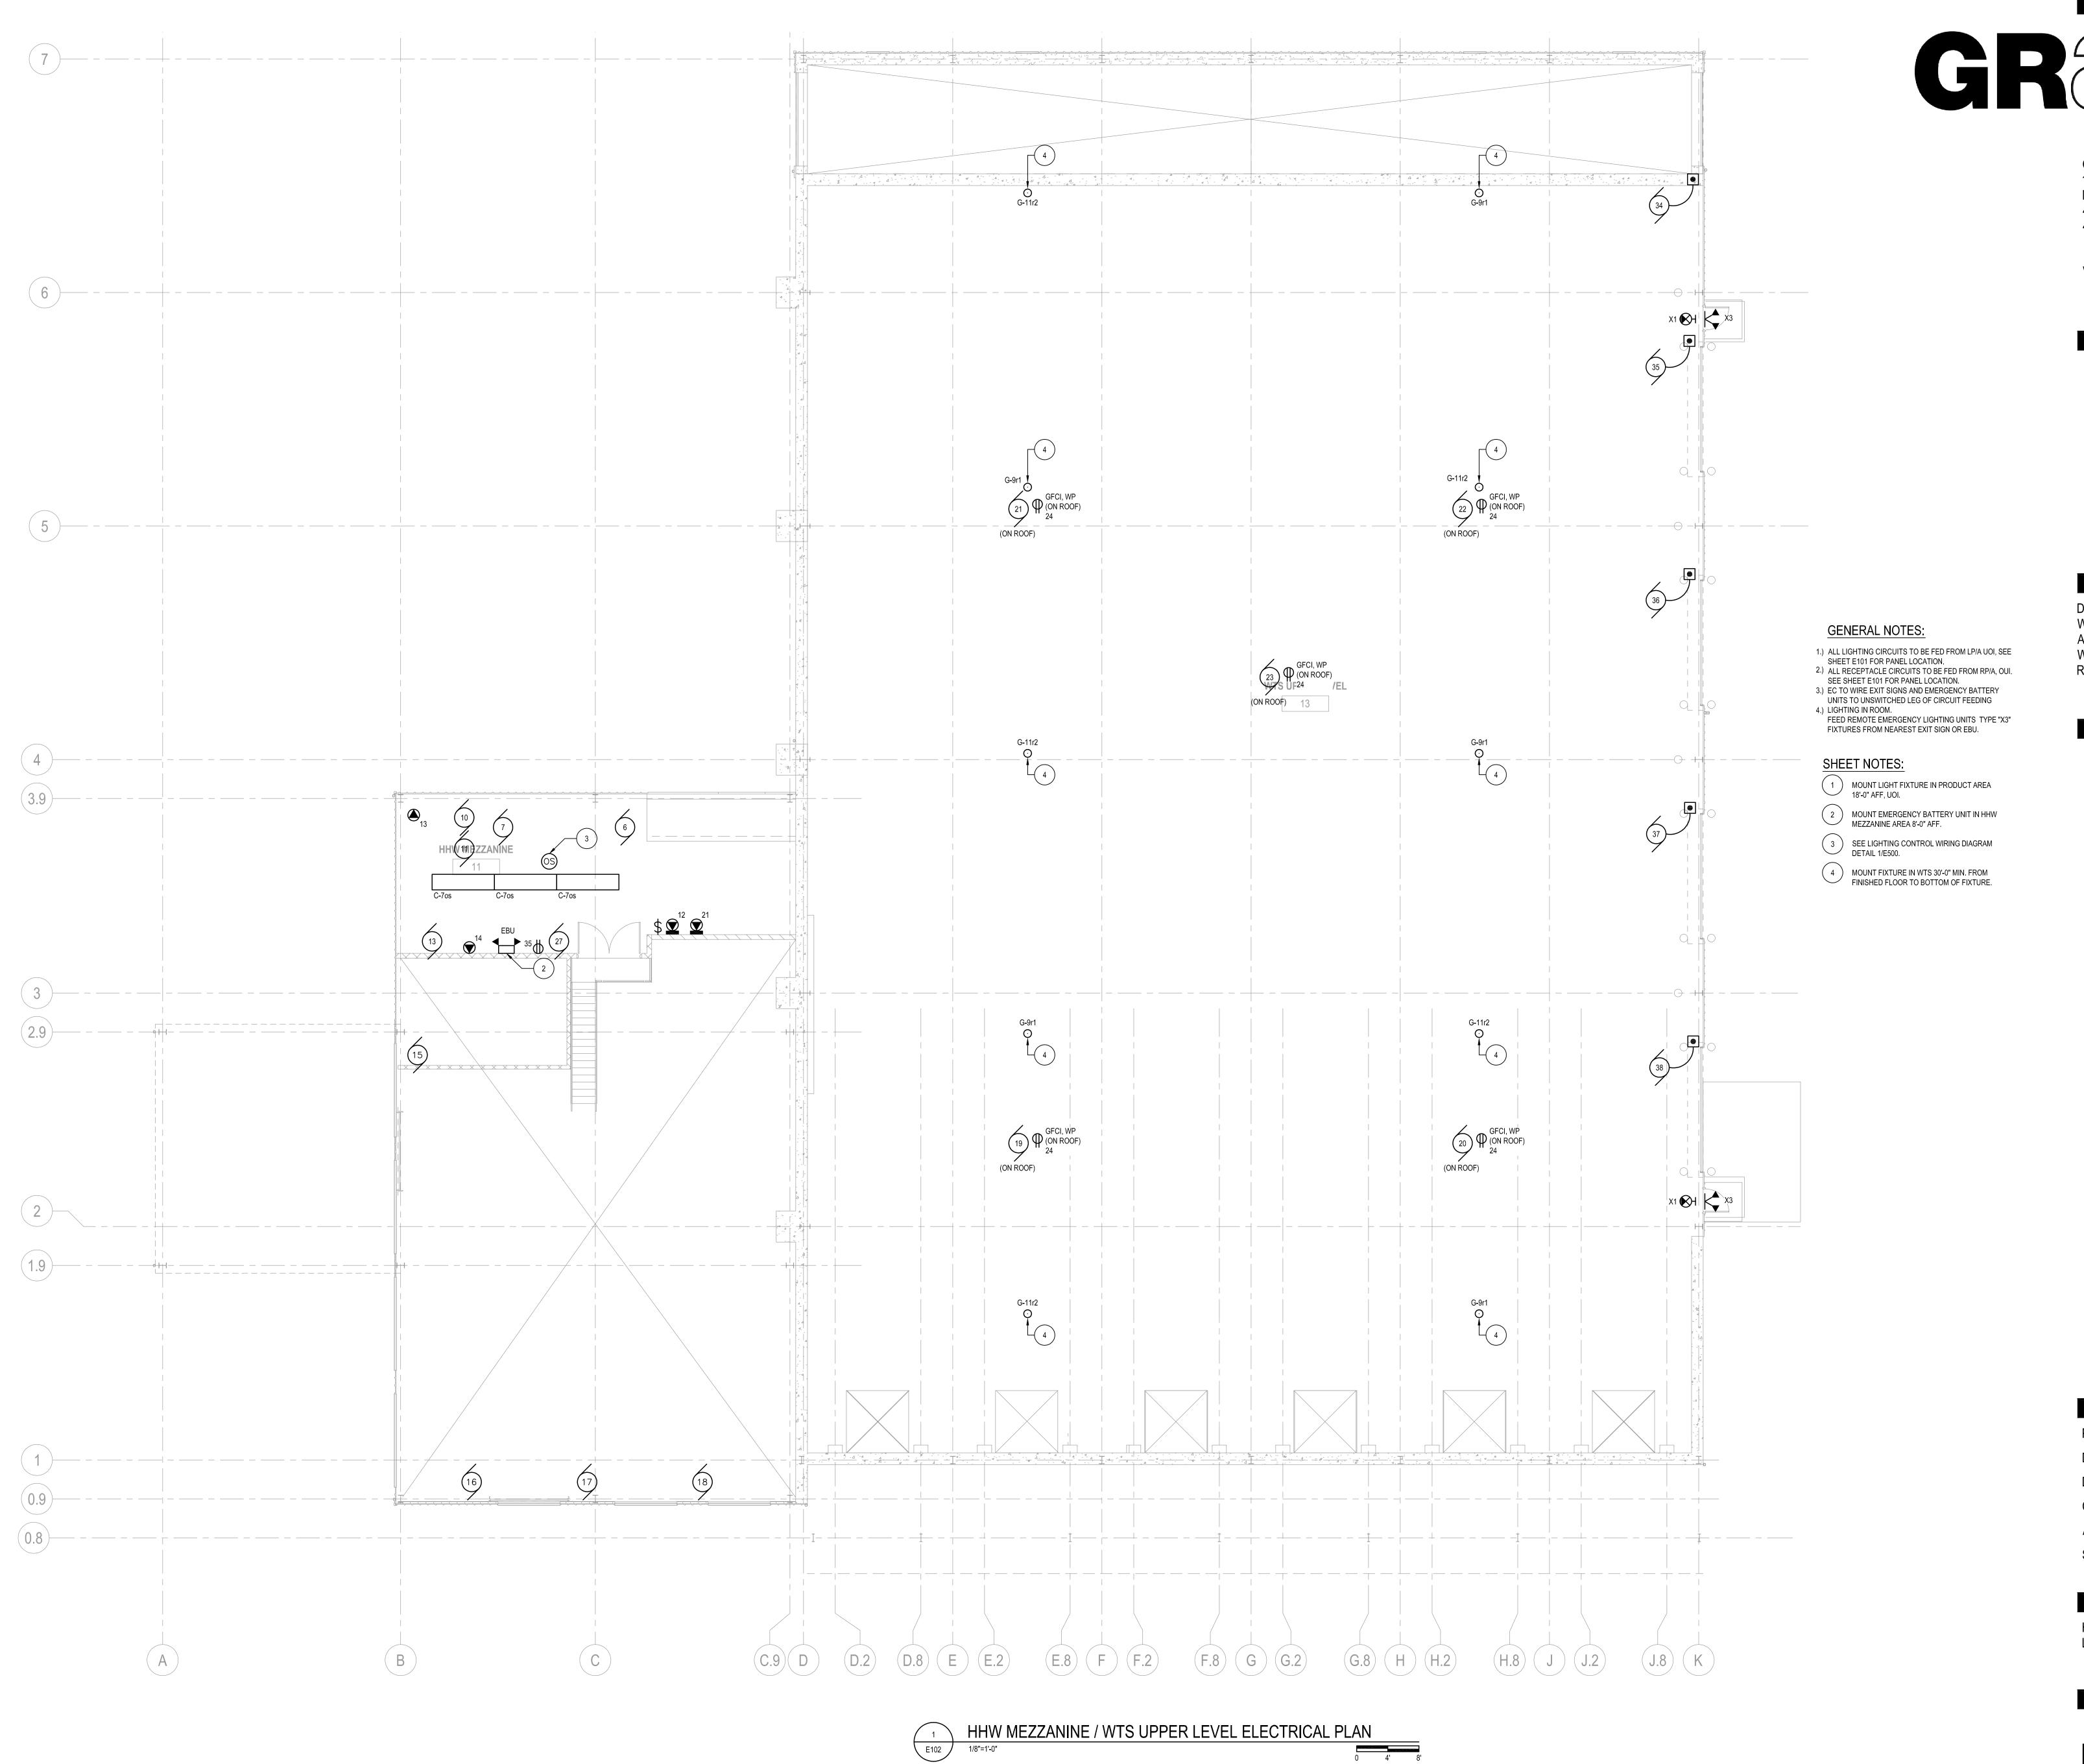
APPROVED BY: JHK

SCALE: AS NOTED

SHEET TITLE: HHW FIRST FLOOR / WTS LOWER

LEVEL ELECTRICAL PLAN







One Honey Creek Corporate Center 125 South 84th Street, Suite 401 Milwaukee, WI 53214-1469 414 / 259 1500 414 / 259 0037 fax

www.graef-usa.com

CONSULTANTS:

PROJECT TITLE:

DANE COUNTY WASTE TRANSFER STATION AND HOUSEHOLD HAZARDOUS WASTE FACILITY RODEFELD LANDFILL

ISSUE:

PROJECT INFORMATION:

PROJECT NUMBER: 2009-0328.00 05-11-2010


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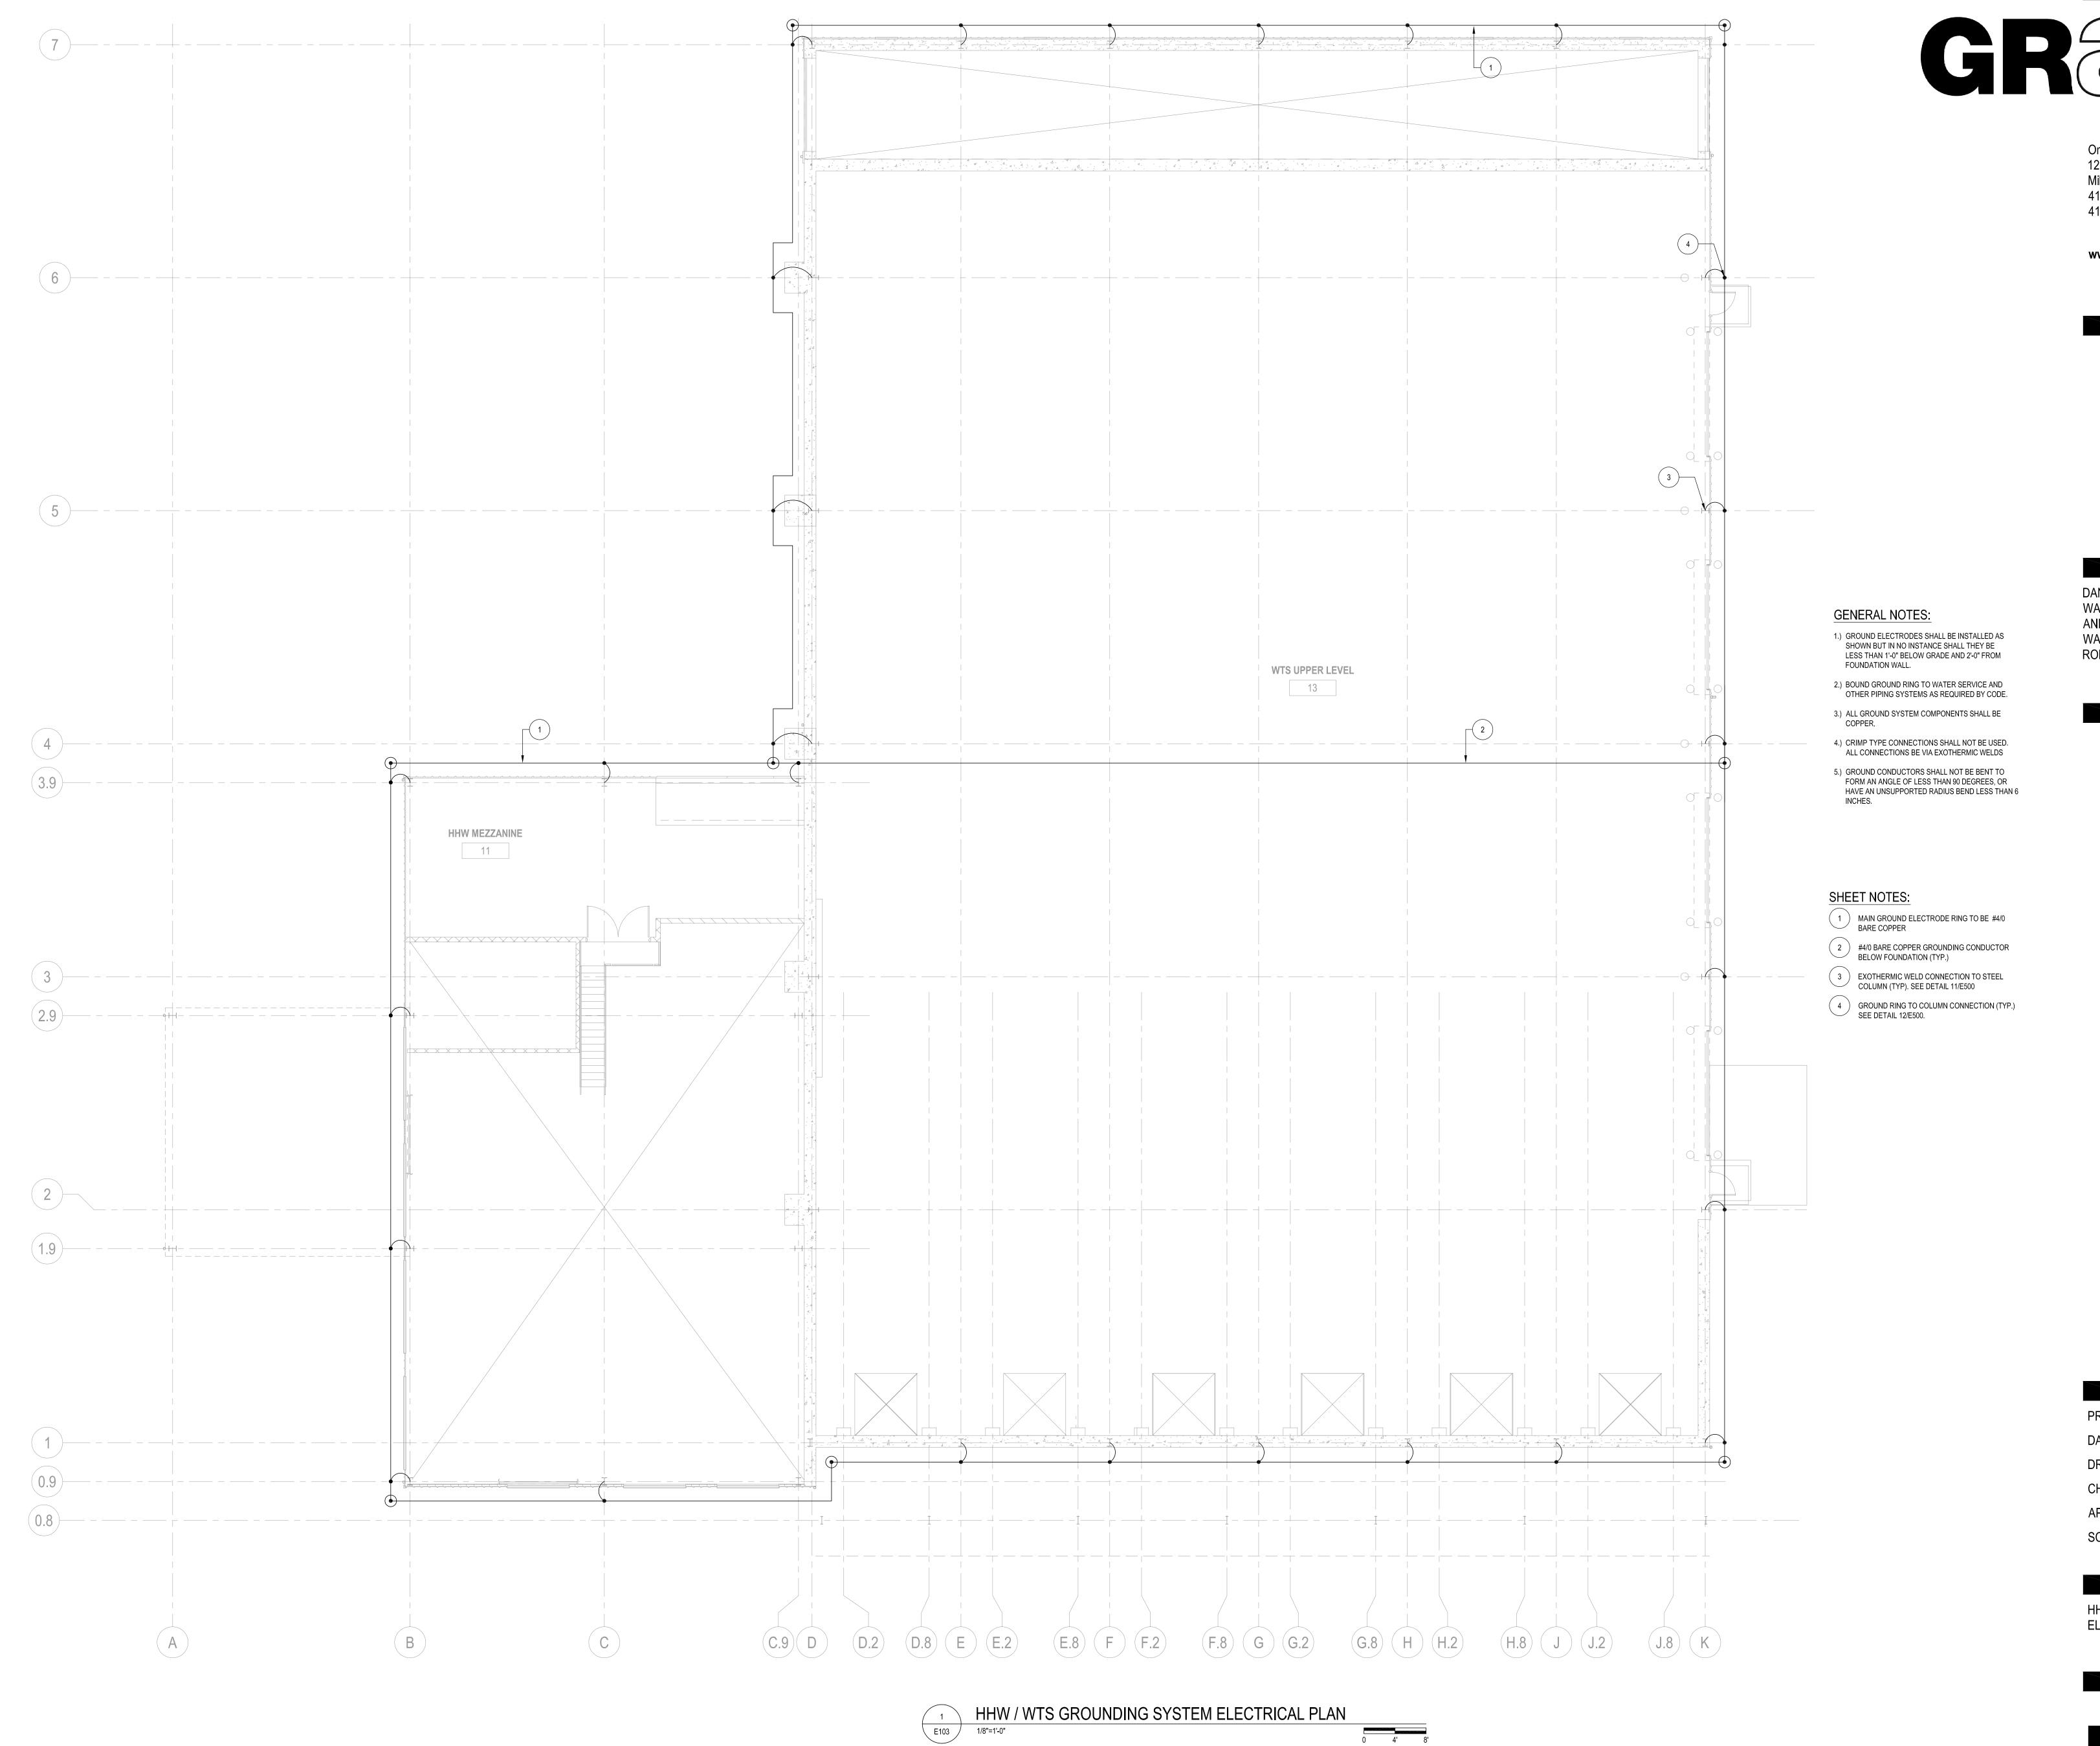
SCALE: AS NOTED

SHEET TITLE:

HHW MEZZANINE / WTS UPPER LEVEL ELECTRICAL PLAN





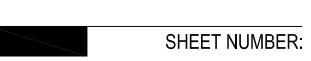

One Honey Creek Corporate Center 125 South 84th Street, Suite 401 Milwaukee, WI 53214-1469 414 / 259 1500 414 / 259 0037 fax

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CONSULTANTS:

PROJECT TITLE:

DANE COUNTY WASTE TRANSFER STATION AND HOUSEHOLD HAZARDOUS WASTE FACILITY RODEFELD LANDFILL

ISSUE:

PROJECT NUMBER: 2009-0328.00 05-11-2010


CHECKED BY:

APPROVED BY: JHK


SCALE: AS NOTED

SHEET TITLE:

HHW / WTS GROUNDING SYSTEM ELECTRICAL PLAN

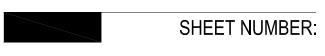



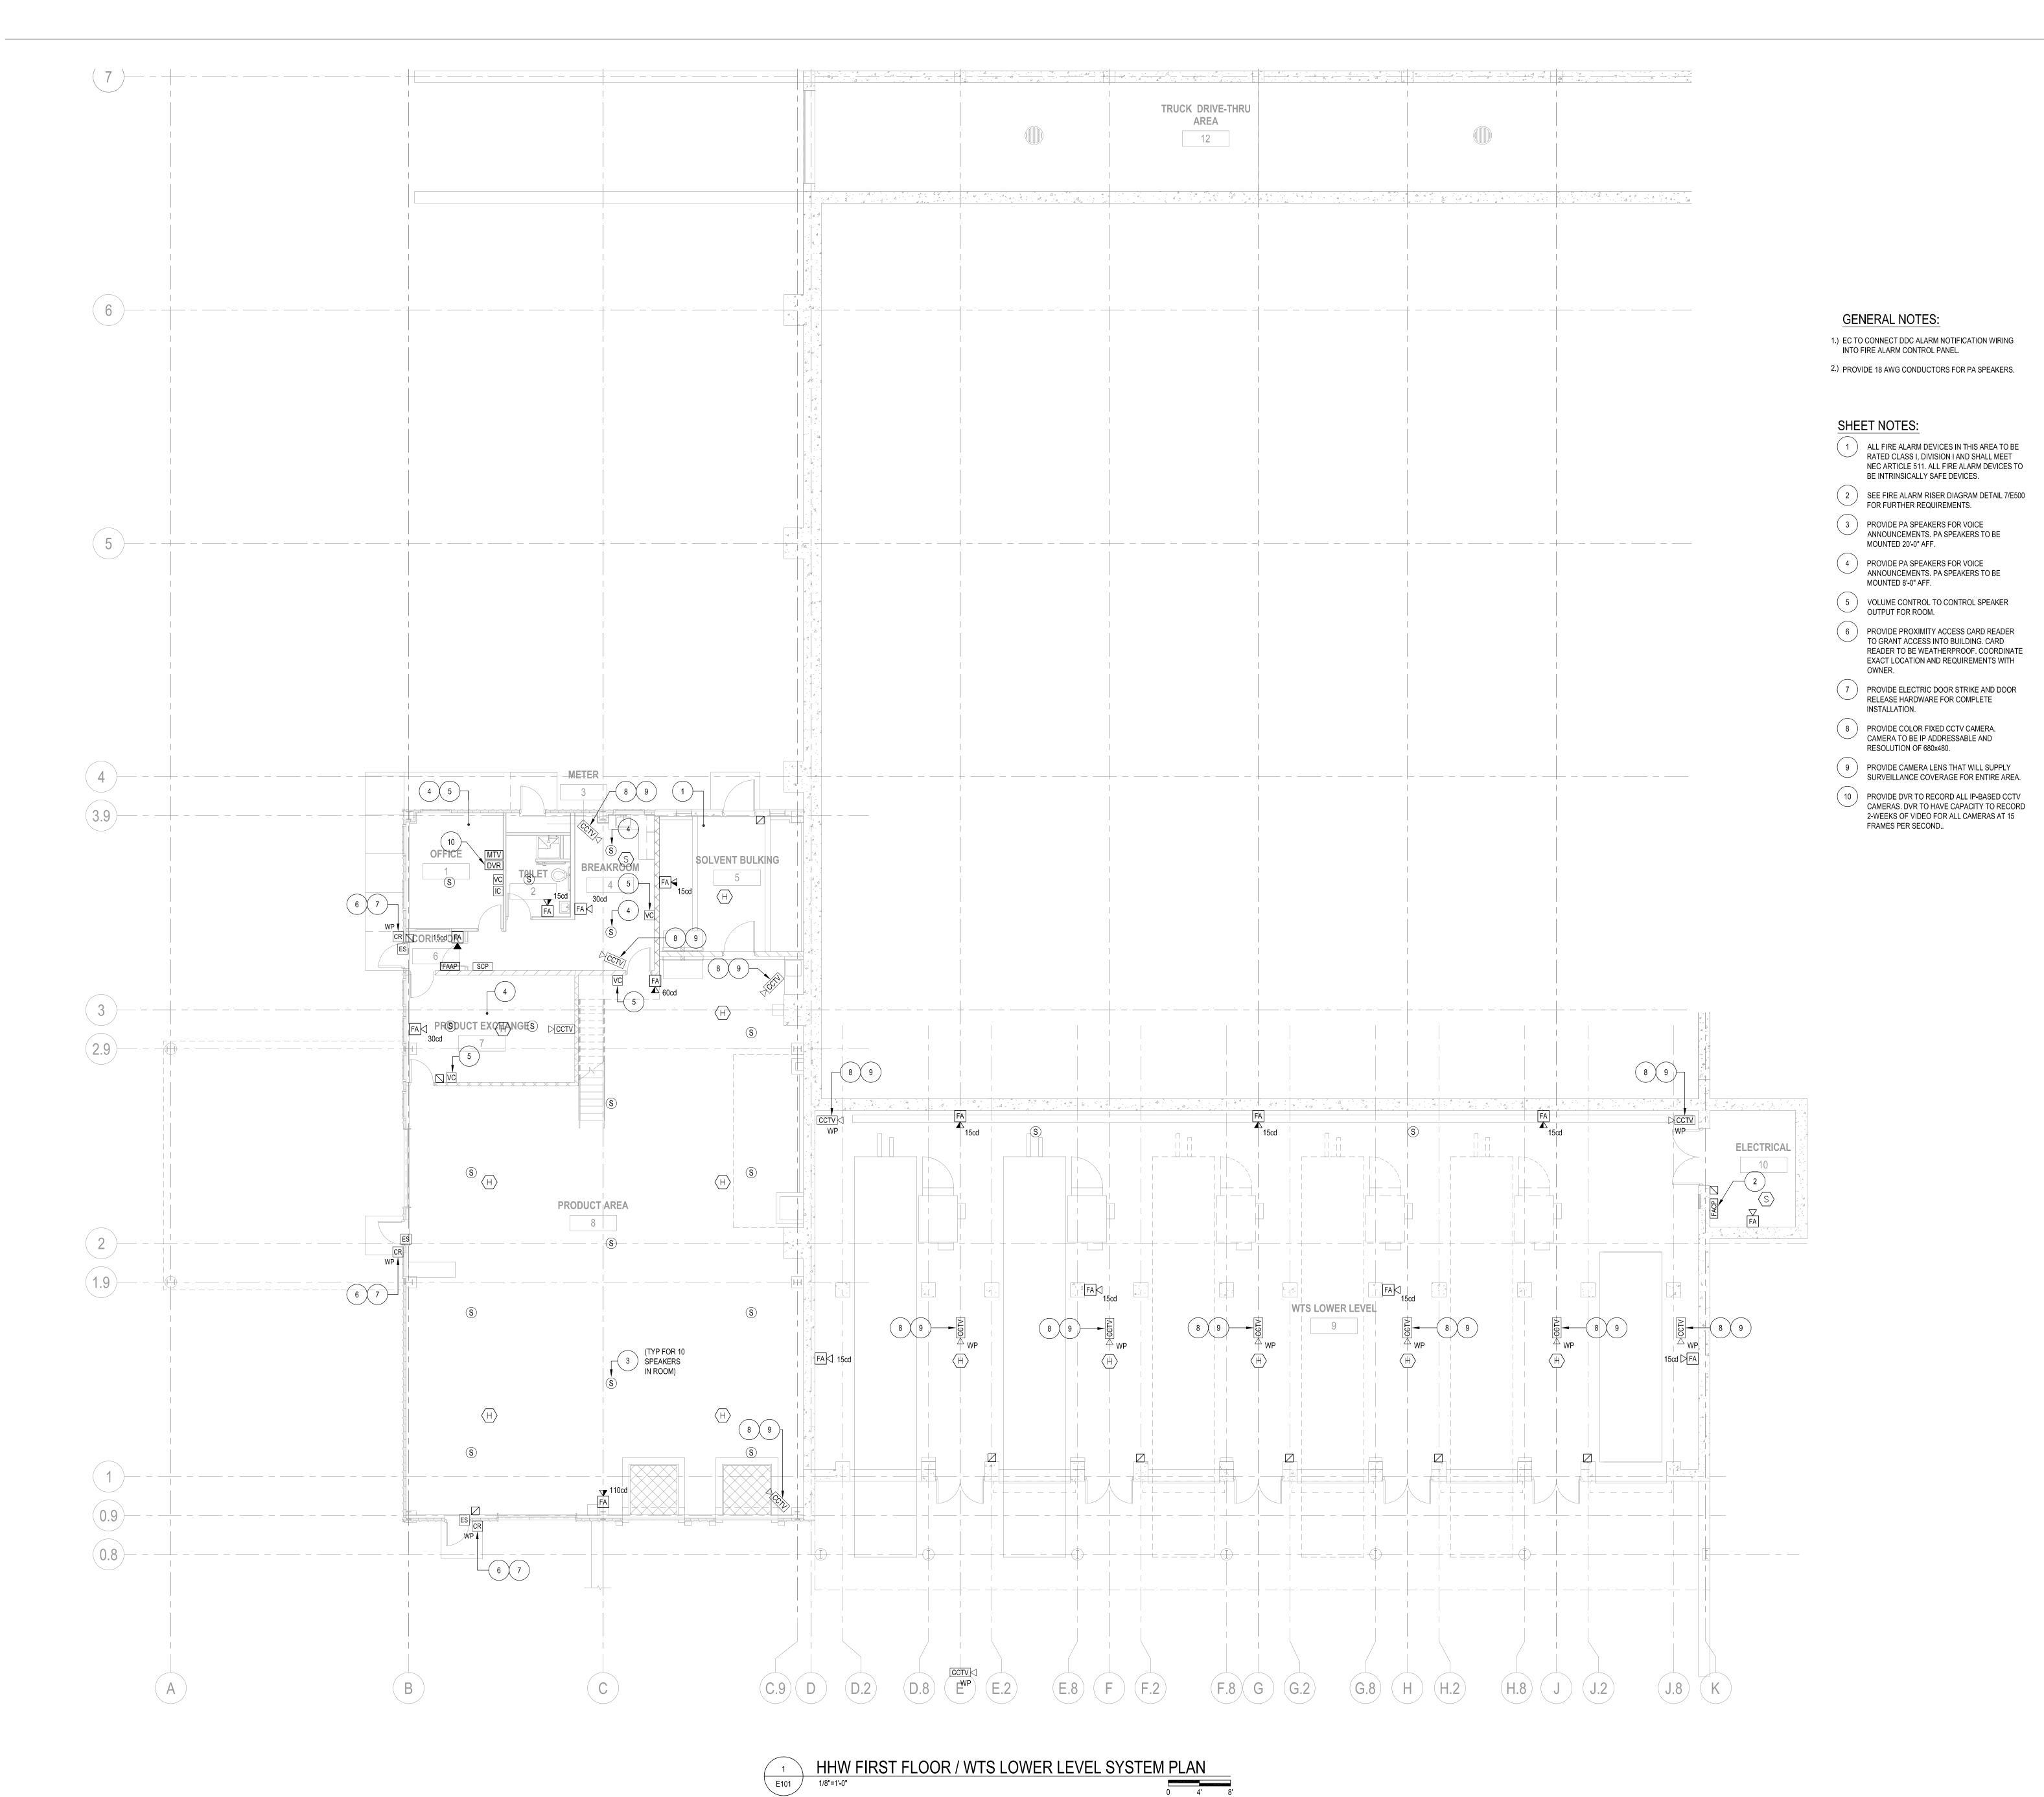



One Honey Creek Corporate Center 125 South 84th Street, Suite 401 Milwaukee, WI 53214-1469 414 / 259 1500 414 / 259 0037 fax

www.graef-usa.com

CONSULTANTS:

PROJECT TITLE:

ISSUE:

DANE COUNTY
WASTE TRANSFER STATION
AND HOUSEHOLD HAZARDOUS
WASTE FACILITY
RODEFELD LANDFILL

PROJECT INFORMATION

PROJECT NUMBER: 2009-0328.00
DATE: 05-11-2010

DRAWN BY:

CHECKED BY: AAS
APPROVED BY: JHK


SCALE: AS NOTED

SHEET TITLE:

HHW FIRST FLOOR / WTS LOWER LEVEL SYSTEM PLAN





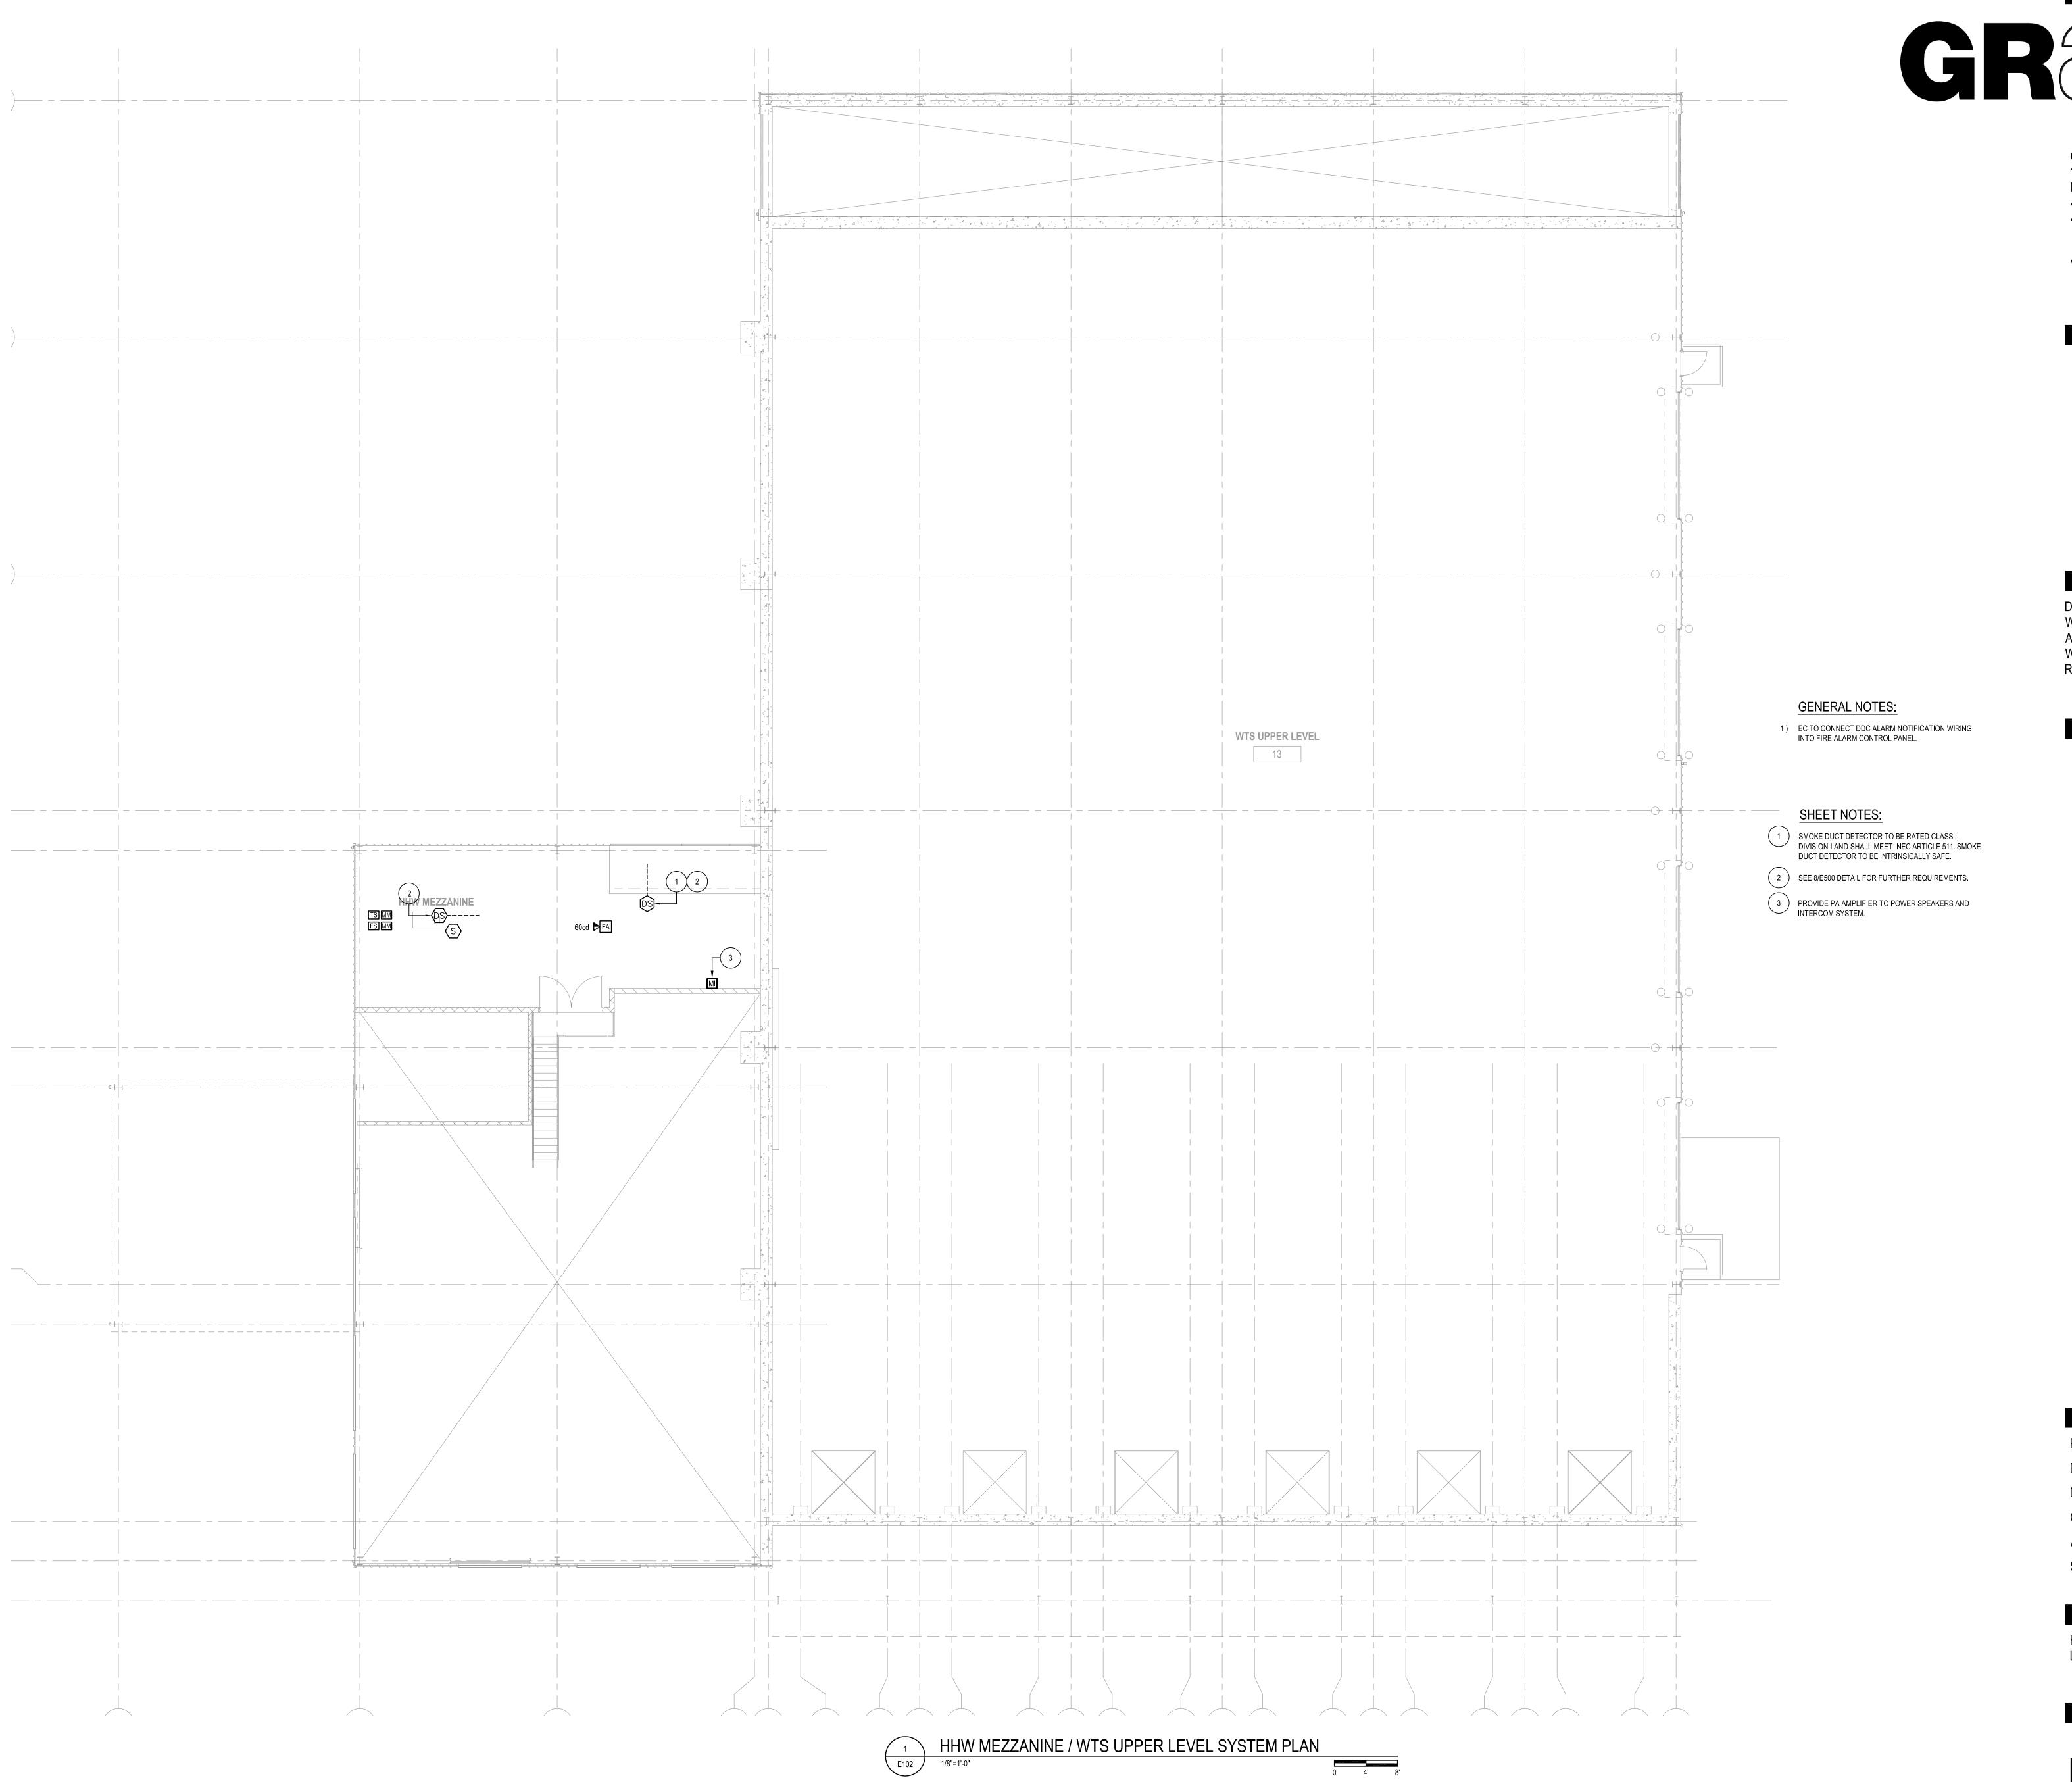

One Honey Creek Corporate Center 125 South 84th Street, Suite 401 Milwaukee, WI 53214-1469 414 / 259 1500 414 / 259 0037 fax

www.graef-usa.com

CONSULTANTS:

PROJECT TITLE:

ISSUE:

DANE COUNTY WASTE TRANSFER STATION AND HOUSEHOLD HAZARDOUS WASTE FACILITY RODEFELD LANDFILL


PROJECT NUMBER: 2009-0328.00 05-11-2010

CHECKED BY:

APPROVED BY: JHK SCALE: AS NOTED

SHEET TITLE:

HHW MEZZANINE / WTS UPPER LEVEL SYSTEM PLAN

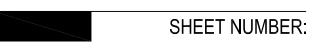

																T) (DE				STARTE		0.UED D) (<u> </u>									TOR DISC	ONNECT			1	EQU	ESSORIES	WIRED			ARTER/UN			
																TYPE					FURNIS	SHED BY		ACCES	SSORIES	S ON START	IER				TYPE			FUI	RNISHED BY		<u></u>	TO START	ER			JOHINGE			
1.				N STARTERS SHALL BE CIRCUIT BREAKER TYPE UN DNNECT SWITCH FOR ALL MOTORS LOCATED IN SIG			≣D.						AL TO UNIT	L VATION, MAGNETIC,	VOL I AGE REVERSING	IIC, FULL VOL I AGE SING	TATE BENIICED		TEED, I WINDING	PEED, 2 WINDING	ACTURER	ACTOR ACTOR RICAL CONTRACTOR	F, PUSHBUTTON	; SWITCH	JFF-AUTO	LIGHT	LOSS PROTECTION	STARTER SIZE	AL TO UNIT	쥖ㅣ;;	SWITCH	T BREAKER NEAR	X ENCLOSURE	IENT ACTURER	HANICAL TRACTOR STRICAL CONTRACTOR	, PUSHBUTTO	; SWITCH	JFF-AUTO	ІСНТ	LOSS PROTECTION	HVAC DRAWINGS SPECIFICATION		AL	ПЕЅ	
# LOAD) \	VOLT	PH	LOC (RM) DRIVING	FEED F	FROM		AKER	+		H WIRING	COND	INTEGR	MANUAI	FULL VG NON-RE	MAGNE II REVERSII	VFD	VOLTAGE	TO OWI	TWO SF EQUIPN	告ㅣ돺	CONTR	· I LL	ON-OFF,	HAND-C	PILOT L	PHASE	NEMA S	INTEGR	NOT RE	NEAR MG FUSIBLE	CIRCUIT	NEMA 4	EQUIPN MANUF,		ON-OFF	ON-OFF	HAND-C	PILOT LIGH	ĕ	SEE HV AND SP	MANUAI	INTEGR	SEE NO.	#
1 200A	4	480	3	9 COMPACTOR	MSB-1	-	-	— SE	E ONE LIN	E DIAGR	AM —	-								•	•										•)			•									3	1
2 200A	۸	480	3	9 COMPACTOR	MSB-1	-	-	SE	E ONE LIN	E DIAGR	AM —	-	•							•											•)			•									3	2
3 200A	4	480	3	9 COMPACTOR (FUTURE)	MSB-1	_	-	SE	E ONE LIN	E DIAGR	AM —	-	•							•											•)			•									3	3
4 200A	4	480	3	9 COMPACTOR (FUTURE)	MSB-1	-	-	SE	E ONE LIN	E DIAGR	AM ——	-	•							•											•				•	_								4	4
5 200A	4	480	3	9 COMPACTOR (FUTURE)	MSB-1	-	-	— SE	E ONE LIN	E DIAGR	AM —	<u></u>	•							•	•				_						•)			•	_								4	5
6 10HP		480	3	11 MAU-1 (SUPPLY)	LP/A	2,4,6	30	3	3	10	10	3/4"					9								•										•	-								2	6
7 10HP		480	3	11 MAU-1 (EXHAUST)	LP/A	8,10,12	30	3	3	10	10	3/4"													•					•					•	_								2	7
8 7 FLA	-	120	1	11 ERV-1	RP/A	2	20	1 1	2	12	12	3/4"												-	-									•	•	-								2	8
9 22MC	+	208	1	11 ACCU-1 11 PP-1	RP/A	4,6 14,16,18	35	1	3	8	10	3/4"					9			•											•				•	-								1,2	10
10 7.5HF 11 7.5HF		480	3	11 PP-1 11 PP-2	LP/A LP/A	20,22,24	20	3	3	12 12	12	3/4"																		-					•	_								2	11
12 3/4HF		480		11 CP-1	LP/A	26,28,30	+	3	3	12	12	3/4"			•	,																				-								1,2	12
13 1/2HF	-	120		11 CP-2	LP/A	28	20	1	2	12	12	3/4"			9																				•	-		+						1,2	13
14 3/4HF	-	480		11 CP-3	LP/A	38,40,42		3	3	12	12	3/4"			•						_														•	-								1,2	14
15 .15HF	-+	120		11 UH-1	RP/A	8	20	1	2	12	12	3/4"																							•	-		1				+		2	15
16 .15HF	-+	120		11 UH-2	RP/A	10	20	1	2	12	12	3/4"																							•	-								2	16
17 .15HF	-	120	1	11 UH-3	RP/A	12	20	1	2	12	12	3/4"																								-								2	17
18 .15HF	P	120	1	11 UH-4	RP/A	14	20	1	2	12	12	3/4"																		•	•													2	18
19 3/4HF	P	480	3	11 EF-1	LP/A	43,45,47	20	3	3	12	12	3/4"								•														•										1,2	19
20 3/4HF	P	480	3	11 EF-2	LP/A	49,51,53	20	3	3	12	12	3/4"	•	(•					•														•										1,2	20
21 3/4HF	Р	480	3	11 EF-3	LP/A	55,57,59	20	3	3	12	12	3/4"	•							•										(•			•										1,2	21
22 3/4HF	P	480	3	11 EF-4	LP/A	61,63,65	20	3	3	12	12	3/4"			•					•											•			•										1,2	22
23 1/4HF	Р	120	1	11 EF-5	RP/A	26	20	1	2	12	12	3/4"	•	(9					•	•									(•										1,2	23
24 1 1/2HF	Р	480	3	9 EF-6	LP/A	63,65,67	20	3	3	12	12	3/4"		(•																			•										1,2	24
25 1 1/2HF	Р	480	3	9 EF-7	LP/A	73,75,77	20	3	3	12	12	3/4"																						•										1,2	25
26 1/3HF	IP	120	1	9 EF-8	RP/A	30	20	3	3	12	12	3/4"								•														•										1,2	26
27 1/4HF	IP	208	1	11 FC-1	RP/A	32,34	20	1	2	12	12	3/4"		(•	•													•										1,2	27
28 3/4HI	IP	480	3	9 IFP-1	LP/A	52,54,56	20	3	3	12	12	3/4"								•															•									3	28
29 3/4HI	IP	480	3	9 IFP-2	LP/A	58,60,62	20	3	3	12	12	3/4"													_										•	-								3	29
30 1HP		120	-+	8 OVERHEAD DOOR	RP/A	51	20	1	3	12	12	3/4"	•							•	-				_						•				•									3	30
31 1HP	_	120		8 OVERHEAD DOOR	RP/A	53	20	1	3	12	12	3/4"	•																		•				•									3	31
32 1HP		120		8 OVERHEAD DOOR	RP/A	55	20	1	3	12		3/4"	•																		•				•									3,5	32
33 1HP	_	120	-	8 OVERHEAD DOOR	RP/A	57	20	1	3	12		3/4"	•								•				-			\perp							•									3,5	33
34 2HP	-+	120		WTS OVERHEAD DOOR	RP/A	59	20	1	3	12	12	3/4"	•												-			\perp							•	-								3,5	34
35 2HP		120		WTS OVERHEAD DOOR	RP/A	61	20	1	3	12	12	3/4"	•																						•	-								3,5	35
36 2HP	_			WTS OVERHEAD DOOR	RP/A	63	20	1 .	3	12	12	3/4"													-			-							•									3,5	36
37 2HP	-+	120		WTS OVERHEAD DOOR	RP/A	65	20	1	3	12	12	3/4"									_							_							•									3,5	37
38 2HP		120		WTS OVERHEAD DOOR ING SCHEDULE NOTES:	RP/A	67	20	1] 3]	12	12	3/4"																					<u> </u>		•									3,5	38

MOTOR STARTER / WIRING SCHEDULE NOTES:

- EC TO PROVIDE HACR BREAKERS. EC TO COORDINATE WITH MECHANICAL CONTRACTOR FOR EXACT REQUIREMENTS.
- EC TO COORDINATE WITH EQUIPMENT MANUFACTURER FOR EXACT REQUIREMENTS. EC TO PROVIDE SPARE CIRCUIT BREAKER FOR FUTURE COMPACTORS.
- 5. EC TO COORDINATE EXACT HORSEPOWER AND VOLTAGE WITH DOOR MANUFACTURER. PROVIDE ALL WIRING INTERFACES WITH LIMIT SWITCHES, DOOR CONTROLLER, ETC.

			SPECIAI	_ PURPOSE	OUTLE	T SCHE	DULE						
#	SERVING	LOC	FEED	FROM	BRE/	AKER		WIRING		VOLT	PHASE	LOAD	SEE
#	SERVING		PANEL	CIRCUIT	SIZE	POLE	#	SIZE	COND	VOLI	FRASE	LOAD	NOTE
1	COMPACTOR CONTROL PANEL	9	RP/A	5	20	1	3	12	3/4"	120	1		1
2	COMPACTOR CONTROL PANEL	9	RP/A	7	20	1	3	12	3/4"	120	1		1
3	COMPACTOR CONTROL PANEL	9	RP/A	9	20	1	3	12	3/4"	120	1		1
4	COMPACTOR CONTROL PANEL (FUTURE)	9	RP/A	11	20	1	3	12	3/4"	120	1		1
5	COMPACTOR CONTROL PANEL (FUTURE)	9	RP/A	13	20	1	3	12	3/4"	120	1		1
6	EWH-1	2	RP/A	37,39	30	2	4	10	3/4"	208	1	3.0KW	1,2
7	VENDING MACHINE	4	RP/A	27	20	1	3	12	3/4"	120	1		
8	VENDING MACHINE	4	RP/A	29	20	1	3	12	3/4"	120	1		
9	VENDING MACHINE	4	RP/A	31	20	1	3	12	3/4"	120	1		
10	REFRIGERATOR	4	RP/A	23	20	1	3	12	3/4"	120	1		
11	MICROWAVE	4	RP/A	25	20	1	3	12	3/4"	120	1		
12	TEMPERATURE CONTROL PANEL	11	RP/A	22	20	1	3	12	3/4"	120	1		1
13	WH-1	11	RP/A	16,18,20	20	3	4	12	3/4"	208	3	4.5KW	1
14	BOILER	11	MSB-1	-	4	- SEE ONE	LINE DIAG	GRAM —	-	480	3	300KW	1,2
15	HAZARDOUS MATERIAL STORAGE	-	RP/A	43,45	50	2	2 1	8 10	3/4"	208	1	-	2
16	HAZARDOUS MATERIAL STORAGE	-	RP/A	47,49	50	2	2 1	8 10	3/4"	208	1	-	2
17	DOCK LEVELER	8	LP/A	44,46,48	20	3	4	12	3/4"	480	3	-	3
18	DOCK VEHICLE RESTRAINT	8	RP/A	46	20	3	3	12	3/4"	120	1	-	1
19	DOCK LEVELER	8	LP/A	44,46,48	20	3	4	12	3/4"	480	3	-	3
20	DOCK VEHICLE RESTRAINT	8	RP/A	46	20	1	3	12	3/4"	120	1	-	1
21	GAS MOTOR CONTROL PANEL	11	RP/A	22	20	1	3	12	3/4"	120	1	-	1
FA	FIRE ALARM PANEL	-	RP/A	44	20	1	3	12	3/4"	120	1	-	1

SPECIAL PURPOSE OUTLET SCHEDULE NOTES:

- 1. EC TO COORDINATE EXACT REQUIREMENTS WITH MANUFACTURER. 2. EC TO PROVIDE DISCONNECT.
- 3. FOR INSTALLATION SEE DETAIL 1/E401, 2/E401, 3/E401. CONFIRM EXACT INSTALLATION DETAILS WITH SHOP DRAWINGS AND ACTUAL EQUIPMENT PURCHASED FOR PROJECT.

				LIG	SHTING FIXTURE SCH	IEDULE						
		REFERENCED	PECIFICATIONS SECTIONS FOR ADDITIONAL INFORMA BY THE COLUMN TITLED "OPTIONS/ACCESSORIES". I MANUFACTURERS MUST MEET THE PHOTOMETRIC PI	MANUFACTURERS LISTED AS ACCEP					RIES			
		ABBREVIATI	ONS: DW = DRY WALL ES = EXPOSED STRUCTURE LG = LAY-IN GRID		R = RECESS V S = SURFACE W = WALL MOUNTED	= VARIES						
DES		LAMP DATA	DESCRIPTION	LIGHTING	G FIXTURE	VOLT	MOUNT	CEILING	FIXTURE	OPTIONS/ ACCESSORIES	ACCEPTABLE MANUFACTURERS	SEE NOTE
DES	#	TYPE	DESCRIPTION	MANUFACTURER	CATALOG SERIES	VOLI	WOONT	TYPE	DEPTH	OPTIONS/ ACCESSORIES	ACCEPTABLE MANUFACTURERS	SEENOTE
A	6	F32T8	HIGH BAY FLUORESCENT	COOPER	2HB-632-MPC6	277	Р	ES			LITHONIA, DAYBRITE, LSI	
В	2	F32T8	INDUSTRIAL STRIPS	COOPER	J8-R-232-TBW	277	Р	ES			LITHONIA, DAYBRITE, LSI	
С	2	F32T8	VAPORTIGHT FLUORESCENT	COOPER	-	277	S	ES			LITHONIA, DAYBRITE, LSI	
D	2	F32T8	BATHROOM VANITY FLUORESCENT	COOPER	BAU-EB	277	S	ES			LITHONIA, DAYBRITE, LSI	
G	1	320W PSMH	HID HIGHBAY	COOPER	MPLX-PD-FC3-FH-1	277	₽	ES			LITHONIA, DAYBRITE, LSI	
Н	2	F32T8	EXPLOSION PROOF LINEAR	LDPI	380-T8-2L-4-277	277	S	ES				
К	1	200W A21	-	-	-	277	S	ES				
X1	2	12W MR16	EXIT SIGN WITH BATTERY BACK	EMERGI-LITE	BBSVX24NRDA2MK	277	W	ES			COOPER, LITHONIA, DAYBRITE	
X2	2	12W MR16	SOLVENT EXIT SIGN WITH BATTERY BACK	COOPER	HZX21	277	W	ES			EMERGI-LITE	
Х3	2	20W MR16	REMOTE HEADS	EMERGI-LITE	EF39-MD	277	W	ES			COOPER, LITHONIA, DAYBRITE	
EBU	2	20W MR16	EMERGENCY BATTERY UNIT	EMERGI-LITE	B12SV24N-2MW-DA	277	W	ES			COOPER, LITHONIA, DAYBRITE	


LIGHTING FIXTURE SCHEDULE NOTES:


CABINET DESIGN	ATION: LCP/A		
DELAY#	ODOUIT CONTROLLED	CONTROL	LED BY
RELAY#	CIRCUIT CONTROLLED	SWITCH STATION	SWITCH DES
1	LP/A-9		
2	LP/A-11		
3	LP/A-13	PHOTOCELL	PHOTOCELL
4	LP/A-15	PHOTOCELL	PHOTOCELL
5	LP/A-17	PHOTOCELL	PHOTOCELL
6	LP/A-19	PHOTOCELL	PHOTOCELL
7	LP/A-21	PHOTOCELL	PHOTOCELL
8	LP/A-3	A,B,C	а


LOW VOLTAGE RELAY CABINET SCHEDULE NOTES: 1. SEE LIGHTING CONTROL SCHEMATIC DETAIL 2/E500 FOR FURTHER REQUIREMENTS.

DESIGNATION	LOCATION	SWITCH	CIRCUITS CONTROLLED	RELAY CABINET	SEE NOTE
А	8	а	LP/A-3	LCP/A	1
В	8	а	LP/A-3	LCP/A	1
С	8	а	LP/A-3	LCP/A	1


1. PROVIDE WEATHER-PROOF ENCLOSURE FOR OVER RIDE SWITCH

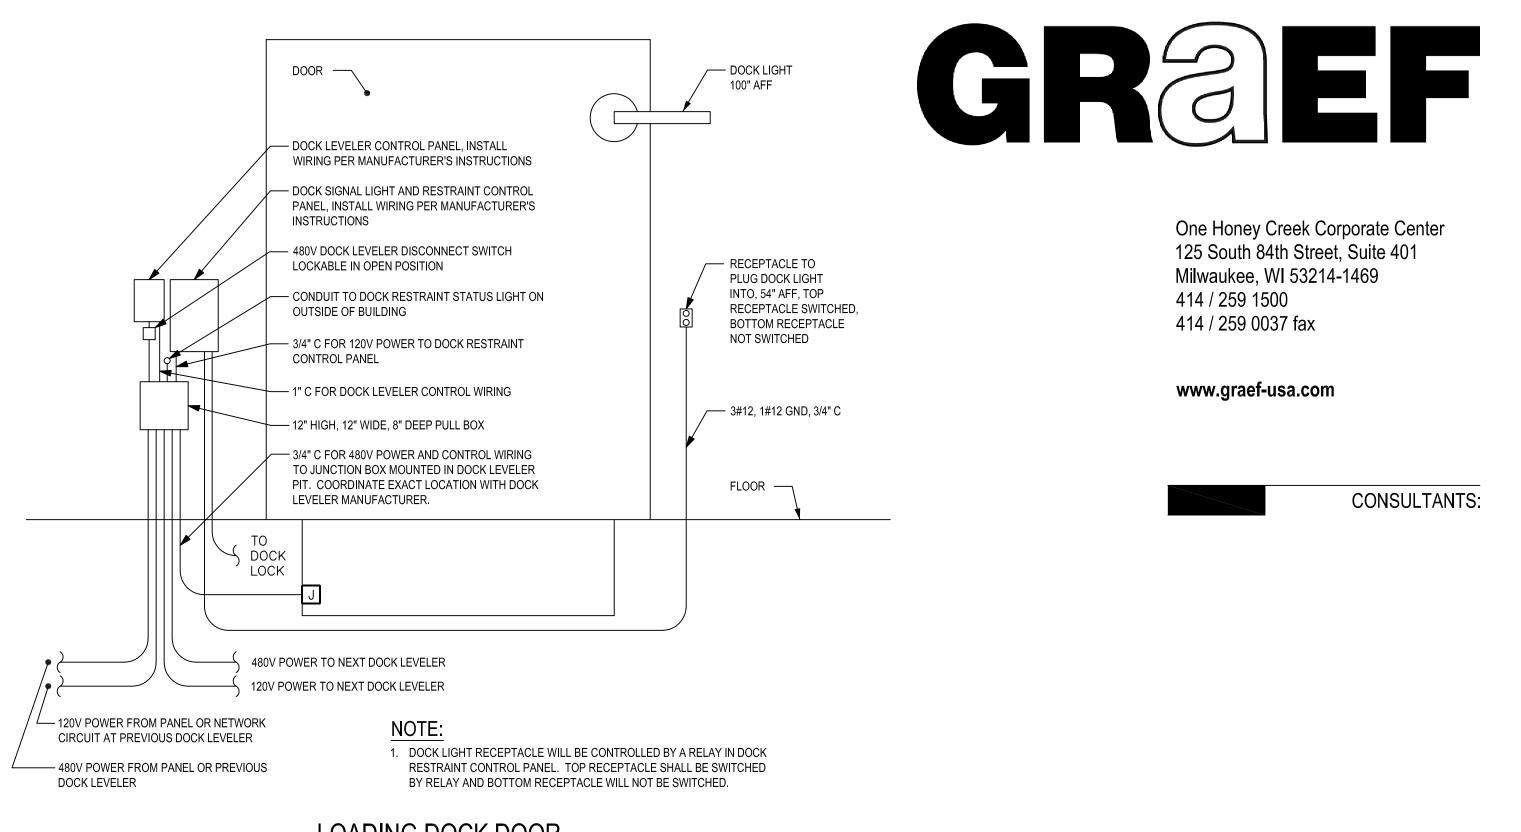

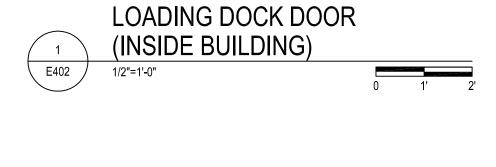

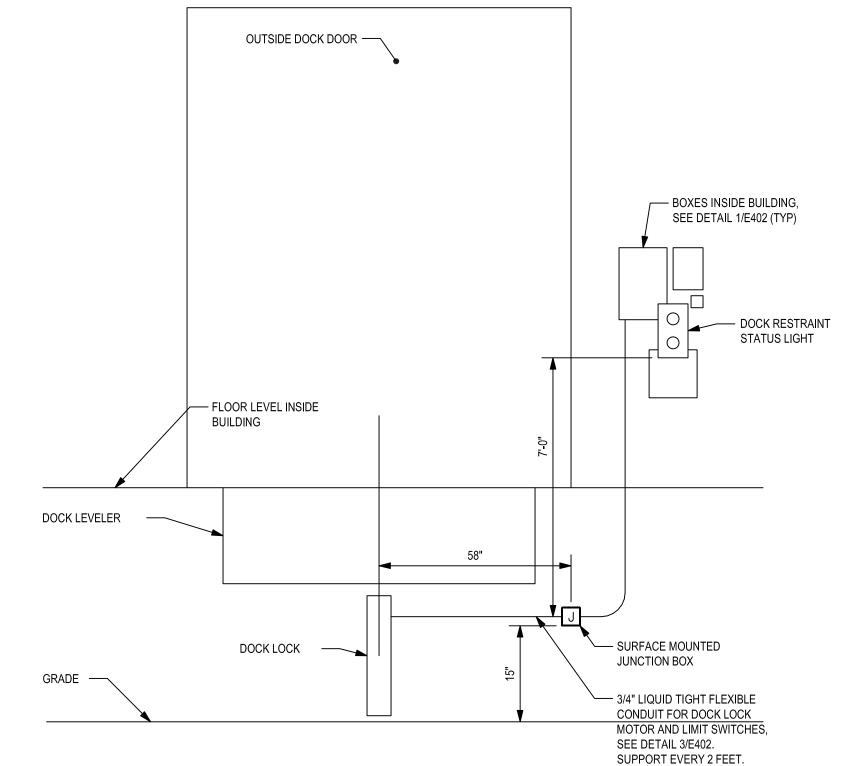



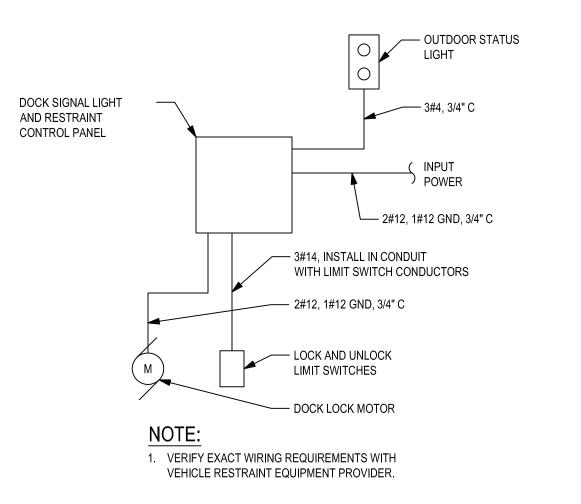

VEHICLE RESTRAINT

PROJECT INFORMATION:

125 South 84th Street, Suite 401

CONSULTANTS:

PROJECT TITLE:

ISSUE:

Milwaukee, WI 53214-1469

414 / 259 0037 fax

www.graef-usa.com

DANE COUNTY

WASTE FACILITY

RODEFELD LANDFILL


WASTE TRANSFER STATION AND HOUSEHOLD HAZARDOUS

PROJECT NUMBER: 2009-0328.00 DATE: 05-11-2010 CHECKED BY:

APPROVED BY: JHK SCALE: AS NOTED

SHEET TITLE:

ELECTRICAL SCHEDULES

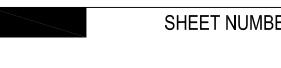



PA	NELBOARD SCI	HEDU	JLE:	_LF	P/A (TU	ΙB	<u>-1)</u>)					
PHAS SINTE	SE/WIRE: 3P/4W SERVICE ENTRANCE LABEL RRUPTING RATING: .000 AMPS SYMMETRICAL SERIES RATED	MAIN TYF LUGS SUB-F SHUN	ONLY EED (D	CO	NTAC ⁻ EED TH	FOR IRU	3	⊠ □ GR	COPP ALUM 200% OUND STAN	ER INUM NEUTR ING: DARD (AL NON-IN	SULATE	X SURFACE☐ FLUSHENCLOSURE:X NEMA 1	
CCT #	LOAD DESCRIPTION	V A	A/PHAS	E C	TRIP				TRIP	A	/A/PHAS	SE C	LOAD DESCRIPTION	CCT #
1	LIGHTING	1,500			20/1	1	Y	2	30/3	-			MOTOR #6	2
3	LIGHTING		1,980		20/1	3		4	Х		-		-	4
5	LIGHTING			240	20/1	5		6	Х			-	-	6
7	LIGHTING	1,260			20/1	7	T	8	30/3	-			MOTOR #7	8
9	LIGHTING		2,275		20/1	9		10	Х		-		-	10
11	LIGHTING			2,275	20/1	11		12	Х			-	-	12
13	LIGHTING	216			20/1	13	Ī	14	20/3	-			MOTOR #10	14
15	LIGHTING		3,185		20/1	15		16	Х		-		-	16
17	LIGHTING			1,820	20/1	17	Ĭ	18	Х			-	-	18
19	LIGHTING	2,275			20/1	19	Ħ	20	20/3	-			MOTOR #11	20
21	SPARE		-		20/1	21		22	Х		-		-	22
23	SPARE			-	20/1	23		24	Х			-	-	24
25	SPARE	-			20/1	25	T	26	20/3 HACR	-			MOTOR #12	26
27	SPARE		-		20/1	27		28	Х		-		-	28
29	SPARE			-	20/1	29	Ĭ	30	X/1			-	-	30
31	SPARE	-			20/1	31	$\ $	32	20/1	-			SPARE	32
33	SPARE		-		20/1	33		34	20/1		-		SPARE	34
35	SPARE			-	20/1	35		36	20/1			-	SPARE	36
37	SPARE	_			20/1	37	Ħ	38	20/3 HACR	-			MOTOR #14	38
39	SPARE		-		20/1	39	\dagger	40	T		-		-	40
41	SPARE			-	20/1	41	ľ	42	Х			-	-	42
		A	-		В		<u>.</u>	. ~		С	-	•	TOTAL CONNECTED:	-
		<u> </u>								•			TOTAL DEMAND:	-
													ABBREVIATIONS: HB HANDLE-BLOCKING DEVICE GFCI GROUND FAULT CIRCUIT INTERRUPTI HACR HEATING AND AIR-CONDITIONING RA	

PA	NELBOARD SCHEDULE NOTES:
1.	PROVIDE HACR CIRCUIT BREAKERS FOR CIRCUITS 26,28,30 AND 38,40,42.

PHAS SINTE	TAGE: 480/277 SE/WIRE: 3P/4W SERVICE ENTRANCE LABEL RRUPTING RATING: 1,000 AMPS SYMMETRICAL SERIES RATED	MAIN TYF	ONLY EED (C	CO	NTAC [*] EED TH	TOR HRU	GF	COPI ALUM 200% ROUNE STAM	PER MINUM NEUTR DING:	AL NON-IN		MOUNTING: SURFACE FLUSH ENCLOSURE: NEMA 1	
CCT #	LOAD DESCRIPTION	V A	/A/PHAS	SE C	TRIP		•	TRIF	A	/A/PHAS	ЕС	LOAD DESCRIPTION	CO
43	MOTOR #19	443			20/3 HACR	43	YY 4	20/3	1024			SPO #17, 19	4
45	-		443		Х	45	1 4	5 X		1024		-	4
47	-			443	Х	47	4	З			1024	-	4
49	MOTOR #20	443			20/3 HACR	49	5	20/1	-			SPARE	ţ
51	-		443		х	51	T 5	20/3		256		MOTOR #28	,
53	-			443	Х	53	\prod_{5}	4 X			256	-	;
55	MOTOR #21	443			20/3 HACR	55	5	3 X	256			-	
57	-		443		Х	57	5	3 20/3		256		MOTOR #29	;
59	-			443	Х	59	6	X			256	-	
61	MOTOR #22	443			20/3 HACR	61	6	2 X	256			-	(
63	-		443		Х	63	6	4				SPACE	
65	-			443	Х	65	6	6				SPACE	
67	MOTOR #24	832			20/3 HACR	67	\prod_{6}	3				SPACE	
69	-		832		Х	69	7	0				SPACE	
71	-			832	Х	71	7	2				SPACE	
73	MOTOR #25	832			20/3 HACR	73	7	4				SPACE	
75	-		832		Х	75	7	6				SPACE	
77	-			832	Х	77	7	3				SPACE	
79	SPACE					79	8					SPACE	,
81	SPACE					81	8	2				SPACE	;
83	SPACE					83	8	4				SPACE	
		A	25,270		В	27	,459		С	24,354		TOTAL CONNECTED: 77	7,083\
					-				•			TOTAL DEMAND: 1	101.3


PANELBOARD SCHEDULE NOTES:

1. PROVIDE HACR CIRCUIT BREAKERS FOR CIRCUITS 43 THRU 77.

PHAS SINTE	TAGE: 208/120 SE/WIRE: 3P/4W SERVICE ENTRANCE LABEL RRUPTING RATING: .000 AMPS SYMMETRICAL SERIES RATED	MAIN TYP \(\textstyle \textstyle 2 \) \(\textstyle \textstyle 1 \) \(\tex	25 ONLY EED (D	CO	NTACTED TH	ΓOR IRU	0	X 	COPP ALUM 200% DUND STAN	ER INUM NEUTR ING: DARD (I	5 AL NON-INS ISULATI	SULATE	X SURFACE☐ FLUSHENCLOSURE:X NEMA 1	
CCT #	LOAD DESCRIPTION	A	A/PHAS B	E C	TRIP				TRIP	V A	A/PHAS B	E C	LOAD DESCRIPTION	CC #
1	RECEPTACLES	720			20/1	1		2	30/1	840			MOTOR #8	2
3	RECEPTACLES		540		20/1	3	\prod	4	35/2 HACR		2,288		MOTOR #9	4
5	SPO #1			600	20/1	5	$\ $	6	Х			2,288	-	6
7	SPO #2	600			20/1	7	\prod	8 (20/1	114			MOTOR #15	8
9	SPO #3		600		20/1	9	\prod	10	20/1		114		MOTOR #16	10
11	SPO #4			600	20/1	11		12	20/1			114	MOTOR #17	12
13	SPO #5	600			20/1	13		14	20/1	114			MOTOR #18	14
15	RECEPTACLES		540		20/1	15	Ш	16	20/3		1,500		SPO #13	16
17	RECEPTACLES			540	20/1	17		18	20/1			1,500	-	18
19	RECEPTACLES	360			20/1	19		20	20/1	1,500			-	20
21	RECEPTACLES		900		20/1	21	П	22	20/1		600		SPO #12	22
23	SPO #10			1,200	20/1	23		24	20/1			ı	RECEPTACLES	24
25	SPO #11	1,200			20/1	25		26	20/1	696			MOTOR #23	26
27	SPO #7		1,200		20/1	27	Ш	28	20/1 HACR		1,176		MOTOR #13	28
29	SPO #8			1,200	20/1	29		30	20/1 HACR			696	MOTOR #26	30
31	SPO #9	1,200			20/1	31	\prod	32	20/2 HACR	130			MOTOR #27	32
33	RECEPTACLES		1,080		20/1	33	$\ $	34	Х		130		-	34
35	RECEPTACLES			180	20/1	35		36	20/1			-	SPARE	36
37	SPO 36	1,500			30/2	37		38	20/1	-			SPARE	38
39	-		1,500		Х	39		40	20/1		-		SPARE	40
41	SPARE			-	20/1	41		42	20/1			-	SPARE	42
		A	-		В	_~_	_	_~_		С	-		TOTAL CONNECTED:	
		•											TOTAL DEMAND: ABBREVIATIONS: HB HANDLE-BLOCKING DEVICE GFCI GROUND FAULT CIRCUIT INTERRUPTER	2


PANELBOARD SCHEDULE NOTES:

1. PROVIDE HACR CIRCUIT BREAKERS FOR CIRCUITS 4,6,28,30,32,34.

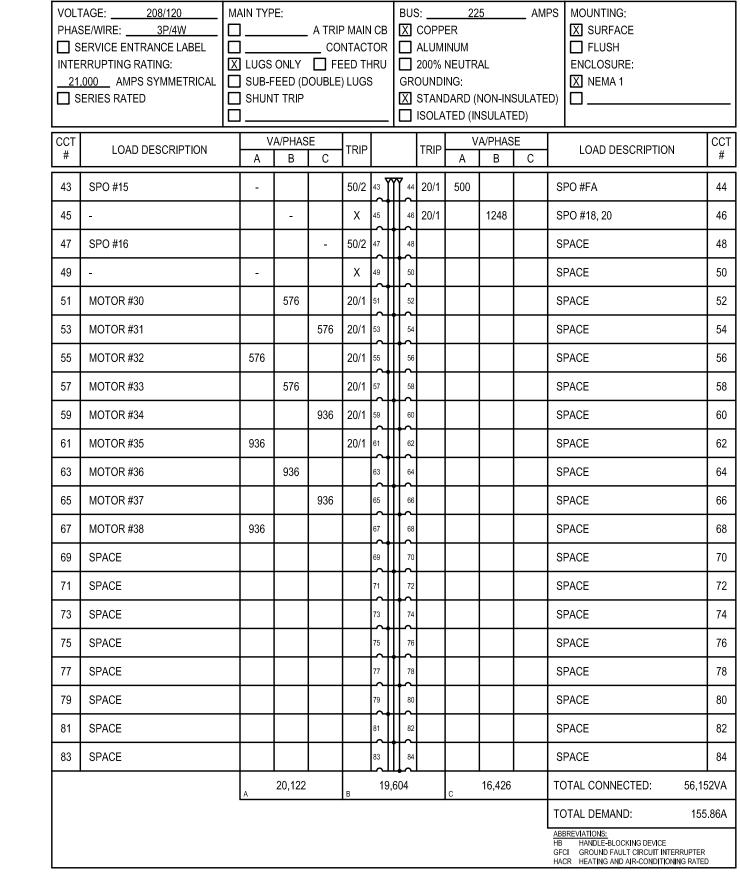

PANELBOARD SCHEDULE: RP/A (TUB-2)

PANELBOARD SCHEDULE NOTES:

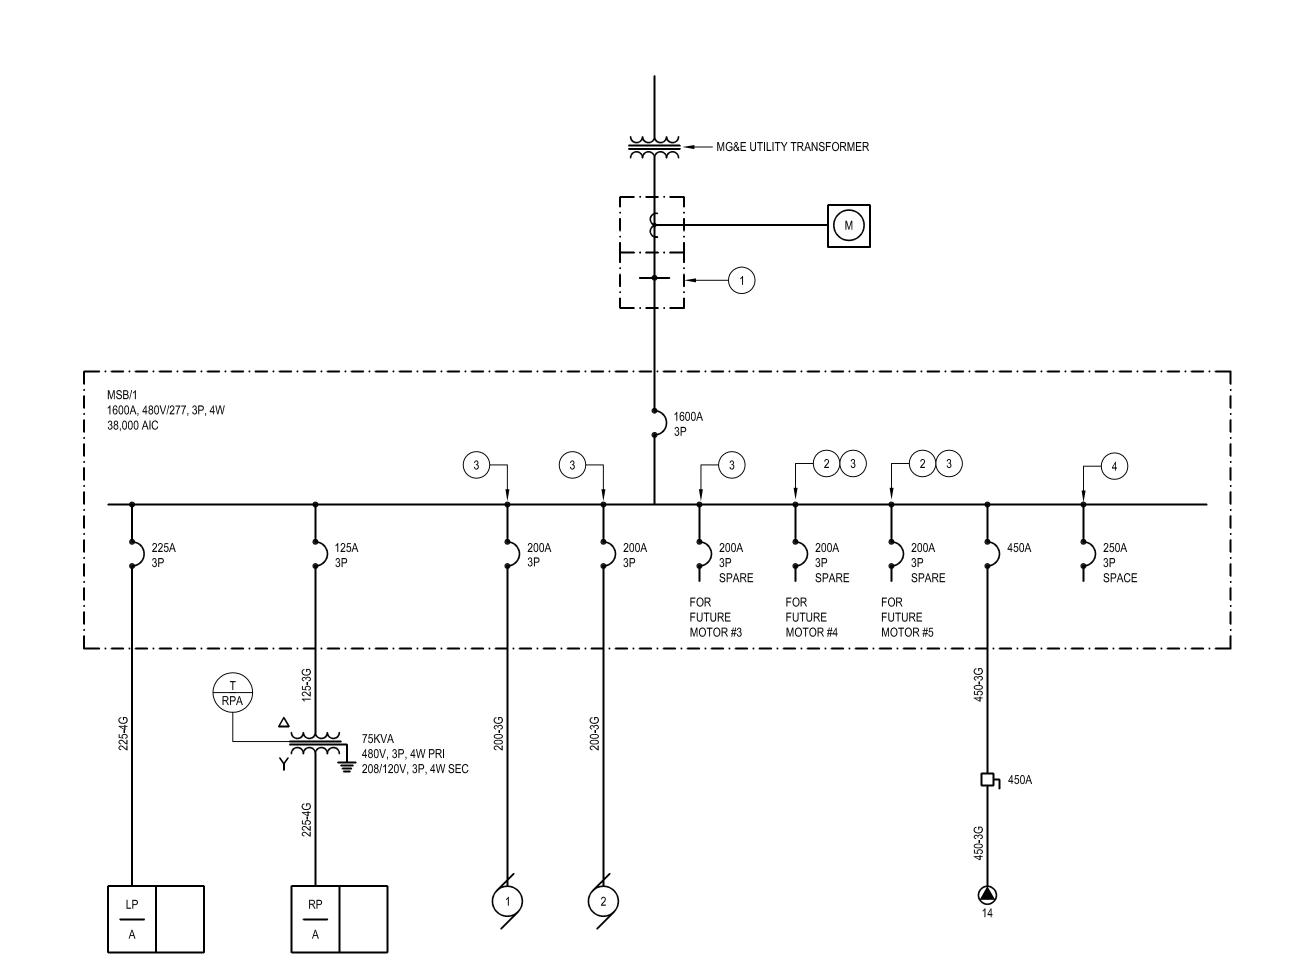


ONE LINE DIAGRAM NOTES:

- 1 EC TO PROVIDE 1,600A, 480VOLT, 3-PHASE, 4-WIRE TRANSOCKET WITH METER SOCKET. EC TO COORDINATE WITH UTILITY FOR ACCEPTABLE MANUFACTURES FOR EXACT REQUIREMENTS.
- 2 EC TO PROVIDE 200A, 3-POLE, SPACE CIRCUIT BREAKERS FOR FUTURE COMPACTORS
- 3 EC TO PROVIDE INVERSE TIME BREAKER FOR COMPACTORS.
- EC TO PROVIDE SPACES FOR (5) ADDITIONAL 250A 3P BREAKERS

	FEE	DER SCHE	DULE	
FEEDER	CONDUCTOR	SIZE (kcmil)	CONDU	JIT SIZE
AMPACITY	PH AND N	GRD	(3) AND (3G)	(4) AND (4G)
50	#8	#10	3/4"	1"
70	#4	#8	1-1/4"	1-1/4"
80	#4	#8	1-1/4"	1-1/4"
100	#3	#8	1-1/4"	1-1/4"
110	#2	#6	1-1/4"	1-1/2"
125	#1	#6	1-1/2"	2"
150	#1/0	#6	1-1/2"	2"
175	#2/0	#6	2"	2"
200	#3/0	#6	2"	2-1/2"
225	#4/0	#4	2"	2-1/2"
250	#250	#4	2-1/2"	3"
300	#350	#4	3"	3"
350	#500	#3	3"	3-1/2"
380	#500	#3	3"	3-1/2"
400	(2) #3/0	(2) #3	(2) 2"	(2) 2-1/2"
450	(2) #4/0	(2) #2	(2) 2"	(2) 2-1/2"
500	(2) #250	(2) #2	(2) 2-1/2"	(2) 3"
600	(2) #350	(2) #1	(2) 3"	(2) 3"
700	(2) #500	(2) #1/0	(2) 3"	(2) 3-1/2"
800	(2) #600	(2) #1/0	(2) 3-1/2"	(2) 4"
1000	(3) #400	(3) #2/0	(3) 3"	(3) 3-1/2"
1200	(3) 600	(3) #3/0	(3) 3-1/2"	(3) 4"
1600	(4) 600	(4) #4/0	(4) 3-1/2"	(4) 4"
2000	(5) 600	(5) #250	(5) 3-1/2"	(5) 4"

GENERAL NOTES:

- ABOVE FEEDER SCHEDULE IS SCHEDULE OF TYPICAL FEEDERS AND SOME SIZES MAY NOT BE UTILIZED.
- ALL CONDUCTOR AMPACITIES ARE BASED ON TABLE 310-16 OF NEC FOR COPPER CONDUCTOR TYPE THW / THWN.
- FEEDER SIZES SHOWN ON RISER DIAGRAM INDICATE FEEDER AMPACITIES AND DO NOT NECESSARILY CORRESPOND TO CIRCUIT BREAKER AMPACITIES. CERTAIN FEEDERS MAY BE SIZED FOR DERATING FACTORS REQUIRED BY CODE AND / OR ARE OVERSIZED FOR VOLTAGE DROP.

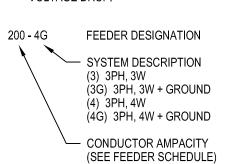



One Honey Creek Corporate Center 125 South 84th Street, Suite 401 Milwaukee, WI 53214-1469 414 / 259 1500 414 / 259 0037 fax

www.graef-usa.com

CONSULTANTS:

PROJECT TITLE:

DANE COUNTY
WASTE TRANSFER STATION
AND HOUSEHOLD HAZARDOUS
WASTE FACILITY
RODEFELD LANDFILL

ISSUE:

PROJECT INFORMATION:

PROJECT NUMBER: 2009-0328.00
DATE: 05-11-2010

DATE: 05-11

DRAWN BY: JAH

CHECKED BY: AAS

APPROVED BY: JHK


SCALE: AS NOTED

SHEET TITLE:

ONE-LINE DIAGRAM

ELECTRICAL SCHEDULES &



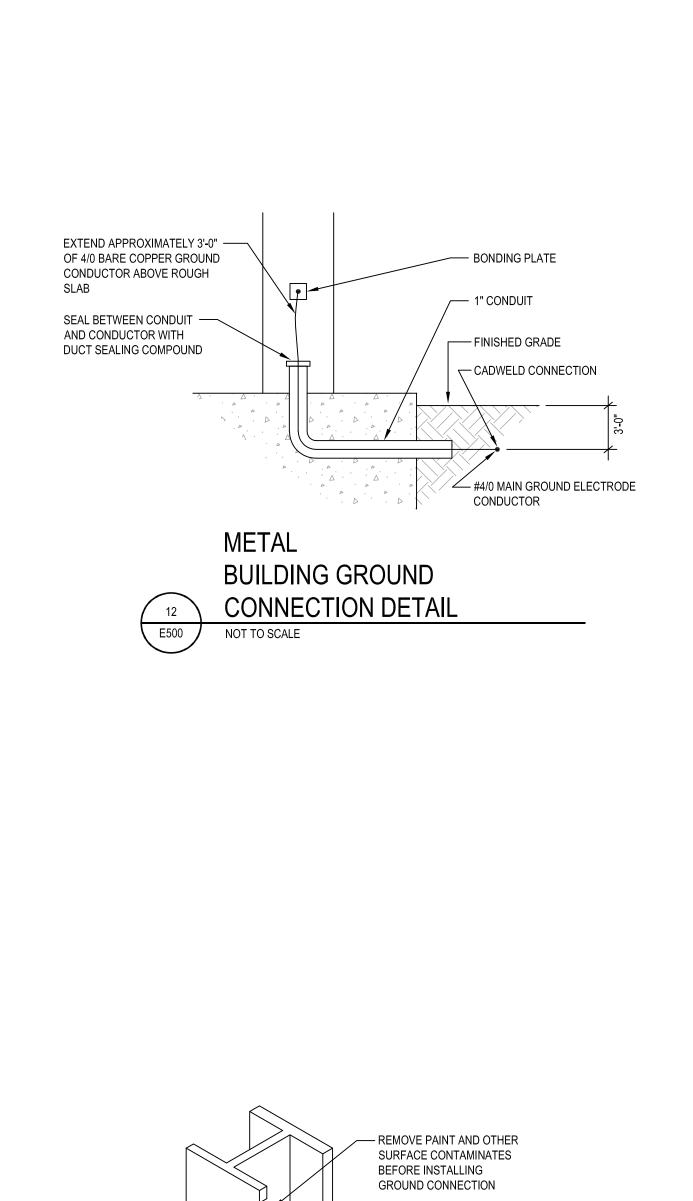


— EXOTHERMIC WELD TO

GROUND

NOT TO SCALE

CONNECTION DETAIL

STRUCTURAL STEEL COLUMN

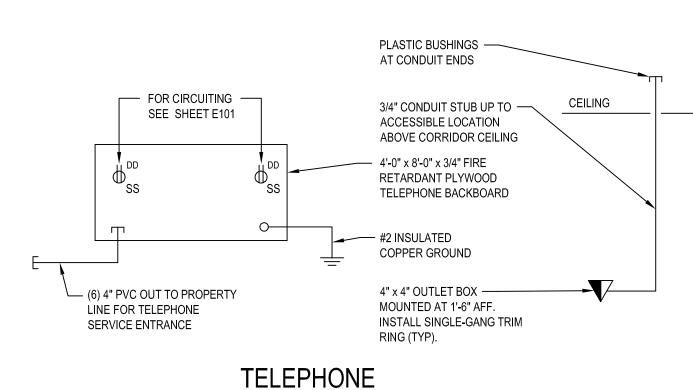

SERVICE RISER DIAGRAM

CELL AIR RETURN DUCT

— ACCESS PANEL BY

- FLEXIBLE CONDUIT

JUNCTION BOX

ON FIXED WALL

HVAC CONTRACTOR SHALL CUT HOLE —

IN ACCESS PANEL AS DIRECTED BY EC.

JUNCTION BOX, AND FACE OF ACCESS

EC SHALL PROVIDE CLOSED CELL,

NEOPRENE GASKET BETWEEN

MOUNTED SMOKE

DETECTOR DETAIL

NOT TO SCALE

SURFACE

ELEVATION OF DUCT

FROM WITHIN CHASE

HVAC CONTRACTOR

JUNCTION BOX MOUNTED

TO DUCT ACCESS PANEL

- SMOKE


DETECTOR


MOUNTED IN DUCT


SECTION

THROUGH DUCT


NOT TO SCALE

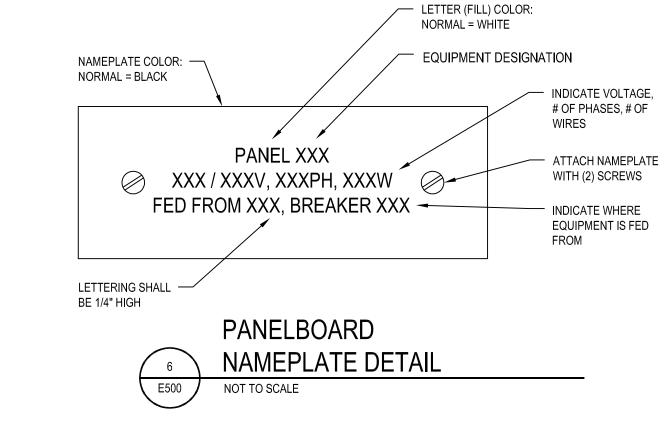


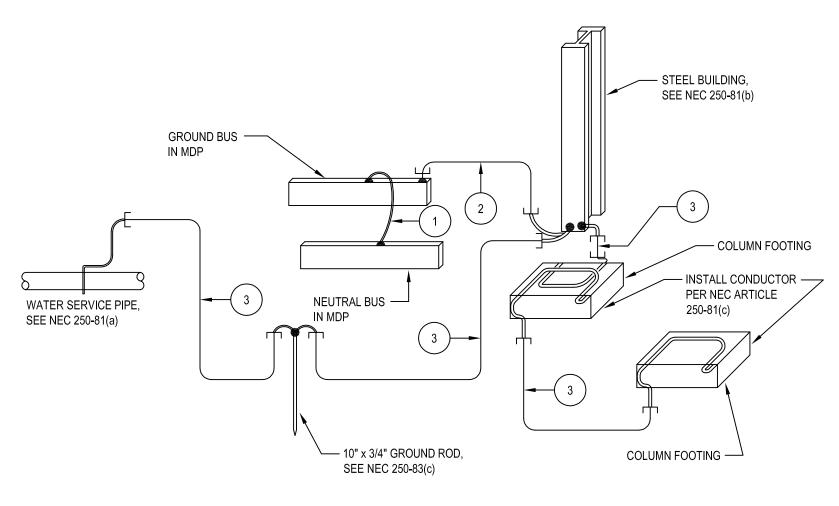


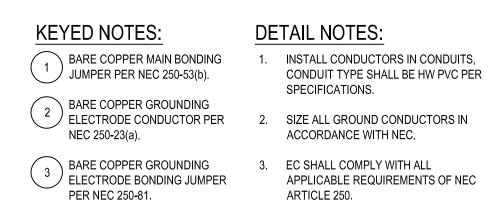




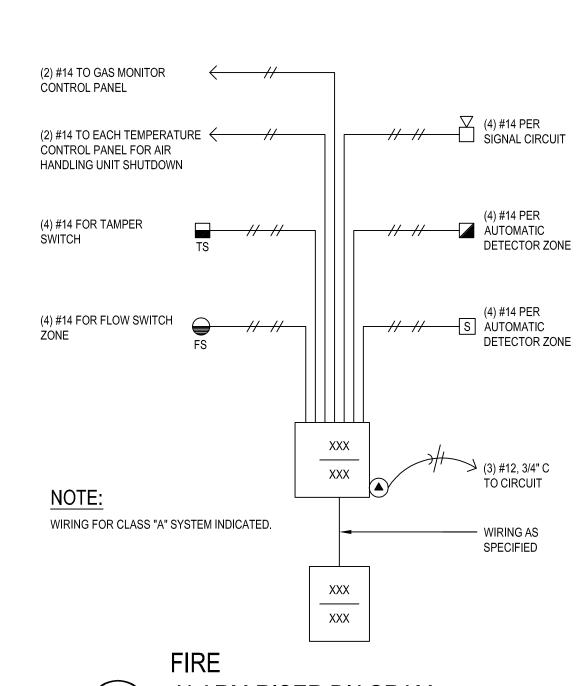

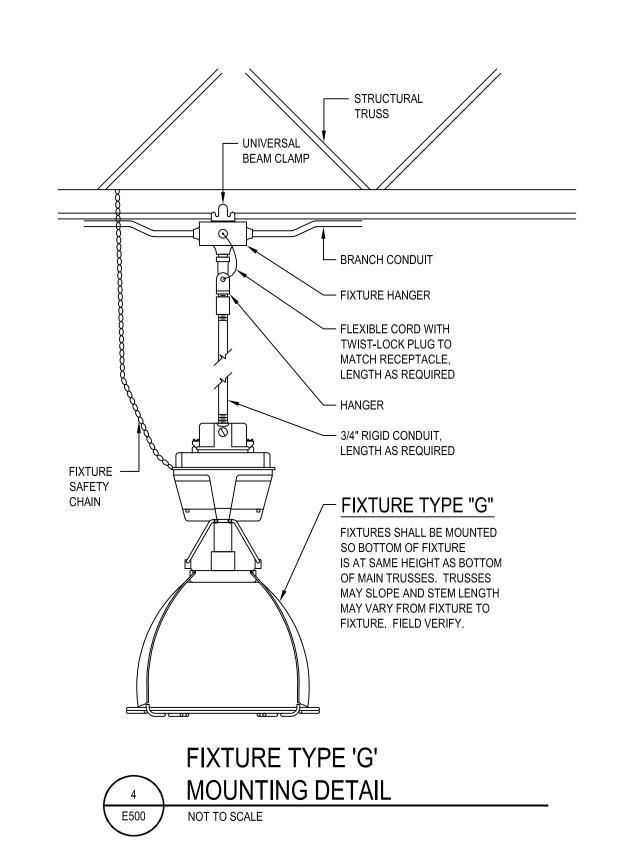

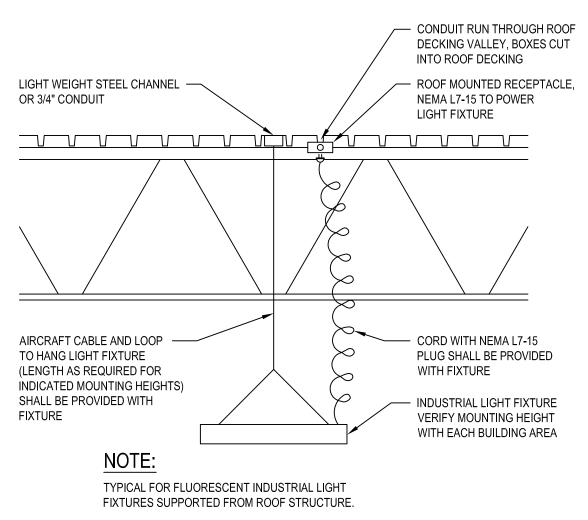



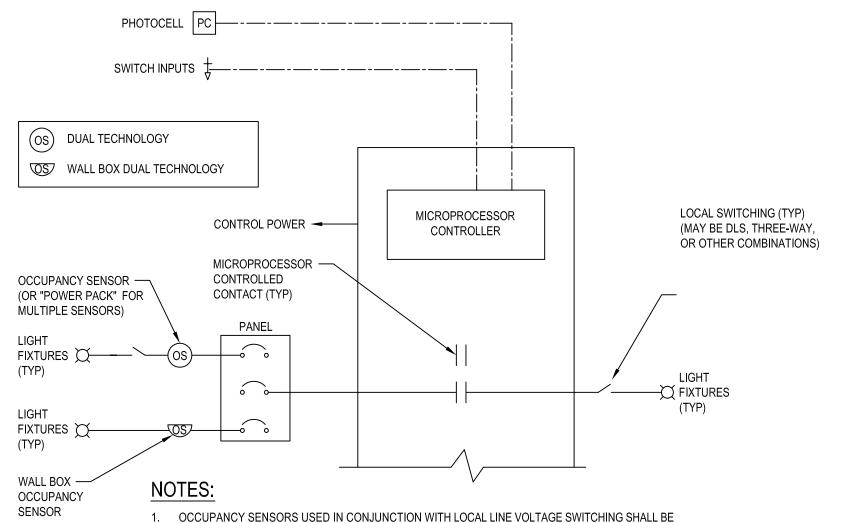

ELECTRICALLY LOCATED ON PANEL SIDE OF SWITCH, AS INDICATED IN ABOVE DIAGRAM, UOI


2. BOTH SENSORS CONTROL SAME LIGHT FIXTURES VIA COMMON "POWER PACK" IN ROOMS SHOWN WITH (2) OR MORE OCCUPANCY SENSORS, UOI.

3. WHENEVER FEASIBLE, POWER PACKS SHALL BE LOCATED IN CEILING SPACE DIRECTLY ABOVE LOCAL WALL SWITCH.

4. USE OF OCCUPANCY SENSOR SYMBOL IN ROOM INDICATES TYPE OF SENSOR TO BE USED TO CONTROL ALL LIGHTS IN SPACE. EXACT LOCATION, MOUNTING, AND CONFIGURATION OF SENSOR SHALL BE DETERMINED IN FIELD, BASED UPON MANUFACTURER'S RECOMMENDATIONS AND GUIDELINES.

5. SPECIFIC MODEL OF OCCUPANCY SENSOR SHALL BE COORDINATED WITH ROOM SIZE, LAYOUT, CEILING HEIGHT, AND MOUNTING REQUIREMENTS, SENSOR MANUFACTURER, AND CONTRACTOR. VERIFY DEVICE COLOR WITH ARCHITECT PRIOR TO ORDERING.

6. OCCUPANCY SENSOR MANUFACTURER SHALL PROVIDE HARD COPIES AND ELECTRONIC AUTOCAD DRAWINGS FILES OF LOCATION AND MODEL NUMBERS OF ALL ASSOCIATED EQUIPMENT.

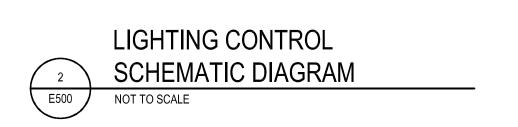

____ 277V ____ ROOM LIGHTING CIRCUIT — ROOM LIGHTING



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www.graef-usa.com

CONSULTANTS:

PROJECT TITLE:

DANE COUNTY WASTE TRANSFER STATION AND HOUSEHOLD HAZARDOUS WASTE FACILITY RODEFELD LANDFILL

ISSUE:

OCCUPANCY SENSOR -ROOM TOGGLE SWITCH SYSTEM POWER PACK

SHEET TITLE:

APPROVED BY: JHK

ELECTRICAL DETAILS

PROJECT NUMBER: 2009-0328.00

DATE:

SCALE:

CHECKED BY:

PROJECT INFORMATION:


05-11-2010

AS NOTED

SHEET NUMBER:



E500

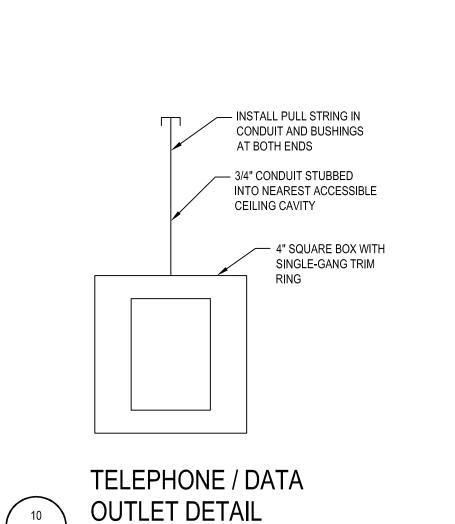

ALARM RISER DIAGRAM NOT TO SCALE



PLUMBING SYMBOLS, ABBREVIATIONS & SCHEDULES

NOTE: NOT ALL SYMBOLS AND ABBREVIATIONS INDICATED HERE ARE USED IN THE DRAWINGS AND MAY NOT APPLY TO THIS PROJECT. ADDITIONAL SYMBOLS MAY BE INDICATED IN THE DRAWINGS.

PLUMBING ABBREVIATIONS

		PLUMBING AD	DKEVIA		
A AFF	-	AIR ABOVE FINISHED FLOOR	L LBS.	-	LAVATORY POUNDS
AFG	-	ABOVE FINISHED GRADE	LB/HR	-	POUNDS PER HOUR
ALT AP	-	ALTERNATE ACCESS PANEL	MAX	-	MAXIMUM
APPROX. ARCH	-	APPROXIMATELY ARCHITECTURAL	MB MBH	-	MOP BASIN THOUSANDS OF BTU PER HOUR
٩V	-	ACID VENT	MC	-	MECHANICAL CONTRACTOR
AVG AW	-	AVERAGE ACID WASTE	MEP MER	-	MECHANICAL, ELECTRICAL AND PIPING MECHANICAL EQUIPMENT ROOM
			MEZZ	-	MEZZANINE
BFF BLDG	-	BELOW FINISHED FLOOR BUILDING	MFR MH	-	MANUFACTURER MANHOLE
ВОТ	-	BOTTOM	MIN.	-	MINIMUM
BOP BT	-	BOTTOM OF PIPE BATHTUB	MISC MTD	-	MISCELLANEOUS MOUNTED
3TU	-	BRITISH THERMAL UNITS	MTG	-	MOUNTING
BTUH BV	-	BRITISH THERMAL UNITS PER HOUR BALANCING VALVE	NA	-	NOT APPLICABLE
			NIC	-	NOT IN CONTRACT
CAP CC	-	CEILING ACCESS PANEL CAPPED CONNECTION	NO NPS	-	NUMBER NOMINAL PIPE SIZE
CFH	-	CUBIC FEET PER MINUTE	NTS	-	NOT TO SCALE
CFM CL	-	CUBIC FEET PER HOUR CENTERLINE	ОС	-	ON CENTER
CLG CLV	-	CEILING CLEAR WATER VENT	OD OFCI	-	OUTSIDE DIAMETER OWNER FURNISHED, CONTRACTOR INSTALLED
CLW	-	CLEAR WATER WASTE	OFOI	-	OWNER FURNISHED, OWNER INSTALLED
COND	-	CLEANOUT CONDUCTOR	Р	_	PUMP
CONT	-	CONTRACTOR	PC	-	PLUMBING CONTRACTOR
CTR CU	-	CENTER COPPER	PCF PD	-	POUNDS PER CUBIC FOOT PRESSURE DROP
CV	-	CHECK VALVE	PH	-	PHASE
CW CWFU	-	COLD WATER COLD WATER FIXTURE UNITS	PLBG POC	-	PLUMBING POINT OF CONNECTION
CWS	-	COLD WATER SOFT	PP	-	POLYPROPYLENE
DD	-	DRAIN DECK	PPH PRV	-	POUNDS PER HOUR PRESSURE RELIEF VALVE
DET	-	DETAIL	PSF	-	POUNDS PER SQUARE FOOT
DFU DIA	-	DRAINAGE FIXTURE UNITS DIAMETER	PSI PSIA	-	POUNDS PER SQUARE INCH POUNDS PER SQUARE INCH ABSOLUTE
DIM	-	DIMENSION	PSIG	-	POUNDS PER SQUARE INCH GAUGE
ON OS	-	DOWN DOWNSPOUT	PVC	-	POLYVINYL CHLORIDE
T	-	DRAIN TILE	RD BEC	-	ROOF DRAIN
OTR OWG.	-	DRAIN TILE RECEIVER DRAWING	REC RF	-	RECESSED ROOF
OW	-	DISH WASHER	RI PD7	-	ROUGH-IN
Ē	-	EXISTING	RPZ RV	-	REDUCED PRESSURE ZONE VALVE RELIEF VALVE
EEW ELEV	-	EMERGENCY EYEWASH ELEVATION	S	_	SLOPE
ΞM	-	EMERGENCY	SCH	-	SCHEDULE
EQUIP ES	-	EQUIPMENT EMERGENCY SHOWER	SH SHT	-	SHOWER SHEET
ĒΤ	-	EXPANSION TANK	SOG	-	SLAB ON GRADE
ETR EWC	-	EXISTING TO REMAIN ELECTRIC WATER COOLER	SPEC SQ	-	SPECIFICATION SQUARE
EWH	-	ELECTRIC WATER HEATER	SS	-	SERVICE SINK
EXST	-	EXISTING	S/S STD	-	STAINLESS STEEL STANDARD
:	-	FUTURE			
-CO	-	FLOOR CLEANOUT FLOOR DRAIN	T&P TBR	-	TEMPERATURE AND PRESSURE TO BE REMOVED
FE	-	FINISHED FLOOR ELEVATION	TD	-	TRENCH DRAIN
ELR EP	-	FLOOR FIREPROOF	TDFU TEMP	-	TOTAL DRAIN FIXTURE UNITS TEMPERATURE
PM	-	FEET PER MINUTE	TOP	-	TOP OF PIPE
PS S	-	FEET PER SECOND FLOOR SINK	TOS T STAT	-	TOP OF SLAB THERMOSTAT
-&T -T	-	FLOAT AND THERMOSTATIC FEET	TWFU TYP	-	TOTAL WATER FIXTURE UNITS TYPICAL
TG	-	FOOTING		-	
-U	-	FIXTURE UNITS	UNO	-	UNLESS OTHERWISE NOTED
3	-	GAS	V	-	VENT
GAL GC	-	GALLON GENERAL CONTRACTOR	VB VB	-	VACCUM BREAKER VALVE IN BOX
3PM	-	GALLONS PER MINUTE	VTR	-	VENT THRU ROOF
GPH	-	GALLONS PER HOUR	W	-	WASTE
HB	-	HOSE BIBB	W/	-	WITH
HD HP	-	HUB DRAIN HORSE POWER	W/O WHA	-	WITHOUT WATER HAMMER ARRESTOR
HVAC	-	HEATING, VENTILATING & AIR CONDITIONING	WCO	-	WALL CLEANOUT
HW HWFU	-	HOT WATER HOT WATER FIXTURE UNITS	WC WF	-	WATER CLOSET WASH FOUNTAIN
HWR	-	HOT WATER RETURN	WH	-	WATER HEATER
D	_	INSIDE DIAMETER	WM WSFU	-	WASHING MACHINE WATER SUPPLY FIXTURE UNITS
E	-	INVERT ELEVATION	WG	-	WATER GAUGE
N	-	INCHES	YCO	-	YARD CLEAN OUT
(0	-	KNOCK-OUT			
		PIPE FI	TTINGS		
		FLANGE			
	— <u>—</u>	UNION			————O ELBOW UP
	-	— ANCHOR			———— TEE DOWN
		PIPE GUIDE			TEE UP
	1	TEE BRANCH			PIPE CAP
		LINE CONTINUATION BREAK			———⊃≯ VALVE IN VERTICAL
	\	✓ PLUMBING FIXTURE STOPS			_
					→ → → → → DOUBLE WYE
	 	PIPELINE STRAINER			⊢
					├── │
				_	±
		DRAINS AND	CLEAN	OUT	<u>S</u>
	\oslash	FLOOR DRAIN			○——I FIXTURE WASTE TRAP
		I ELOOD SINK			L CO CLEANOUT

— CO CLEANOUT

○— FCO FLOOR CLEANOUT

FLOOR SINK

ROOF DRAIN

HUB DRAIN

PIPING SYSTEM LARELS

	PIPING SYSTI	EM LABELS		
WATER PIPII	NG SYSTEMS:	SITE PIPING SYSTEMS:	TAG	MANUFACTU
	COLD WATER	—— SAN —— SANITARY SEWER	WH-1	A.O. SMITI
	HOT WATER	ST STORM SEWER		
	HOT WATER RETURN	──── W ──── WATER LINE		
— ғ —	FIRE PROTECTION	· · · · · · · · · · · · · · · · · · ·	EXP-1	AMTROL
T	TEMPERED WATER			
WASTE AND	VENT SYSTEMS:		CP-1	BELL & GOSSETT
CWV	CLEARWATER VENT		TMV-1	LAWLER
cww	CLEARWATER WASTE			
— OD —	OVERFLOW DRAIN LINE			
st	STORM		RPBP-1	WATTS
— SSD —	SUBSOIL DRAIN LINE	NOTE: (E) PRIOR TO SYSTEM TYPE DENOTES EXISTING PIPING		
	UNDERFLOOR FOR WASTE OR SOIL, SUBSOIL, STORM & FORCE MAIN	(F) PRIOR TO SYSTEM TYPE DENOTES FUTURE PIPING	HB-1	WOODFOR
	SANITARY VENT			
—— SAN ——	WASTE OR SOIL LINE			
	DIDE VALVES AND	D SDECIAL TIES		
	PIPE VALVES ANI	D SPECIAL HES	TAG	MANUFACTU
			WC-1	KOHLER
—	ANGLE VALVE	BACKFLOW PREVENTER		BEMIS

	ANGLE VALVE		BACKFLOW PREVENTER
	BALANCING VALVE		PRESSURE GAUGE
	BALL VALVE		
— • ←	BUTTERFLY VALVE	<u> </u>	THERMOMETER
	CHECK VALVE	— НВ	HOSE BIBB AND WALL HYDRANT
<u>_</u>	DRAIN VALVE		WATER HAMMER ARRESTOR
 _ _	GAS SHUTOFF VALVE	── \\$	PRESSURE RELIEF VALVE
	GATE VALVE		

REFERENCE SYMBOLS

1 P200	DETAIL REFERENCE TOP DESIGNATES DETAIL NUMBER BOTTOM DESIGNATES SHEET NUMBER	VP 1	EQUIPMENT NAME AND NUMBE
•		1	PLAN NOTE NUMBER
1 P200	SECTION REFERENCE TOP DESIGNATES SECTION NUMBER BOTTOM DESIGNATES SHEET NUMBER	1	REVISION NUMBER
_			POINT OF CONNECTION
•	ELEVATION SYMBOL		POINT OF DISCONNECTION

WATER SUPPLY CALCULATION

USING THE FORMULA, FIND THE PRESSURE AVAILABLE FOR UNIFORM LOSS (PSI/100' OF PIPE) $A = \frac{B-(C+D+E)X100}{F}$

A. 10.4 PRESSURE AVAILABLE FOR UNIFORM LOSS (PSI/100' OF PIPE)

B. <u>50.0</u> AVAILABLE PRESSURE AT THE CONTROL VALVE. C. <u>25.0</u> PRESSURE NEEDED AT CONTROLLING FIXTURE.

D. <u>5.2</u> DIFFERENCE IN ELEVATION BETWEEN WATER METER AND CONTROLLING FIXTURE IN FEET 12 X .434 PSI/FT

E. 12.0 PRESSURE LOSS DUE TO WATER SOFTENERS, WATER TREATMENT DEVICES, INSTANTANEOUS WATER HEATERS, AND BACKFLOW PREVENTORS. CONVENTIONAL WATER HEATERS USUALLY DO NOT HAVE A PRESSURE LOSS. (EXISTING POOL FILL EQUIPM.)

F. 75 DEVELOPED LENGTH FROM WATER METER TO CONTROLLING FIXTURE

WITH PRESSURE AVAILABLE FOR UNIFORM LOSS, GO TO APPLICABLE TABLE FOR DISTRIBUTION SIZING.

PLUMBING EQUIPMENT SCHEDULE				
TAG	MANUFACTURER	MODEL NO.	REMARKS	
WH-1	A.O. SMITH	DEN-66	ELECTRIC WATER HEATER, 66 GALLON STORAGE CAPACITY, 70 DEGREE TEMPERATURE RISE (120 DEGREE DISCHARGE TEMP), 4500W/4500W DUAL ELEMENT, 25 GPH RECOVERY CAPACITY. INCLUDE INSULATION, METAL PROTECTIVE JACKET, T&P RELIEF VALVE, DRAIN VALVE.	
EXP-1	AMTROL	ST-5	STEEL EXPANSION TANK, 40 PSIG FACTORY PRE-CHARGED, EPDM DIAPHRAGM, POLYPROPYLENE LINER, 2 GALLON CAPACITY.	
CP-1	BELL & GOSSETT	SERIES 100	3/4", 1/12 HP, 120 VOLT, 1 PHASE, ALL BRONZE CIRCULATING PUMP.	
TMV-1	LAWLER	911E/F	ALL BRONZE THERMOSTATIC MIXING VLAVE W/OUTLET TEMPERATURE AT FACTORY SET POINT. NOTE: HOT WATER RETURN TEMPERATURE MUST HAVE MINIMUM 10° TEMPERATURE DECREASE FROM OUTLET TEMPERATURE.	
RPBP-1	WATTS	009	3/4" REDUCED PRESSURE ZONE BACKFLOW PREVENTOR, BRONZE BODY CONSTRUCTION, DUAL CHECK VALVE ASSEMBLY.	
HB-1	WOODFORD	MODEL 24	WALL HYDRANT WITH INTEGRAL VACUUM BREAKER, 3/4" HOSE THREAD NOZZLE AND LOOSE TEE KEY.	

		PLUMBING FIXT	URE SCHEDULE
TAG	MANUFACTURER	MODEL NO.	REMARKS
WC-1	KOHLER	WELLCOMME K-4349	VITREOUS CHINA ,FLOOR OUTLET, 1.6 GALLON MANUAL OPERATED FLUSH VALVE.
	BEMIS	1955-SSC	ENLONGATED OPEN FRONT SEAT, LESS COVER, WITH STAINLESS STEEL SELF-SUSTAINING, CHECK HINGE.
	SLOAN	"ROYAL" 111	CHROME PLATED TOP SPUD, 1.6 GALLON MANUAL OPERATED FLUSH VALVE.
L-1	KOHLER	GREENWICH K-2032	VITREOUS CHINA, 20" X 18" WALL HUNG, 4" FAUCET CENTERS, ADA COMPLIANT, COLOR WHITE.
	CHICAGO	2200-4E2805CP	MANUAL, SINGLE CONTROL FAUCET, POLISHED CHROME, WITH GRID STRAINER, CERAMIC CARTRIDGES.
	MCGUIRE	PWV8902	1-1/4" x 1-1/2" P-TRAP, BRASS, 17 GAUGE WITH CLEAN-OUT.
		2165CC	ANGLE STOPS AND SUPPLIES.
		PW2000	INSULATION KIT.
		-	PROVIDE COMMERCIAL GRADE CONCEALED ARM LAVATORY CARRIER.
SH-1	SYMMONS	SAFETYMIX 1-100	SAFETYMIX SHOWER SYSTEM WITH PRESSURE-BALABCING MIXING VALVE, LEVE HANDLE, ADJUSTABLE STOP SCREW, BRONZE BODY VALVE, INTERGRAL SERVICE STOPS & ESCUTCHEON COVER. SHOWER HEAD TO BE CHROME PLATED MOUNTE AT 6'-0" ABOVE FLOOR WITH 2.0 GPM FLOW RESTRICTOR.
S-1	KOHLER	BANNON K-6719	CAST RION, 24"x20.25" WALL HUNG SERVICE SINK, SINGLE COMPARTMENT, BLANI BACK, ACID RESISTANT FINISH & STAINLESS STEEL RIM GUARD.
	CHICAGO	897-RCF	POLISHED CHROME PLATED WALL MOUNTED SERVICE SINK FAUCET WITH INTEGRAL STOPS.
		E27	SPOUT OUTLET VACUUM BREAKER
	KOHLER	K-6673	3" ADJUSTABLE IRON TRAP WITH STRAINER, CLEANOUT AND FLOOR PLATE.
EW/SH-1	ACORN	S1310	PEDESTAL MOUNTED COMBINATION SHOWER/EYEWASH STATION, PLASTIC BOW STAY-OPEN 1/2" BALL VALVE WITH PUSH HANDLE, PLASTIC SHOWERHEAD AND 1" STAY-OPEN BALL VALVE WITH PULL ROD. 20 GPM SHOWERHEAD.

PLUMBING DRAIN AND CLEANOUT SCHEDULE				
TAG	MANUFACTURER	MODEL NO.	REMARKS	
FD-1	ZURN	Z415-B	CAST IRON BODY, ADJUSTABLE STRAINER HEAD, COMBINATION INVERTIBLE MEMBRANE CLAMP AND ADJUSTABLE COLLAR WITH NICKEL BRONZE TOP.	
TD-1	ABT DRAINS, INC. POLYDRAIN	TF-14 TRENCH DRAIN FORMING SYSTEM	CAST-IN-PLACE TRENCH DRAIN AND CATCH BASIN, PRE-MANUFACTURED FORMING INSERTS WITH TRENCH DRAIN RAILS AND TF-14 SLOTTED DUCTILE IRON GRATE (HEAVY DUTY).	
HD-1	ZURN	Z-326-DB	CAST IRON BODY, 9" INDIRECT WASTE FUNNEL WITH DOME BOTTOM STRAINE	
HD-2	ZURN	Z-415-E	CAST IRON BODY, ADJUSTABLE STRAINER HEAD, COMBINATION INVERTIBLE MEMBRANE CLAMP AND ADJUSTABLE COLLAR WITH NICKEL BRONZE TOP WITH 4" DIA FUNNEL.	
FCO	ZURN	Z1400-BP	CAST IRON BODY, ADJUSTABLE FLOOR CLEANOUT WITH NICKEL BRONZE TOP AND GAS AND WATERTIGHT ABS TAPERED BRONZE PLUG (USE IN FINISHED AREAS).	
		Z1474	CAST IRON BODY, HEAVY DUTY CLEANOUT HOUSING, WITH NICKEL BROZE TO AND INTERNAL CLEANOUT (USE IN UNFINISHED AREAS, MECHANICAL ROOMS, JANITOR CLOSETS, ETC.).	
YCO	ZURN	Z1440-BP	CAST IRON BODY FERRULE WITH BRONZE PLUG. PROVIDE WITH FROST SLEEN AND HEAVY DUTY WATER TIGHT TOP.	
WCO	ZURN	Z1468	ROUND STAINLESS STEEL WALL ACCESS COVER WITH SECURING SCREW, BRONZE RAISED HEX HEAD PLUG.	
СО	ZURN	Z1440-BP	CAST IRON BODY FERRULE WITH BRONZE PLUG.	

SHEET INDEX

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- P101 HHW FIRST/WTS LOWER LEVEL PLUMBING PLAN
- P102 HHW MEZZANINE/WTS UPPER LEVEL PLUMBING PLAN
- P300 PLUMBING ISOMETRICS P500 - PLUMBING DETAILS
- FP101 HHW FIRST/WTS LOWER LEVEL FIRE PROTECTION PLAN FP102 - HHW MEZZANINE/WTS UPPER LEVEL FIRE PROTECTION PLAN

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CONSULTANTS:

PROJECT TITLE:

DANE COUNTY WASTE TRANSFER STATION AND HOUSEHOLD HAZARDOUS WASTE FACILITY RODEFELD LANDFILL

ISSUE:

PROJECT NUMBER: 2009-0328.00

CHECKED BY: APPROVED BY: PDZ

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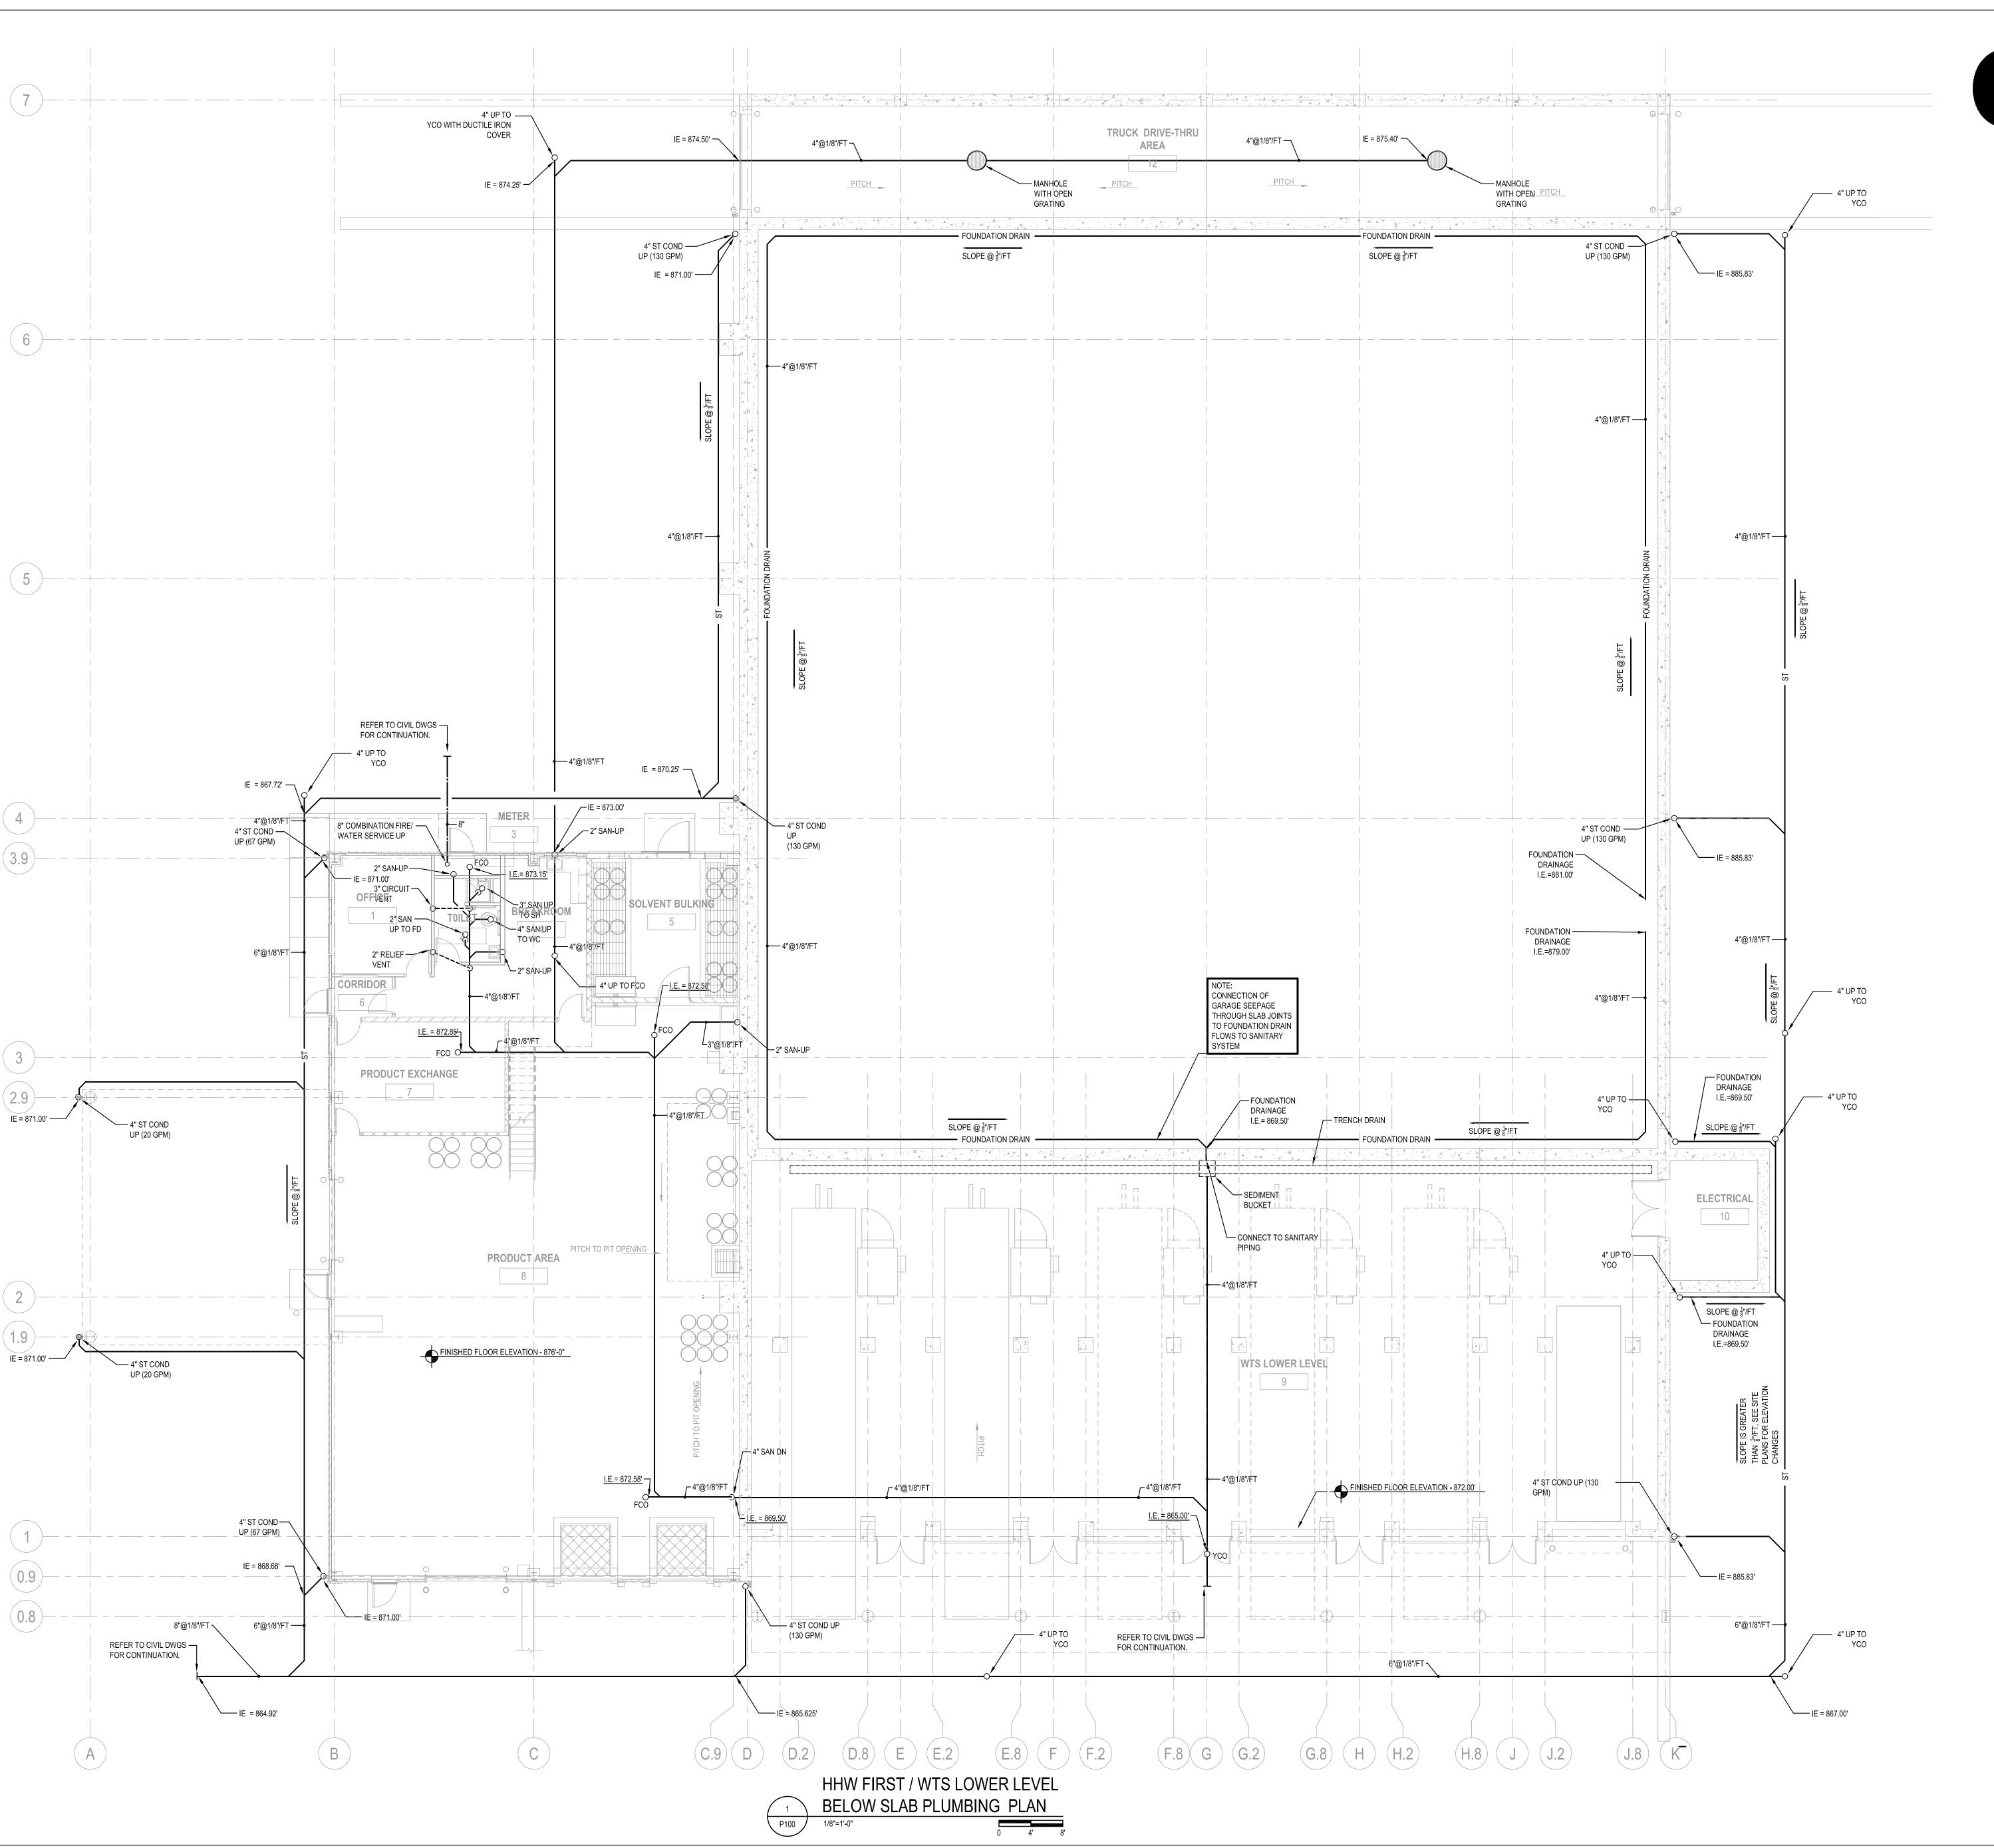
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AS NOTED

SHEET NUMBER:

PLUMBING SYMBOLS ABBREVIATIONS & SCHEDULES





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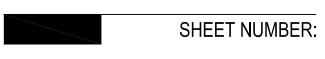
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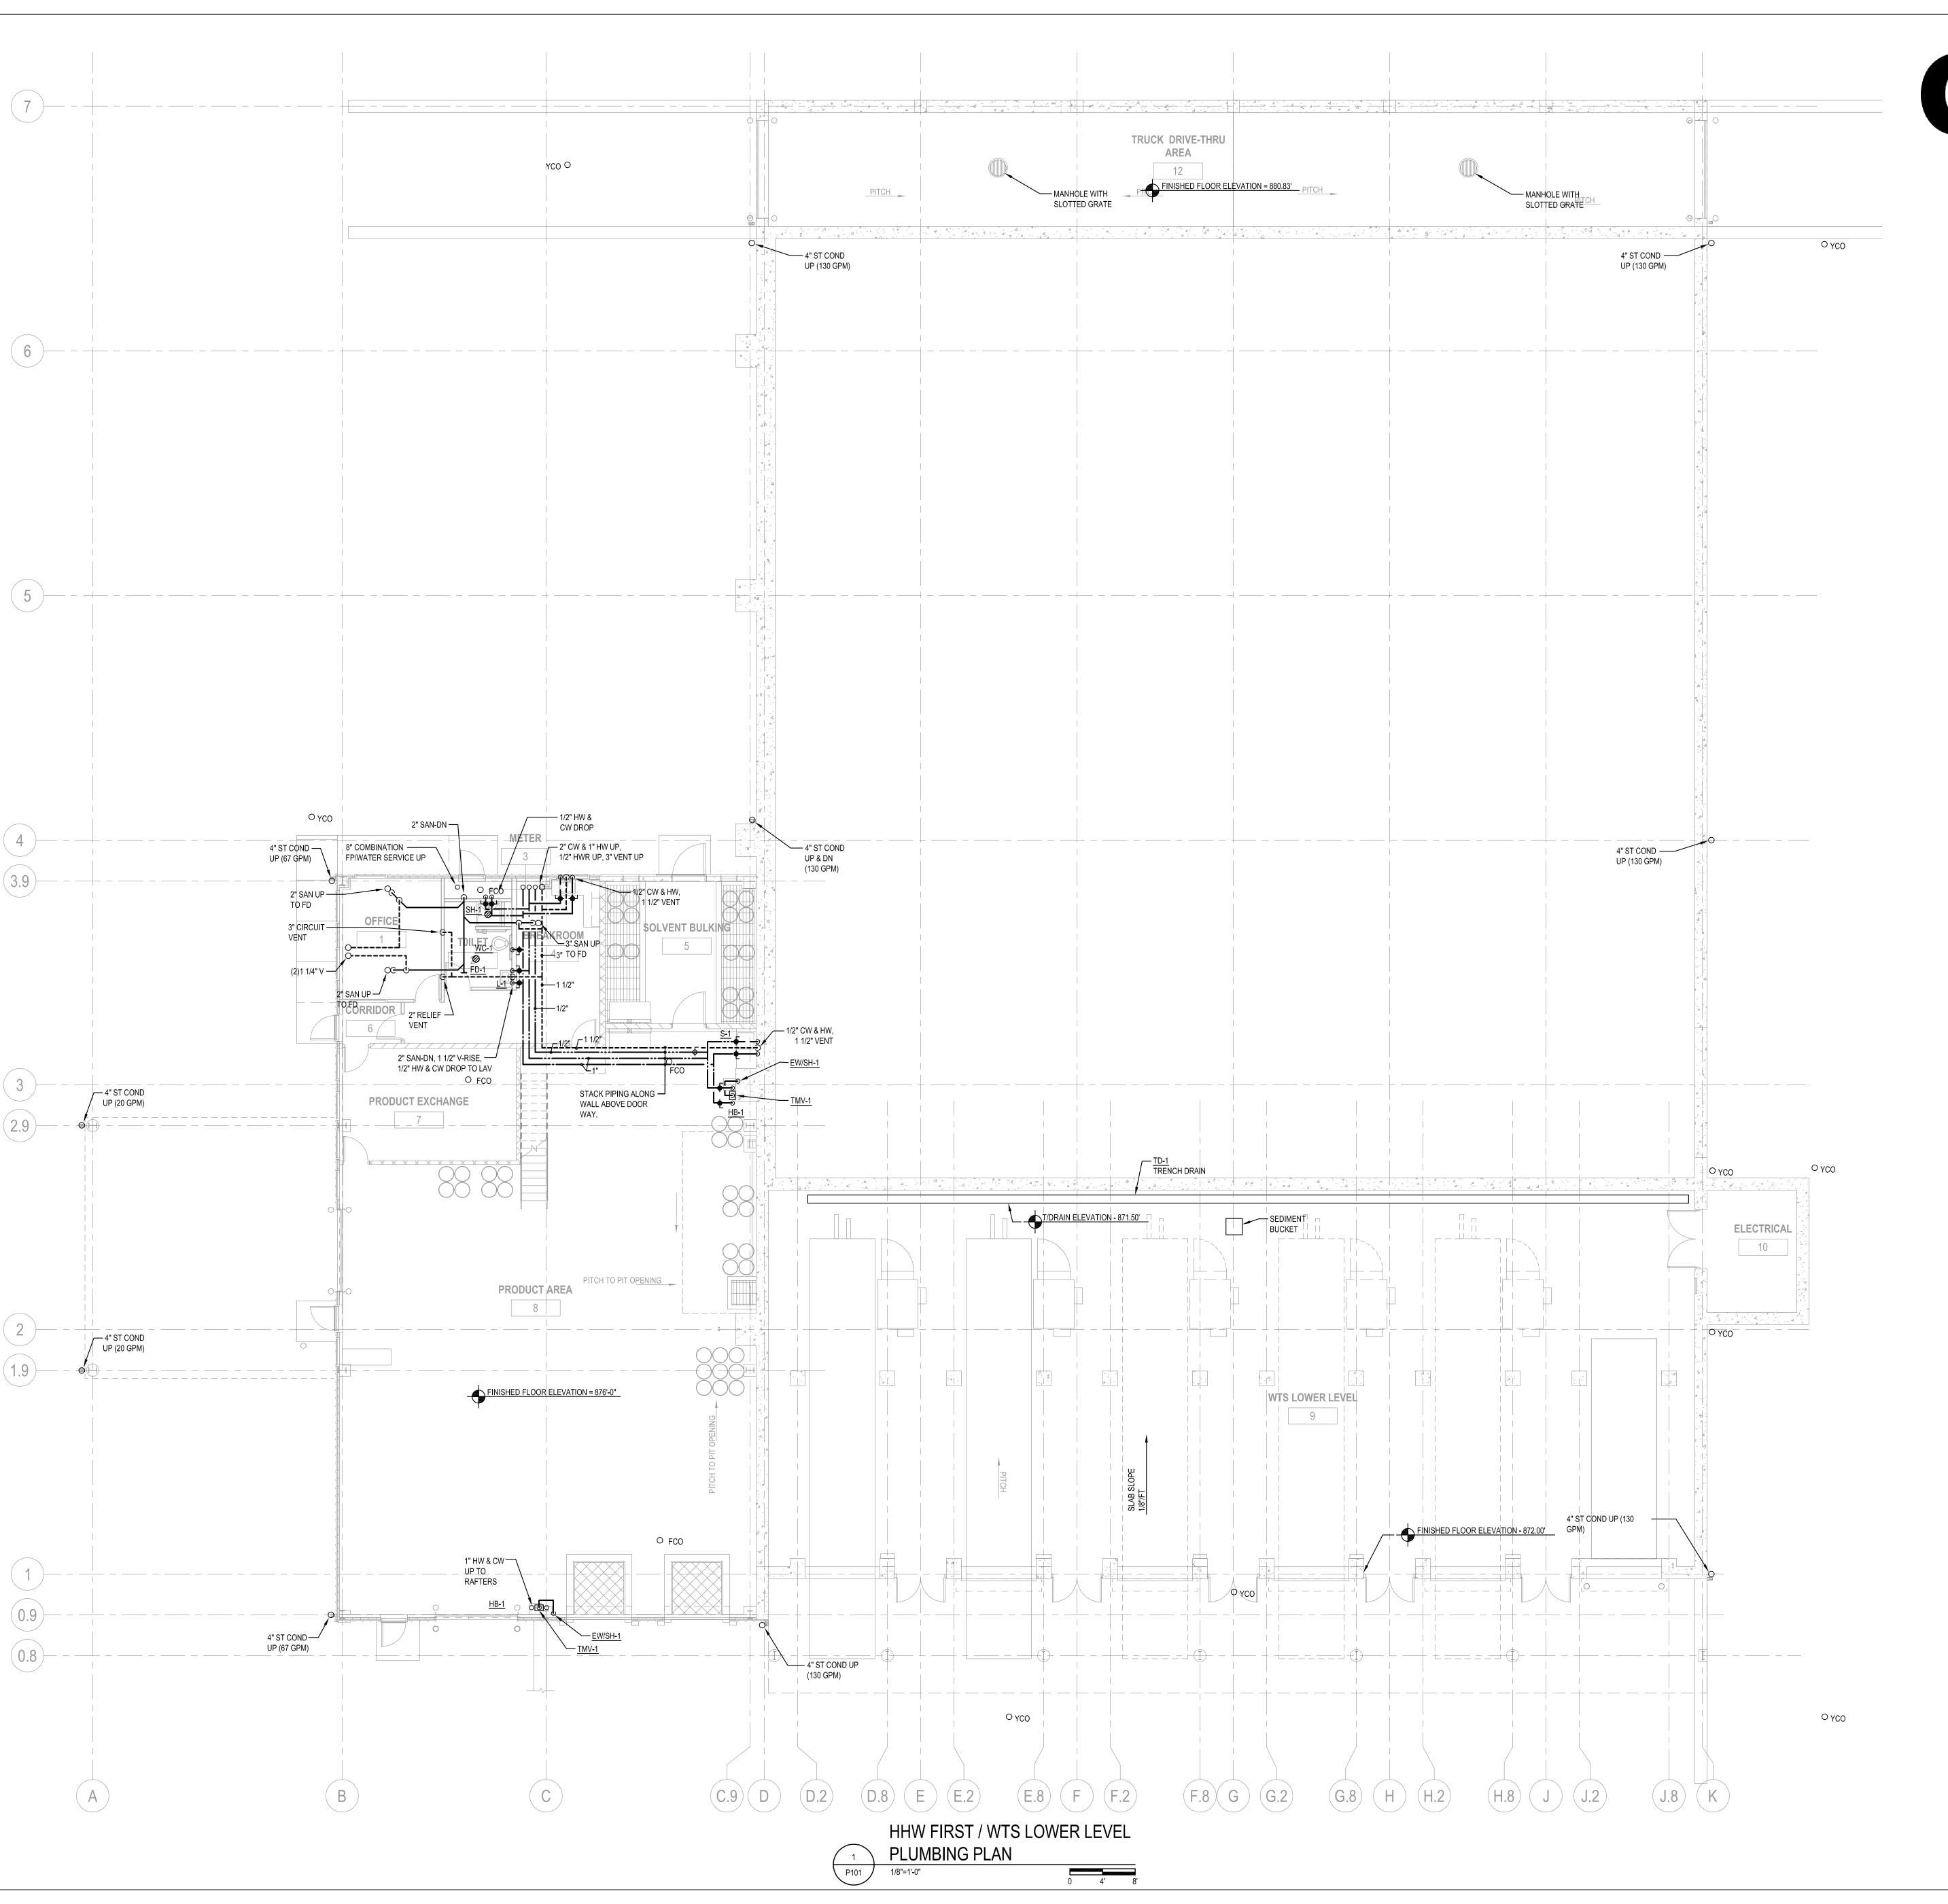
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HHW FIRST/WTS LOWER LEVEL BELOW SLAB PLUMBING PLAN





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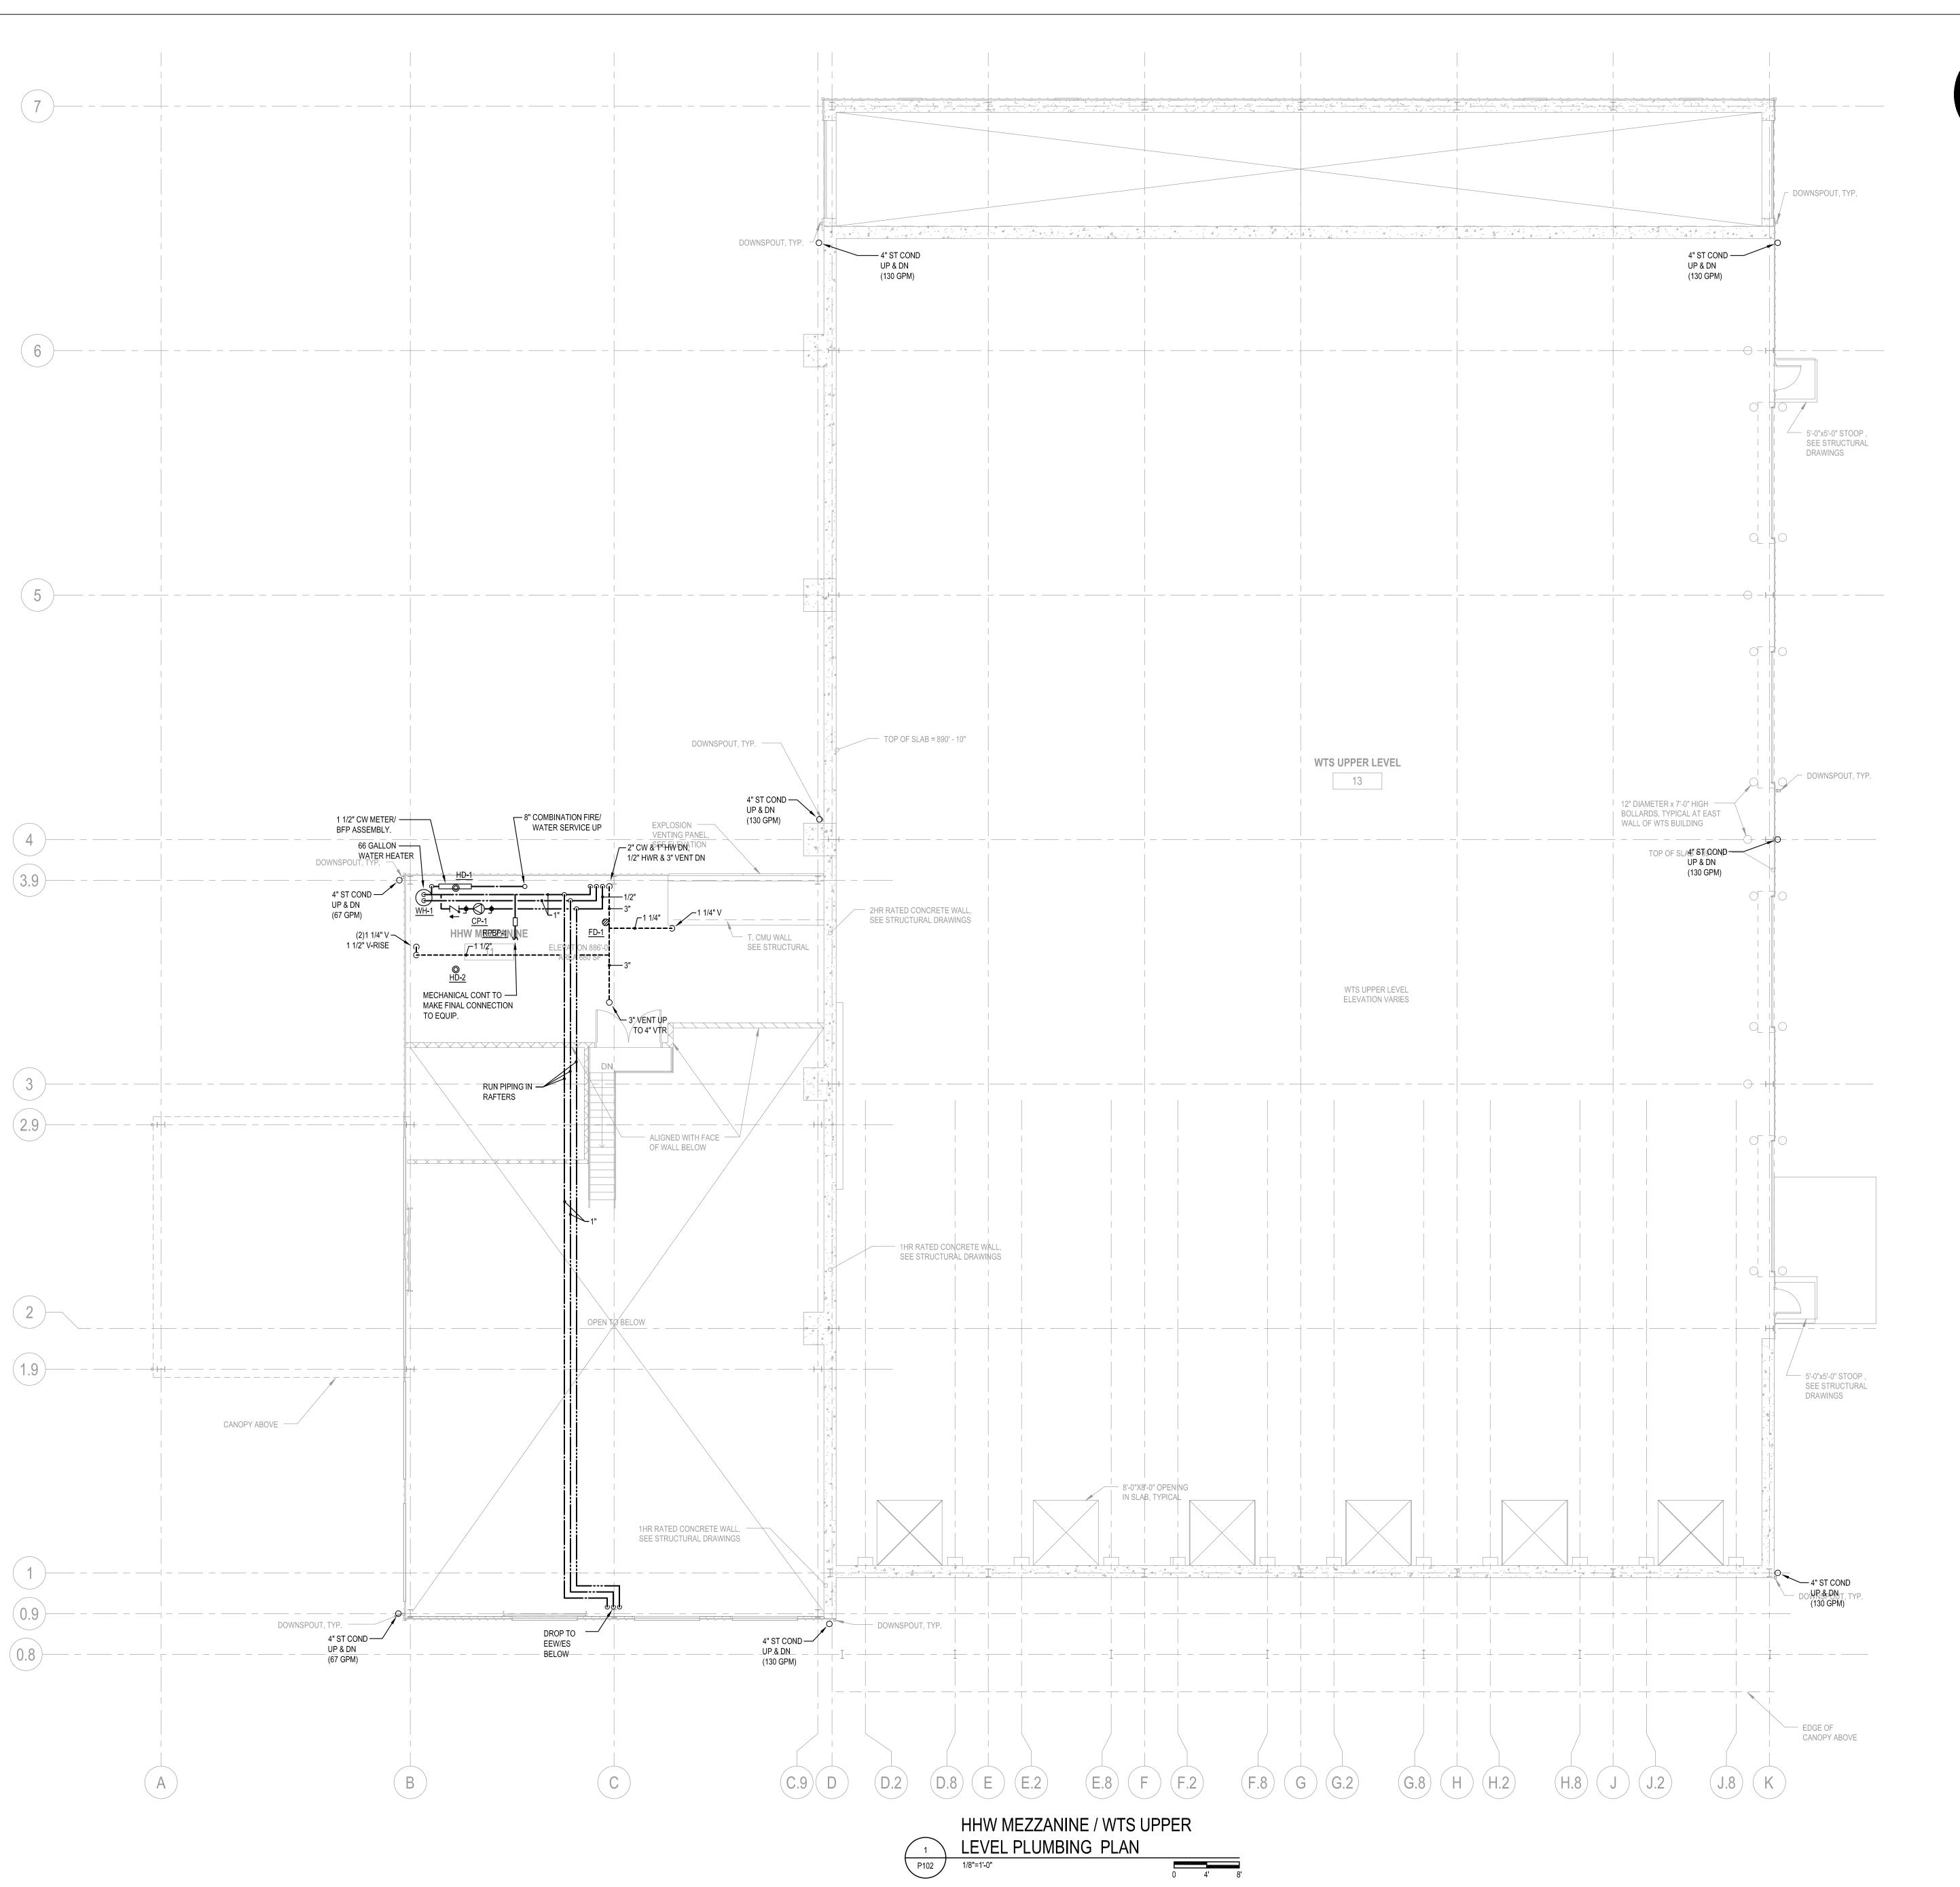
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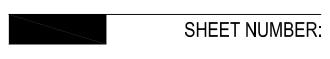
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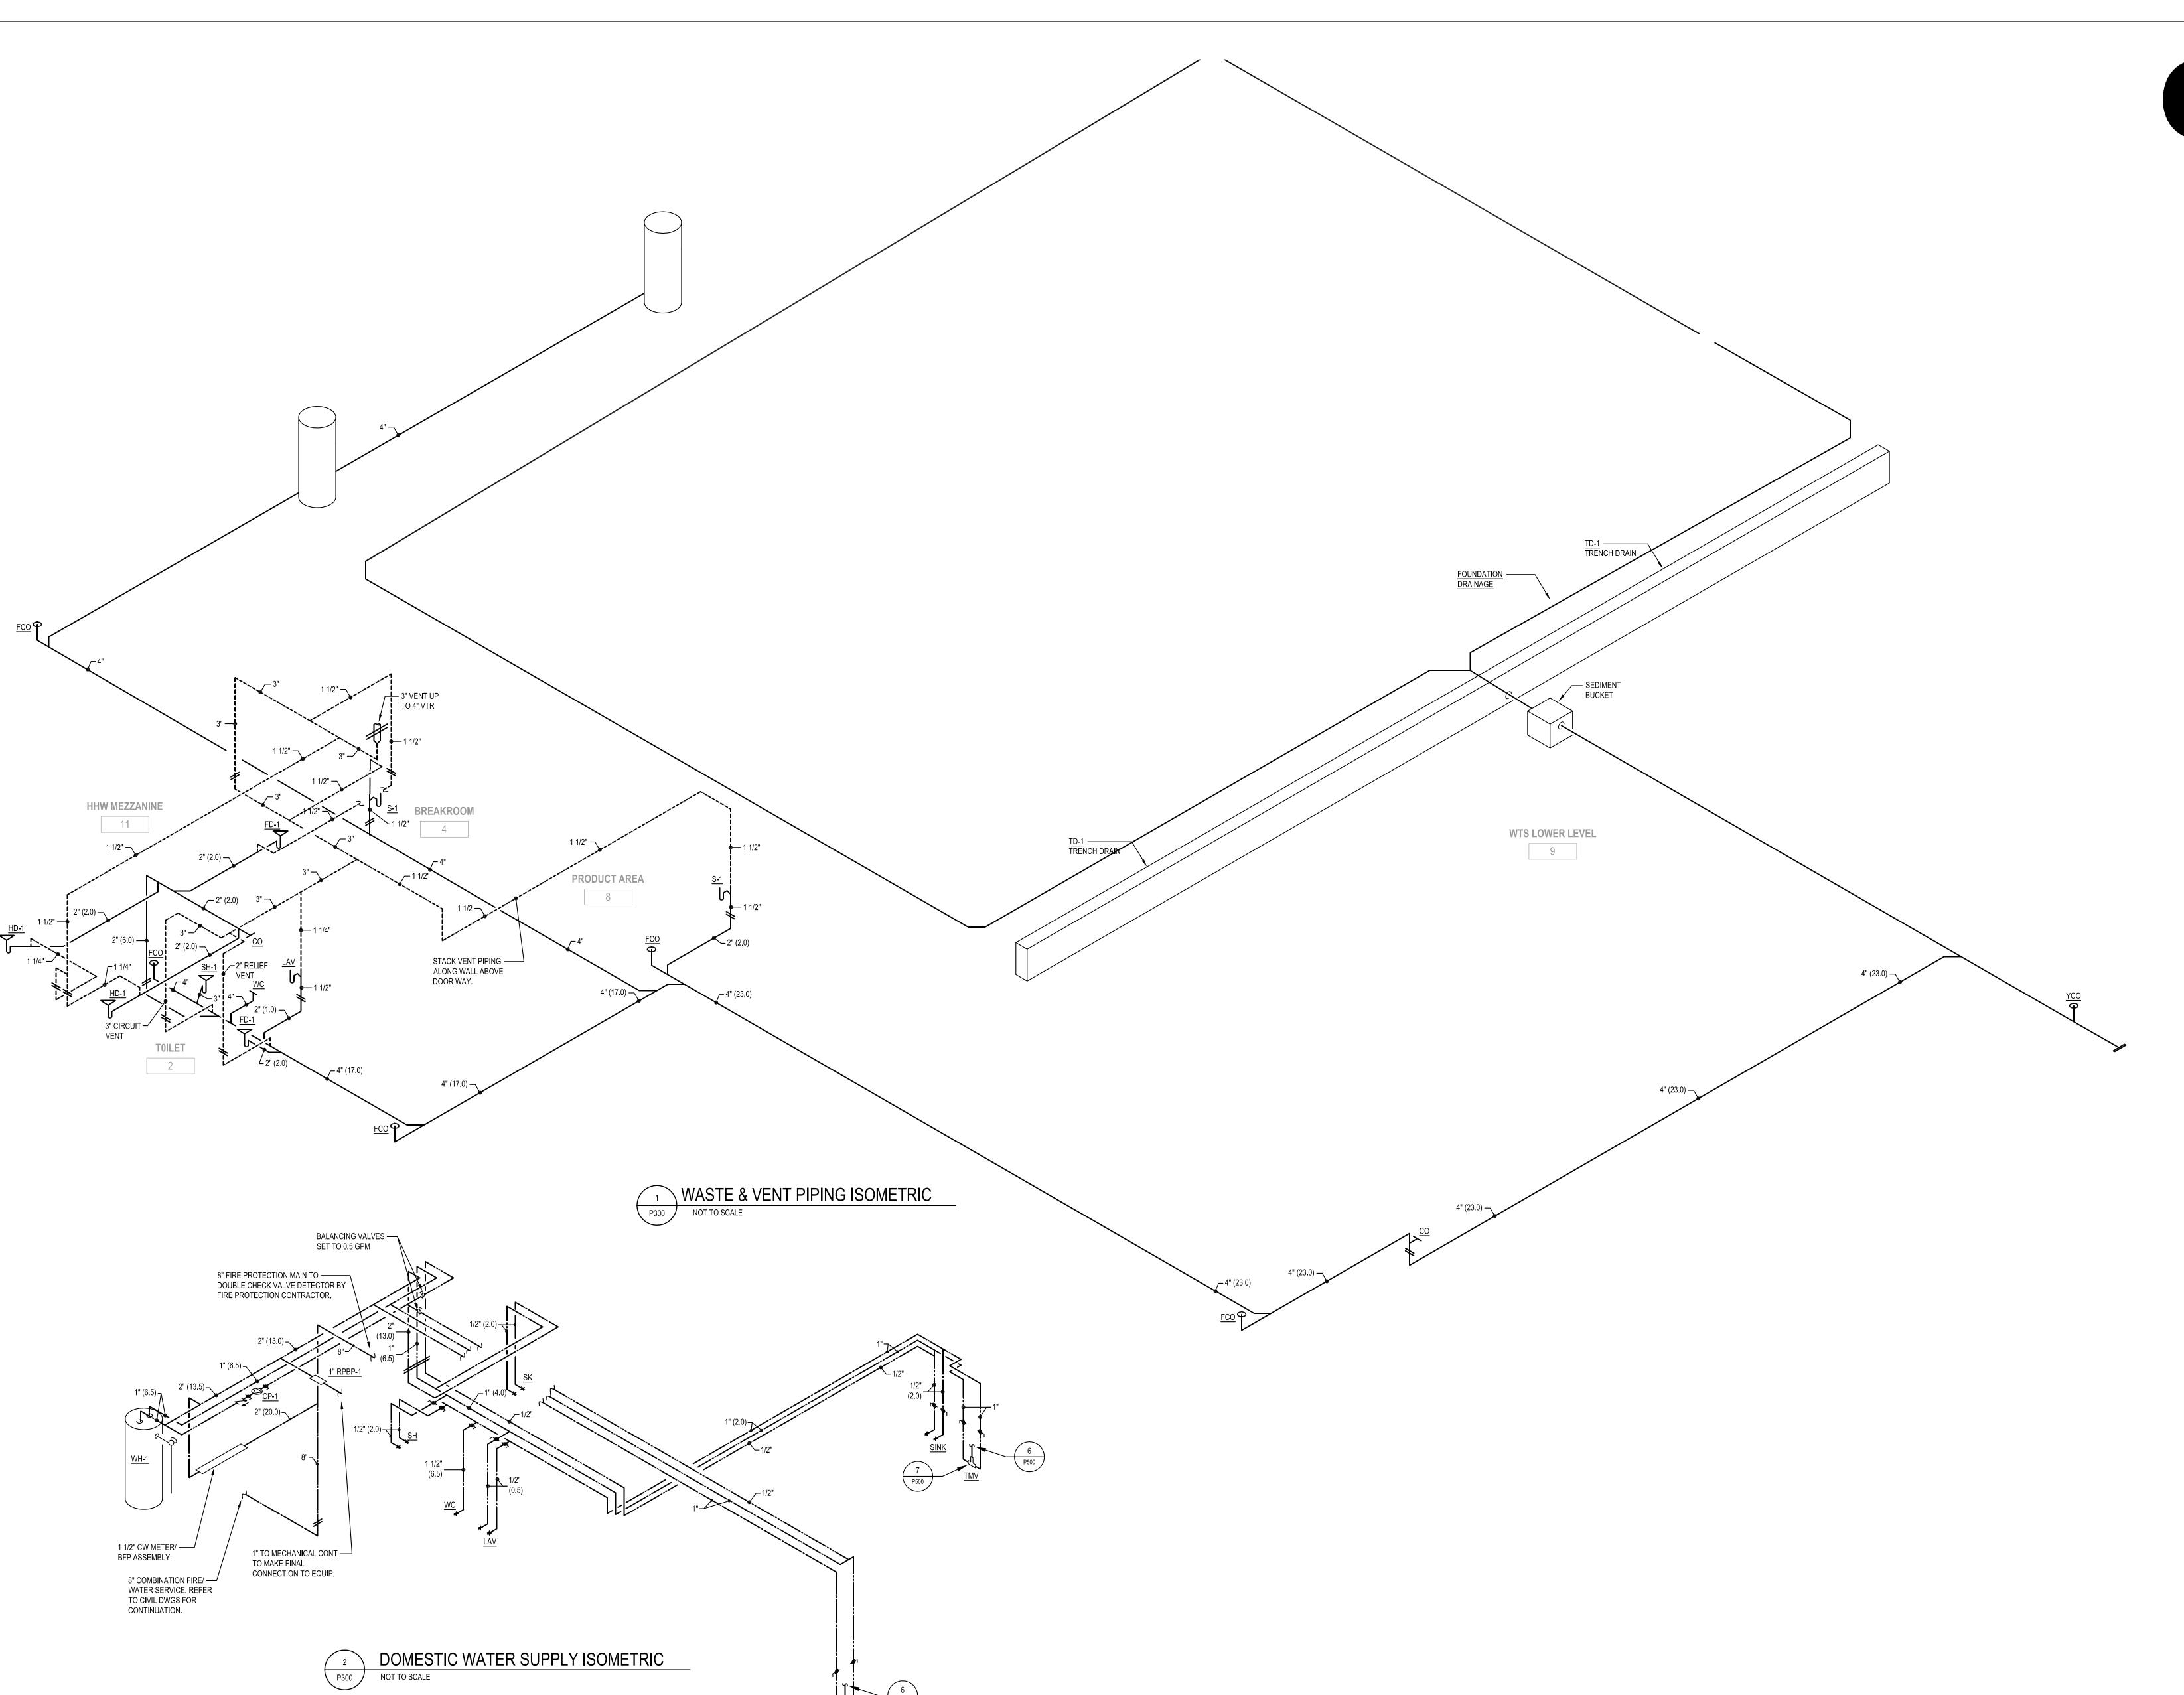
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HHW MEZZANINE/WTS UPPER LEVEL PLUMBING PLAN





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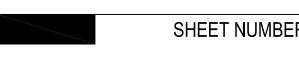
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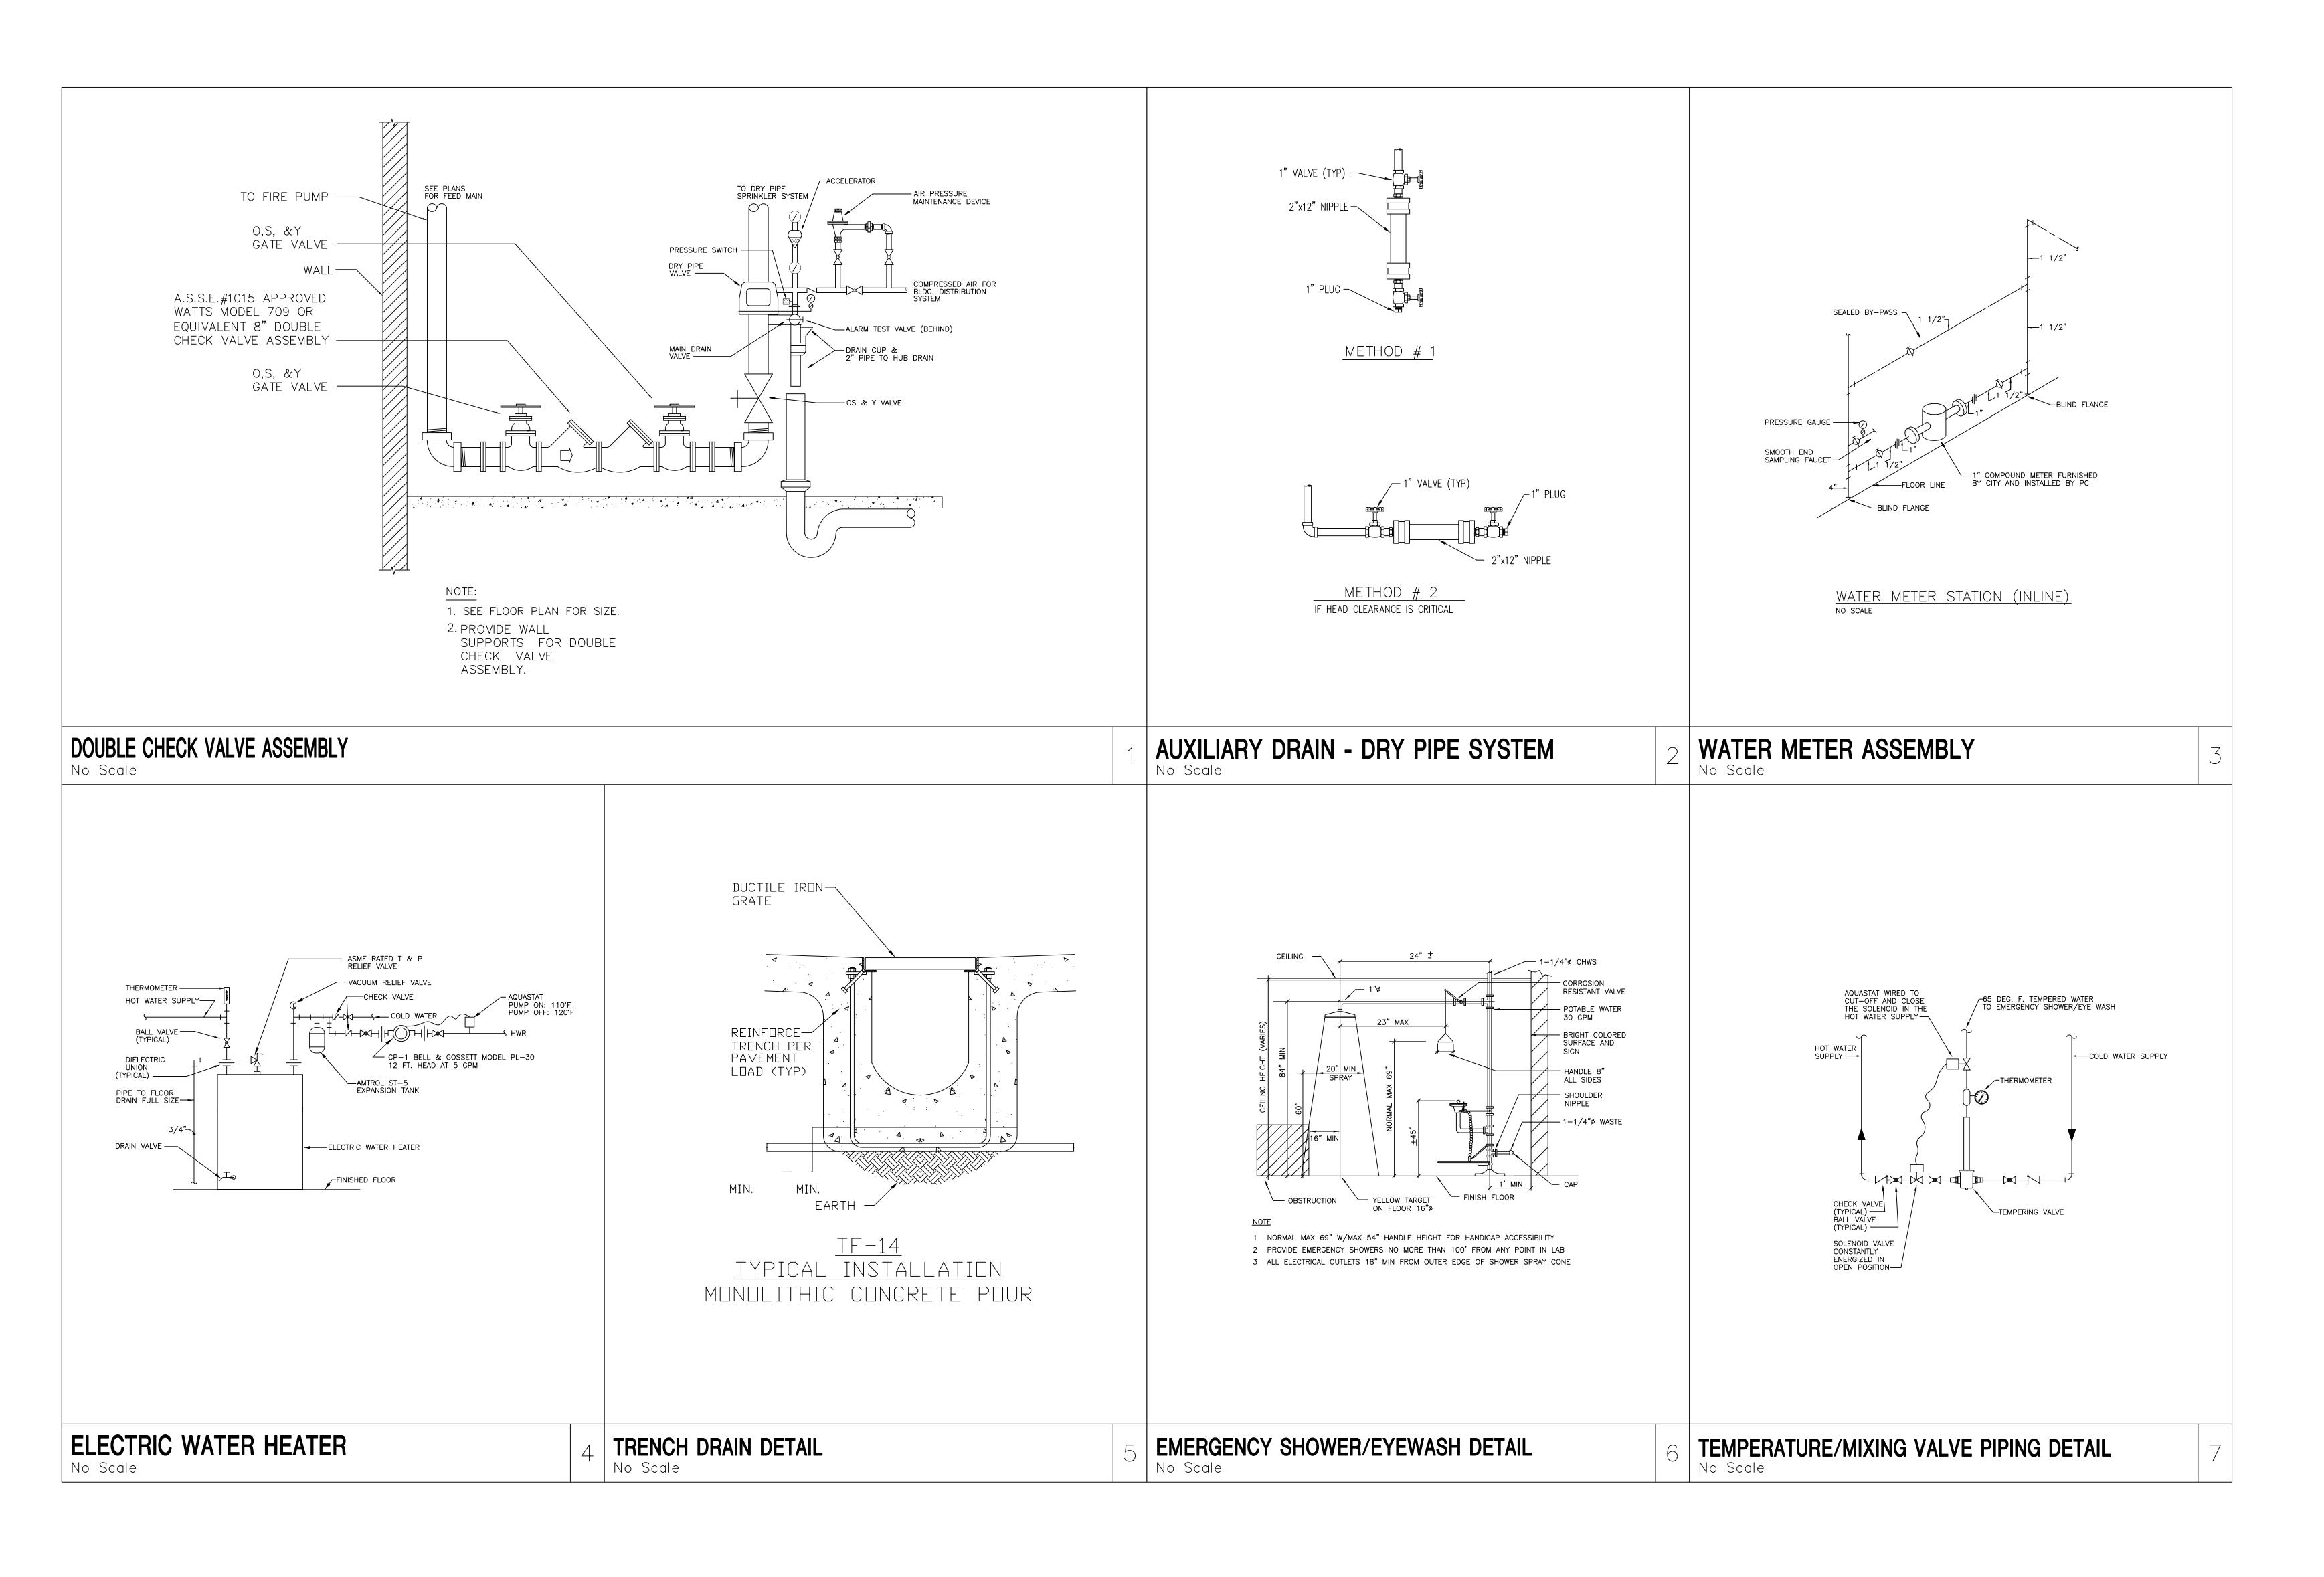
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PLUMBING ISOMETRICS





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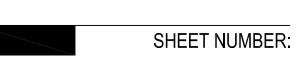
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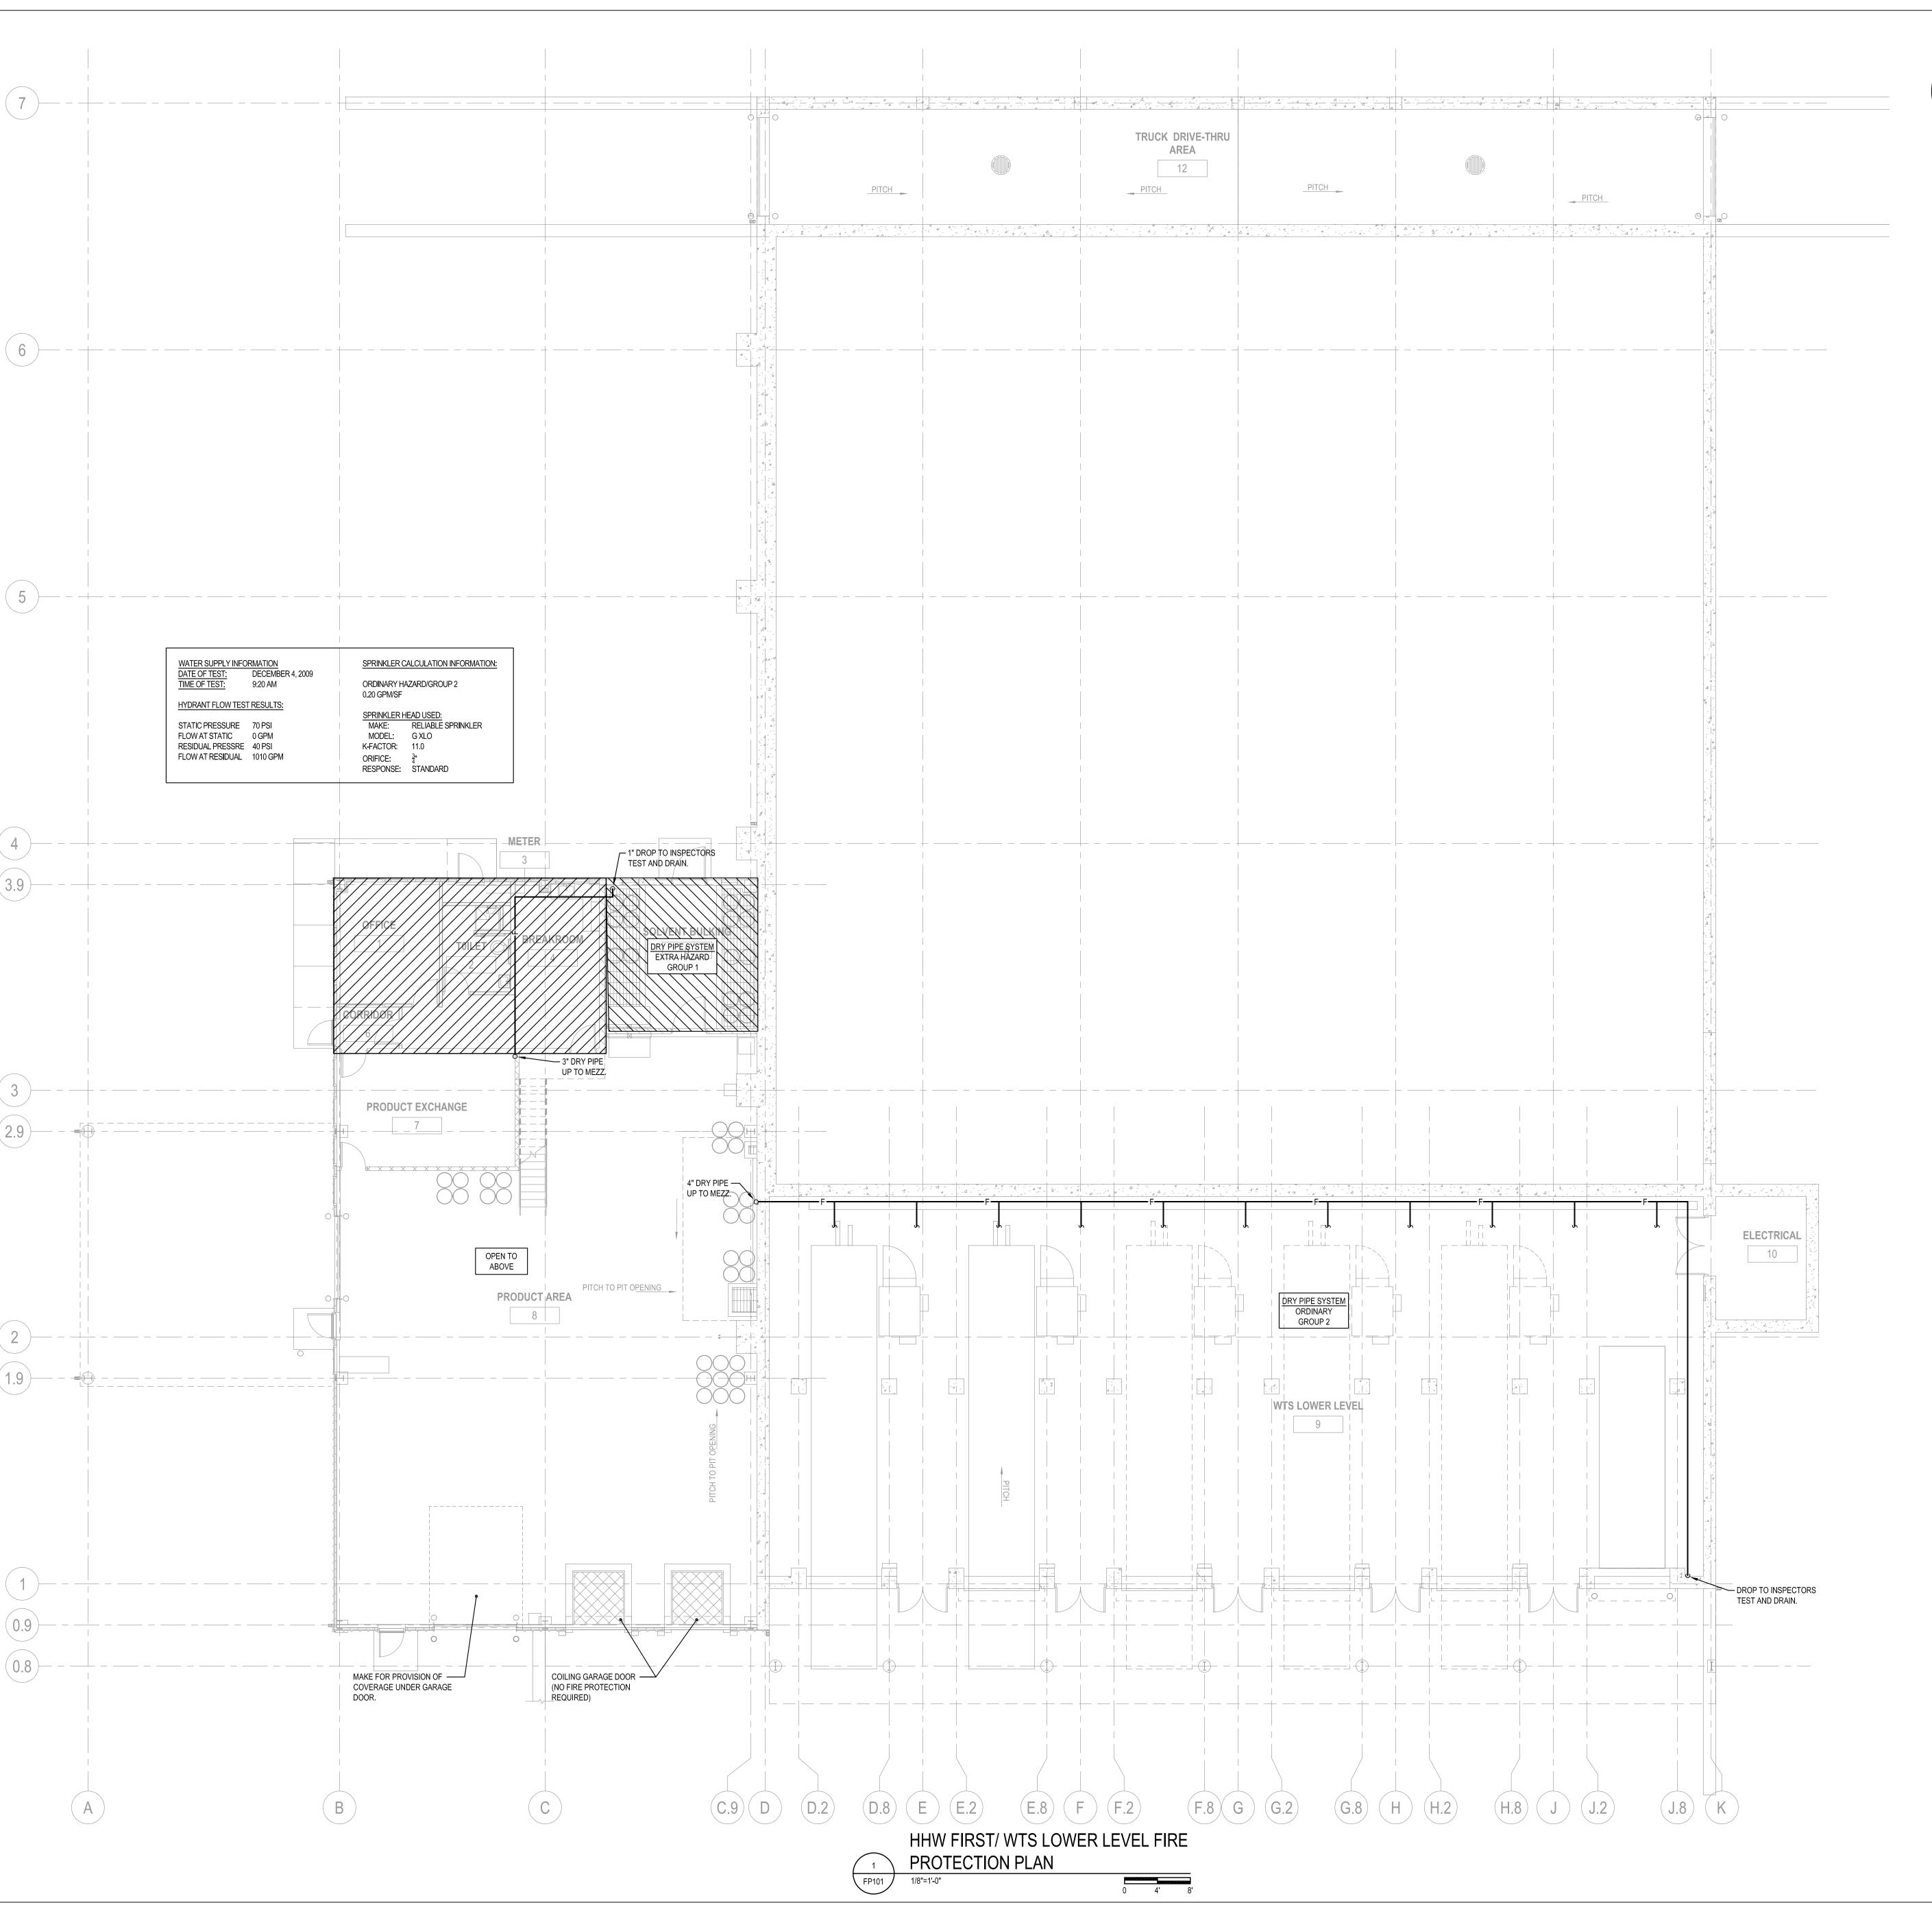
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PLUMBING DETAILS

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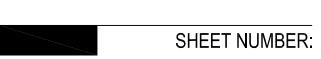
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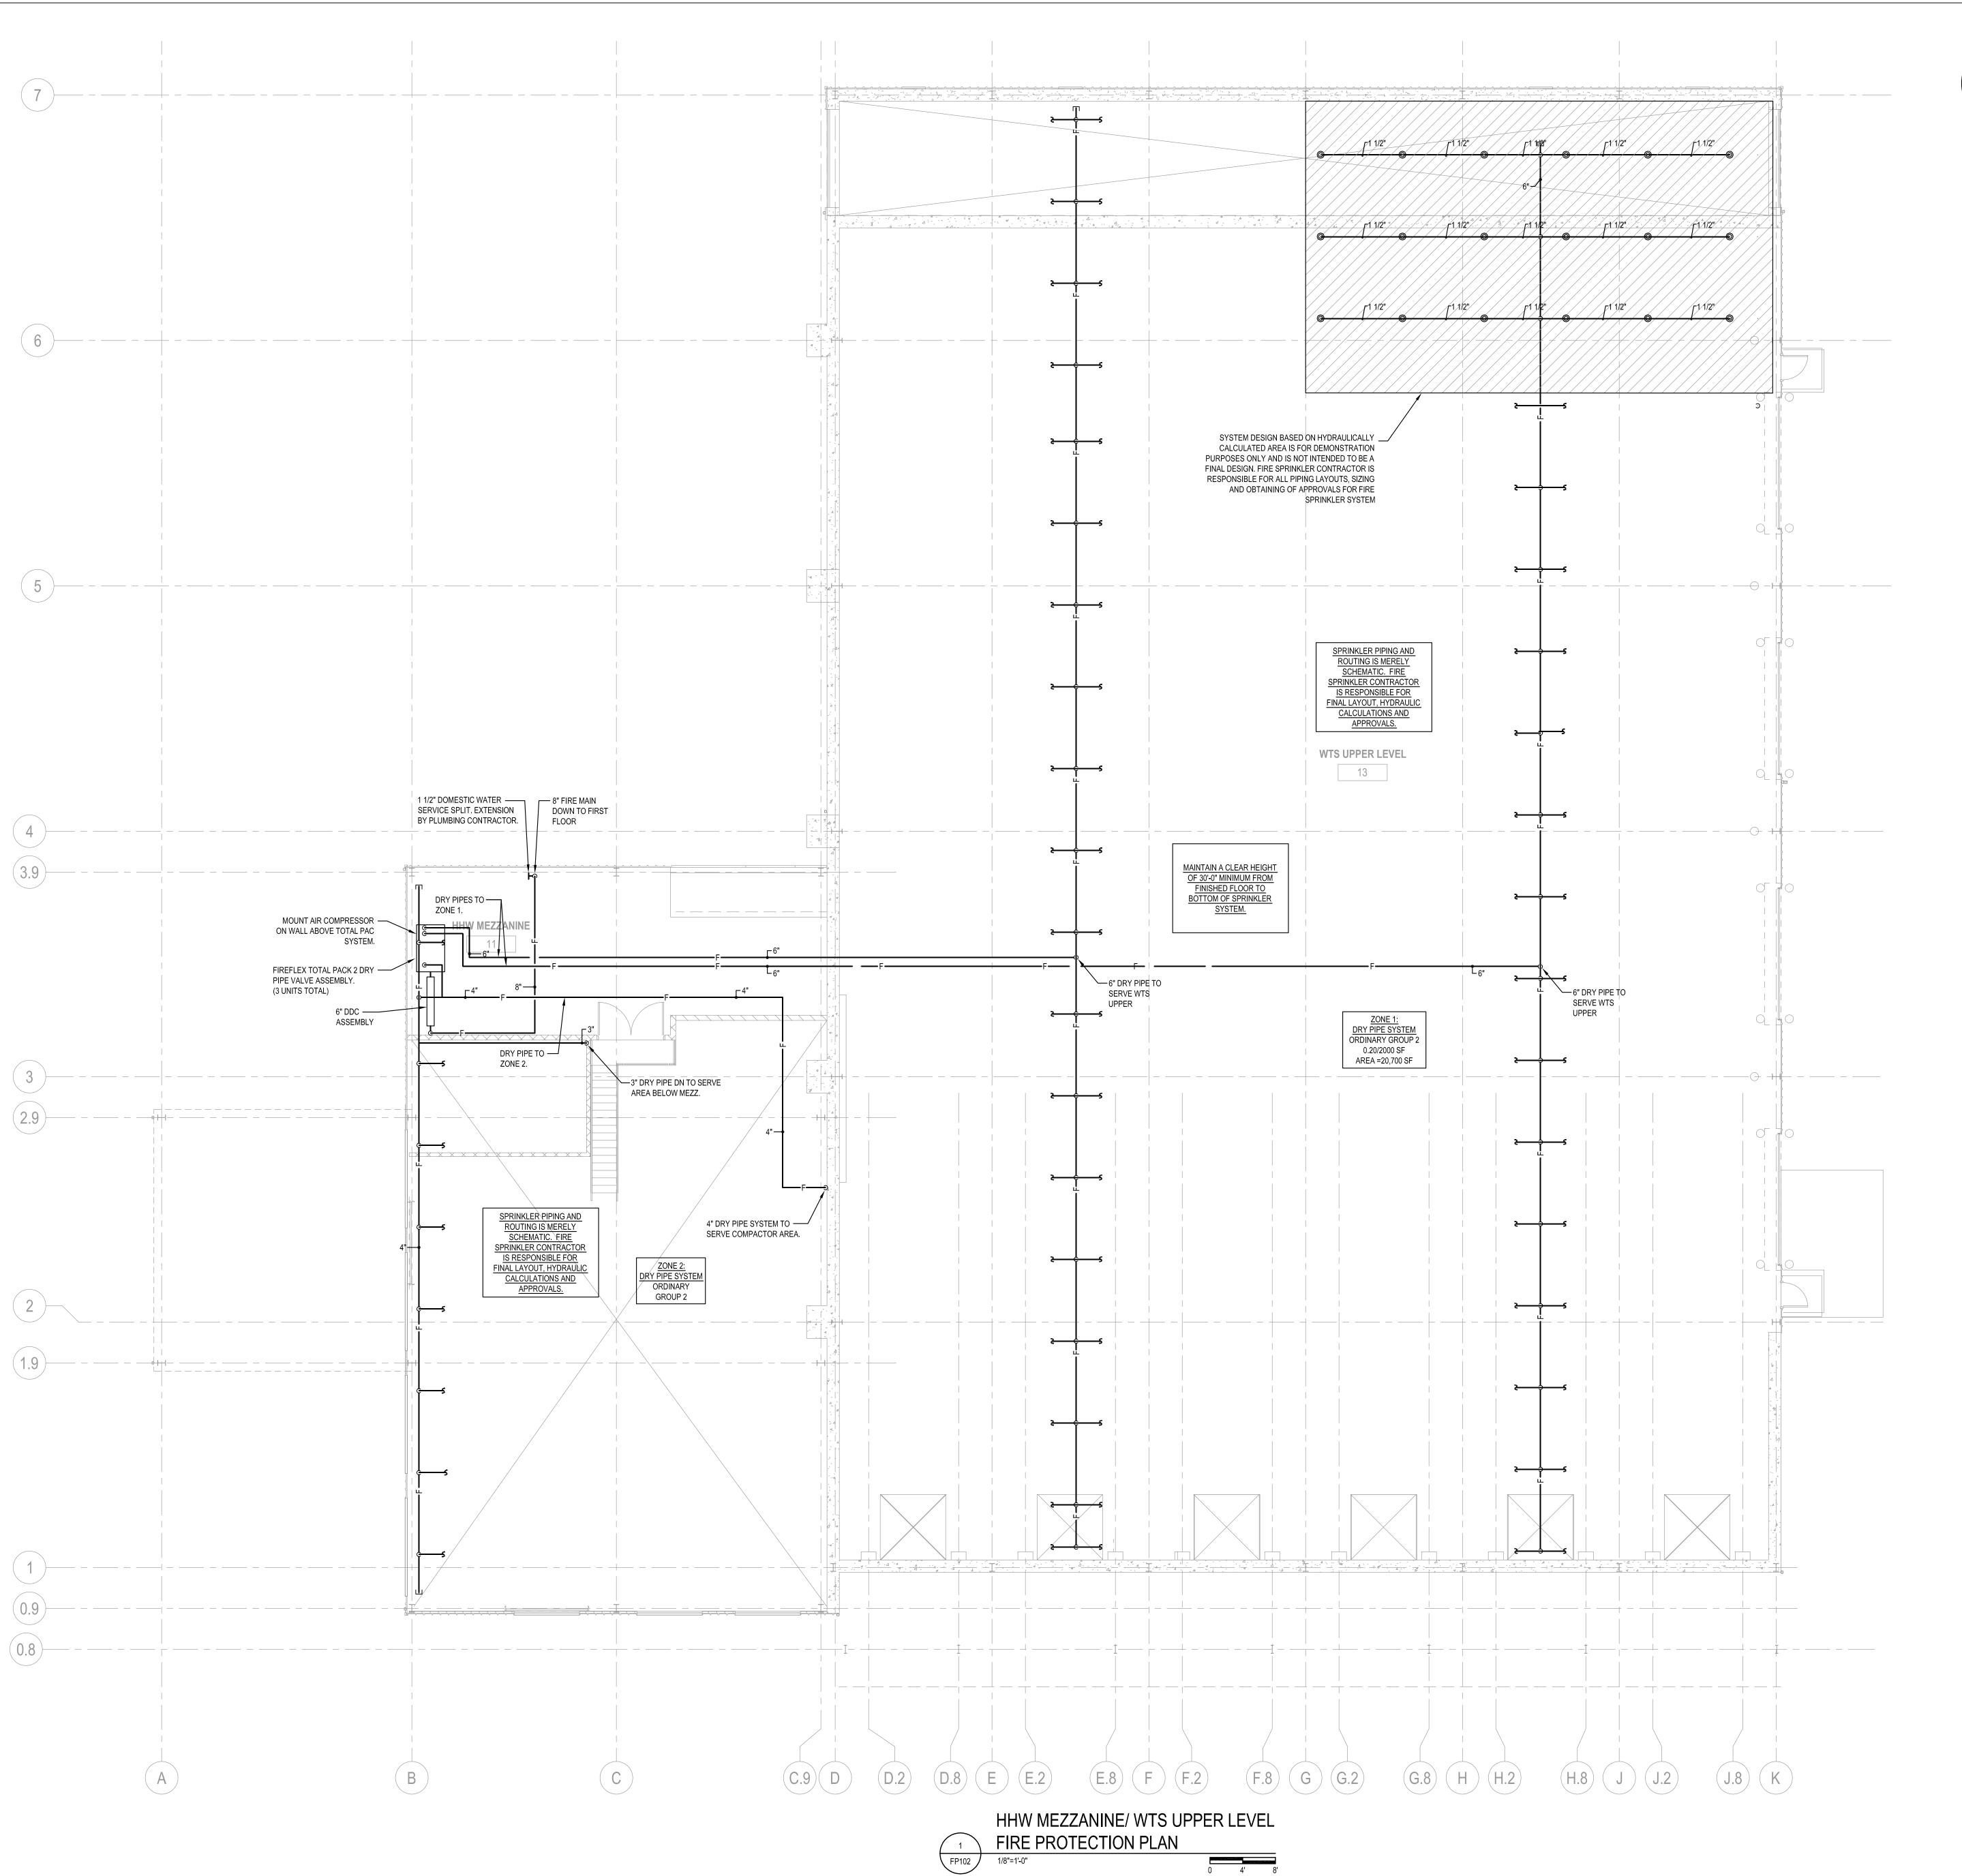
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HHW FIRST/WTS LOWER LEVEL FIRE PROTECTION PLAN



FP101





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DRAWN BY:

APPROVED BY: PDZ
SCALE: AS NOTED

SHEET TITLE:

HHW MEZZANINE/WTS UPPER LEVEL FIRE PROTECTION PLAN

SHEET NUMBER:

FP102