CONSTRUCTION & DEMOLITION WASTE RECYCLING FACILITY BID DOCUMENTS - BID NO. 315011 7102 U.S. HIGHWAY 12/18 MADISON, WISCONSIN

PREPARED FOR: DANE COUNTY DEPARTMENT OF PUBLIC WORKS, HIGHWAY AND TRANSPORTATION


PUBLIC WORKS SOLID WASTE DIVISION 1919 ALLIANT ENERGY CENTER WAY

MADISON, WISCONSIN

PREPARED BY: SCS ENGINEERS

MADISON, WISCONSIN

DATE: APRIL 2015

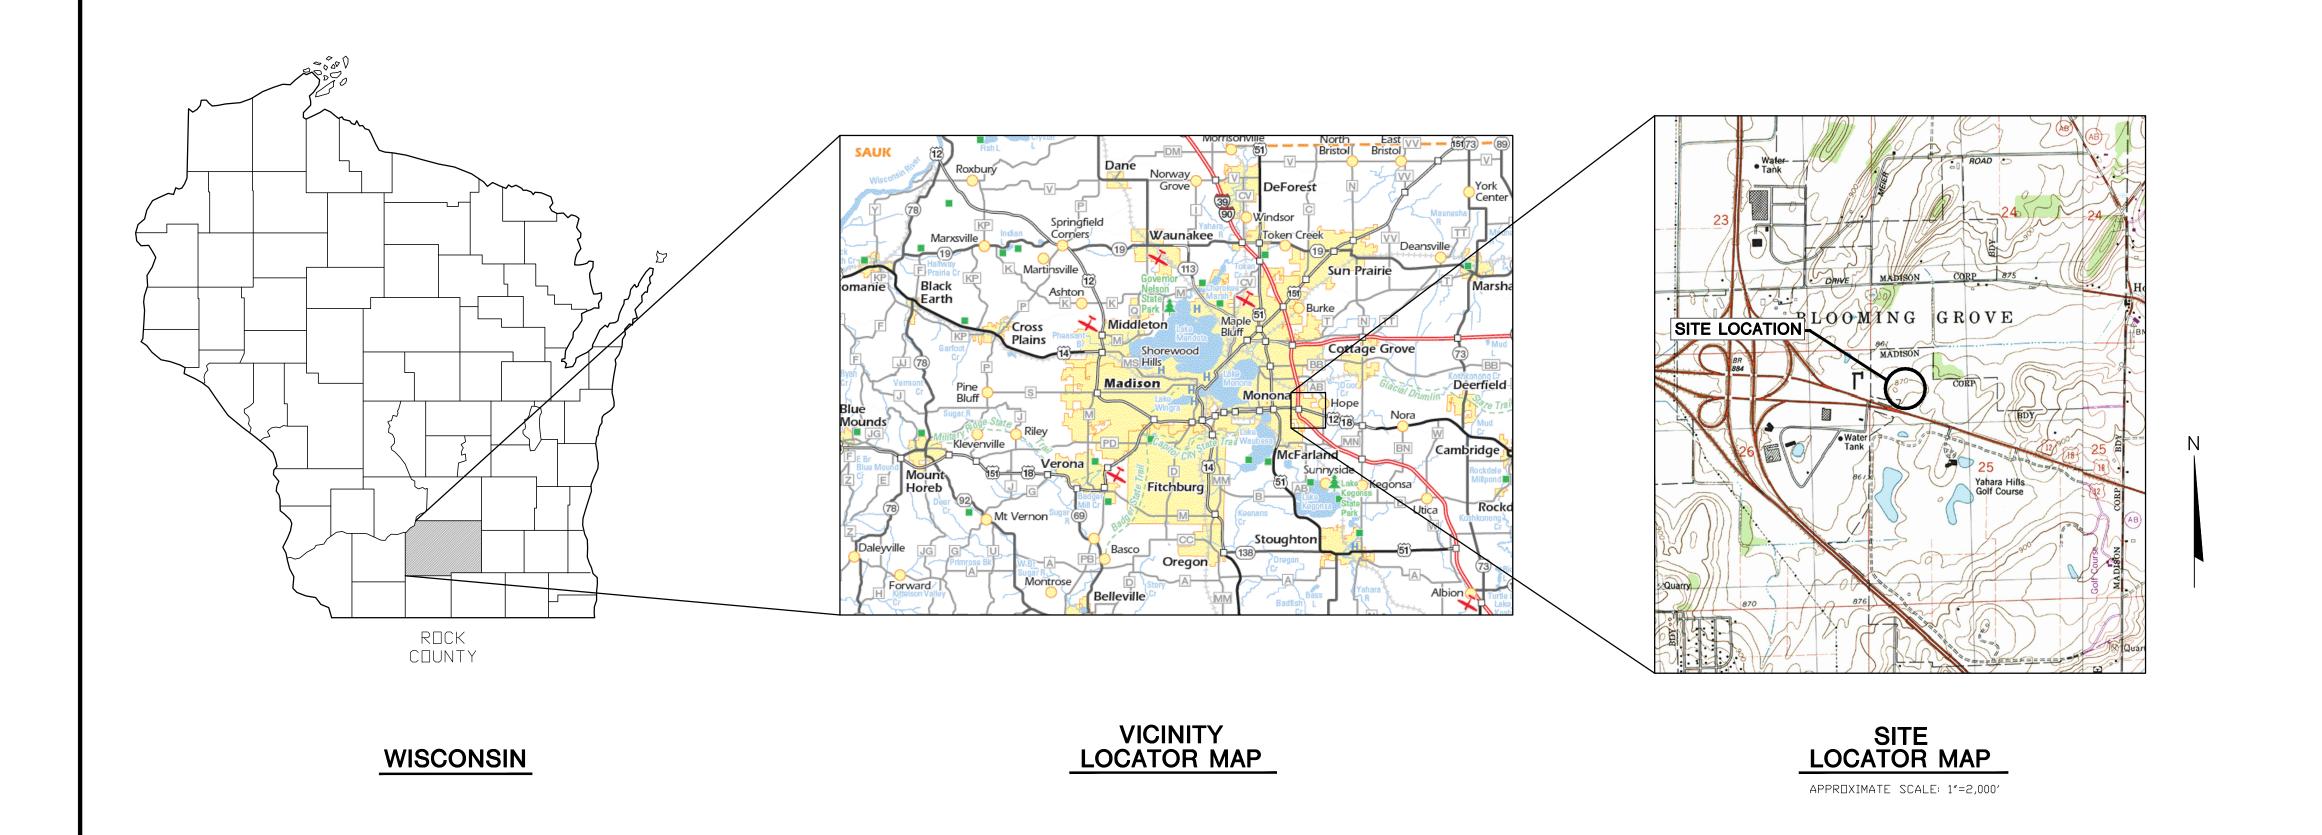

GENERAL	
G100	TITLE SHEET
CIVIL	
C100	EXISTING CONDITIONS
C110	DEMOLITION PLAN
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C310	LANDSCAPE AND RESTORATION PLAN
C500	DETAILS
	DETAILS
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Q200	EQUIPMENT ELEVATIONS - A-C
Q201	EQUIPMENT ELEVATIONS - D-H
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A100	EXTERIOR ELEVATIONS EXTERIOR ELEVATIONS
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A200	WTS NEW TIPPING FLOOR PLAN WTS SORTING PLATFORM FLOOR PLAN
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A401	BUILDING SECTIONS
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A720	DOOR SCHEDULES, DETAILS, AND PARTITION TYPES
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S400	FRAMING DETAILS
S401	FRAMING DETAILS
	THAMING BETALES
FIRE PROTECTION	
F201	WTS NEW TIPPING FLOOR PLAN - FIRE PROTECTION
PLUMBING	
P000	SYMBOLS, ABBREVIATIONS, DETAILS AND SCHEDULES - PLUM
P101	WTS TIPPING FLOOR PLAN DEMOLITION - PLUMBING
P200	UNDERFLOOR PLAN - PLUMBING
P201	CLEAN SWEEP BUILDING - MAIN LEVEL - PLUMBING
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M000	PARTIAL SITE PLAN - HVAC
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M002	
M003	JACKET WATER AND SCAC PIPING
M101	WTS TIPPING FLOOR PLAN - DEMOLITION - HVAC
M201	CLEAN SWEEP BUILDING - MAIN LEVEL - HVAC
M202	WTS NEW TIPPING FLOOR PLAN - HVAC
M203	WTS SORTING PLATFORM FLOOR PLAN - HVAC
M204	WTS SORTING PLATFORM FLOOR PLAN - HVAC PIPING
M800	SCHEDULES - HVAC
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ELECTRICAL	
E000	SYMBOLS & SCHEDULES - ELECTRICAL
E001	SITE PLAN - ELECTRICAL
E101	WTS UPPER LEVEL FLOOR PLAN - DEMOLITION - ELECTRICAL
E201	PARTIAL FLOOR PLANS - ELECTRICAL
	PARTIAL FLOOR PLANS - ELECTRICAL PARTIAL FLOOR PLANS - ELECTRICAL
L-111 111	
E202 E600	ONE-LINE DIAGRAM - ELECTRICAL

SCS ENGINEERS 2830 DAIRY DRIVE MADISON, WI 53718-6751 PHONE: (608) 224-2830

CONSTRUCTION AND DEMOLITION WASTE RECYCLING FACILITY 7102 US HWY 12/18 MADISON, WISCONSIN

DANE COUNTY DEPARTMENT OF PUBLIC WORKS SOLID WASTE DIVISION 1919 ALLIANT ENERGY CENTER WAY

MADISON, WI 53713

PROCESS AND CIVIL ENGINEER:
SCS ENGINEERS
2830 DAIRY DRIVE

MADISON, WI 53718-6751 (608) 224-2830

RCHITECT:

DORSCHNER ASSOCIATES, INC. 849 E. WASHINGTON AVE., SUITE 112 MADISON, WI 53703

STRUCTURAL ENGINEER:

PIERCE ENGINEERS, INC. 10 WEST MIFFLIN ST., SUITE 205 MADISON, WI 53703

MECHANICAL, ELECTRIC, PLUMBING

JDR ENGINEERING, INC. 5525 NOBEL DRIVE, SUITE 110 MADISON, WI 53711

N

EVISION DATE BY TITLE

PROJECT NO. 25214236.00

PRAWN: 02/13/15

PEVISED: 04/27/15

PRAWN BY: AHB

PHECKED BY: MH


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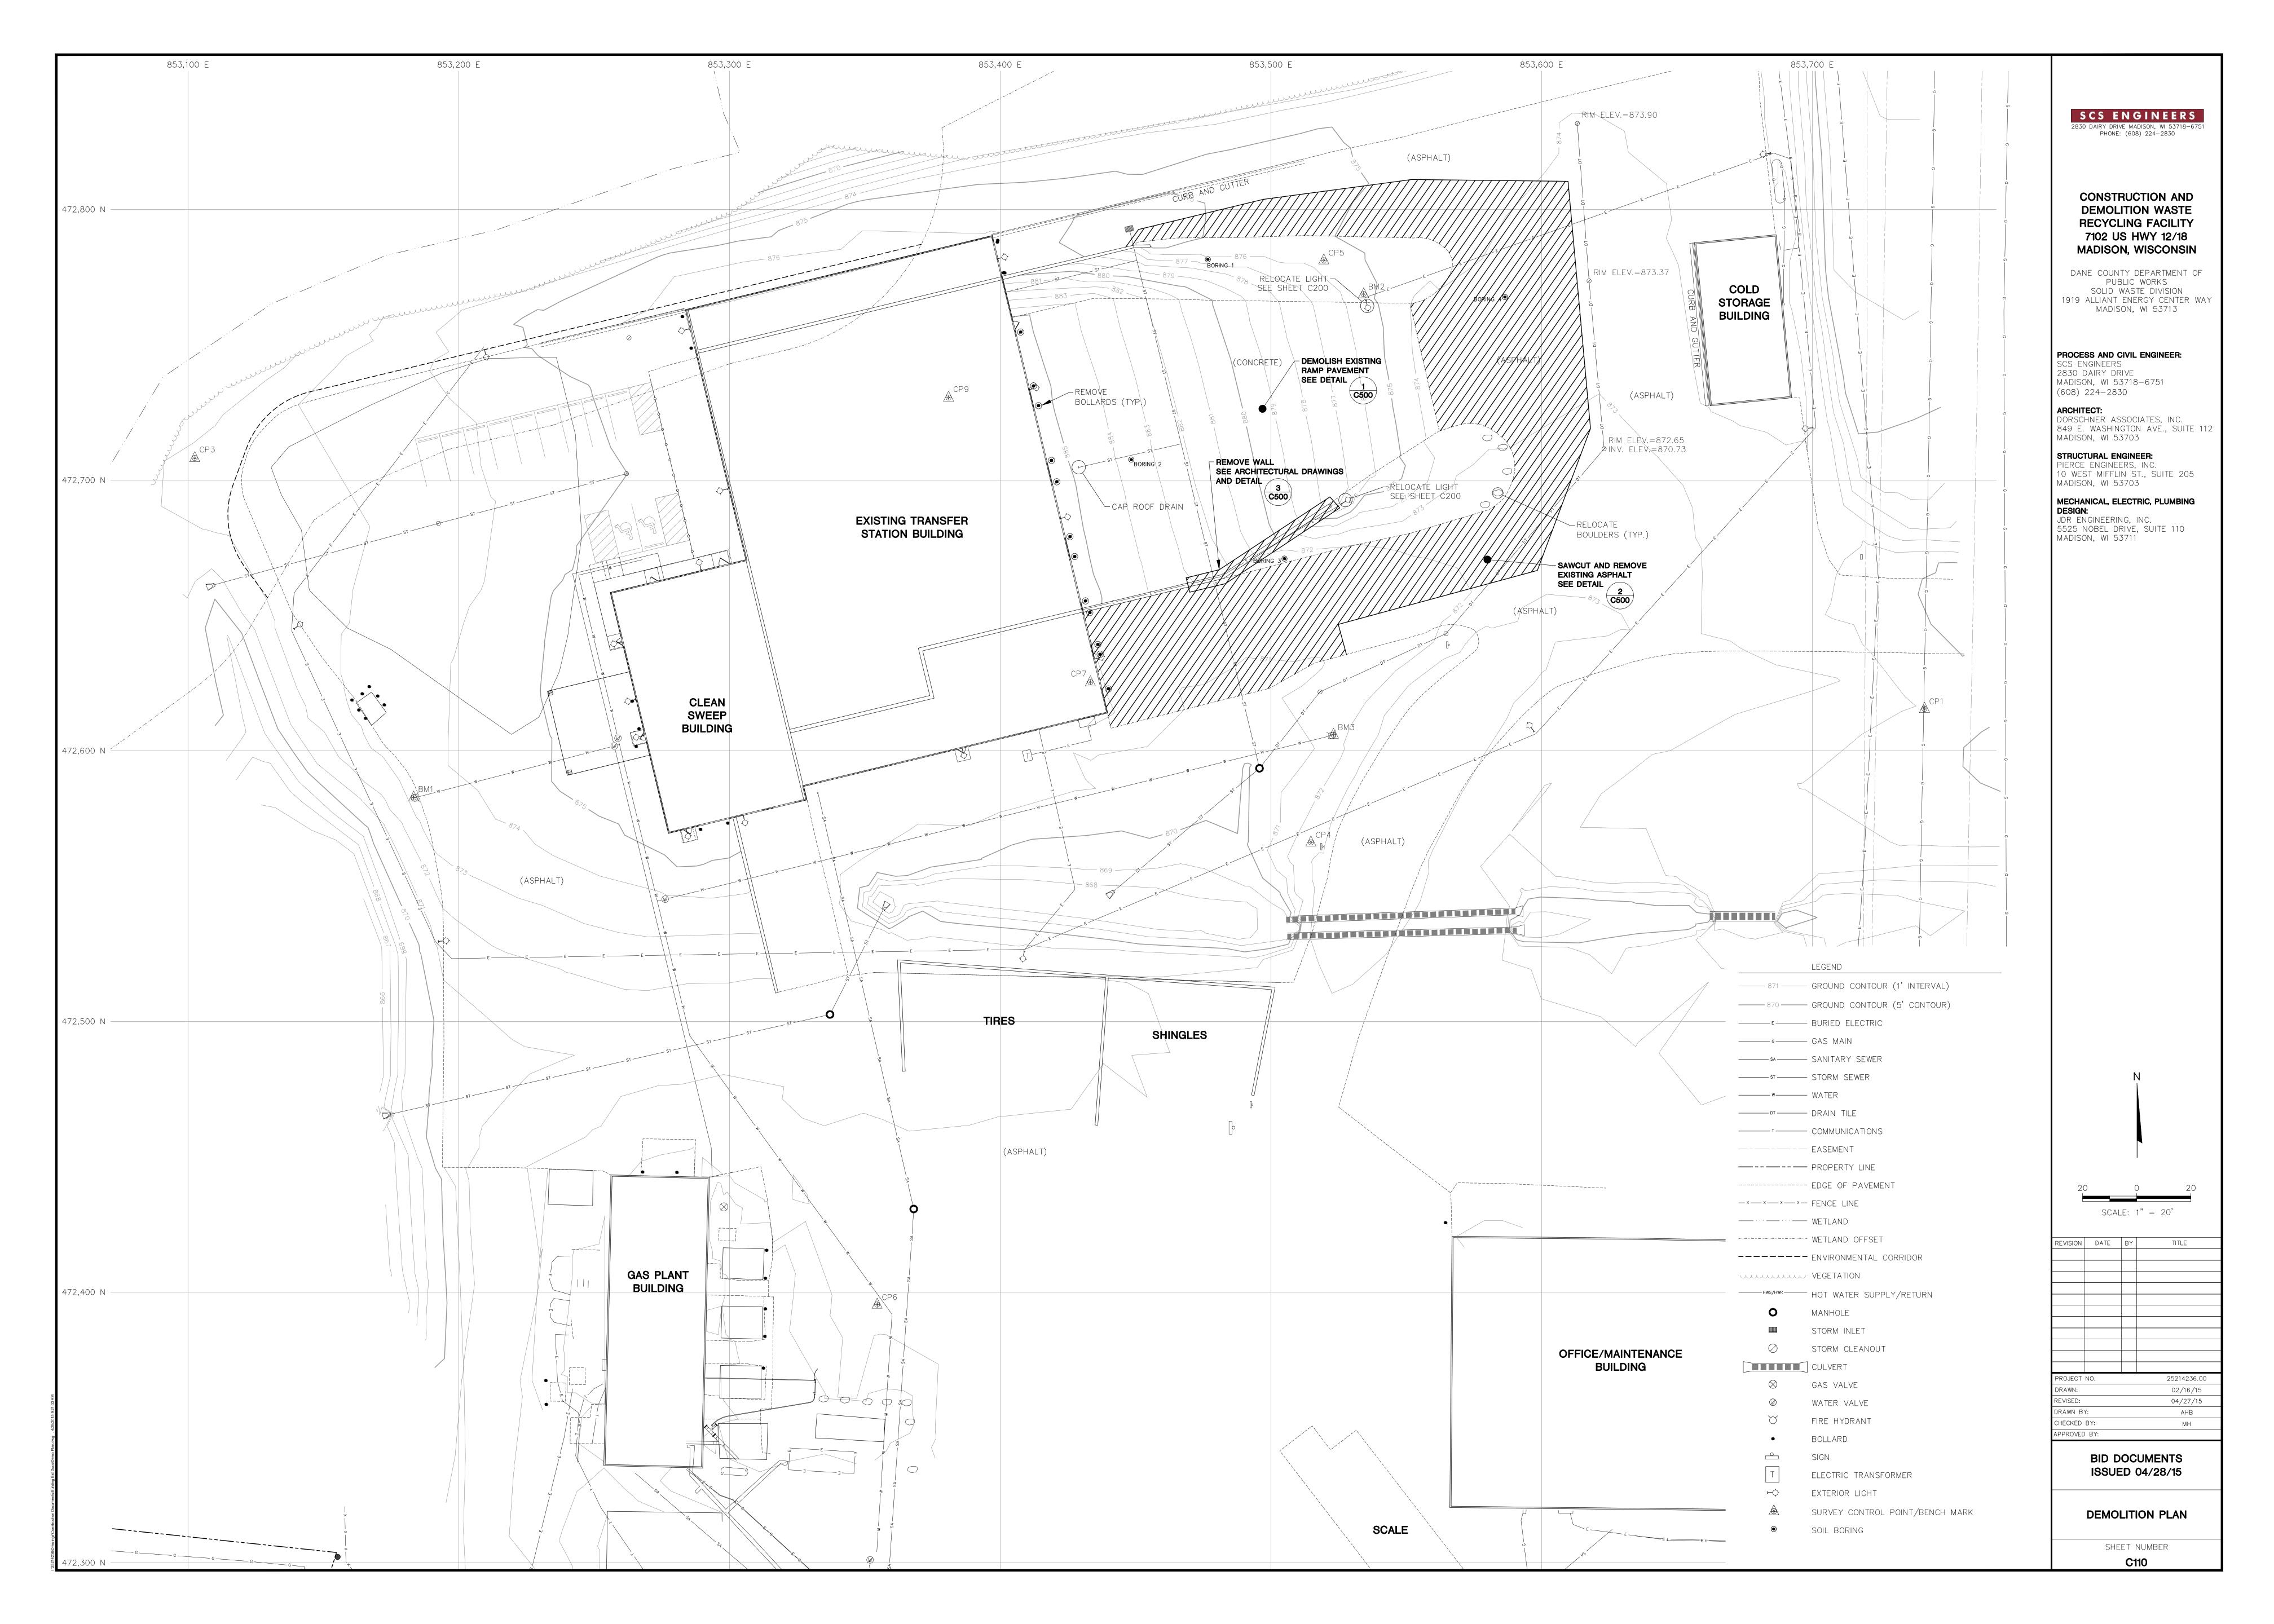
BID DOCUMENTS ISSUED 04/28/15


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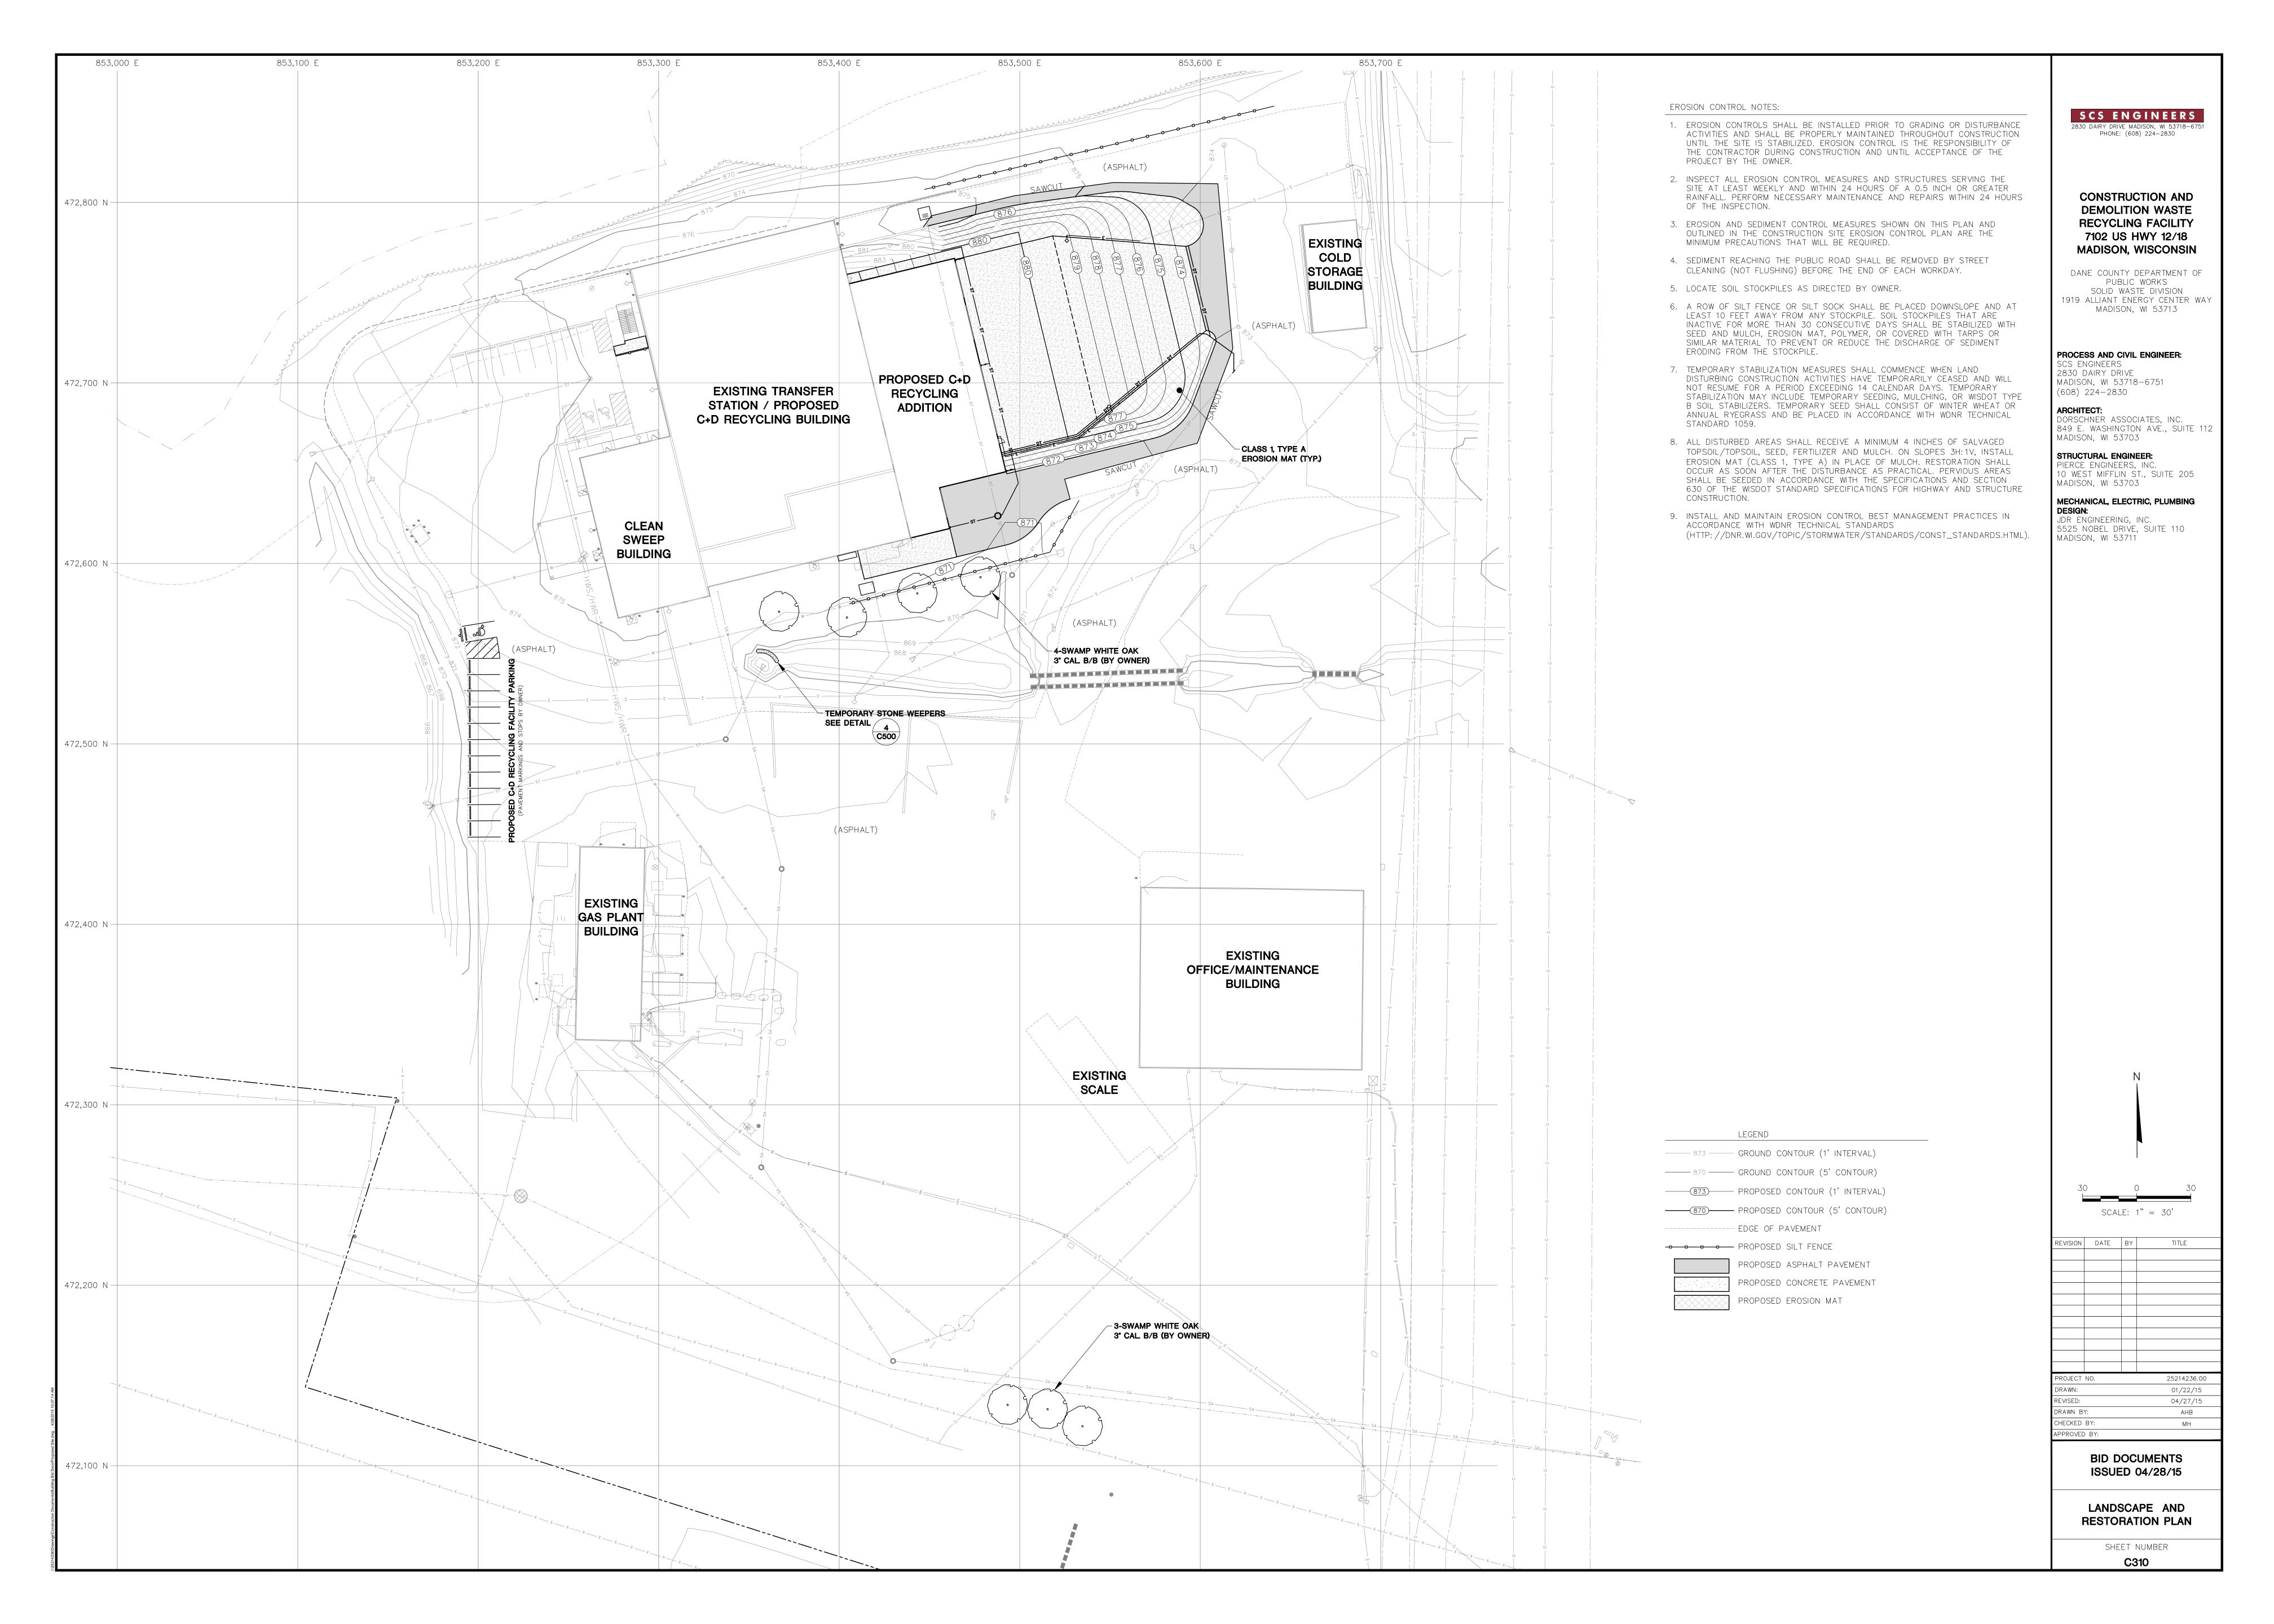
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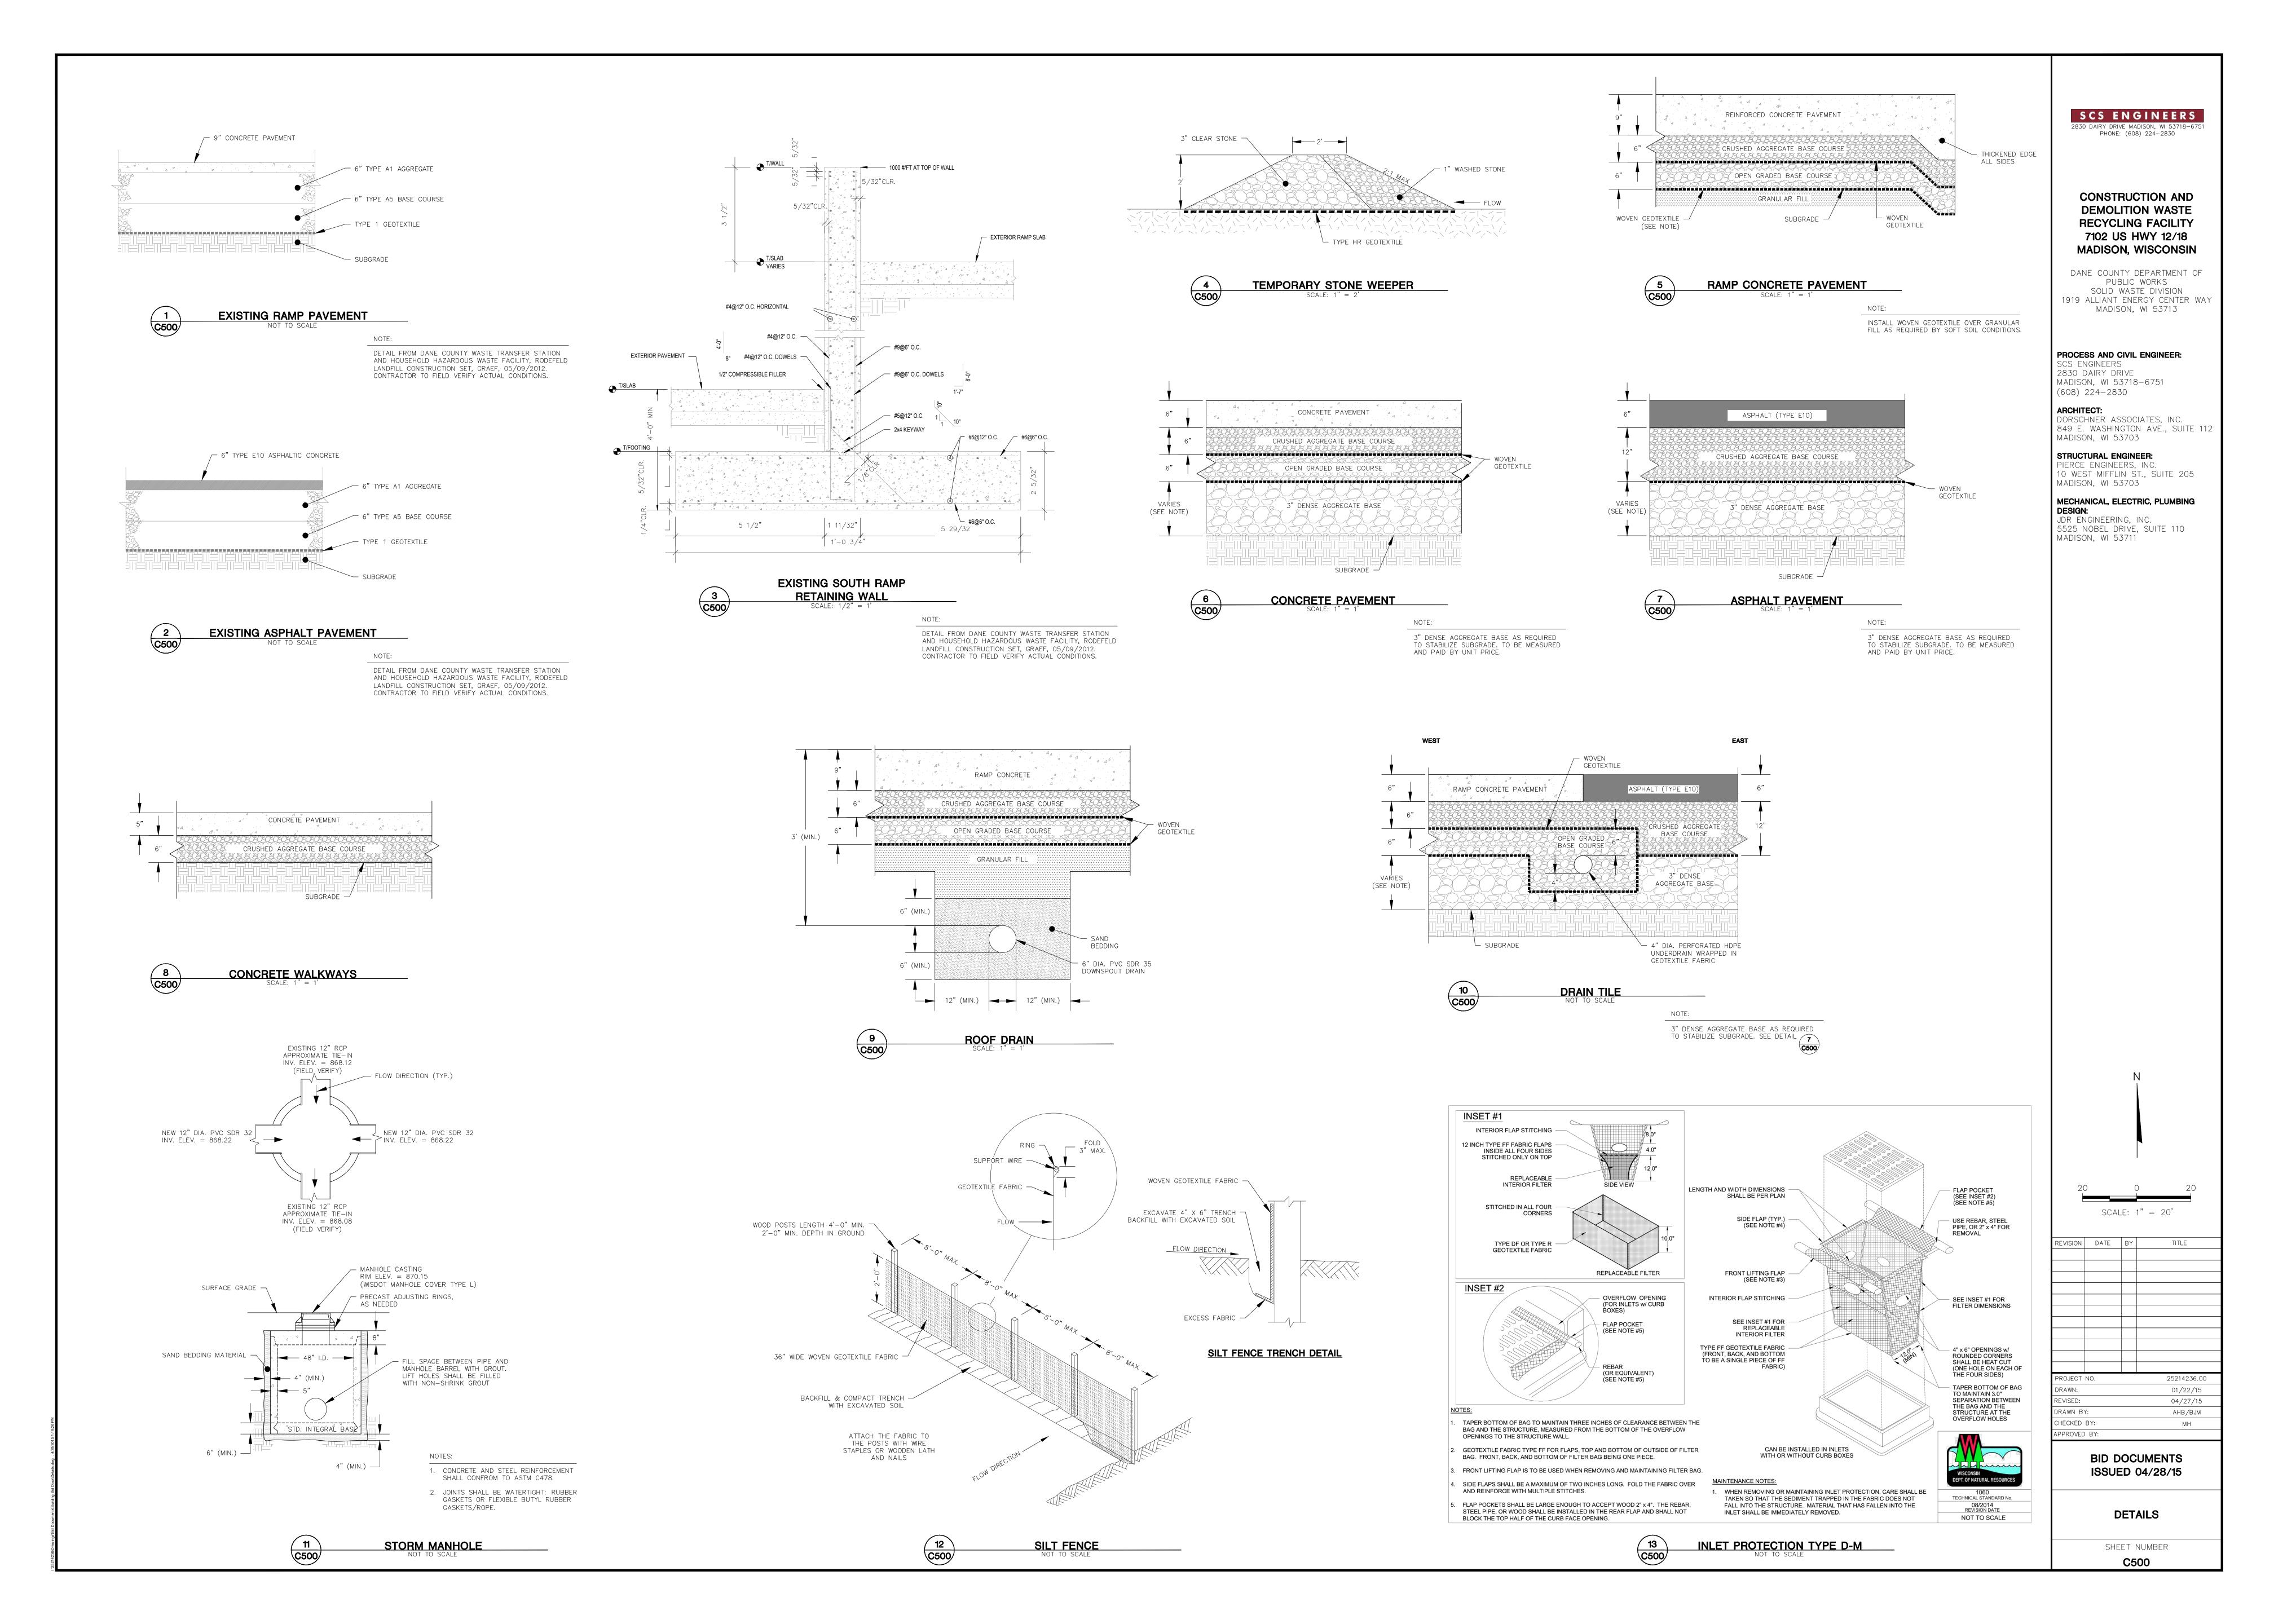
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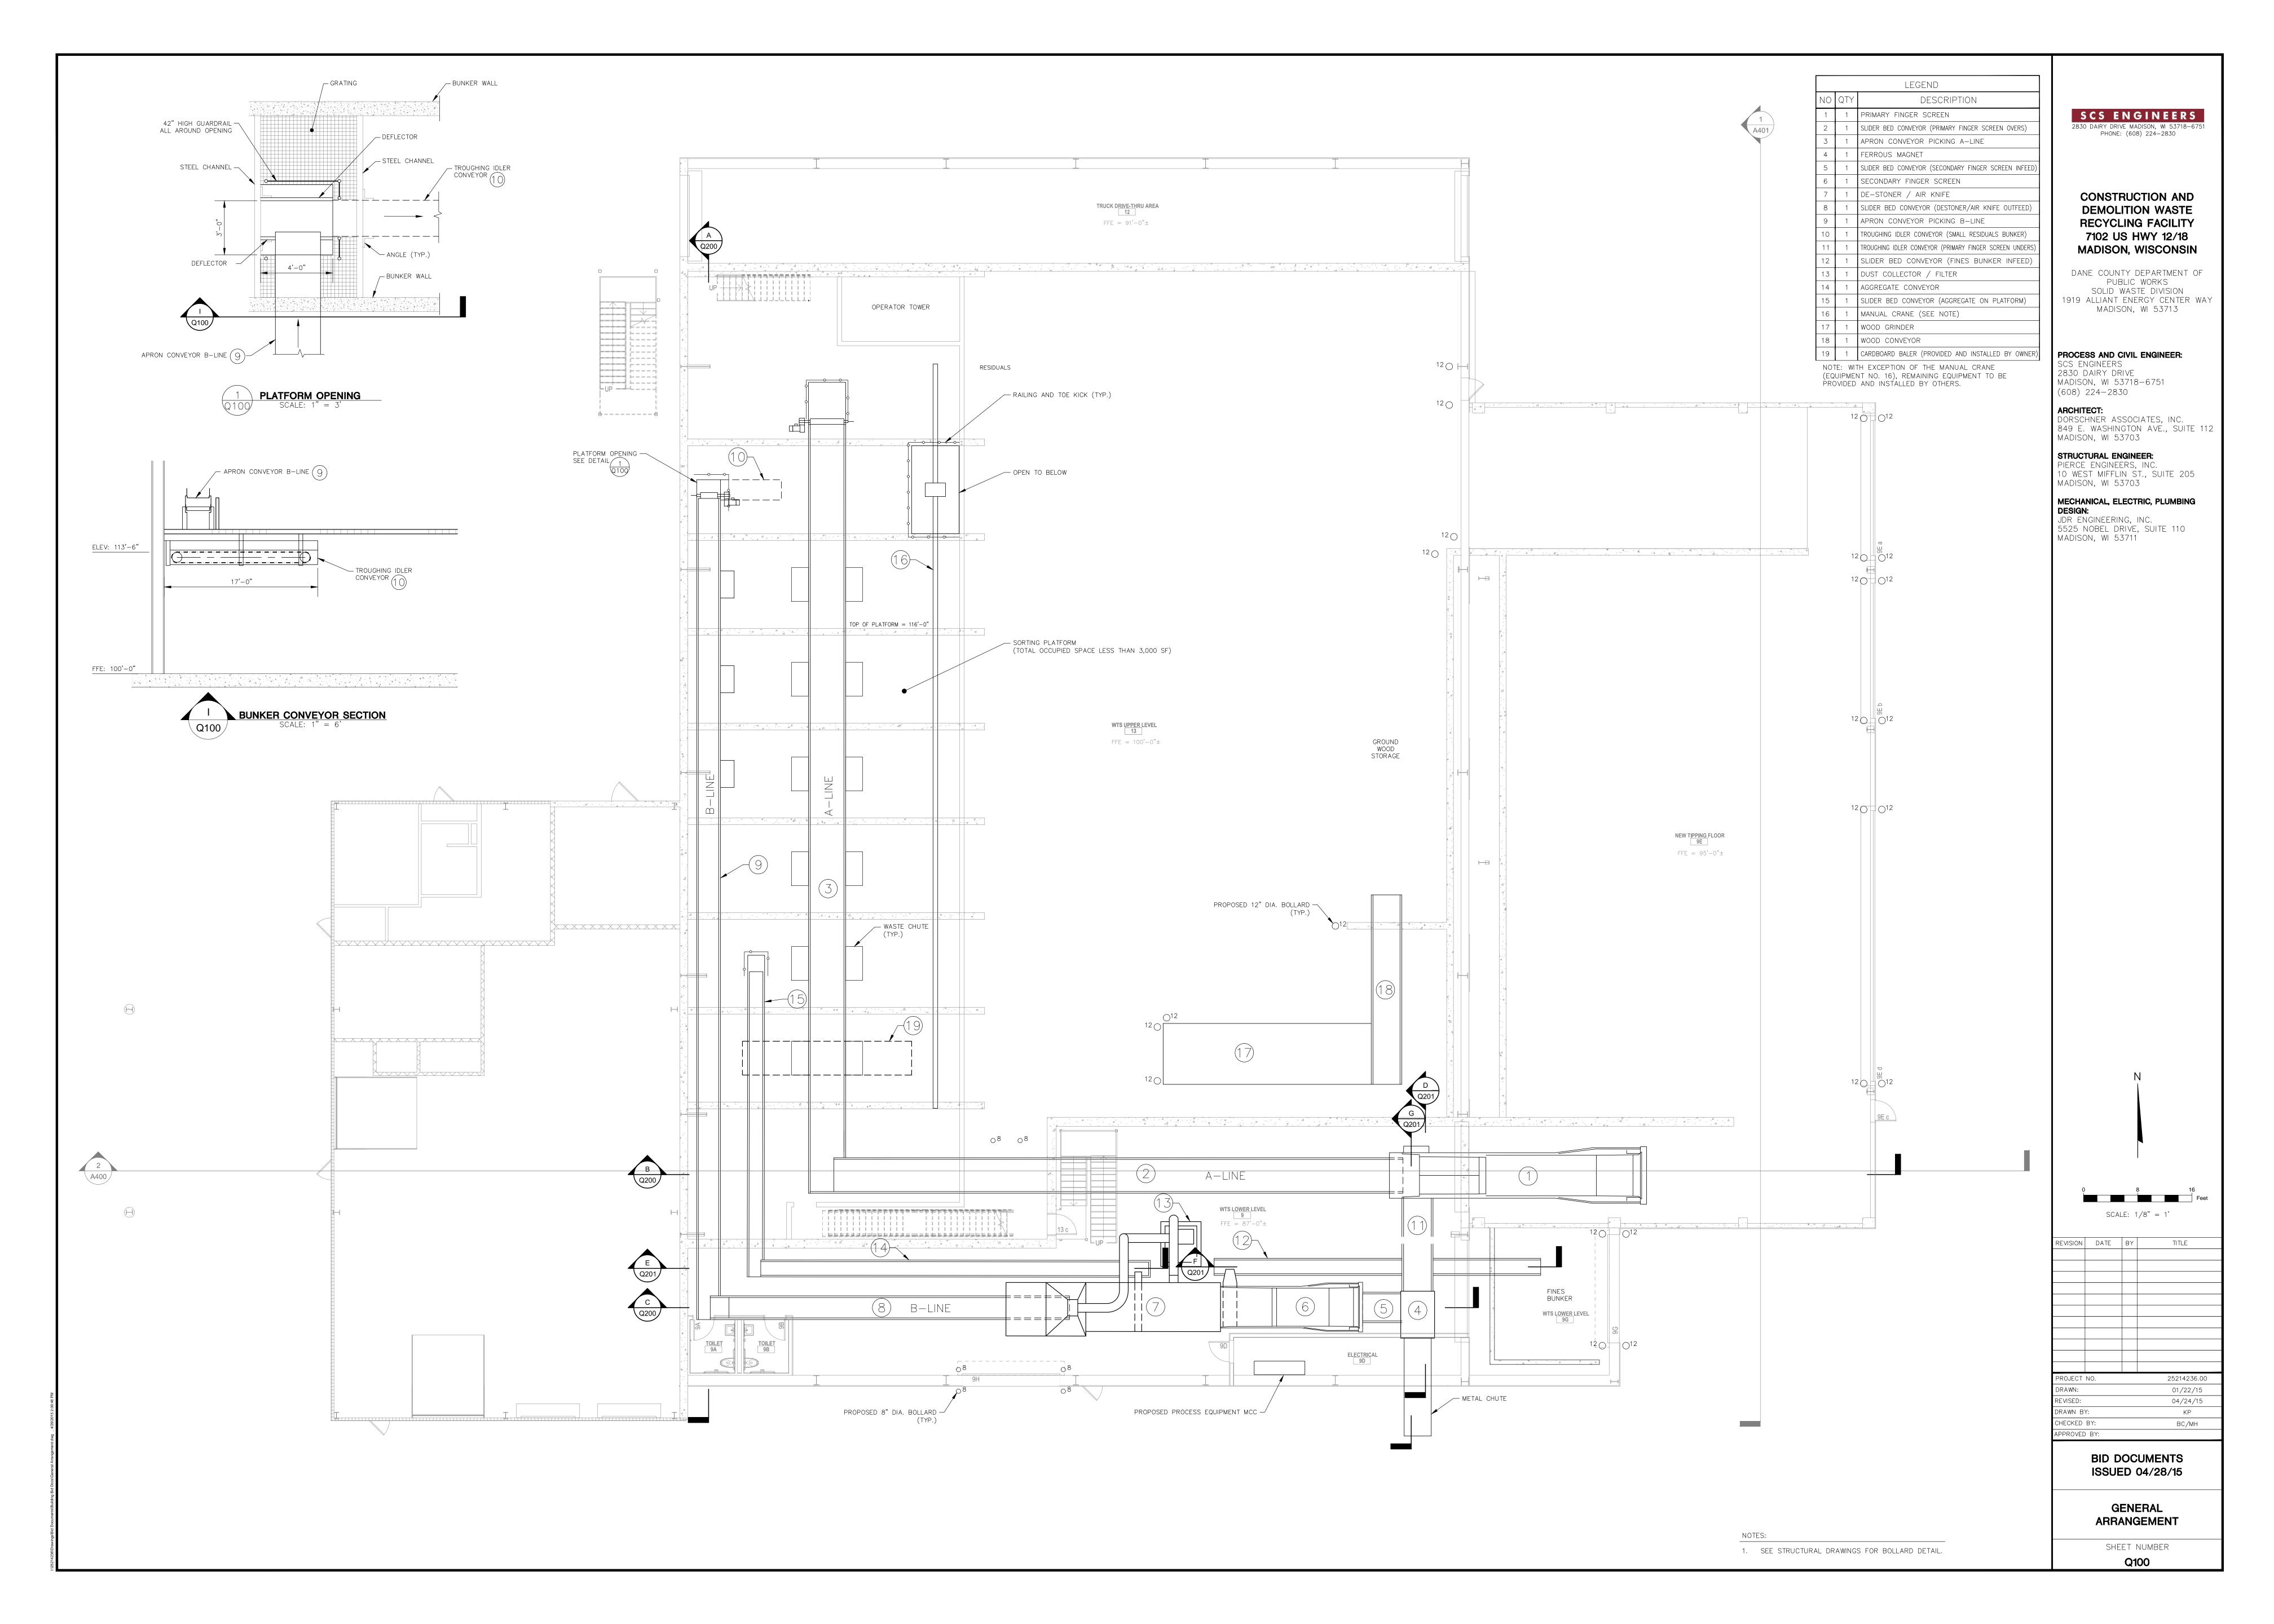










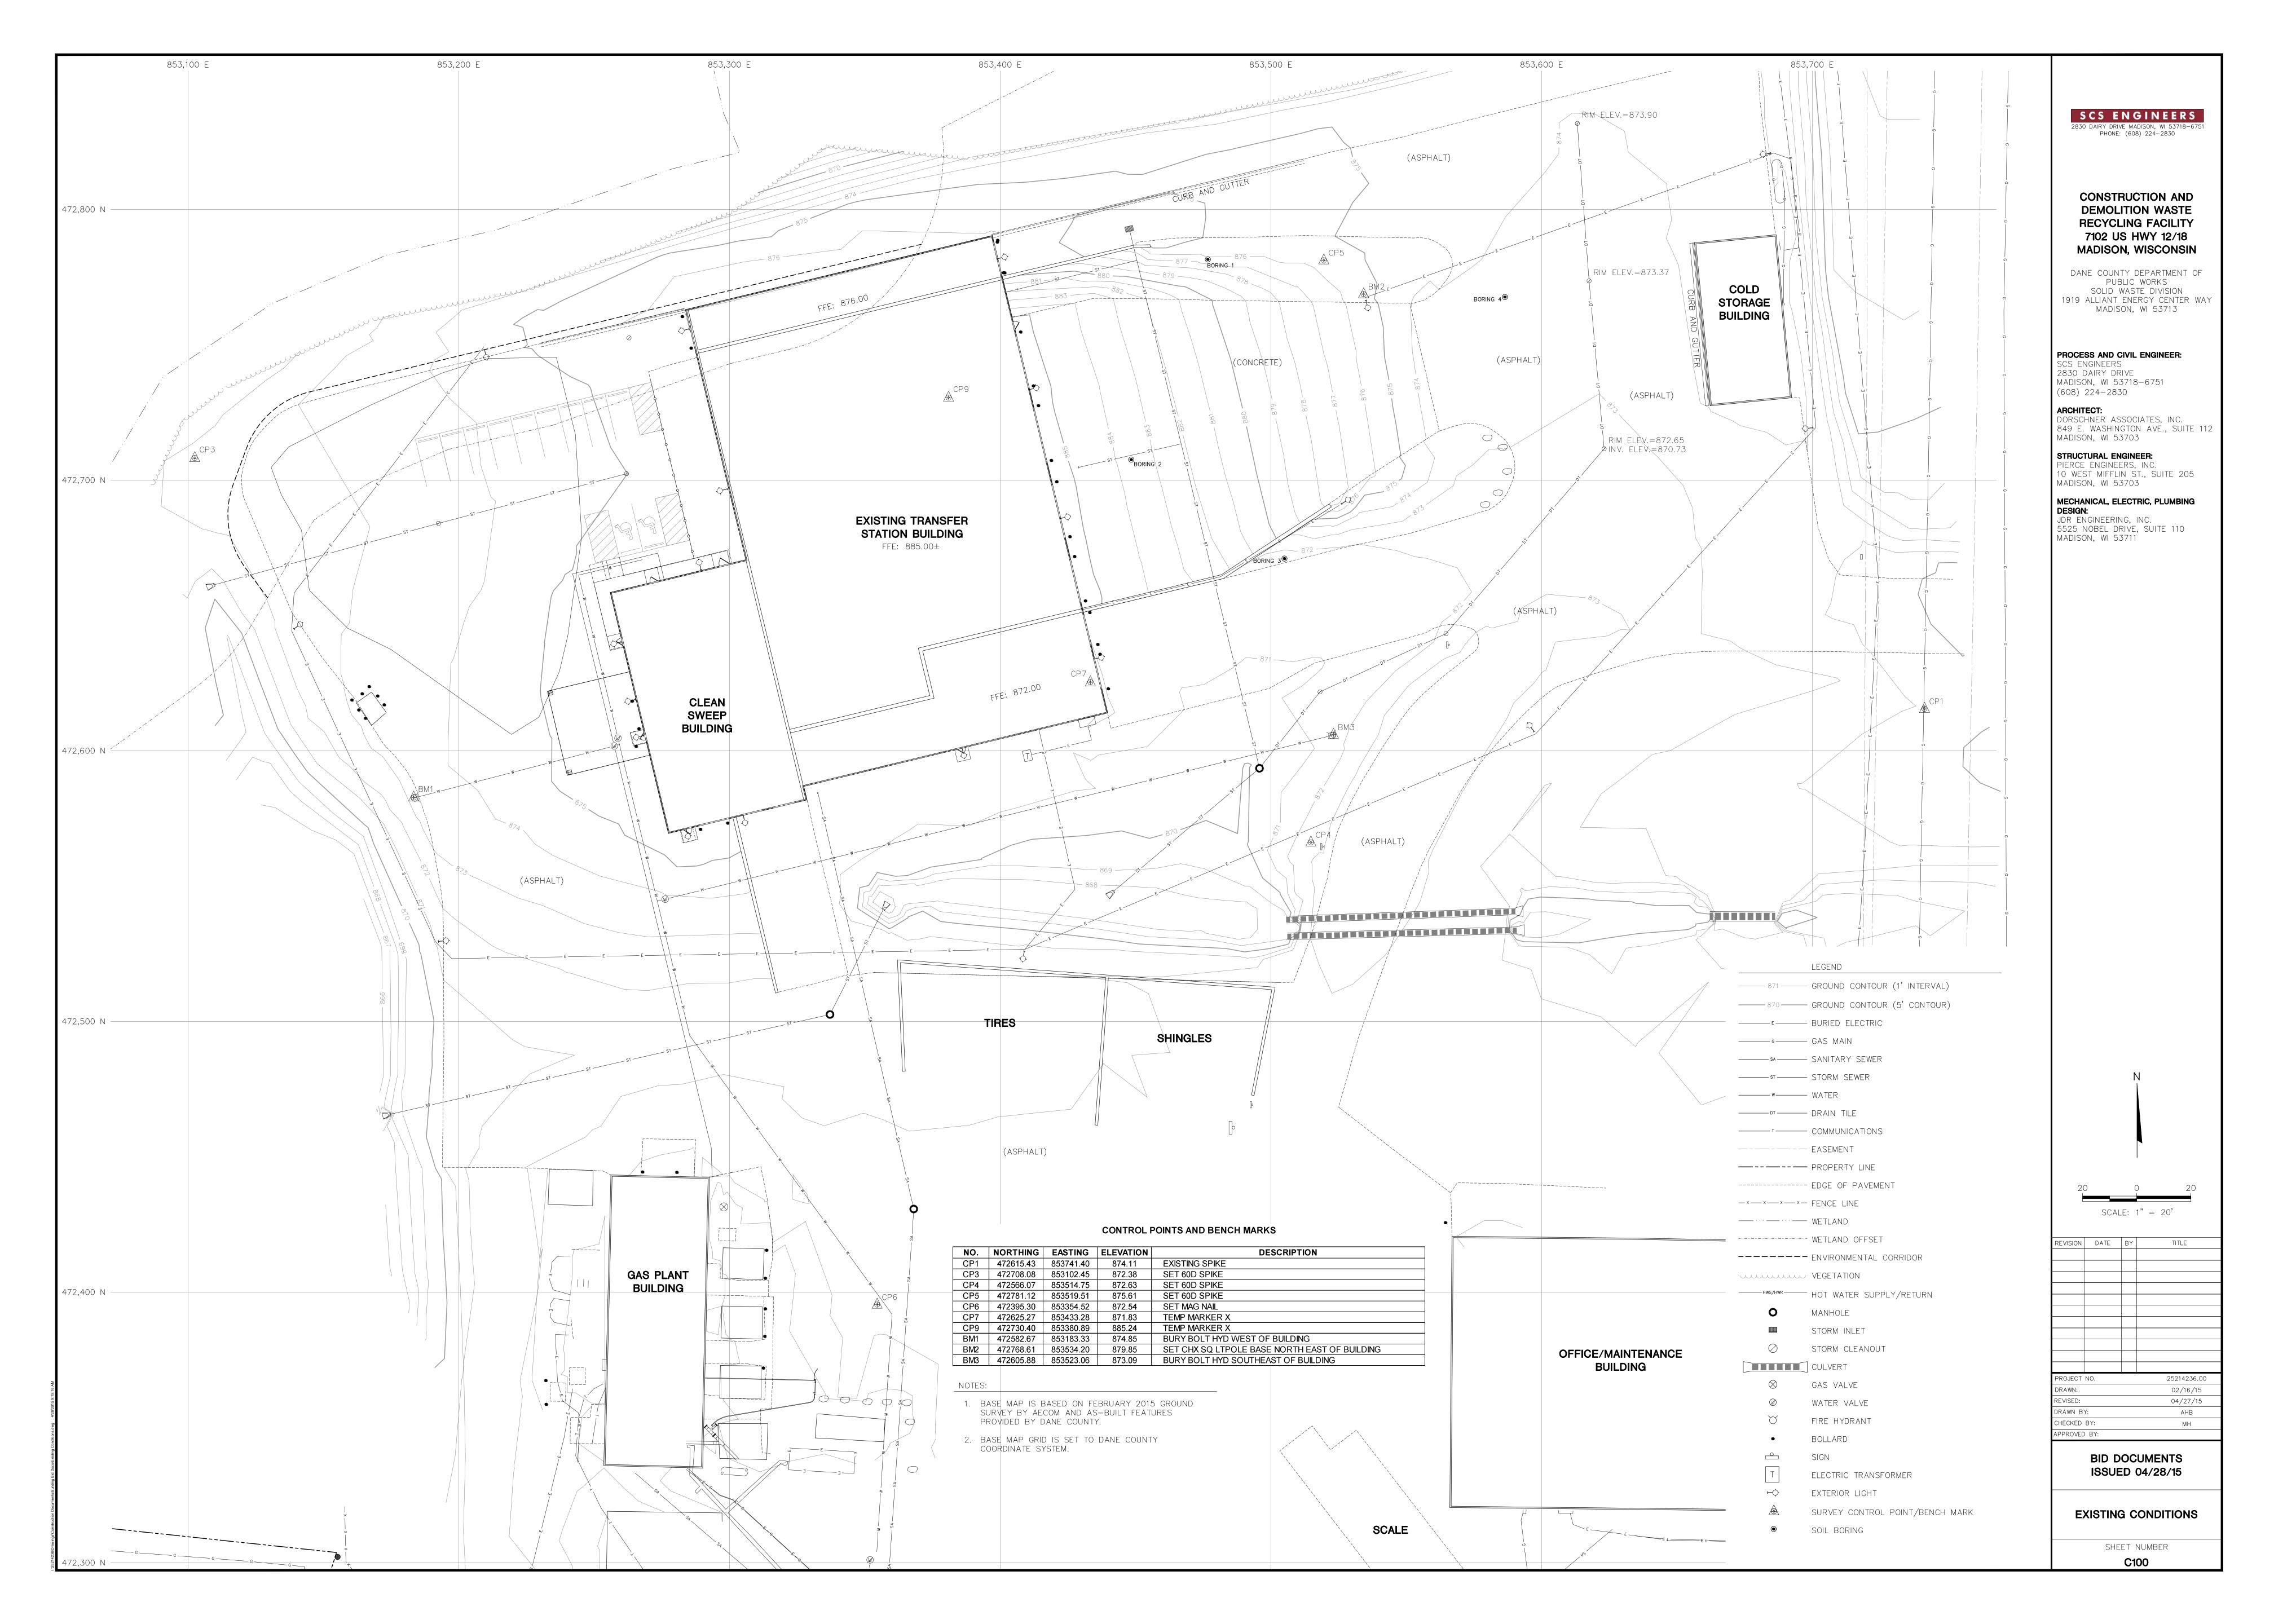


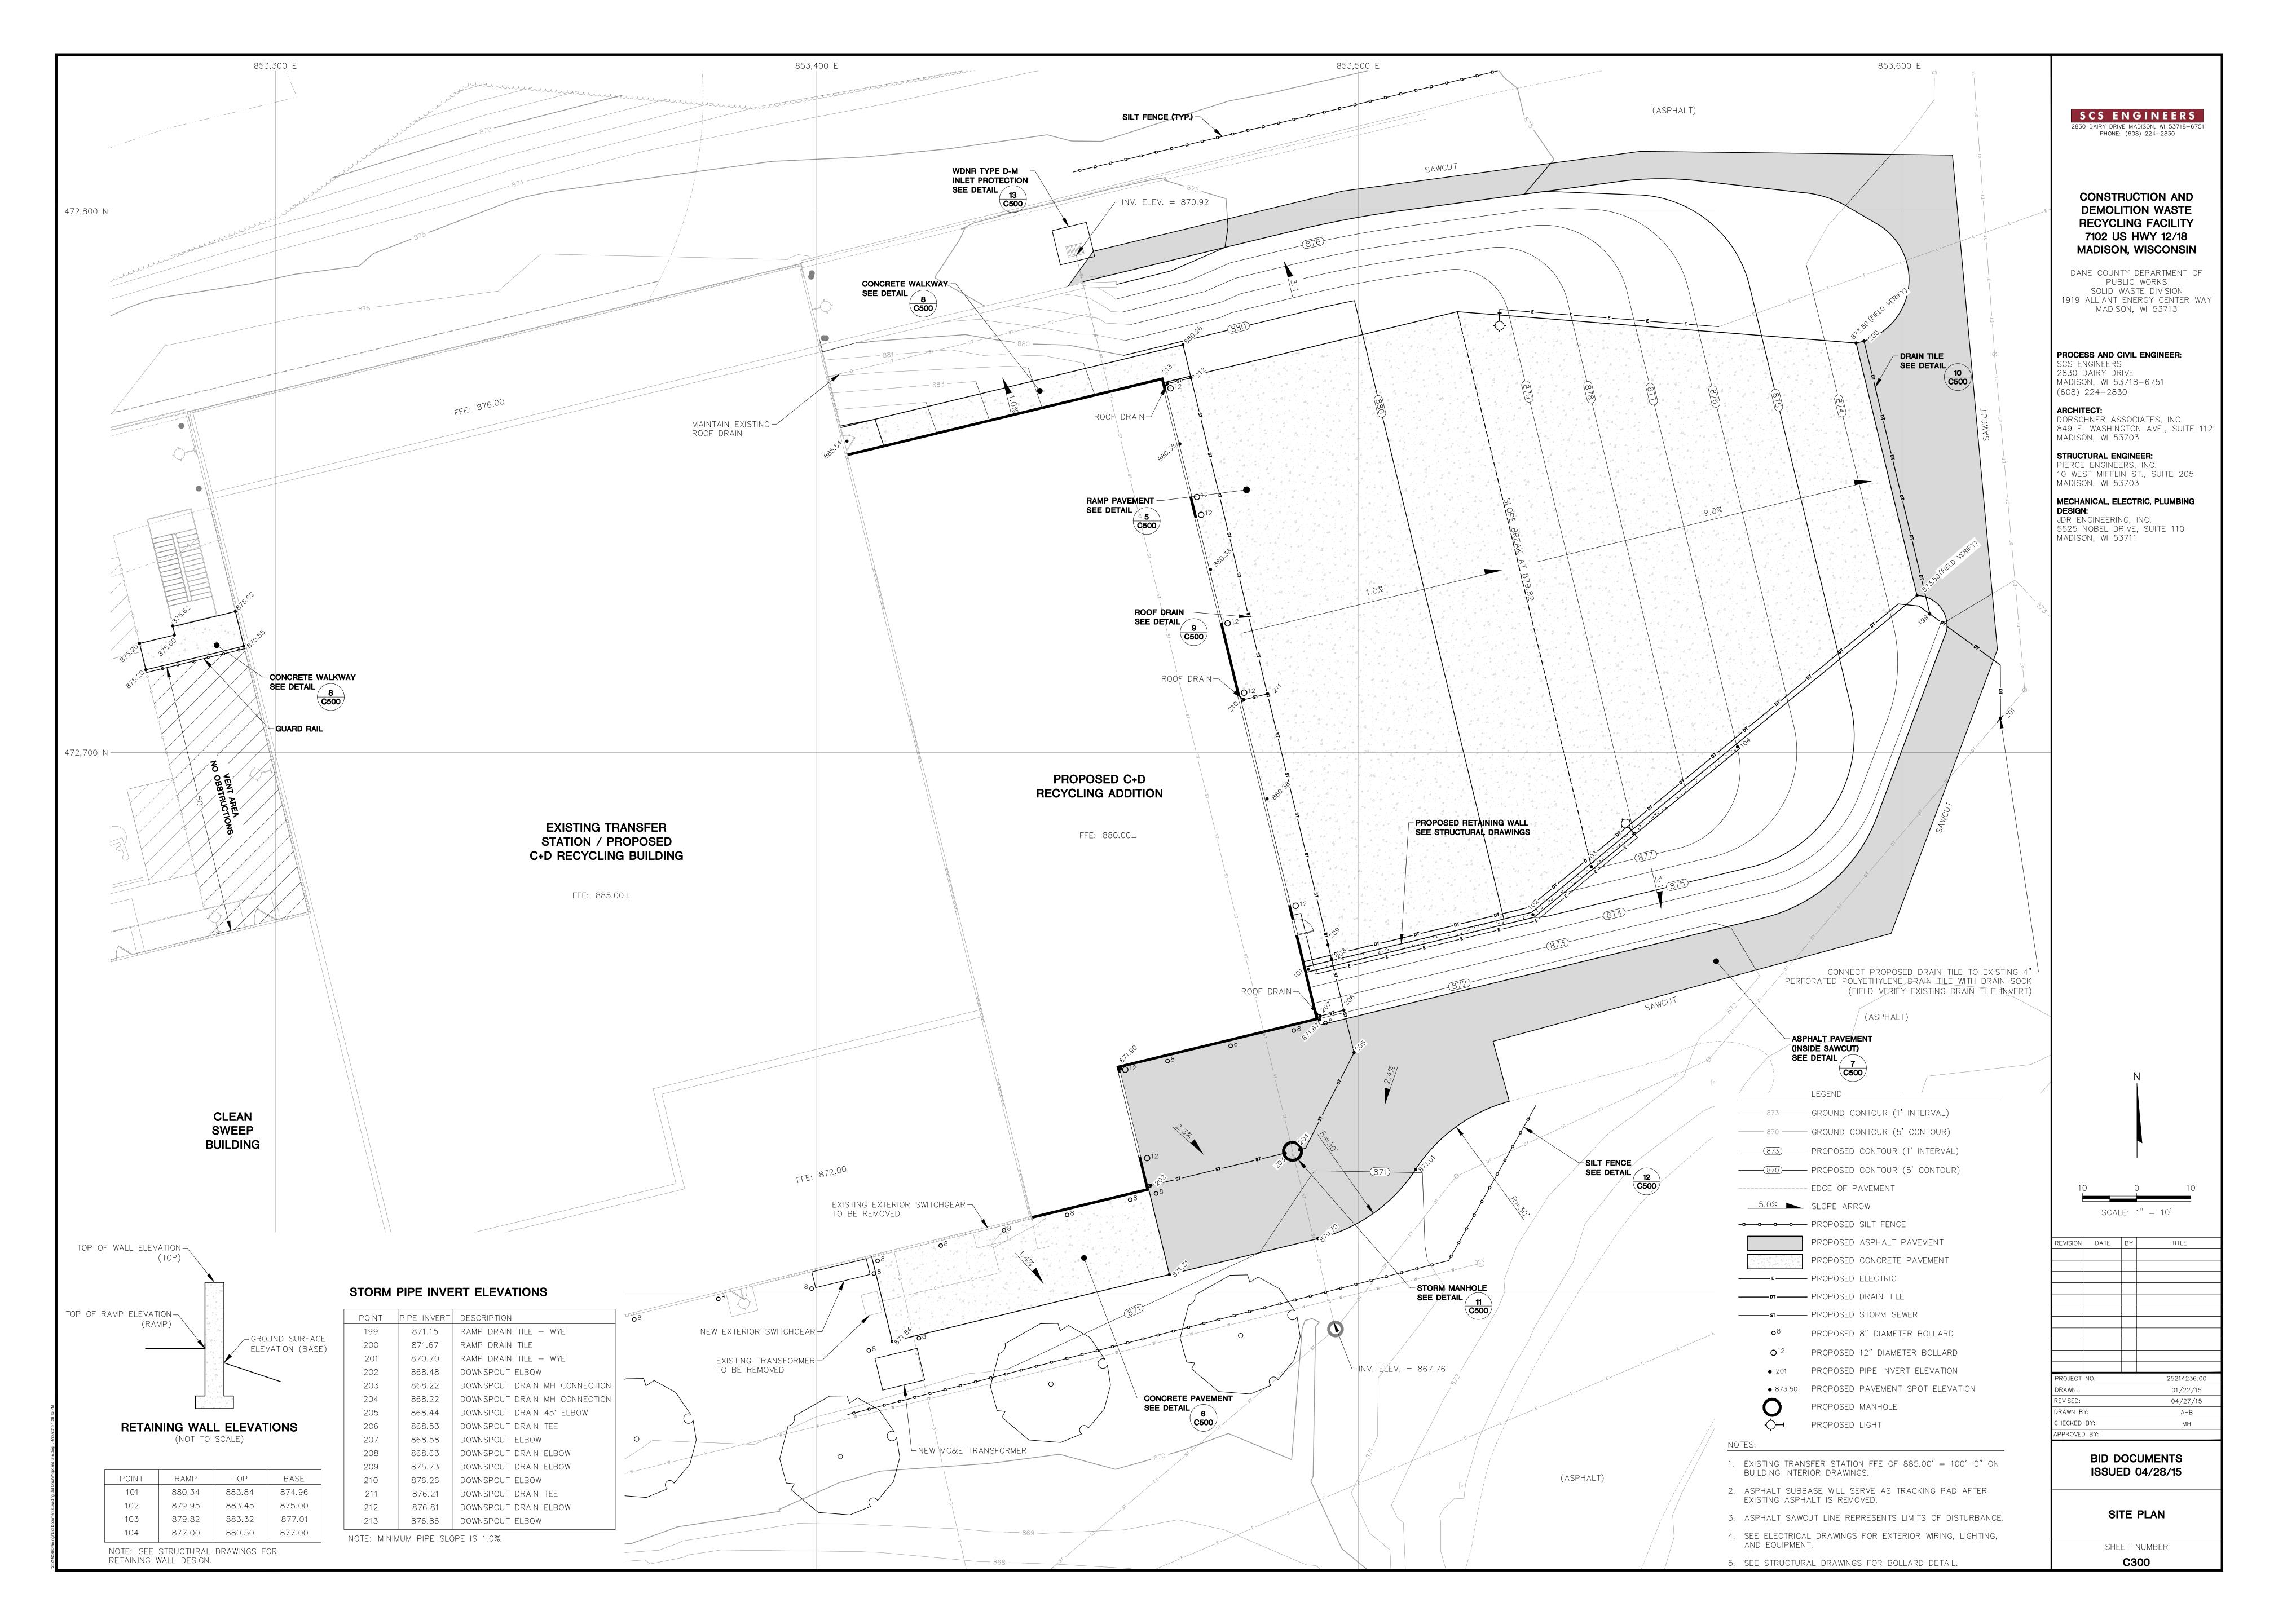

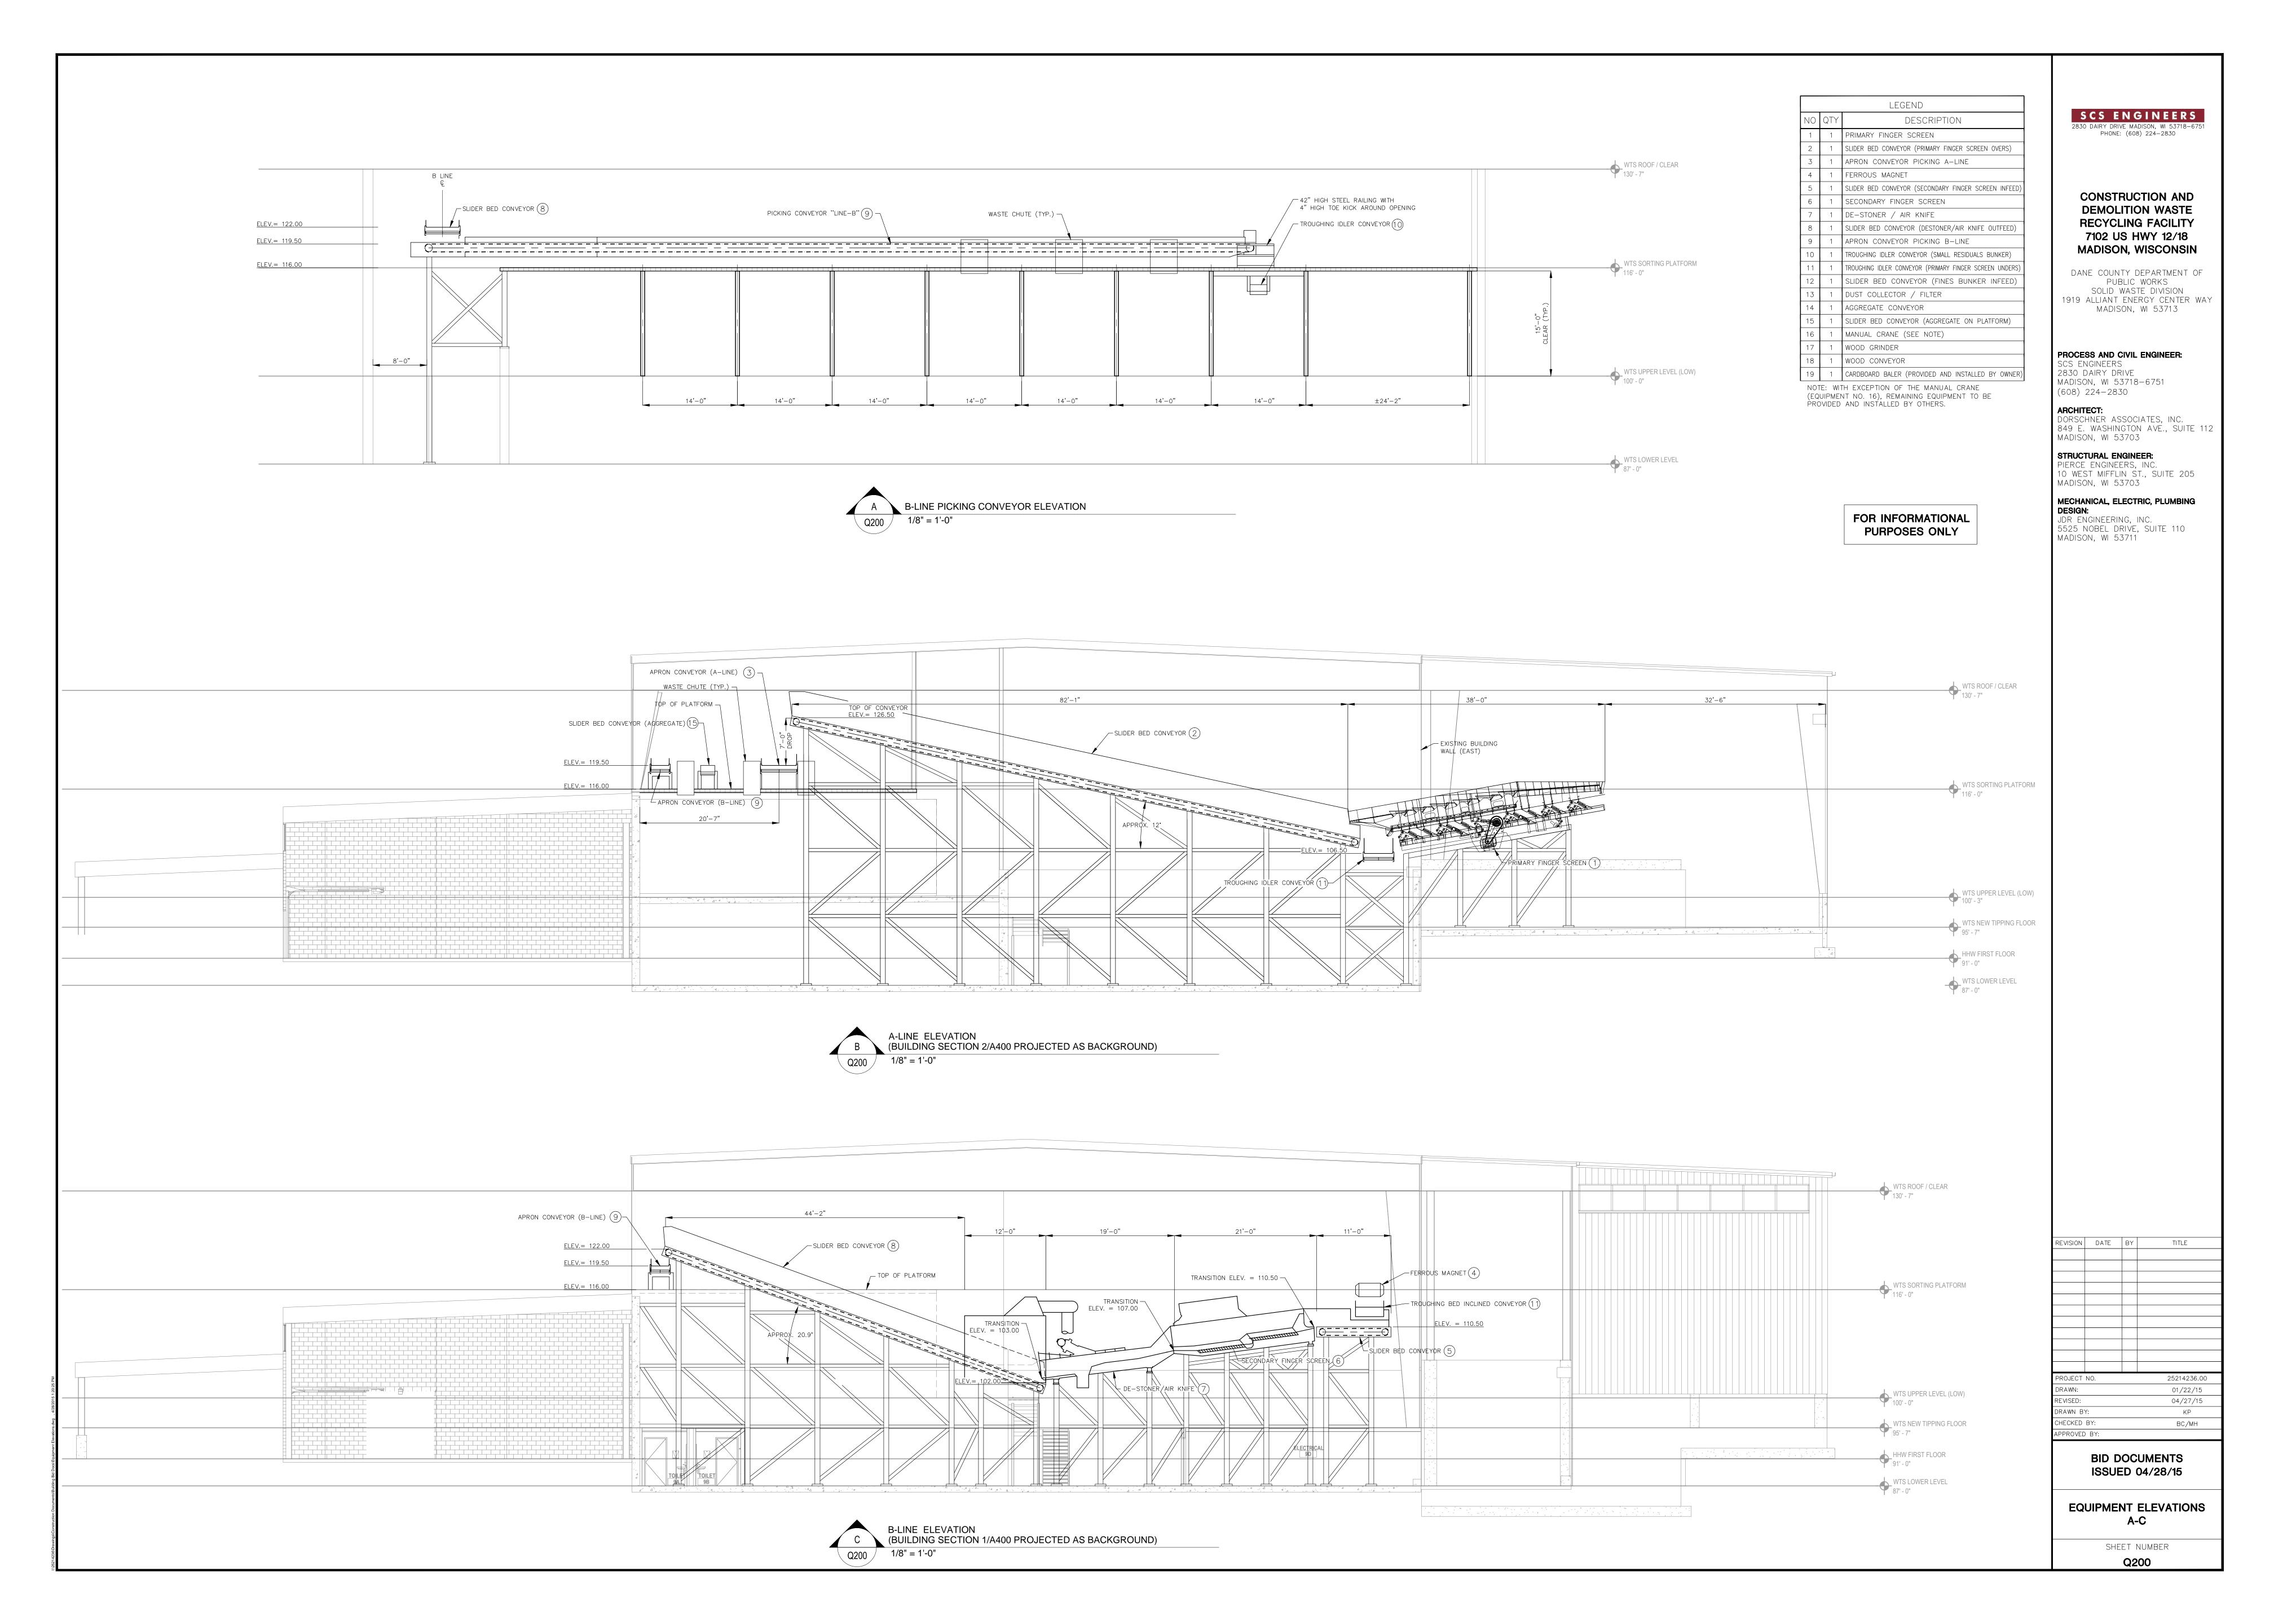


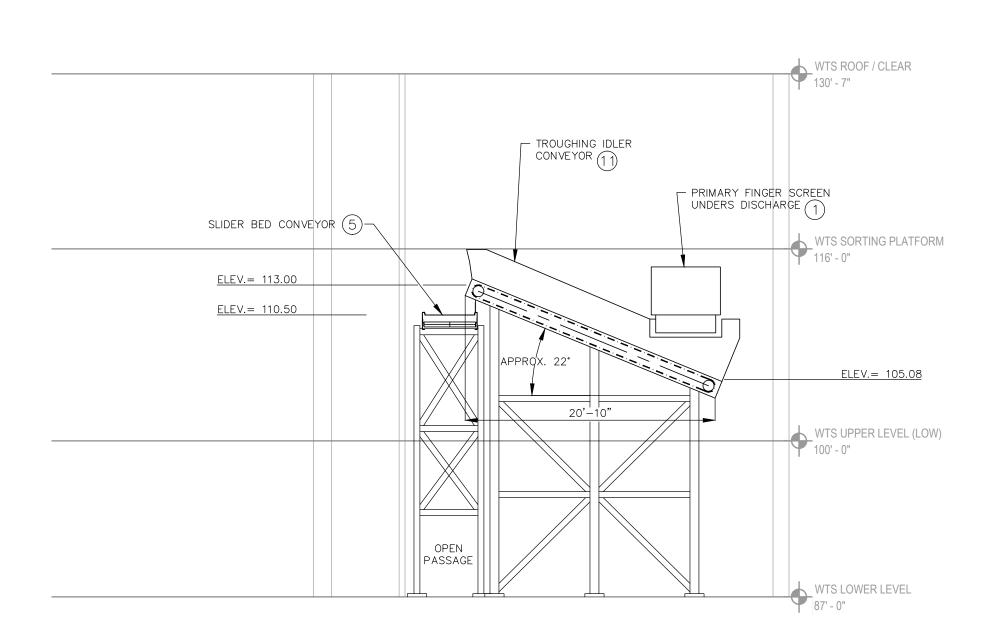




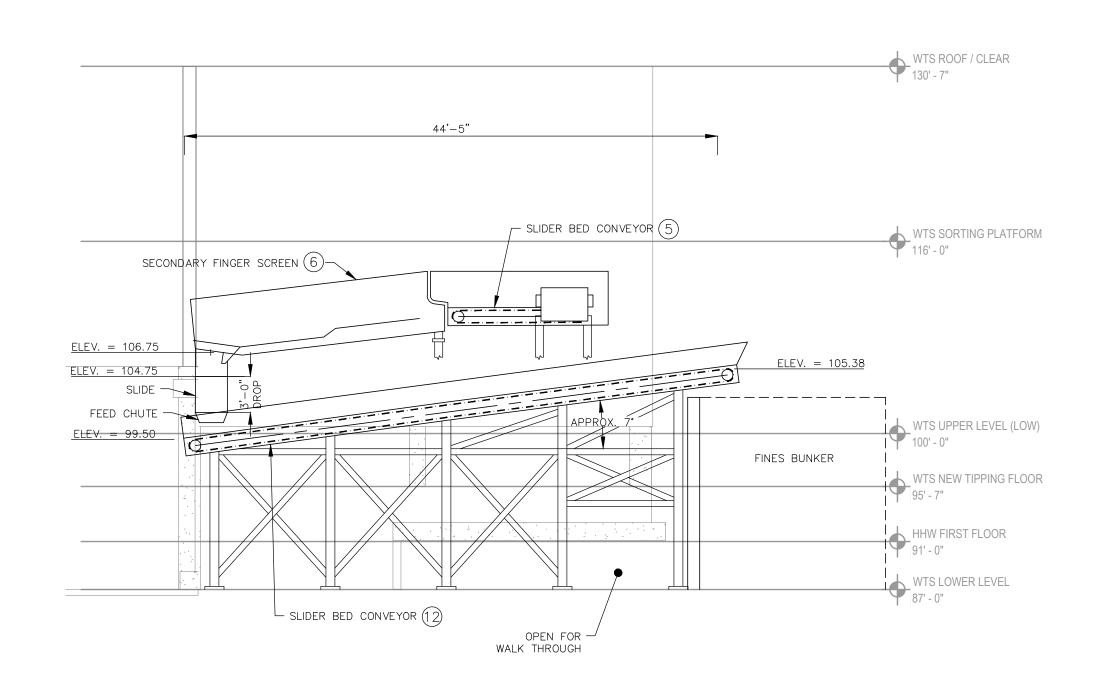



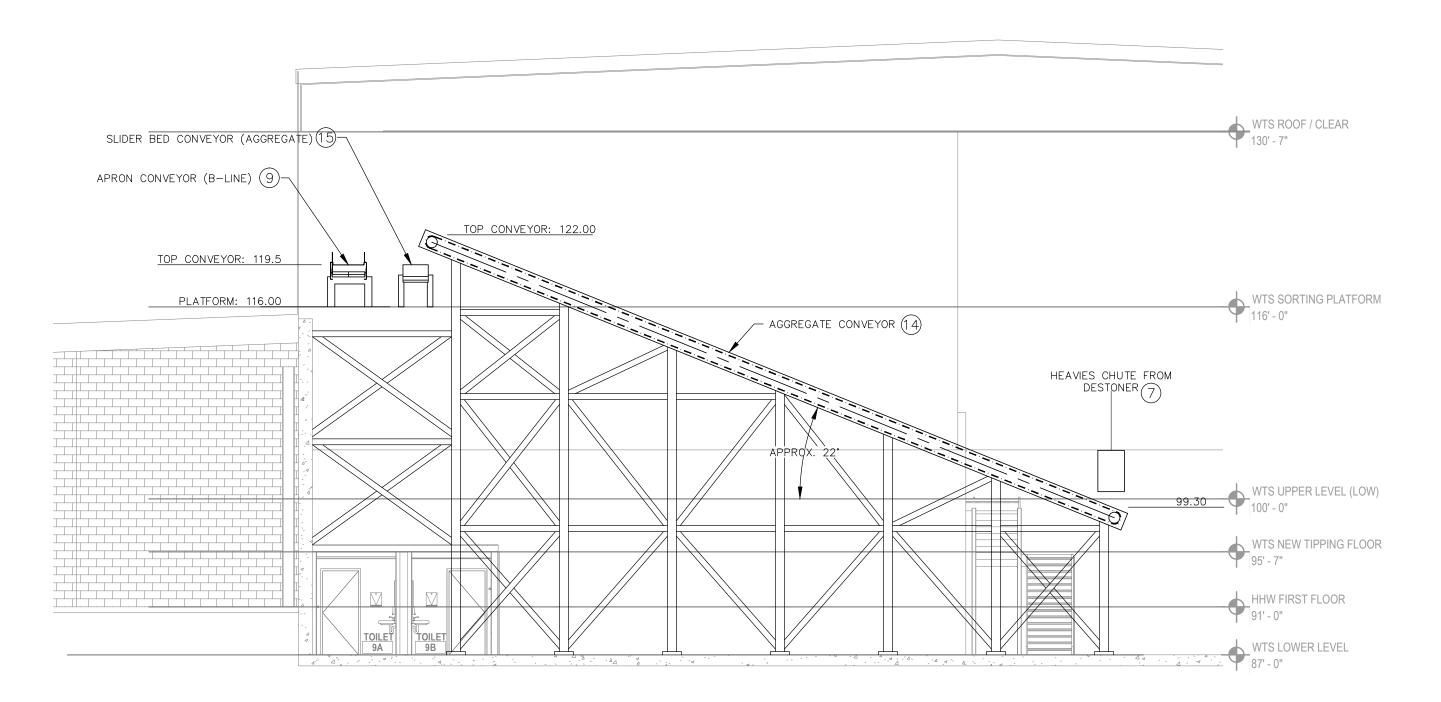





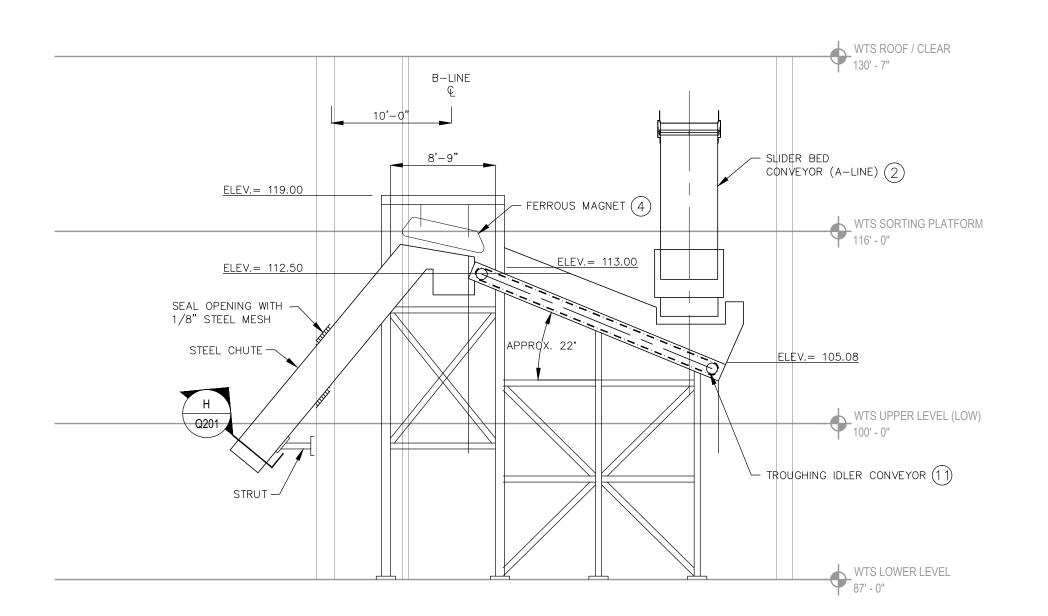

FOR INFORMATIONAL PURPOSES ONLY



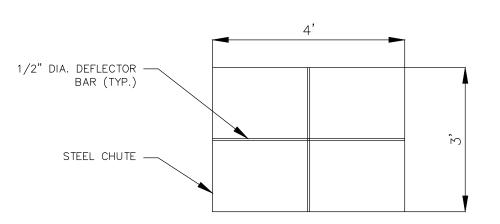

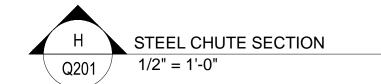

		LEGEND
0	QTY	DESCRIPTION
1	1	PRIMARY FINGER SCREEN
2	1	SLIDER BED CONVEYOR (PRIMARY FINGER SCREEN OVERS)
3	1	APRON CONVEYOR PICKING A-LINE
4	1	FERROUS MAGNET
5	1	SLIDER BED CONVEYOR (SECONDARY FINGER SCREEN INFEED)
6	1	SECONDARY FINGER SCREEN
7	1	DE-STONER / AIR KNIFE
8	1	SLIDER BED CONVEYOR (DESTONER/AIR KNIFE OUTFEED)
9	1	APRON CONVEYOR PICKING B-LINE
0	1	TROUGHING IDLER CONVEYOR (SMALL RESIDUALS BUNKER)
11	1	TROUGHING IDLER CONVEYOR (PRIMARY FINGER SCREEN UNDERS)

SLIDER BED CONVEYOR (DESTONER/AIR KNIFE OUTFEED)		
APRON CONVEYOR PICKING B-LINE	PROJECT NO.	25214236.00
TROUGHING IDLER CONVEYOR (SMALL RESIDUALS BUNKER)	DRAWN:	01/22/15
TROUGHING IDLER CONVEYOR (PRIMARY FINGER SCREEN UNDERS)	REVISED:	04/27/15
SLIDER BED CONVEYOR (FINES BUNKER INFEED)	DRAWN BY:	KP
	CHECKED BY:	BC/MH
DUST COLLECTOR / FILTER	APPROVED BY:	

REVISION DATE BY

SCS ENGINEERS 2830 DAIRY DRIVE MADISON, WI 53718-6751 PHONE: (608) 224-2830

CONSTRUCTION AND **DEMOLITION WASTE** RECYCLING FACILITY

7102 US HWY 12/18

MADISON, WISCONSIN

DANE COUNTY DEPARTMENT OF PUBLIC WORKS

SOLID WASTE DIVISION

1919 ALLIANT ENERGY CENTER WAY

MADISON, WI 53713

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MADISON, WI 53718-6751

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MECHANICAL, ELECTRIC, PLUMBING

JDR ENGINEERING, INC. 5525 NOBEL DRIVE, SUITE 110 MADISON, WI 53711

(608) 224-2830

MADISON, WI 53703

AGGREGATE CONVEYOR BID DOCUMENTS SLIDER BED CONVEYOR (AGGREGATE ON PLATFORM) ISSUED 04/28/15 MANUAL CRANE (SEE NOTE)

WOOD GRINDER WOOD CONVEYOR CARDBOARD BALER (PROVIDED AND INSTALLED BY OWNER)

NOTE: WITH EXCEPTION OF THE MANUAL CRANE (EQUIPMENT NO. 16), REMAINING EQUIPMENT TO BE PROVIDED AND INSTALLED BY OTHERS. SHEET NUMBER Q201

EQUIPMENT ELEVATIONS

ABBREVIATIONS

- ANCHOR BOLT - HEAT STRENGTHEND (GLASS) - AIR CONDITIONING - HOLLOW METAL (STEEL FRAME) - ACCESSIBLE HNDRL - HANDRAIL - ACOUSTICAL - HOLD-OPEN HORIZ - HORIZONTAL - AREA DRAIN ADD - ADDITIONAL - HIGH POINT - ADJUSTABLE HRC - HOSE REEL CABINET - ABOVE FINISH FLOOR - HOUR - AGGREGATE HVAC - HEATING, VENTILATION, AIR CONDITIONING - ALTERNATE ALUM - ALUMINUM - HOT WATER - ANCHOR HYDR - HYDRAULIC ANCH - ANODIZED ANNO - INSIDE DIAMETER - ACCESS PANEL APC - ACOUSTICAL PANEL CEILING APPD - APPROVED INCAND - INCANDESCENT - APPROXIMATE APPROX INCL - INCLUDED / INCLUDING - ARCHITECTURAL - INFORMATION ATC - ACOUTSTICAL TILE CEILING INSUL - INSULATION - AUTOMATIC - INTERIOR AUTO INTERM - AUDIO VISUAL - INTERMEDIATE - BRICK EXPANSION JOINT - INTERNATIONAL PIPE STANDARD - INVERTED ROOF MEMBRANE ASSEMBLY - BOARD - BUILDING - BLOCK - JANITOR'S CLOSET - BEAM BOT - BOTTOM - JOIST - BRICK - JOINT BSMT - BASEMENT - KIP (1000 LBF) - BOLT - BUILT-UP ROOFING - KICK PLATE KILOGRAM - KITCHEN - CATEGORY - KNOCKOUT - CATCH BASIN - LONG OR LITER (METRIC DOCS) - CHALK BOARD - CEMENTITIOUS BACKER UNIT - LABORATORY CEM - CEMENT - LANDING - LAMINATE / LAMINATION CER - CERAMIC - CORNER GUARD - LAVATORY - CHILLER - POUND CHAN - LINEAR FOOT - CHANNEL CHW - CLOTHES HOOK MOUNTED ON WALL - LOCKER - CAST IRON - LONG LEG HORIZONTAL - CAST-IN-PLACE - LONG LEG VERTICAL - CONTROL JOINT / CONSTRUCTION JOINT - CENTER LINE - CEILING - LOW POINT CMU CNTR - CONCRETE MASONRY UNIT - METER, MIRROR MACH - COUNTER - MACHINE - CLEANOUT MAINT - MAINTENANCE MAS - COLUMN - MASONRY - COMPARTMENT COMPART - MATERIAL CONC - CONCRETE - MAXIMUM COND - CONDITION - MACHINE BOLT CONN - CONNECTION - MARBLE CONT - CONTINUOUS - MEDIUM DENSITY FIBERBOARD CONTR - CONTRACTOR - MECHANICAL, ELECTRICAL, PLUMBING COORD - COORDINATE - MEDIUM DENSITY OVERLAY PLYWOOD CORR - CORRIDOR MECH - MECHANICAL MEMB - CERAMIC TILE / COOLING TOWER - MEMBRANE CTR - CENTER - METAL - COUNTER SUNK - MEZZANINE - COLD WATER (PIPING) - MANUFACTURER - MANHOLE - DEEP, DEPTH - MINIMUM - DISABLED - MISCELLANEOUS - DEGREE - MASONRY OPENING DEMO - DEMOLITION - MACHINE SCREW - DEPARTMENT - MOUNTED - DETAIL - MOUNTING - DRINKING FOUNTAIN - METAL - DIAMETER - MULLION - DIFFUSER - NORTH - DIMENSION - DISABLED - NOT APPLICABLE - NOISE CRITERIA - DISPENSER - DAMPPROOFING - NOT IN CONTRACT - DEMOUNTABLE - NUMBER - DOWN - NOMINAL - DOOR OPENING - NOT TO SCALE - DIMENSION POINT - OUTSIDE AIR - DEMOUNTABLE PARTITION - ON CENTER - DOOR - DRAIN OCEW - ON CENTER EACH WAY - DOWNSPOUT - OUTSIDE DIAMETER/DIMENSION OWNER FURNISHED. CONTR INSTALLED - DISHWASHER OFOI - OWNER FURNISHED, OWNER INSTALLED - DRAWING - DRAWER - OVER HEAD - EXISTING - OPPOSITE HAND - EAST OPNG - OPENING - EACH - OPPOSITE OPPHD ORD OUTS - EXPANSION BOLT - OPPOSITE HAND - ELECTRIC HAND DRYER - OVERFLOW ROOF DRAIN - EXTERIOR INSULATION AND FINISH SYSTEM - OUTSIDE OVHD - EXTERIOR FINISH SYSTEM - OVERHEAD - EXPANSION JOINT - PAINT - ELEVATION - ELECTRICAL - PAVING - ELEVATOR PARTN - PARTITION PATD **EMERG** - EMERGENCY - PAPER TOWEL DISPENSER - ENCLOSURE - PARTICLEBOARD - ELECTRICAL PANELBOARD - PRECAST CONCRETE - POWER DRIVEN FASTENER - EQUAL - EQUIPMENT - PERFORATED PERIM PERP **ESCAL** - ESCALATOR - PERIMETER - ELECTRIC TOWEL DISPENSER - PERPENDICULAR - ELECTRIC WATER COOLER - POINT OF INTERSECTION EXH - EXHAUST - EXPANSION PLAM - PLASTIC LAMINATE - EXISTING - PLASTER - EXTERIOR PLBG - PLUMBING - POUNDS PER LINEAR FOOT - FIRE ALARM PLYWD - PLYWOOD - FACE BRICK - PANEL - POLISHED - FACE - FLOOR DRAIN - FIRE DEPARTMENT CONNECTION PREFAB - PREFABRICATED - FOUNDATION - FIRE EXTINGUISHER PSF - POUNDS PER SQUARE FOOT - FIRE EXTINGUISHER CABINET - PAINTED PTD - FURNITURE, FINISHES & EQUIPMENT FFEL - PARTITION - FINISH FLOOR ELEVATION PTN - FLAT HEAD - PAPER TOWEL RECEPTACLE - FIRE HOSE CABINET - QUARRY TILE - FIXTURE QUANTITY - FLOOR - RELOCATED - FLASHING - FLUORESCENT - RADIUS OR RISER (PIPING) - FACE OF - RETURN AIR - FIRE PROTECTION - RADIUS - FIREPROOFING - RESILIENT BASE - FRAME - REFLECTED CEILING PLAN - FOLDING SHOWER SEAT - ROOF DRAIN - RECOMMENDED FRTW - FIRE RETARDANT TREATED WOOD RECPT - RECEPTACLE - FOOTING - RECESSED - FURNITURE - REFERENCE - FURRING - REFLECTED / REFLECTIVE / REFLECT - FABRIC WALLCOVERING - REFRIGERATOR - FABRIC WRAPPED PANEL - REGISTER - REINFORCED / REINFORCING REINF - GROUND - RELOCATE - GAUGE / GAGE - REMOVABLE - REQUIRE / REQUIRED - GALVANIZED - GRAB BAR - RESILIENT - GENERAL CONTRACT(OR) - REVISION / REVISED - GLASS FIBER REINFORCED CONCRETE - GLASS - GRADE - RATED RTG - RATING RWL GRD - GROUND - RAIN WATER LEADER - GYPSUM WALLBOARD - SOUTH - HIGH / HEIGHT - SUPPLY AIR - SANITARY - HOSE BIB

- HOLLOW CORE

- HANDICAPPED

- HARDWARE - HARDWOOD

HCP HDW

- SPEAKER

- STATION

- STEEL - STEEL JOIST

- STORAGE - STRINGER

- STRUCTURAL

STRUCTURAL

- SUSPENDED

TOWEL BAR

TOGGLE BOLT

- THICKNESS - THRESHOLD

- THROUGH

- TACKBOARD

- TOP OF PAVEMENT

TRACTION

TELEVISION - TOP OF WALL

TYPICAL

- VESTIBULE

- VESTIBULE

- VAPOR RETARDER

- WIDE, WIDTH/WEST

- WOOD SCREW

WATERPROOFING

- WEATHERSTRIPPING

WORK POINT

- WALL TO WALL

- WATERPROOF MEMBRANE

- WATER RESISTENT/REPELLANT, WASTE RECEPTACLE

- VINYL WALL COVERING

- VERIFY IN FIELD

- VAPOR RETARDER

VINYL WALL COVERING

- VINYL COMPOSITION TILE

TOILET PAPER HOLDER

UNLESS OTHERWISE NOTED

- VINYL COMPOSITION TILE

- VENTILATION AND AIR CONDITIONING


- VENTILATION AND AIR CONDITIONING


- TOP OF (SEE OTHER WORD)


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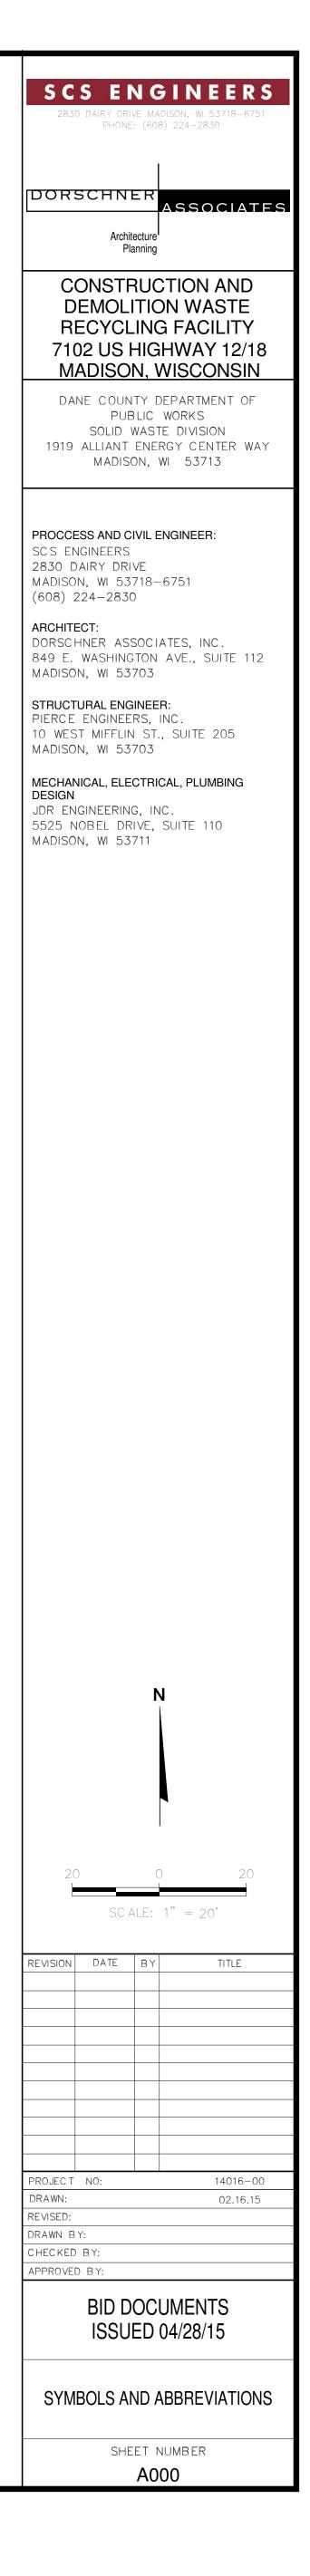
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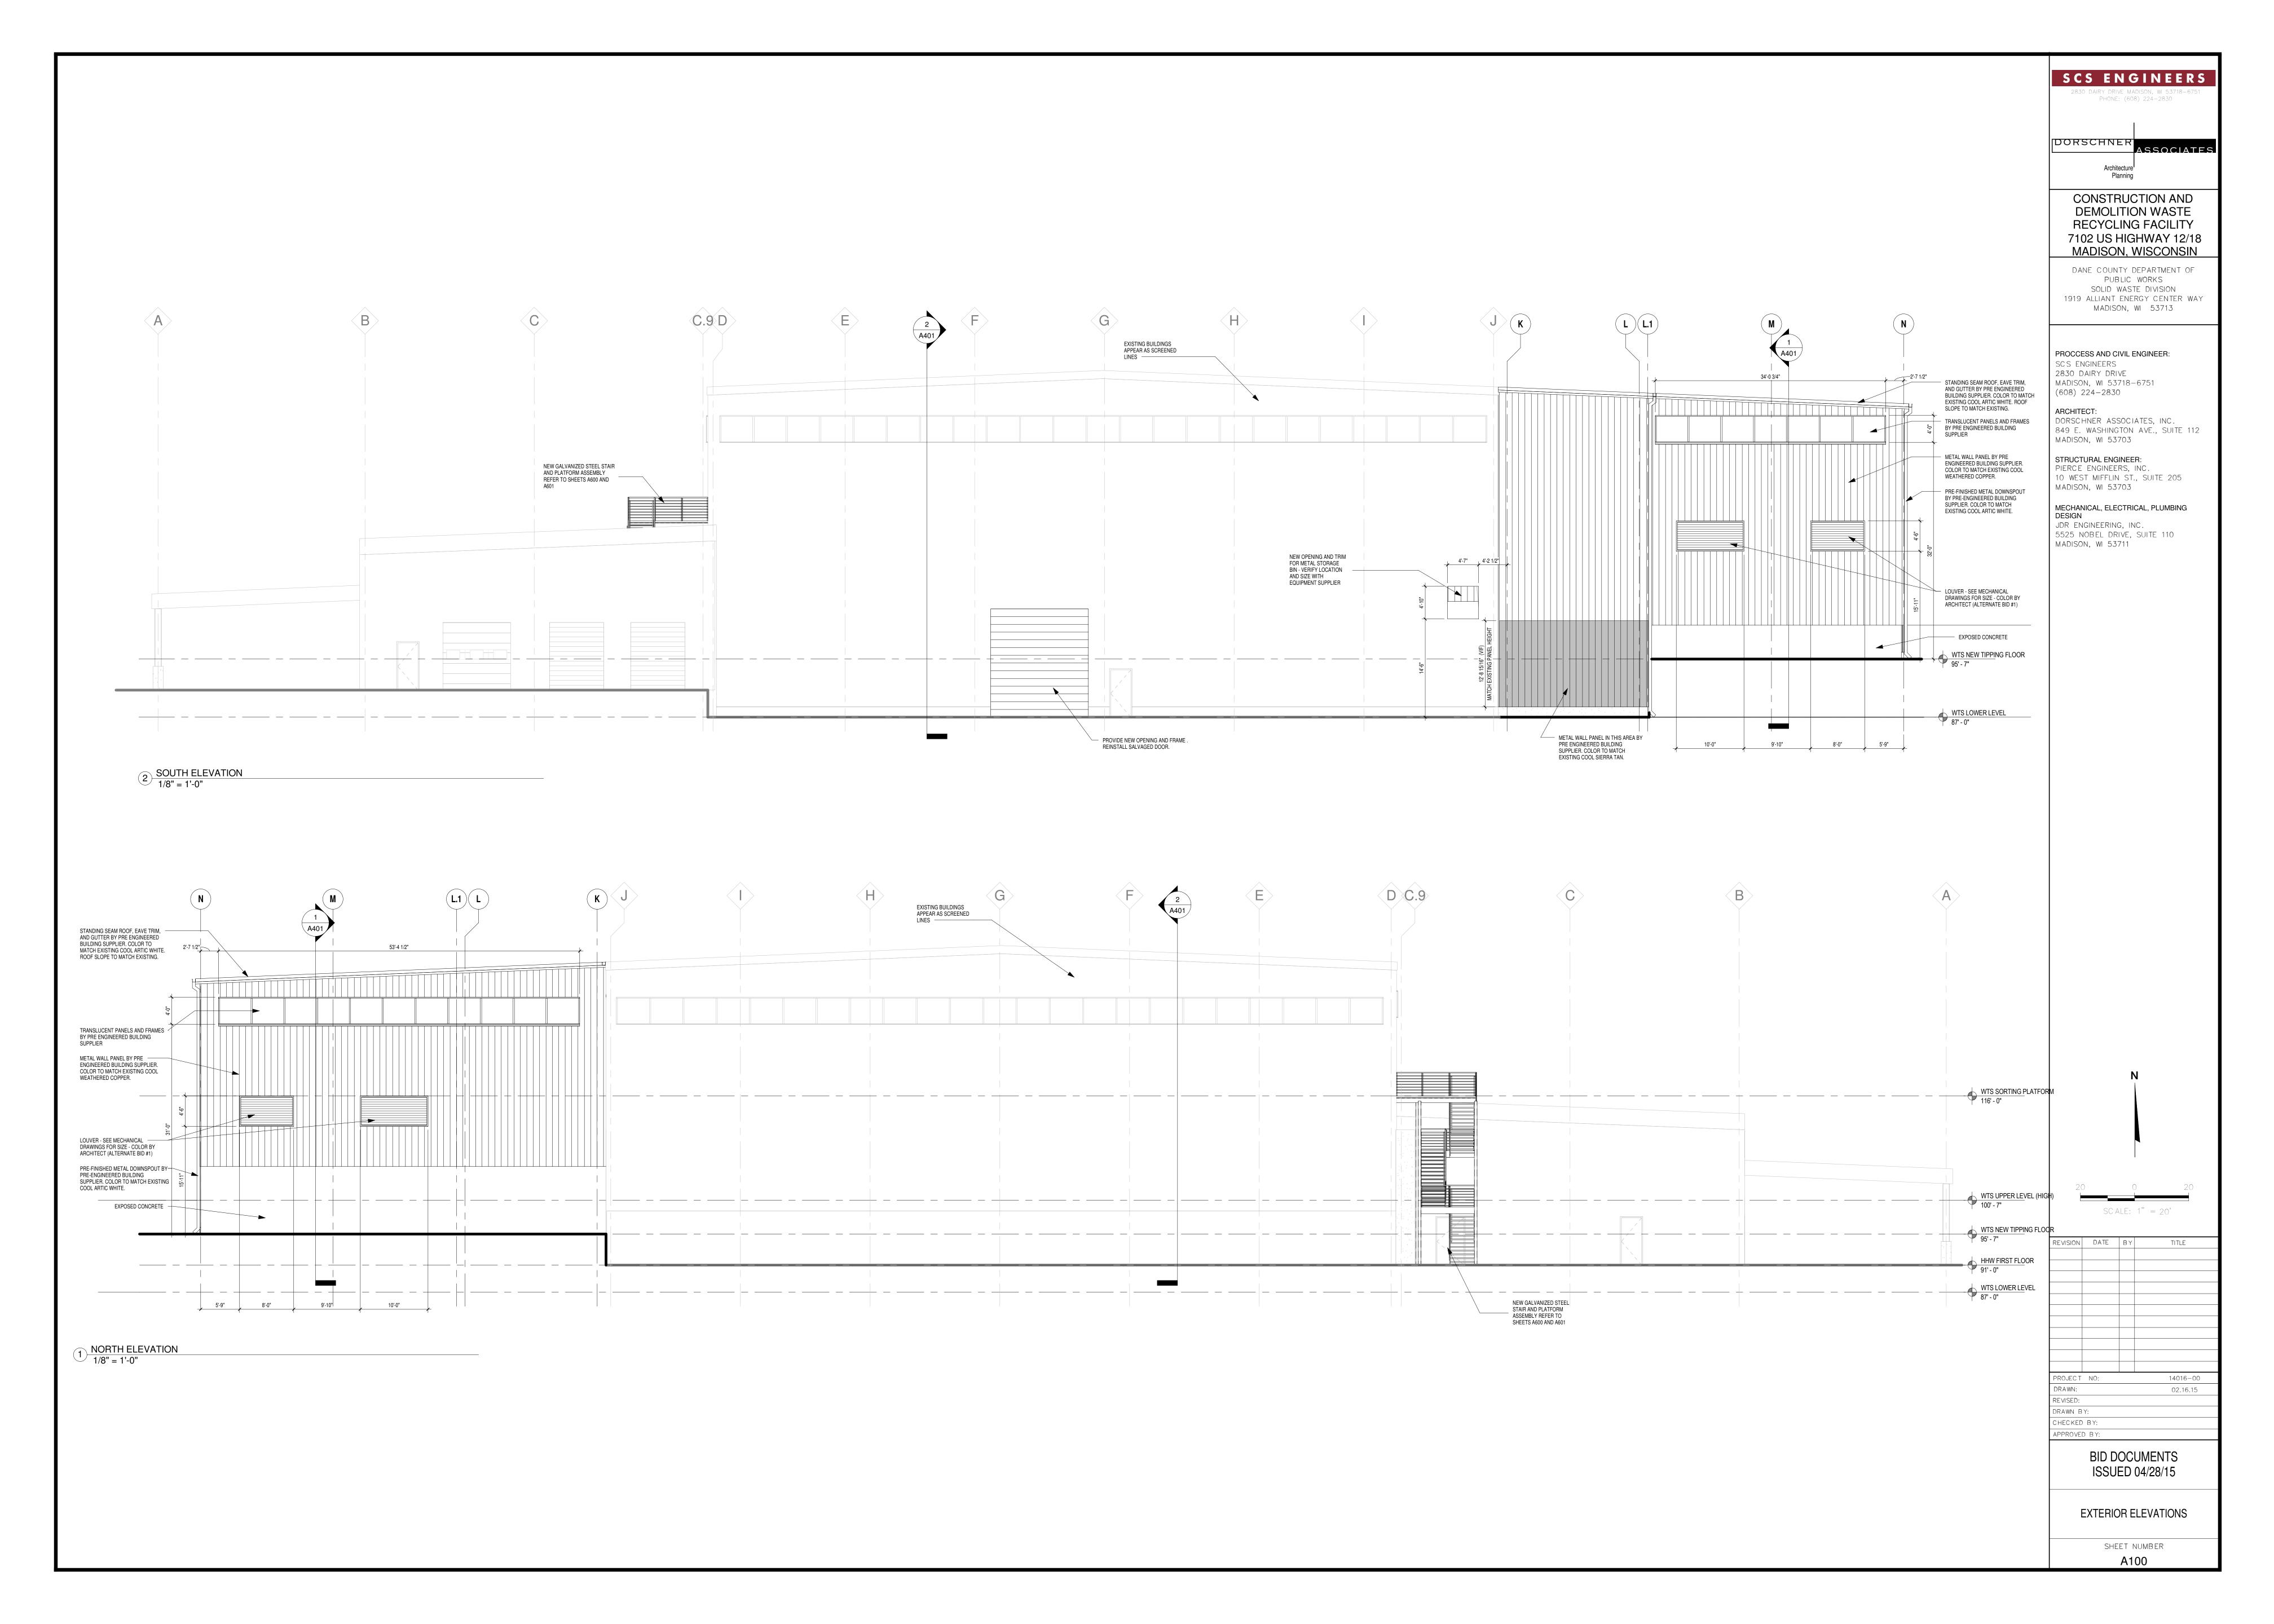
TOILET ACCESSORY SCHEDULE: - SOLID CORE <u>ABBREVIATION</u> STD. MOUNTING HEIGHT - STORM DRAIN / SOAP DISPENSER SEE PLAN AND ELEVATION LAVATORY MOUNTED SOAP DISPENSER (1) 5'-6" A.F.F., (1)4'-0" A.F.F. SEE ELEVATIONS FOR OTHER LOCATIONS - SELF TAP METAL SCREW SQUARE FEET/FOOT (1) 2'-11" A.F.F. TO SPOUT OUTLET, (1) 3'-5" A.F.F. TO SPOUT OUTLET - SPRINKLER HEAD TOP @ 41.25" MALE, 38.25" FEMALE SEE PLUMBING SPECIFICATION - SOLID SURFACE SHEET METAL OR SQUARE METER (METRIC DOCS) SANITARY NAPKIN DISPENSER TOP @ 17-19" A.F.F. - SANITARY NAPKIN DISPOSAL CENTER @ 2'-10" A.F.F., 3'-2" A.F.F. IN SHOWER - SPECIFICATION HORIZ: CENTER @ 2'-10" A.F.F.; VERT: 3'-4" @ B.O. BAR HORIZ: CENTER @ 3'-2" A.F.F., VERT: 3'-7" @ B.O. BAR IN SHOWER - STRUCTURE SLAB ELEVATION CENTER @ 2'-10" A.F.F., 3'-2" A.F.F. IN SHOWER STAINLESS STEEL - SERVICE SINK CENTER @ 2'-10" A.F.F., 3'-2" A.F.F. IN SHOWER CENTER @ 2'-10" A.F.F., 3'-2" A.F.F. IN SHOWER TYPICAL: TOP @ 2'-10" A.F.F. PRESCHOOL: TOP @ 1'-8" A.F.F. BOTTOM @ 3'-4" MAX A.F.F. - SUBCATEGORY TOP @ 48" A.F.F. - SYMMETRICAL LAVATORY MOUNTED - TONGUE AND GROOVE 48" A.F.F. MAX TO OPERATING COMPONENTS (SEE PLAN) TREAD / THERMOSTAT TOP @ 15" MIN, 48" MAX A.F.F. - TOP OF CURB - TOP OF CONCRETE 48" A.F.F. MAX. TO OPERATING COMPONENTS (SEE PLAN) TOWEL DISPENSER TELEPHONE OR TELECOM OUTLET 15" MIN, 48" MAX A.F.F., 7-9" IN FRONT OF WC TO CL (SEE PLAN) SEE PLUMBING TOP @41-45" A.F.F. MAX., BASED ON SPECIFIED PRODUCT (SEE PLAN)






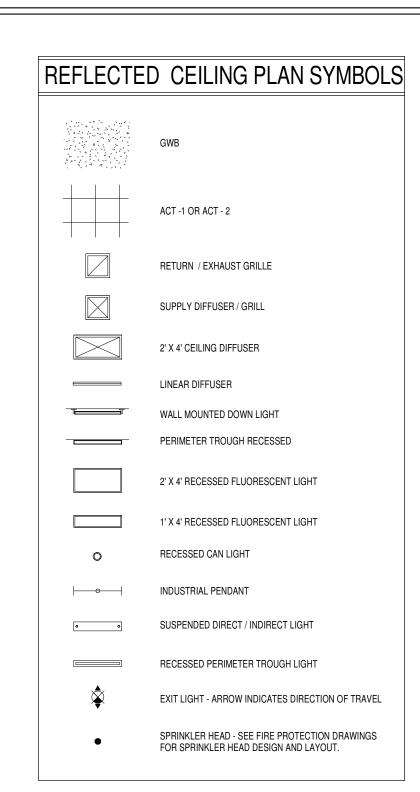


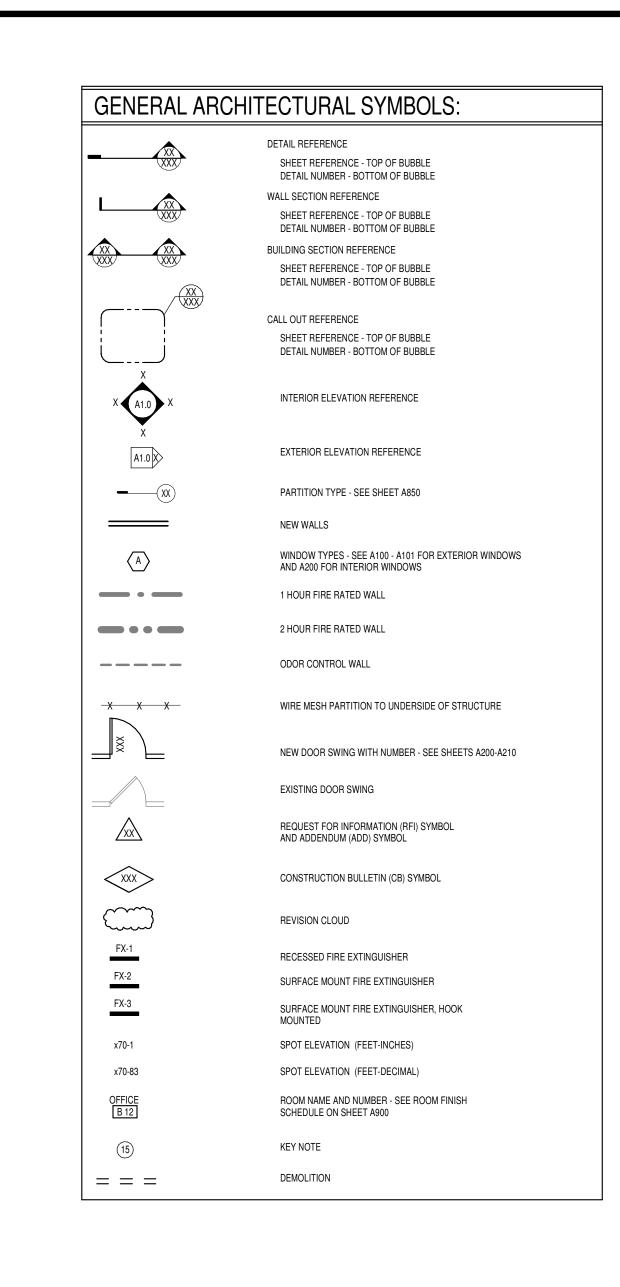

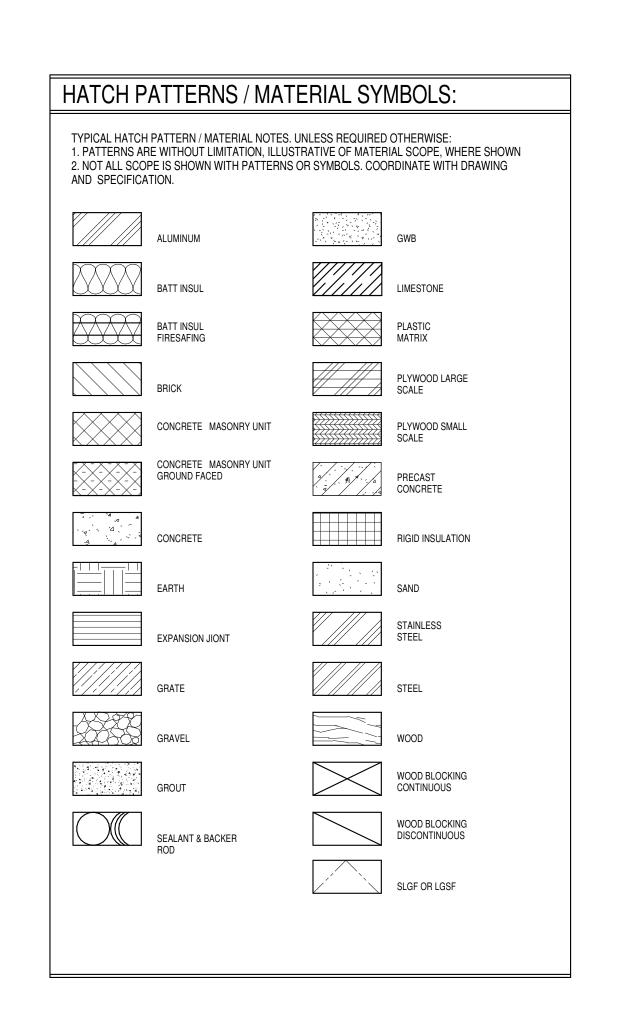

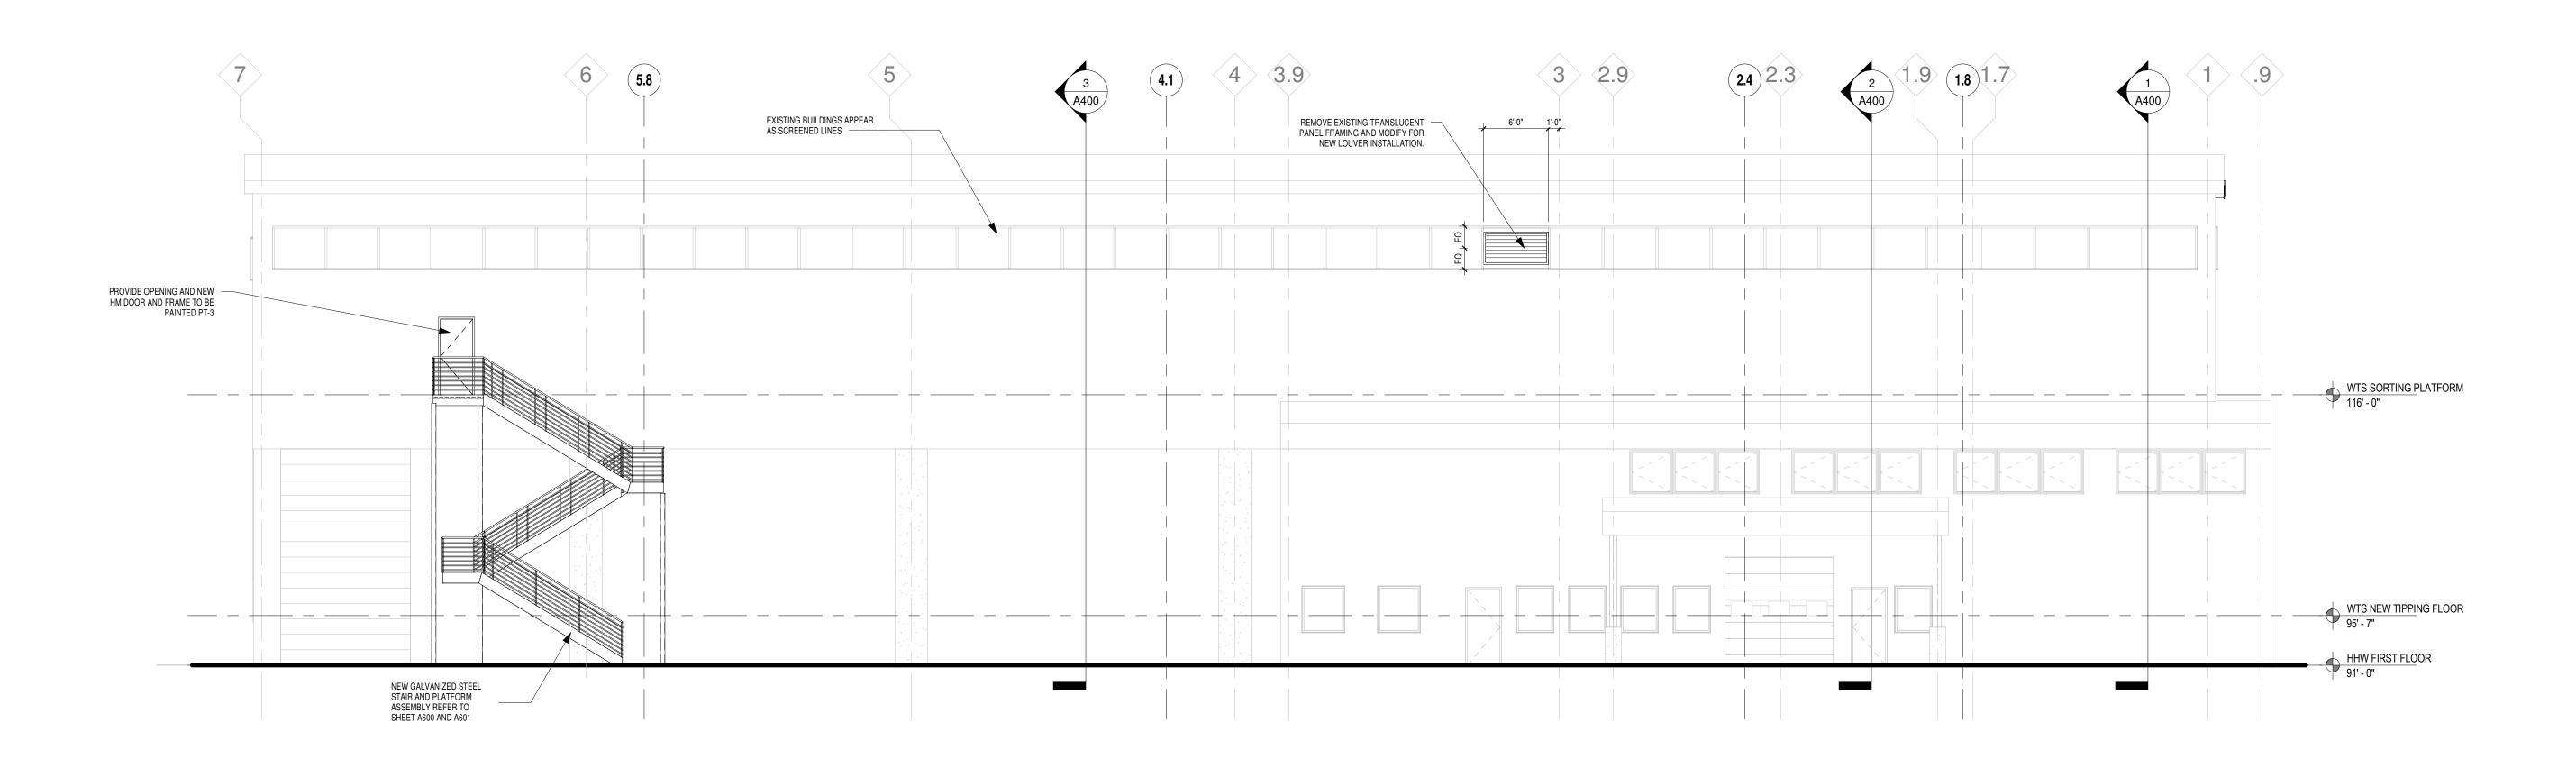



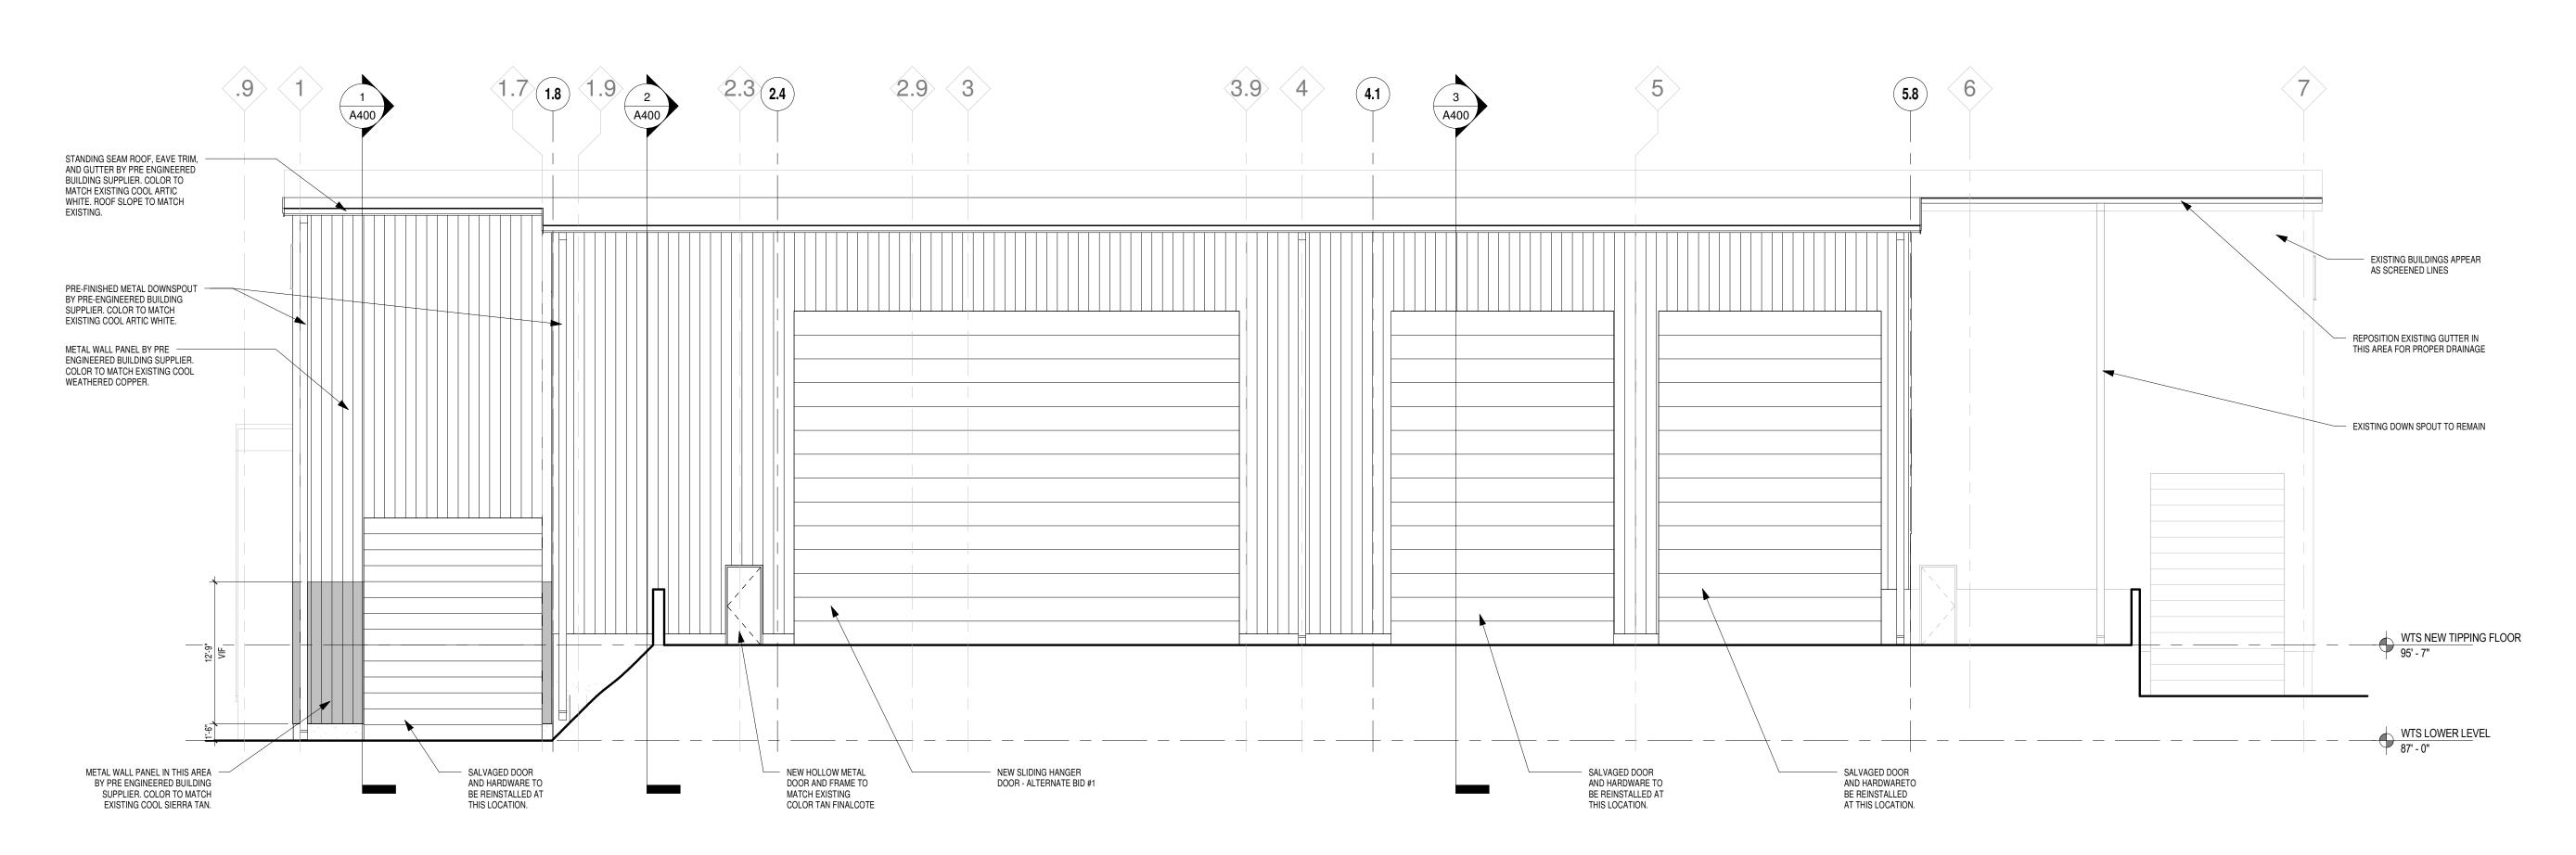

1 EAST ELEVATION 1/8" = 1'-0"



2830 DAIRY DRIVE MADISON, WI 53718-675 PHONE: (608) 224-2830 Architecture¹

CONSTRUCTION AND **DEMOLITION WASTE** RECYCLING FACILITY 7102 US HIGHWAY 12/18 MADISON, WISCONSIN

DANE COUNTY DEPARTMENT OF PUBLIC WORKS SOLID WASTE DIVISION 1919 ALLIANT ENERGY CENTER WAY MADISON, WI 53713

PROCCESS AND CIVIL ENGINEER: SCS ENGINEERS

2830 DAIRY DRIVE MADISON, WI 53718-6751 (608) 224-2830


ARCHITECT: DORSCHNER ASSOCIATES, INC. 849 E. WASHINGTON AVE., SUITE 112 MADISON, WI 53703

STRUCTURAL ENGINEER: PIERCE ENGINEERS, INC. 10 WEST MIFFLIN ST., SUITE 205

MECHANICAL, ELECTRICAL, PLUMBING

JDR ENGINEERING, INC. 5525 NOBEL DRIVE, SUITE 110 MADISON, WI 53711

MADISON, WI 53703

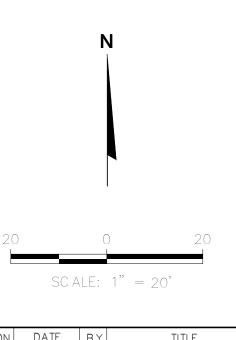



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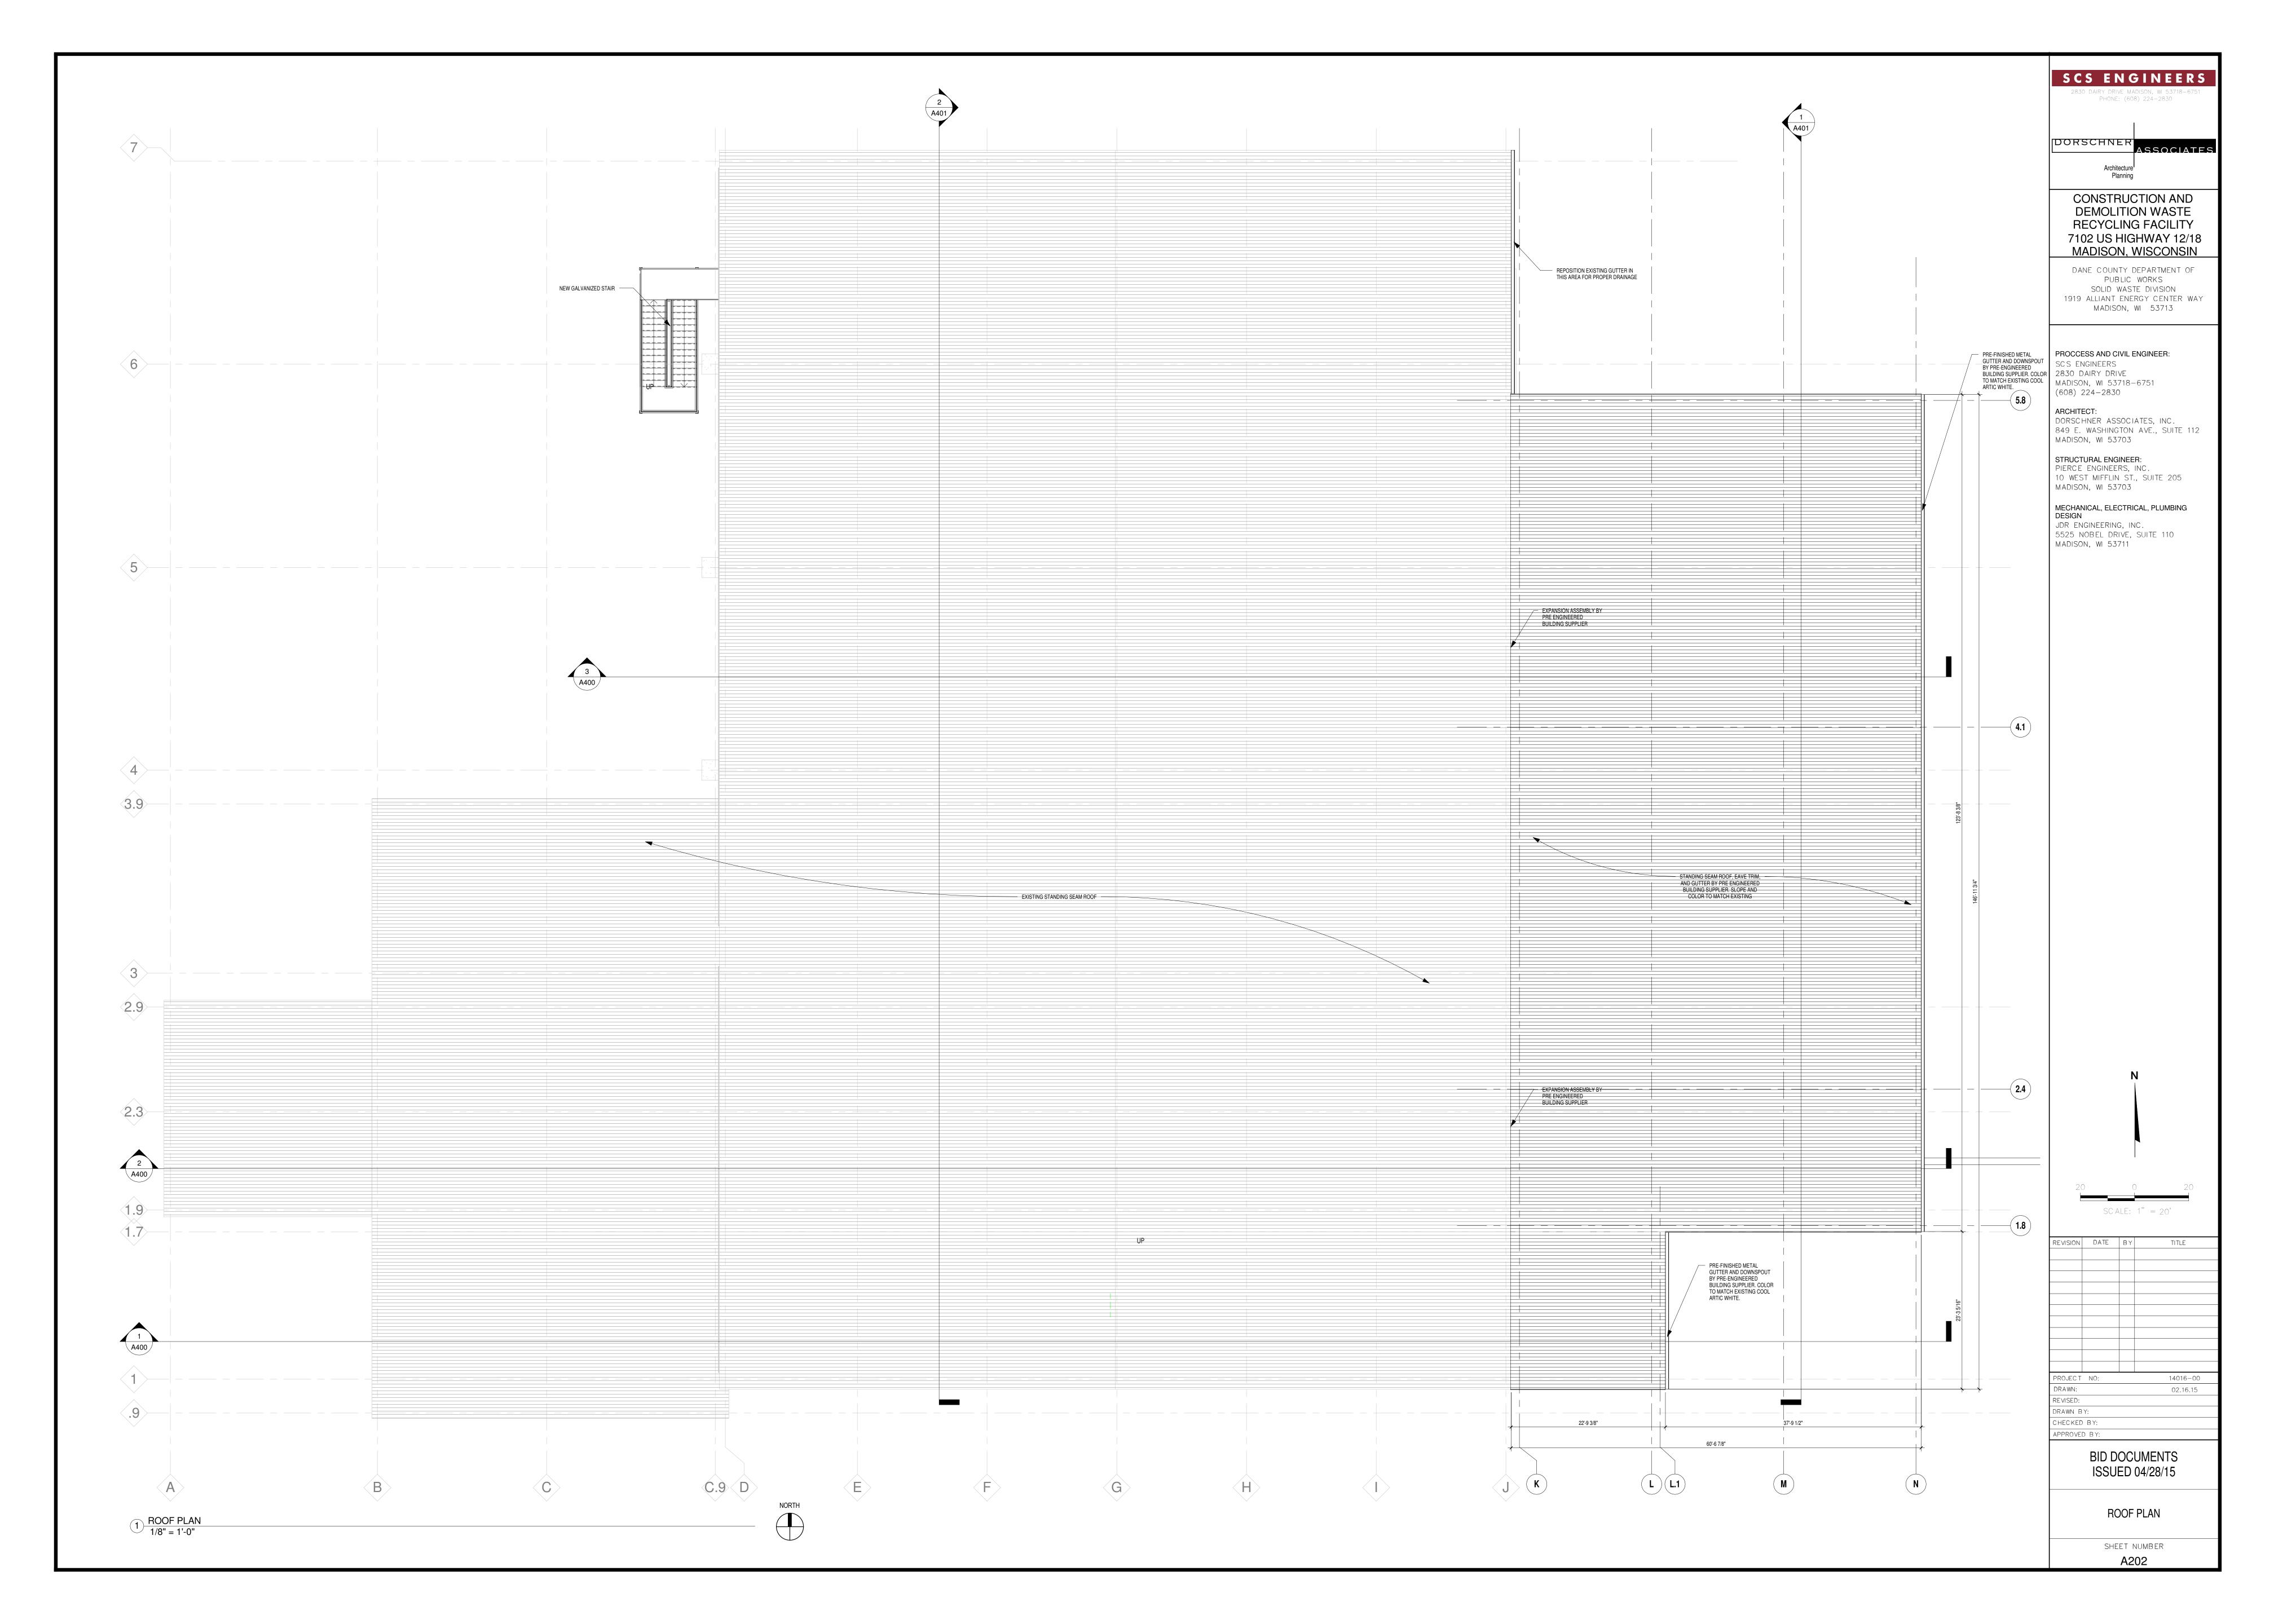
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CHECKED BY:
APPROVED BY:


BID DOCUMENTS ISSUED 04/28/15


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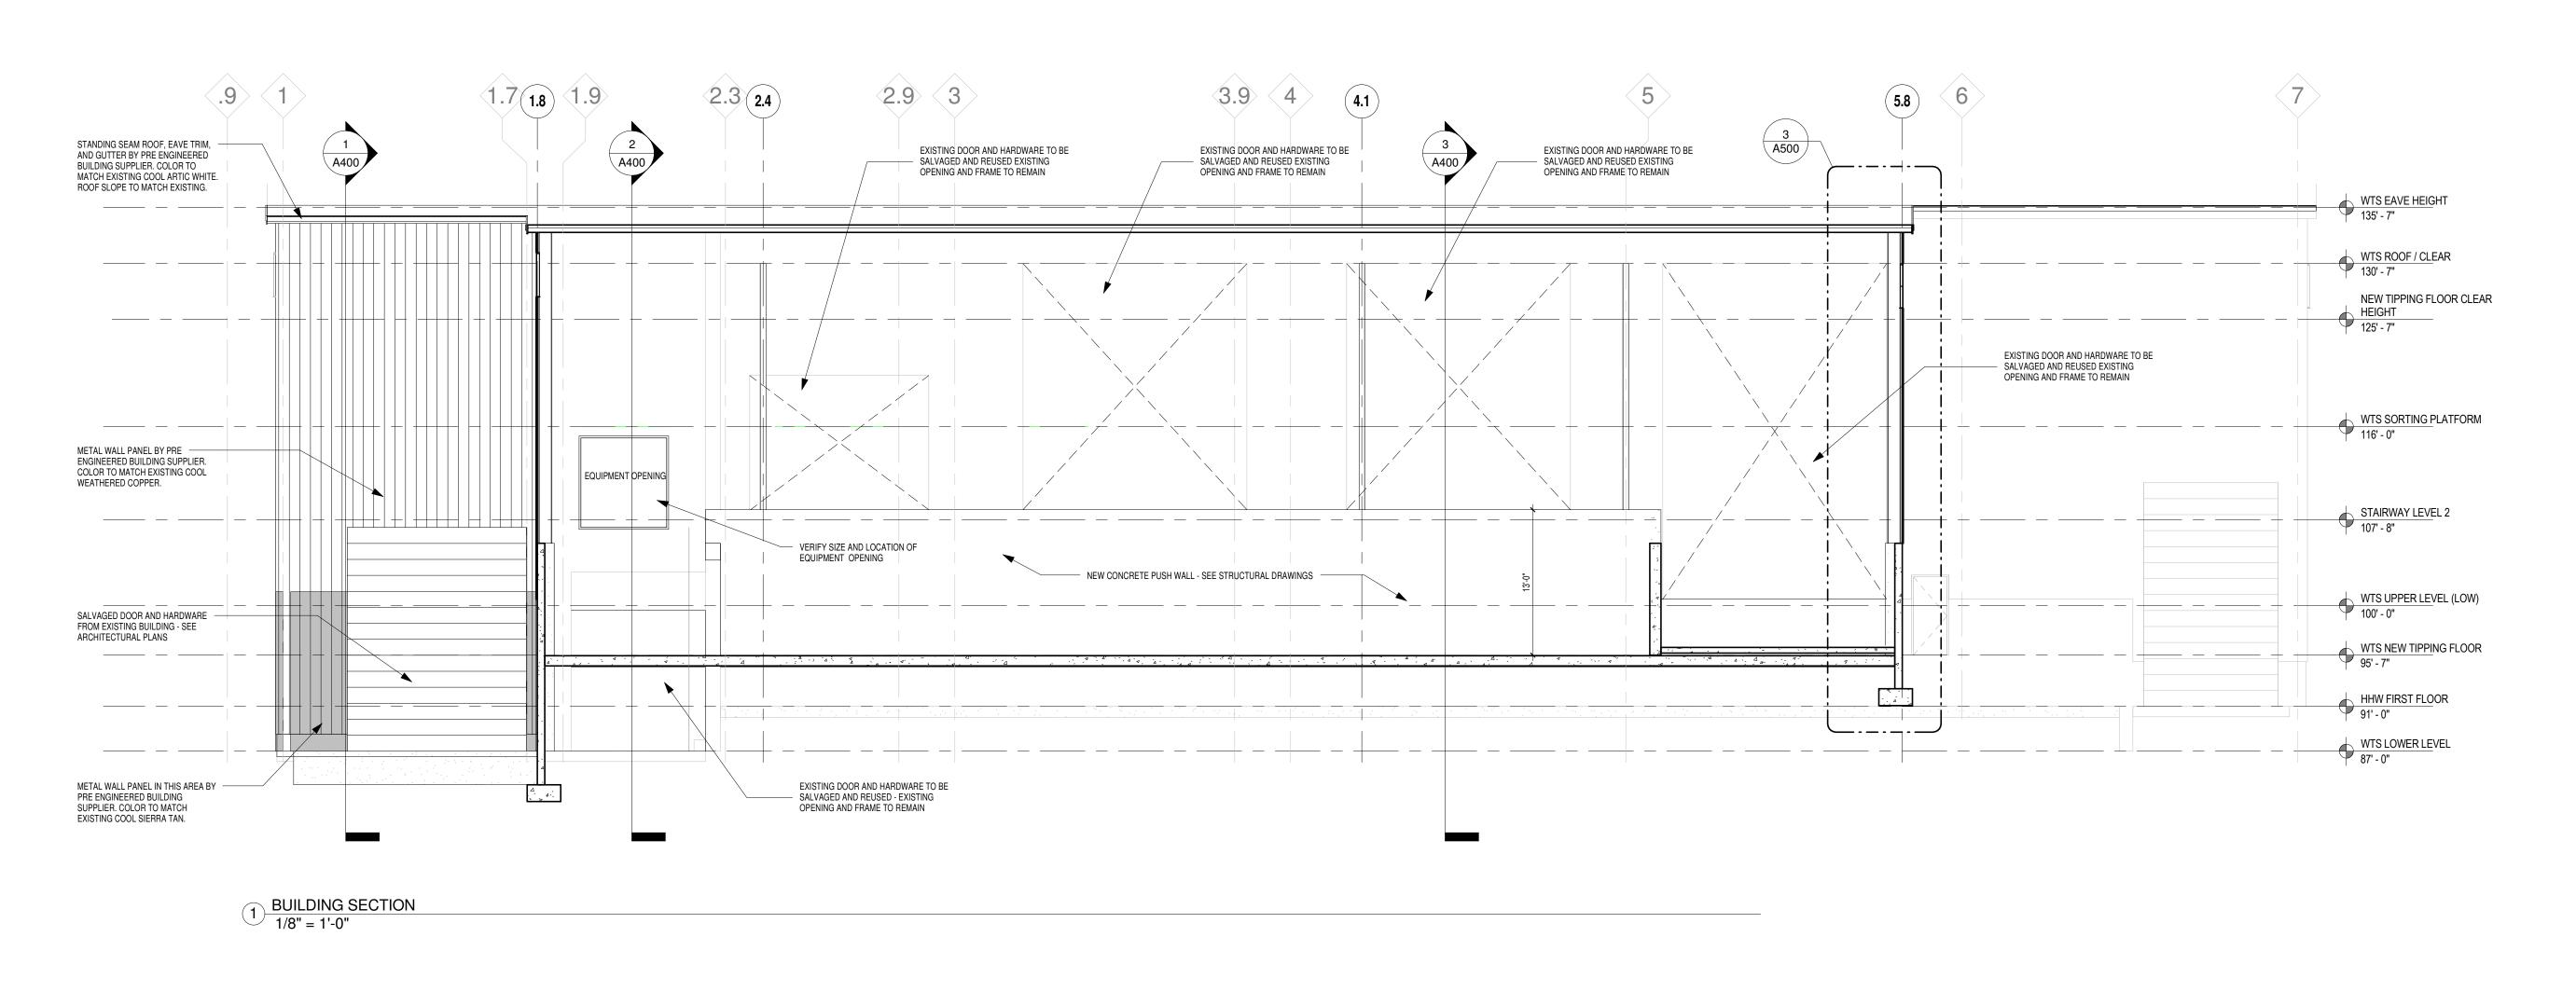




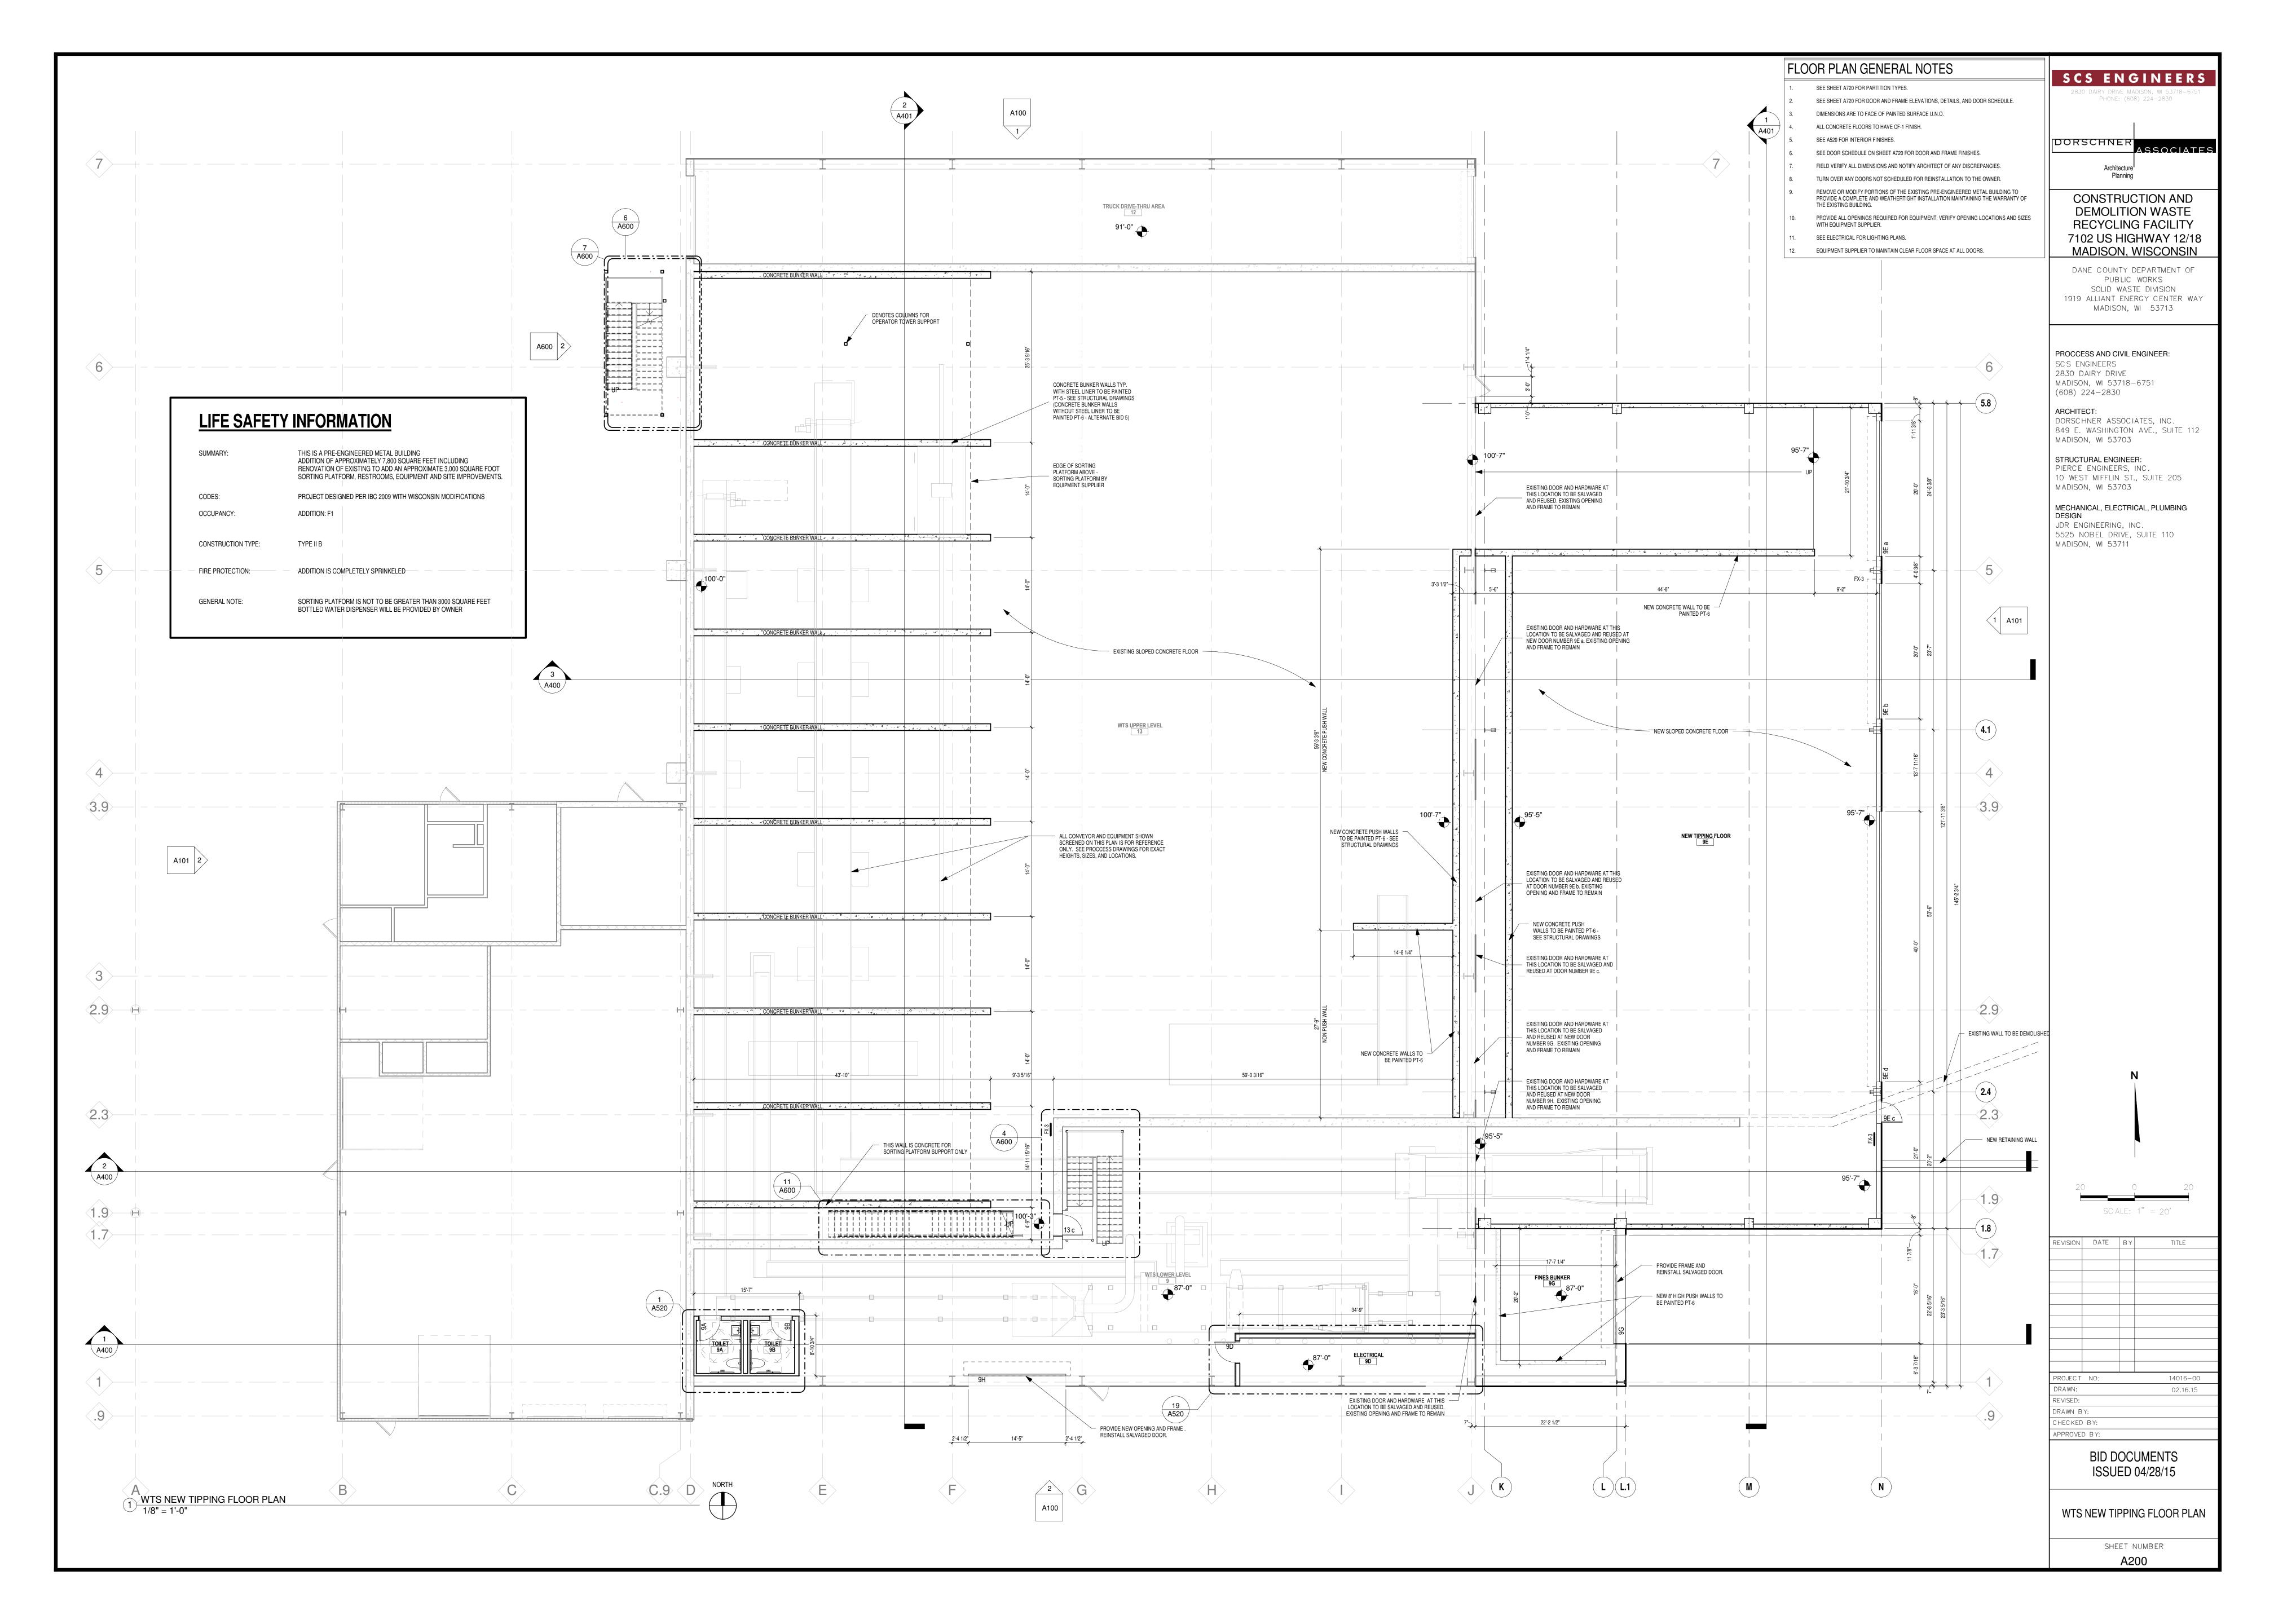

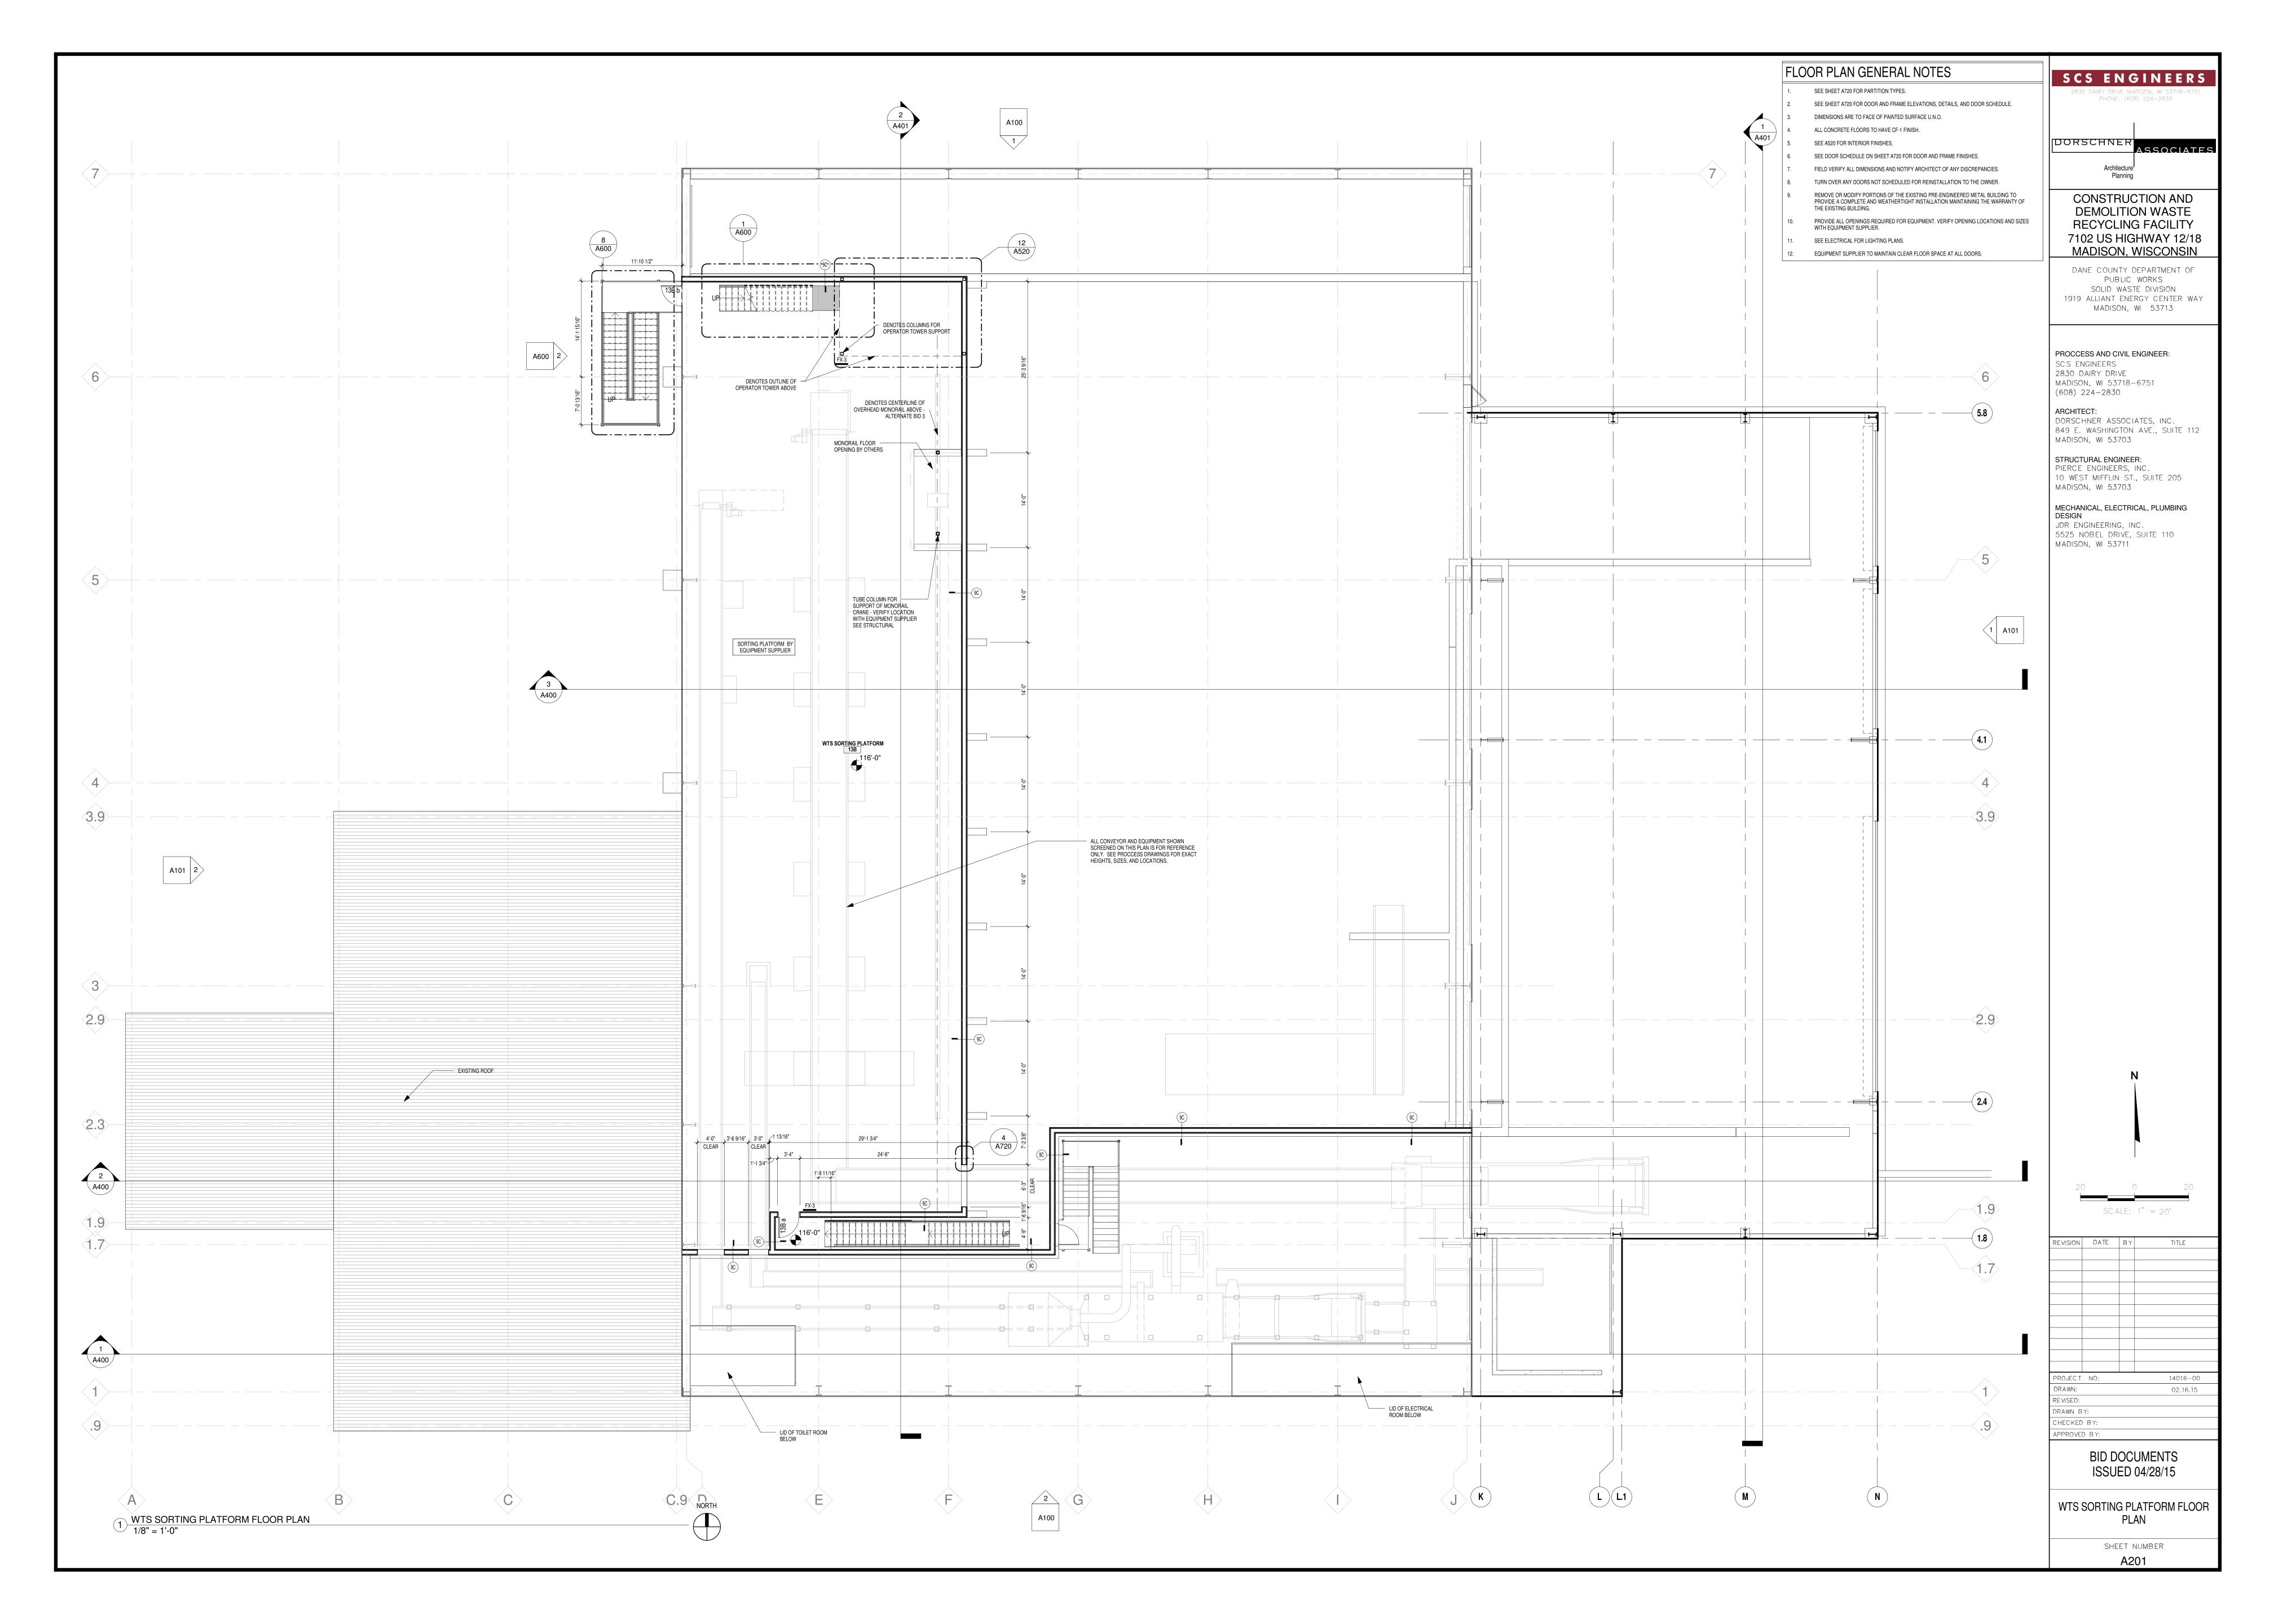

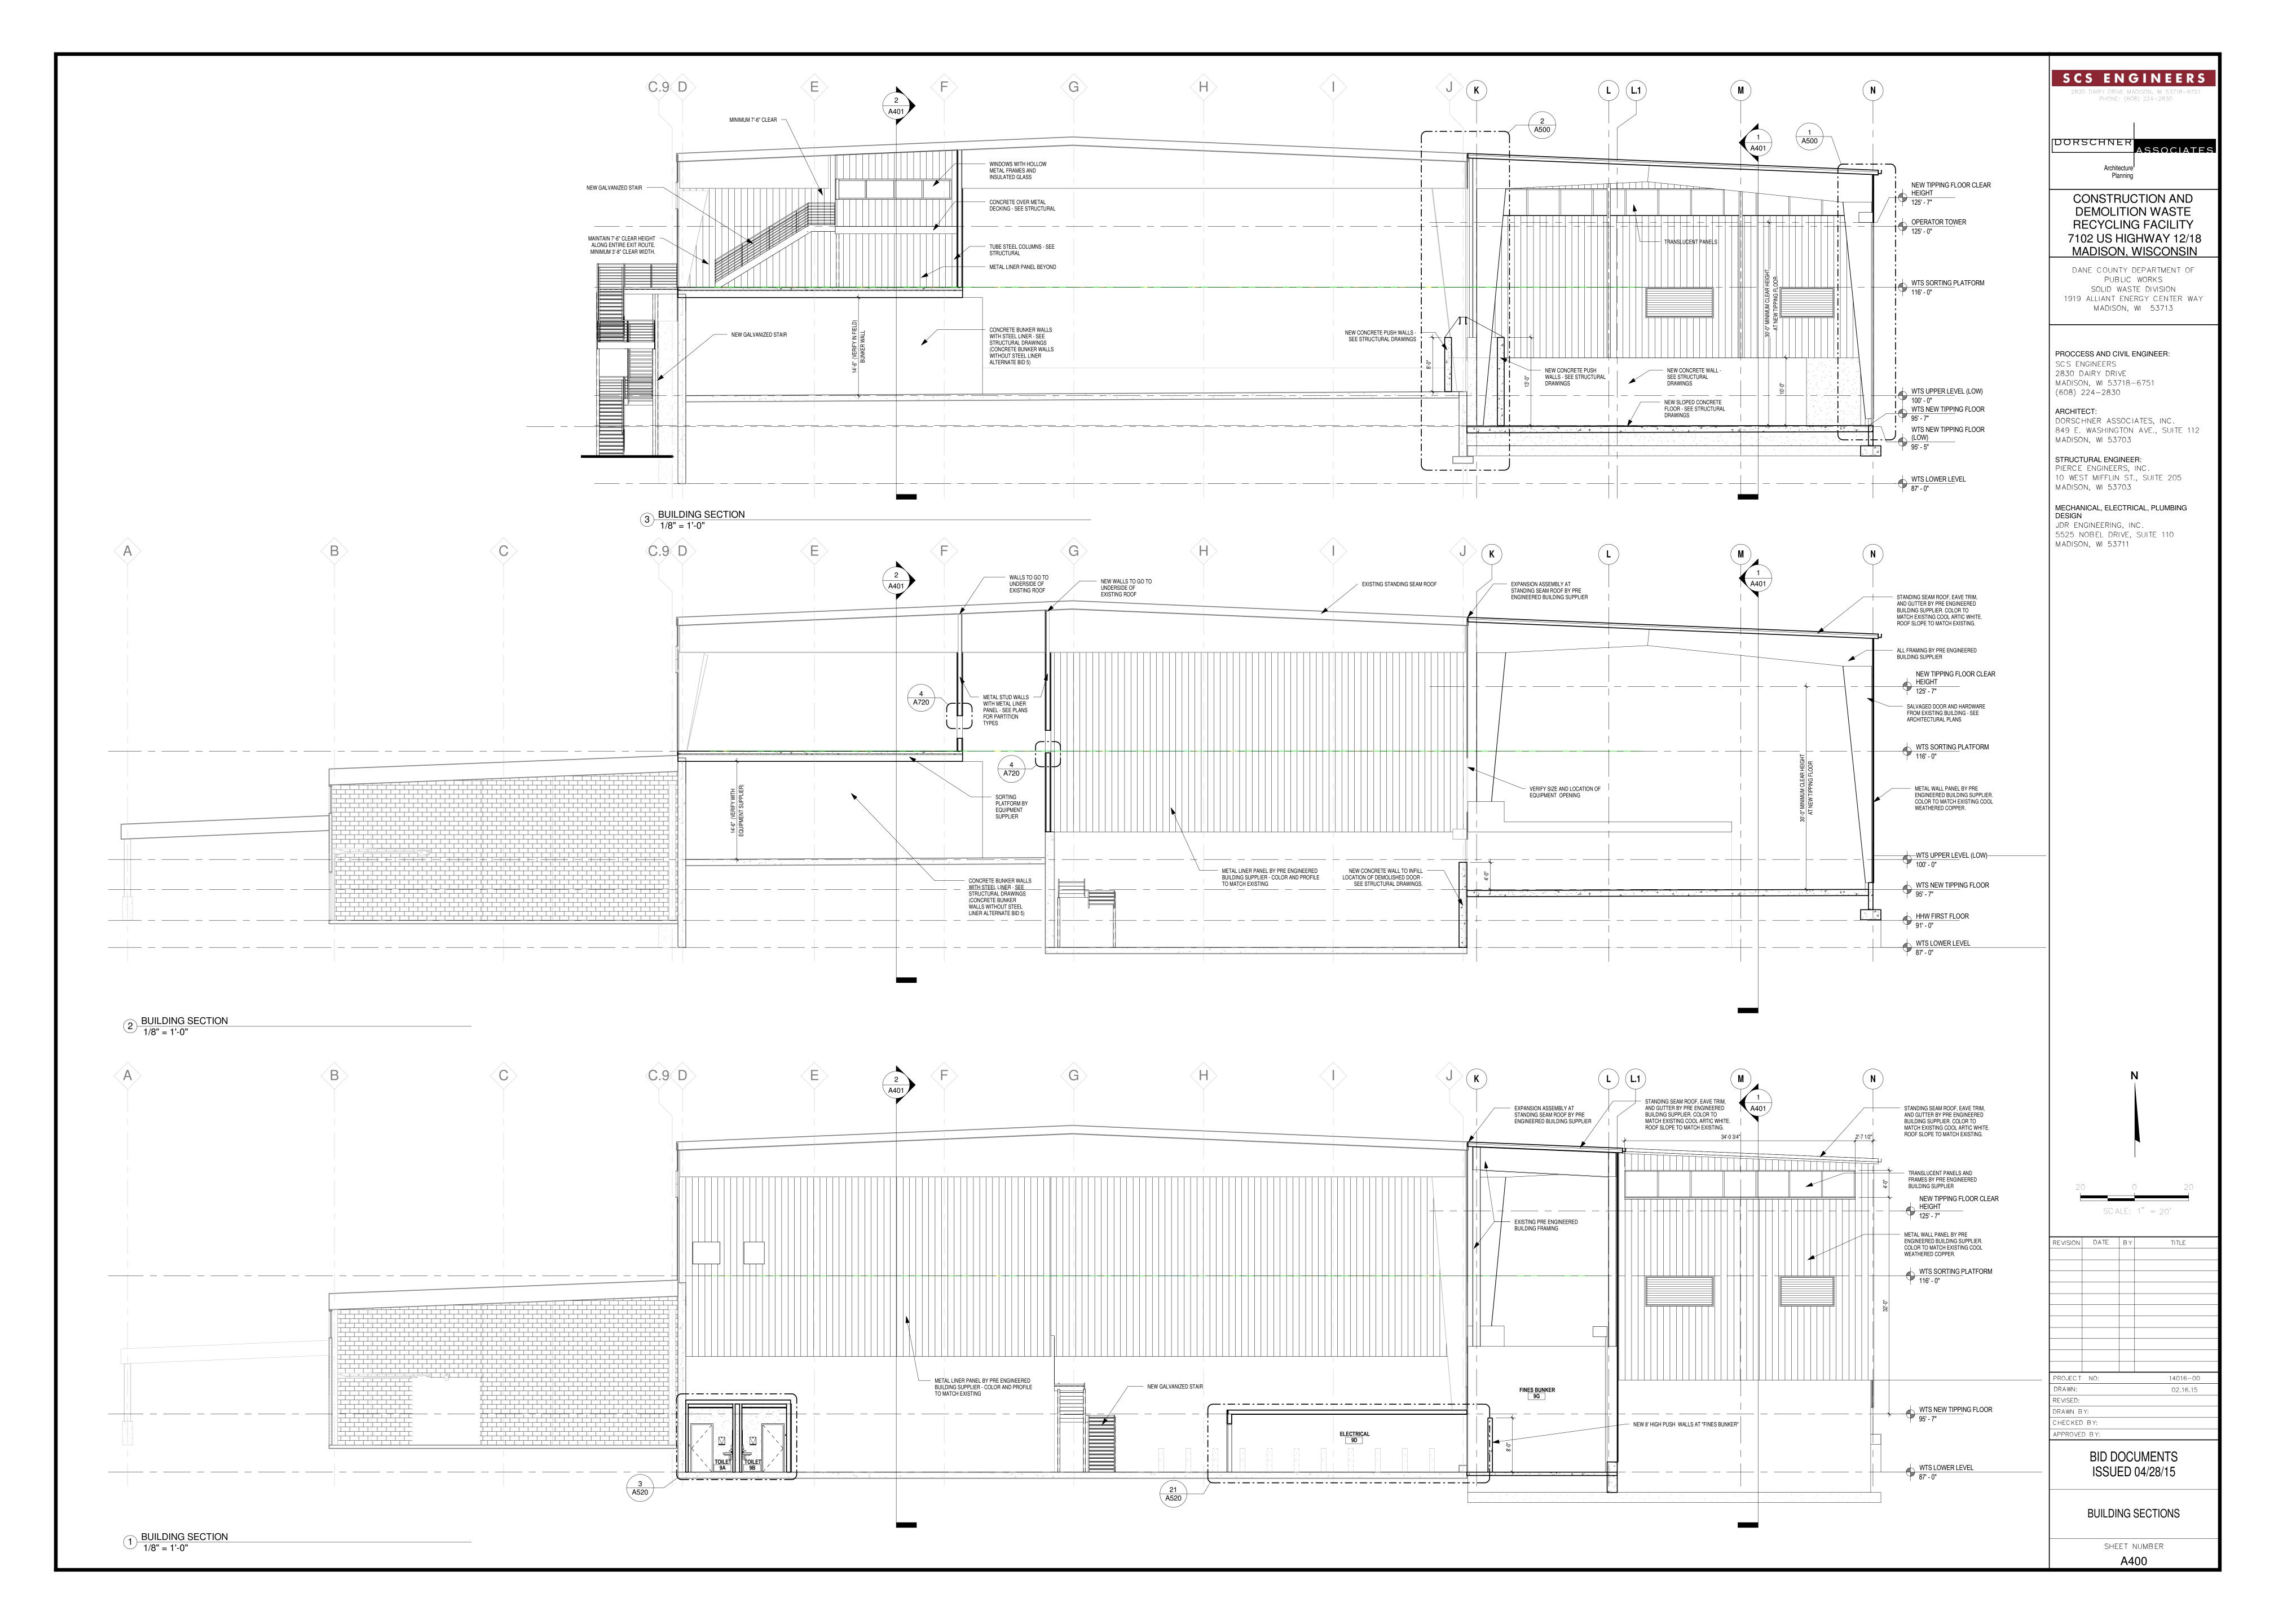

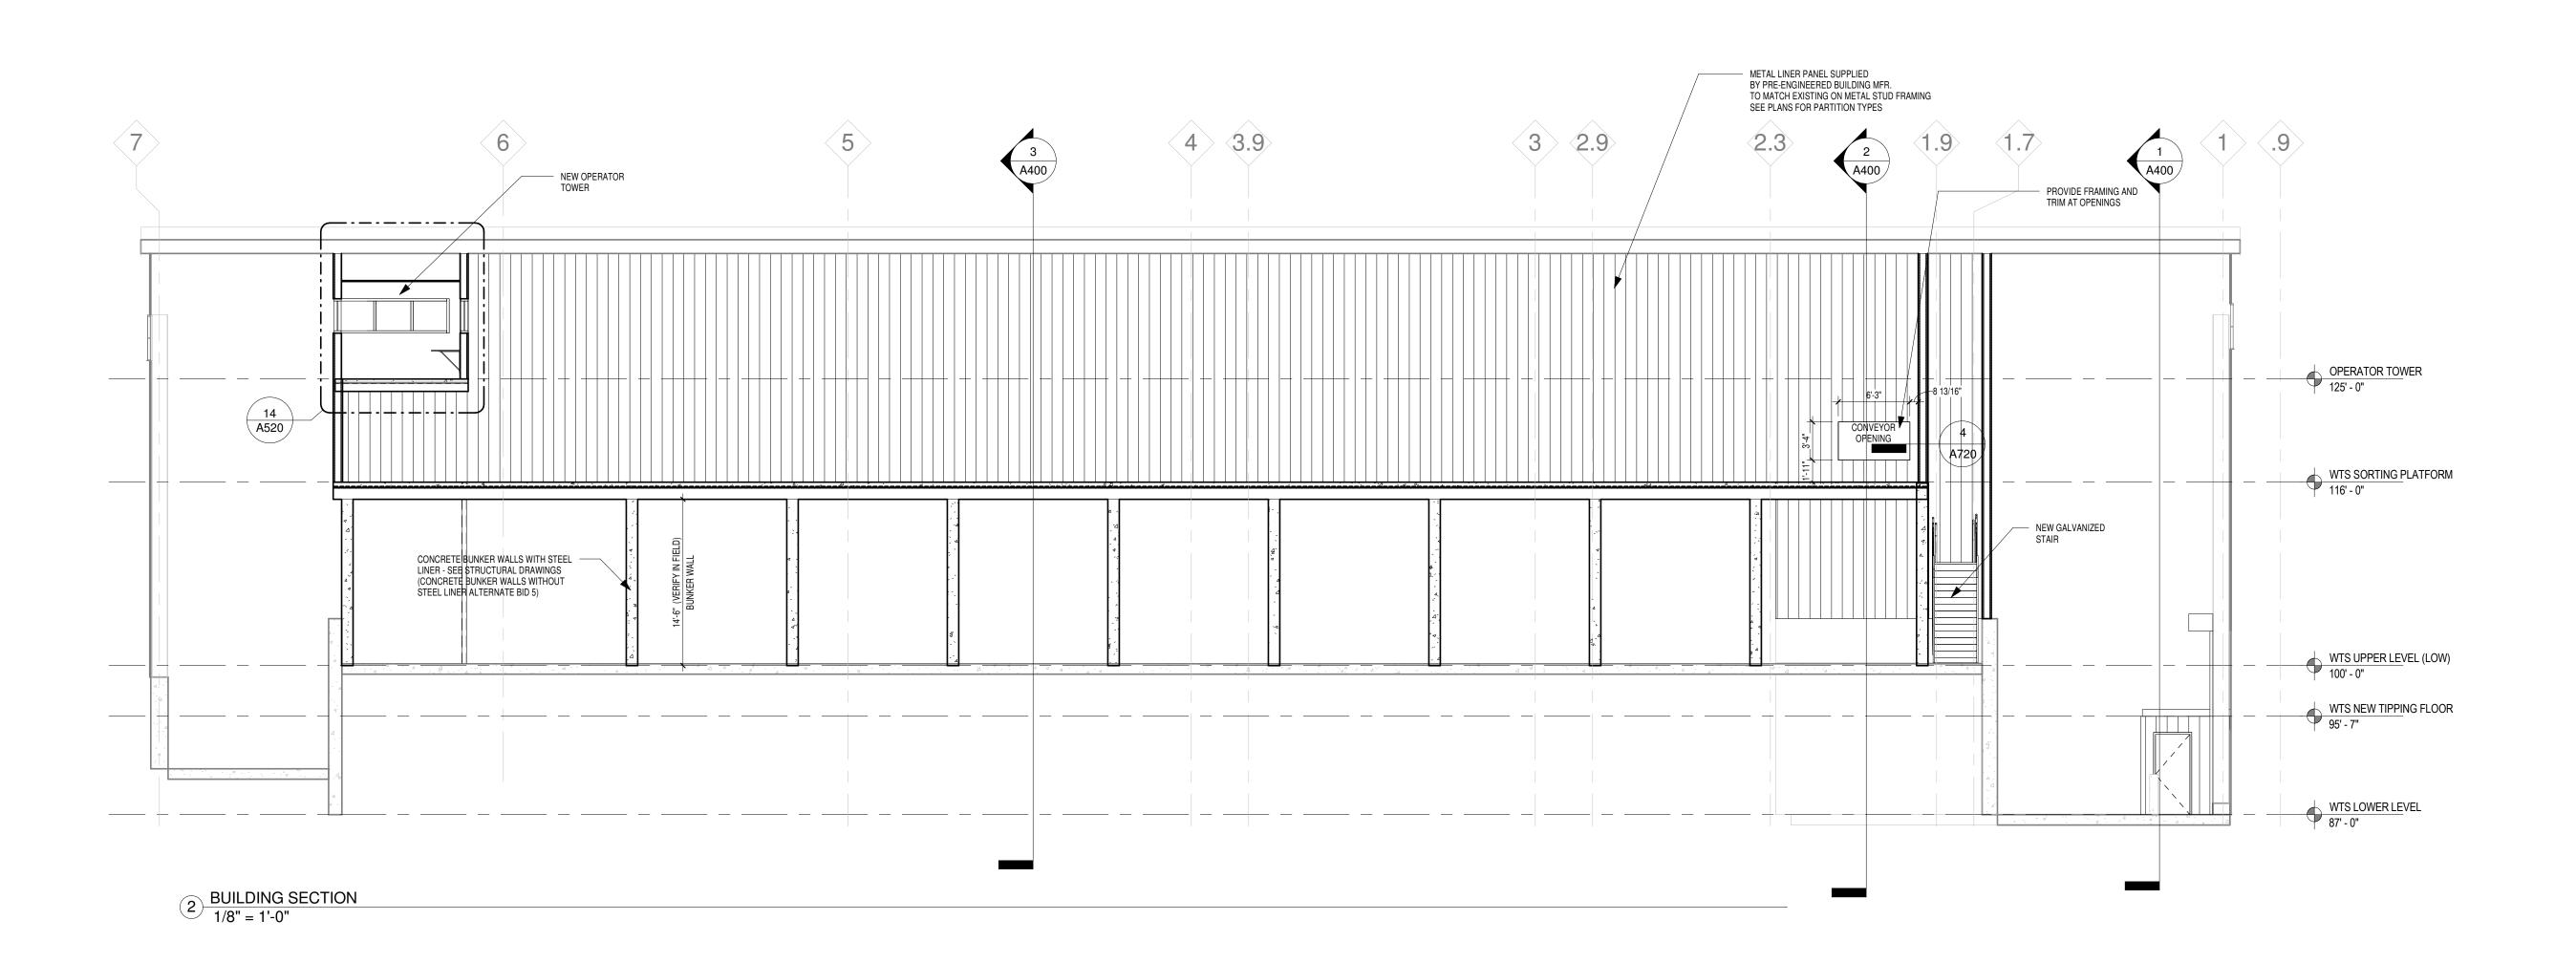



2830 DAIRY DRIVE MADISON, WI 53718-6751
PHONE: (608) 224-2830

DORSCHNER
Architecture

CONSTRUCTION AND DEMOLITION WASTE RECYCLING FACILITY 7102 US HIGHWAY 12/18 MADISON, WISCONSIN

DANE COUNTY DEPARTMENT OF
PUBLIC WORKS
SOLID WASTE DIVISION
1919 ALLIANT ENERGY CENTER WAY

MADISON, WI 53713

PROCCESS AND CIVIL ENGINEER: SCS ENGINEERS


SCS ENGINEERS 2830 DAIRY DRIVE MADISON, WI 53718-6751 (608) 224-2830

ARCHITECT:
DORSCHNER ASSOCIATES, INC.
849 E. WASHINGTON AVE., SUITE 112
MADISON, WI 53703

STRUCTURAL ENGINEER:
PIERCE ENGINEERS, INC.
10 WEST MIFFLIN ST., SUITE 205
MADISON, WI 53703

MECHANICAL, ELECTRICAL, PLUMBING DESIGN

JDR ENGINEERING, INC. 5525 NOBEL DRIVE, SUITE 110 MADISON, WI 53711

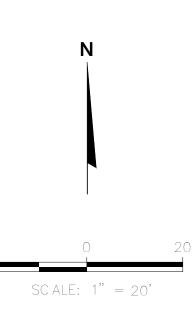

PROJECT NO: 14016-00

PROJECT NO: 14016-00

DRAWN: 02.16.15


REVISED:

DRAWN BY:

CHECKED BY:

BID DOCUMENTS
ISSUED 04/28/15

BUILDING SECTIONS

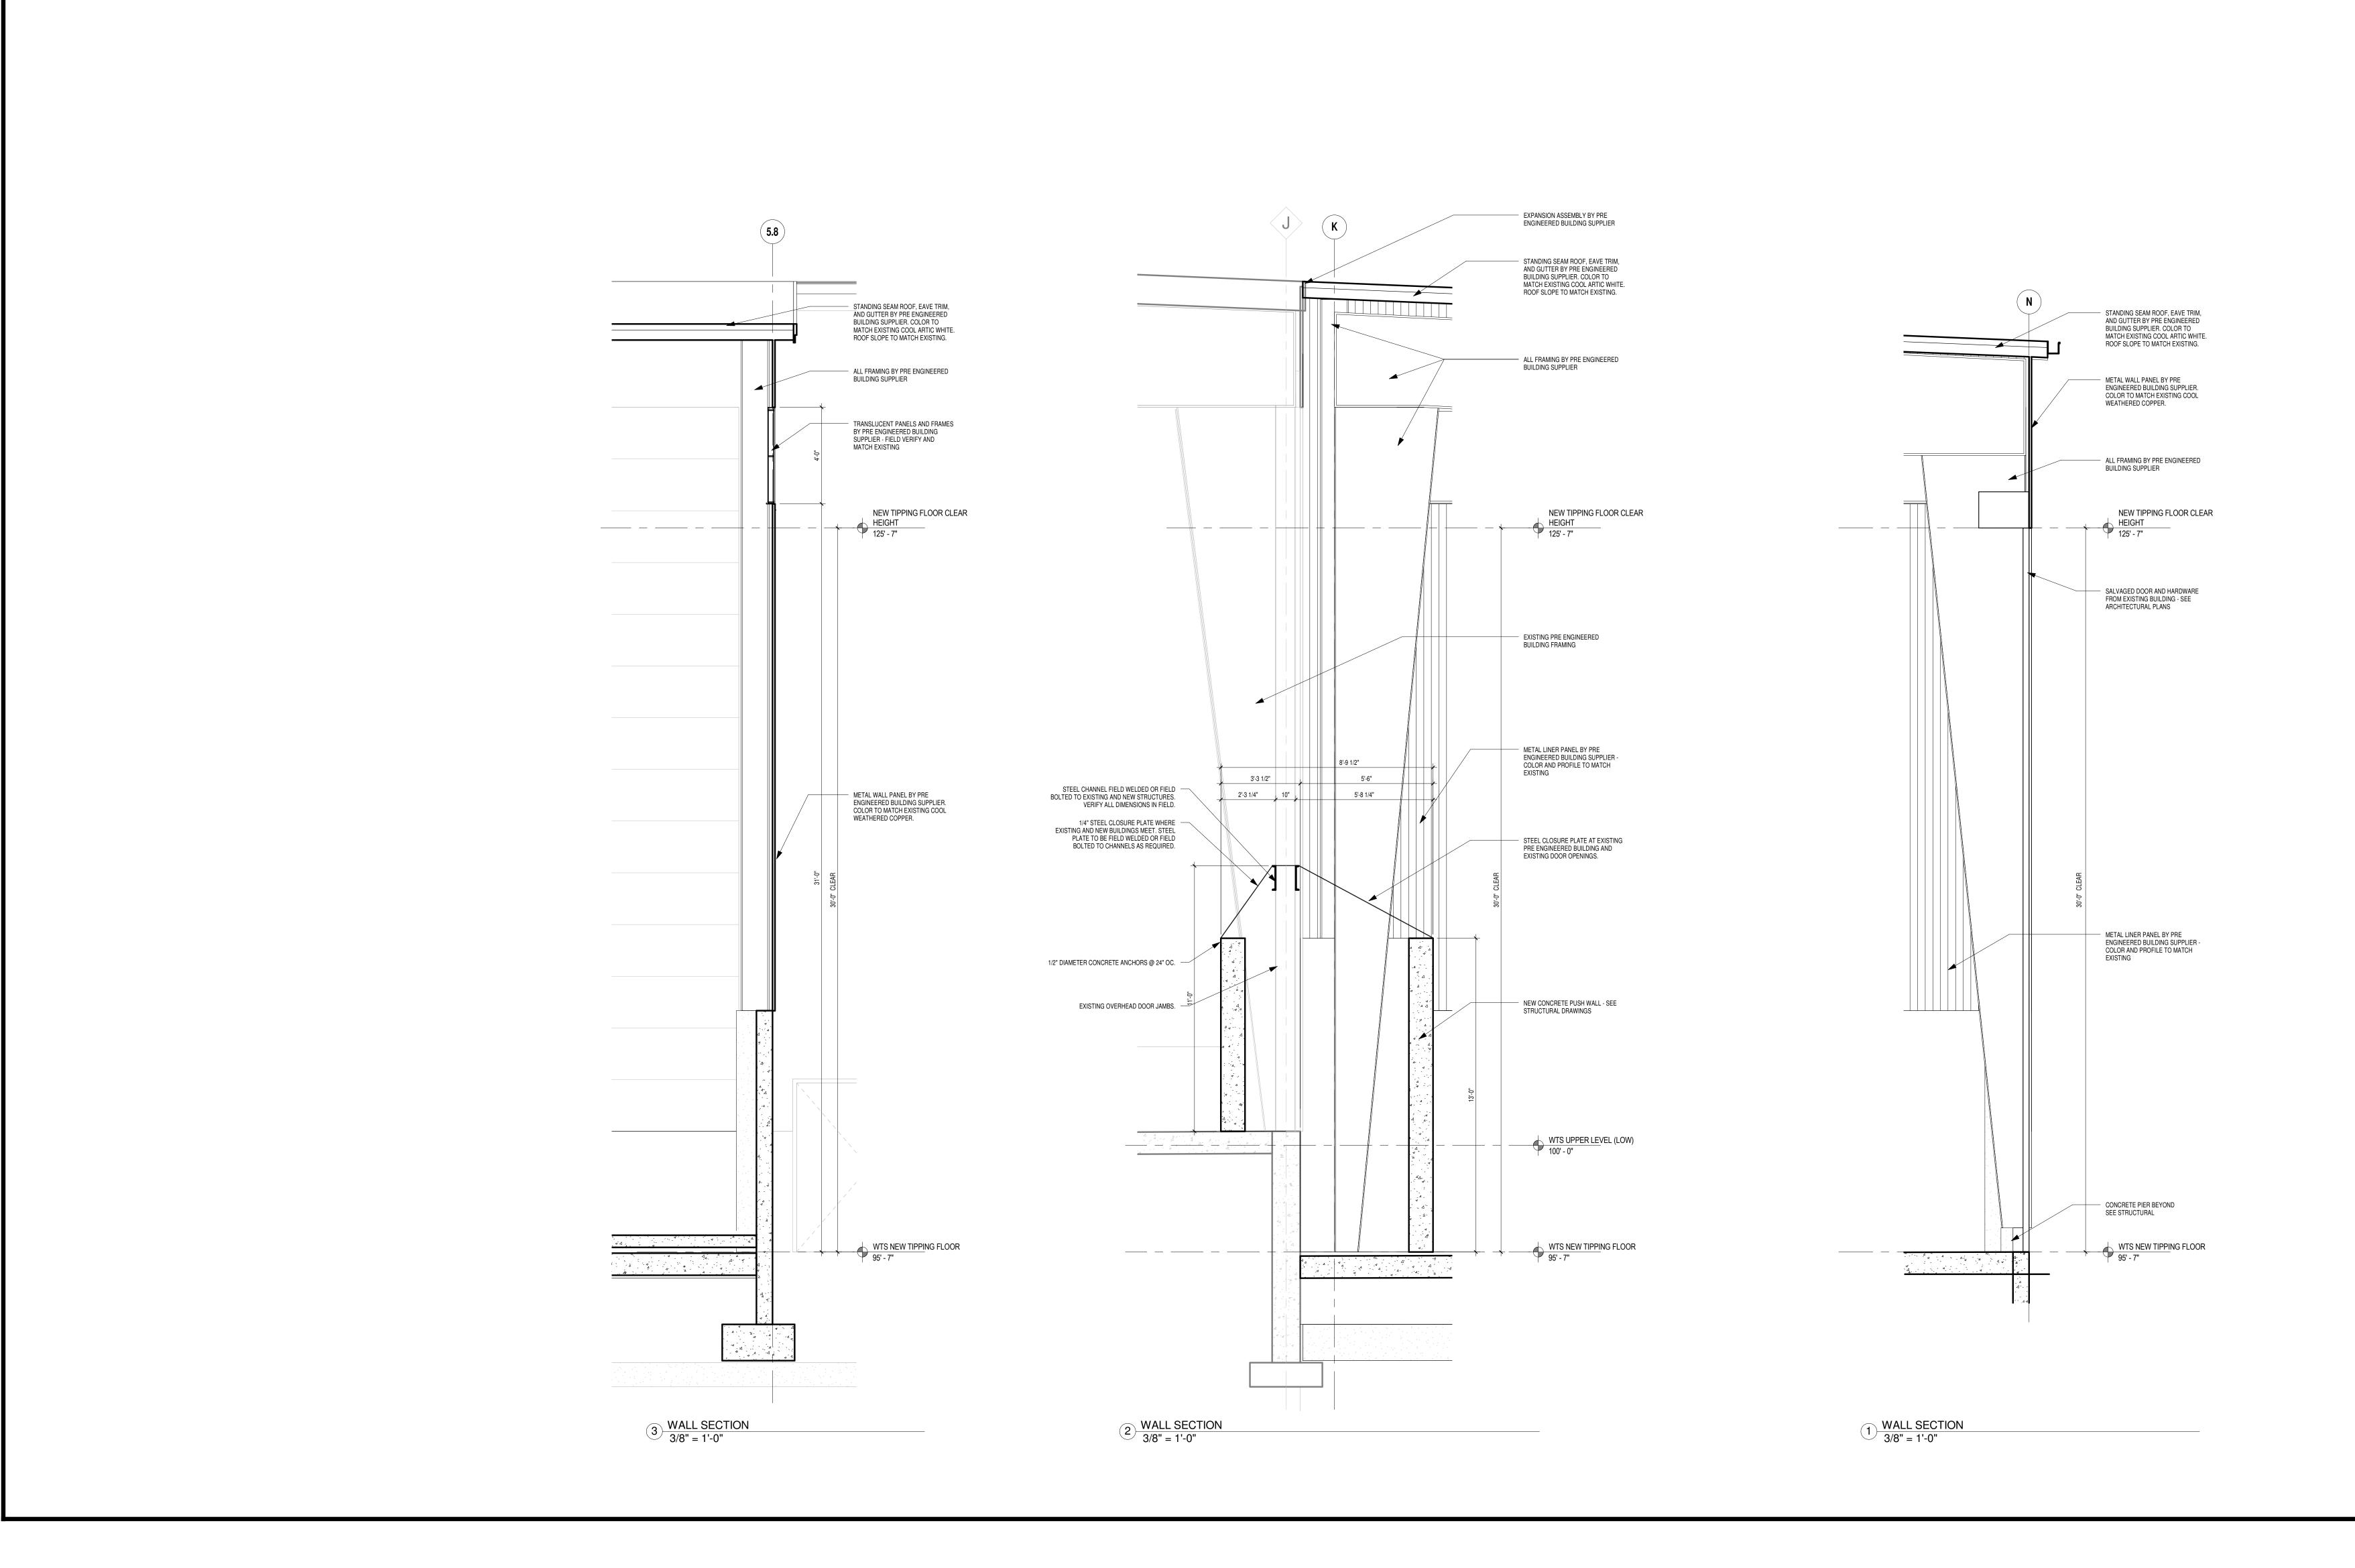

SCS ENGINEERS

2830 DAIRY DRIVE MADISON, WI 53718-6751
PHONE: (608) 224-2830

DORSCHNER
Associates

Architecture

CONSTRUCTION AND DEMOLITION WASTE RECYCLING FACILITY 7102 US HIGHWAY 12/18 MADISON, WISCONSIN

Planning

DANE COUNTY DEPARTMENT OF
PUBLIC WORKS
SOLID WASTE DIVISION
1919 ALLIANT ENERGY CENTER WAY
MADISON, WI 53713

PROCCESS AND CIVIL ENGINEER: SCS ENGINEERS

SCS ENGINEERS 2830 DAIRY DRIVE MADISON, WI 53718-6751 (608) 224-2830


ARCHITECT:
DORSCHNER ASSOCIATES, INC.
849 E. WASHINGTON AVE., SUITE 112
MADISON, WI 53703

STRUCTURAL ENGINEER:
PIERCE ENGINEERS, INC.
10 WEST MIFFLIN ST., SUITE 205

MECHANICAL, ELECTRICAL, PLUMBING DESIGN

MADISON, WI 53703

JDR ENGINEERING, INC. 5525 NOBEL DRIVE, SUITE 110 MADISON, WI 53711

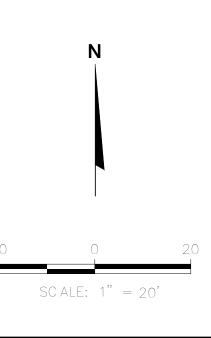

REVISION	DATE	ВҮ	TITLE
PROJEC T	NO:		14016-00
DRAWN:	•		02 16 15

PROJECT NO: 14016-00

DRAWN: 02.16.15


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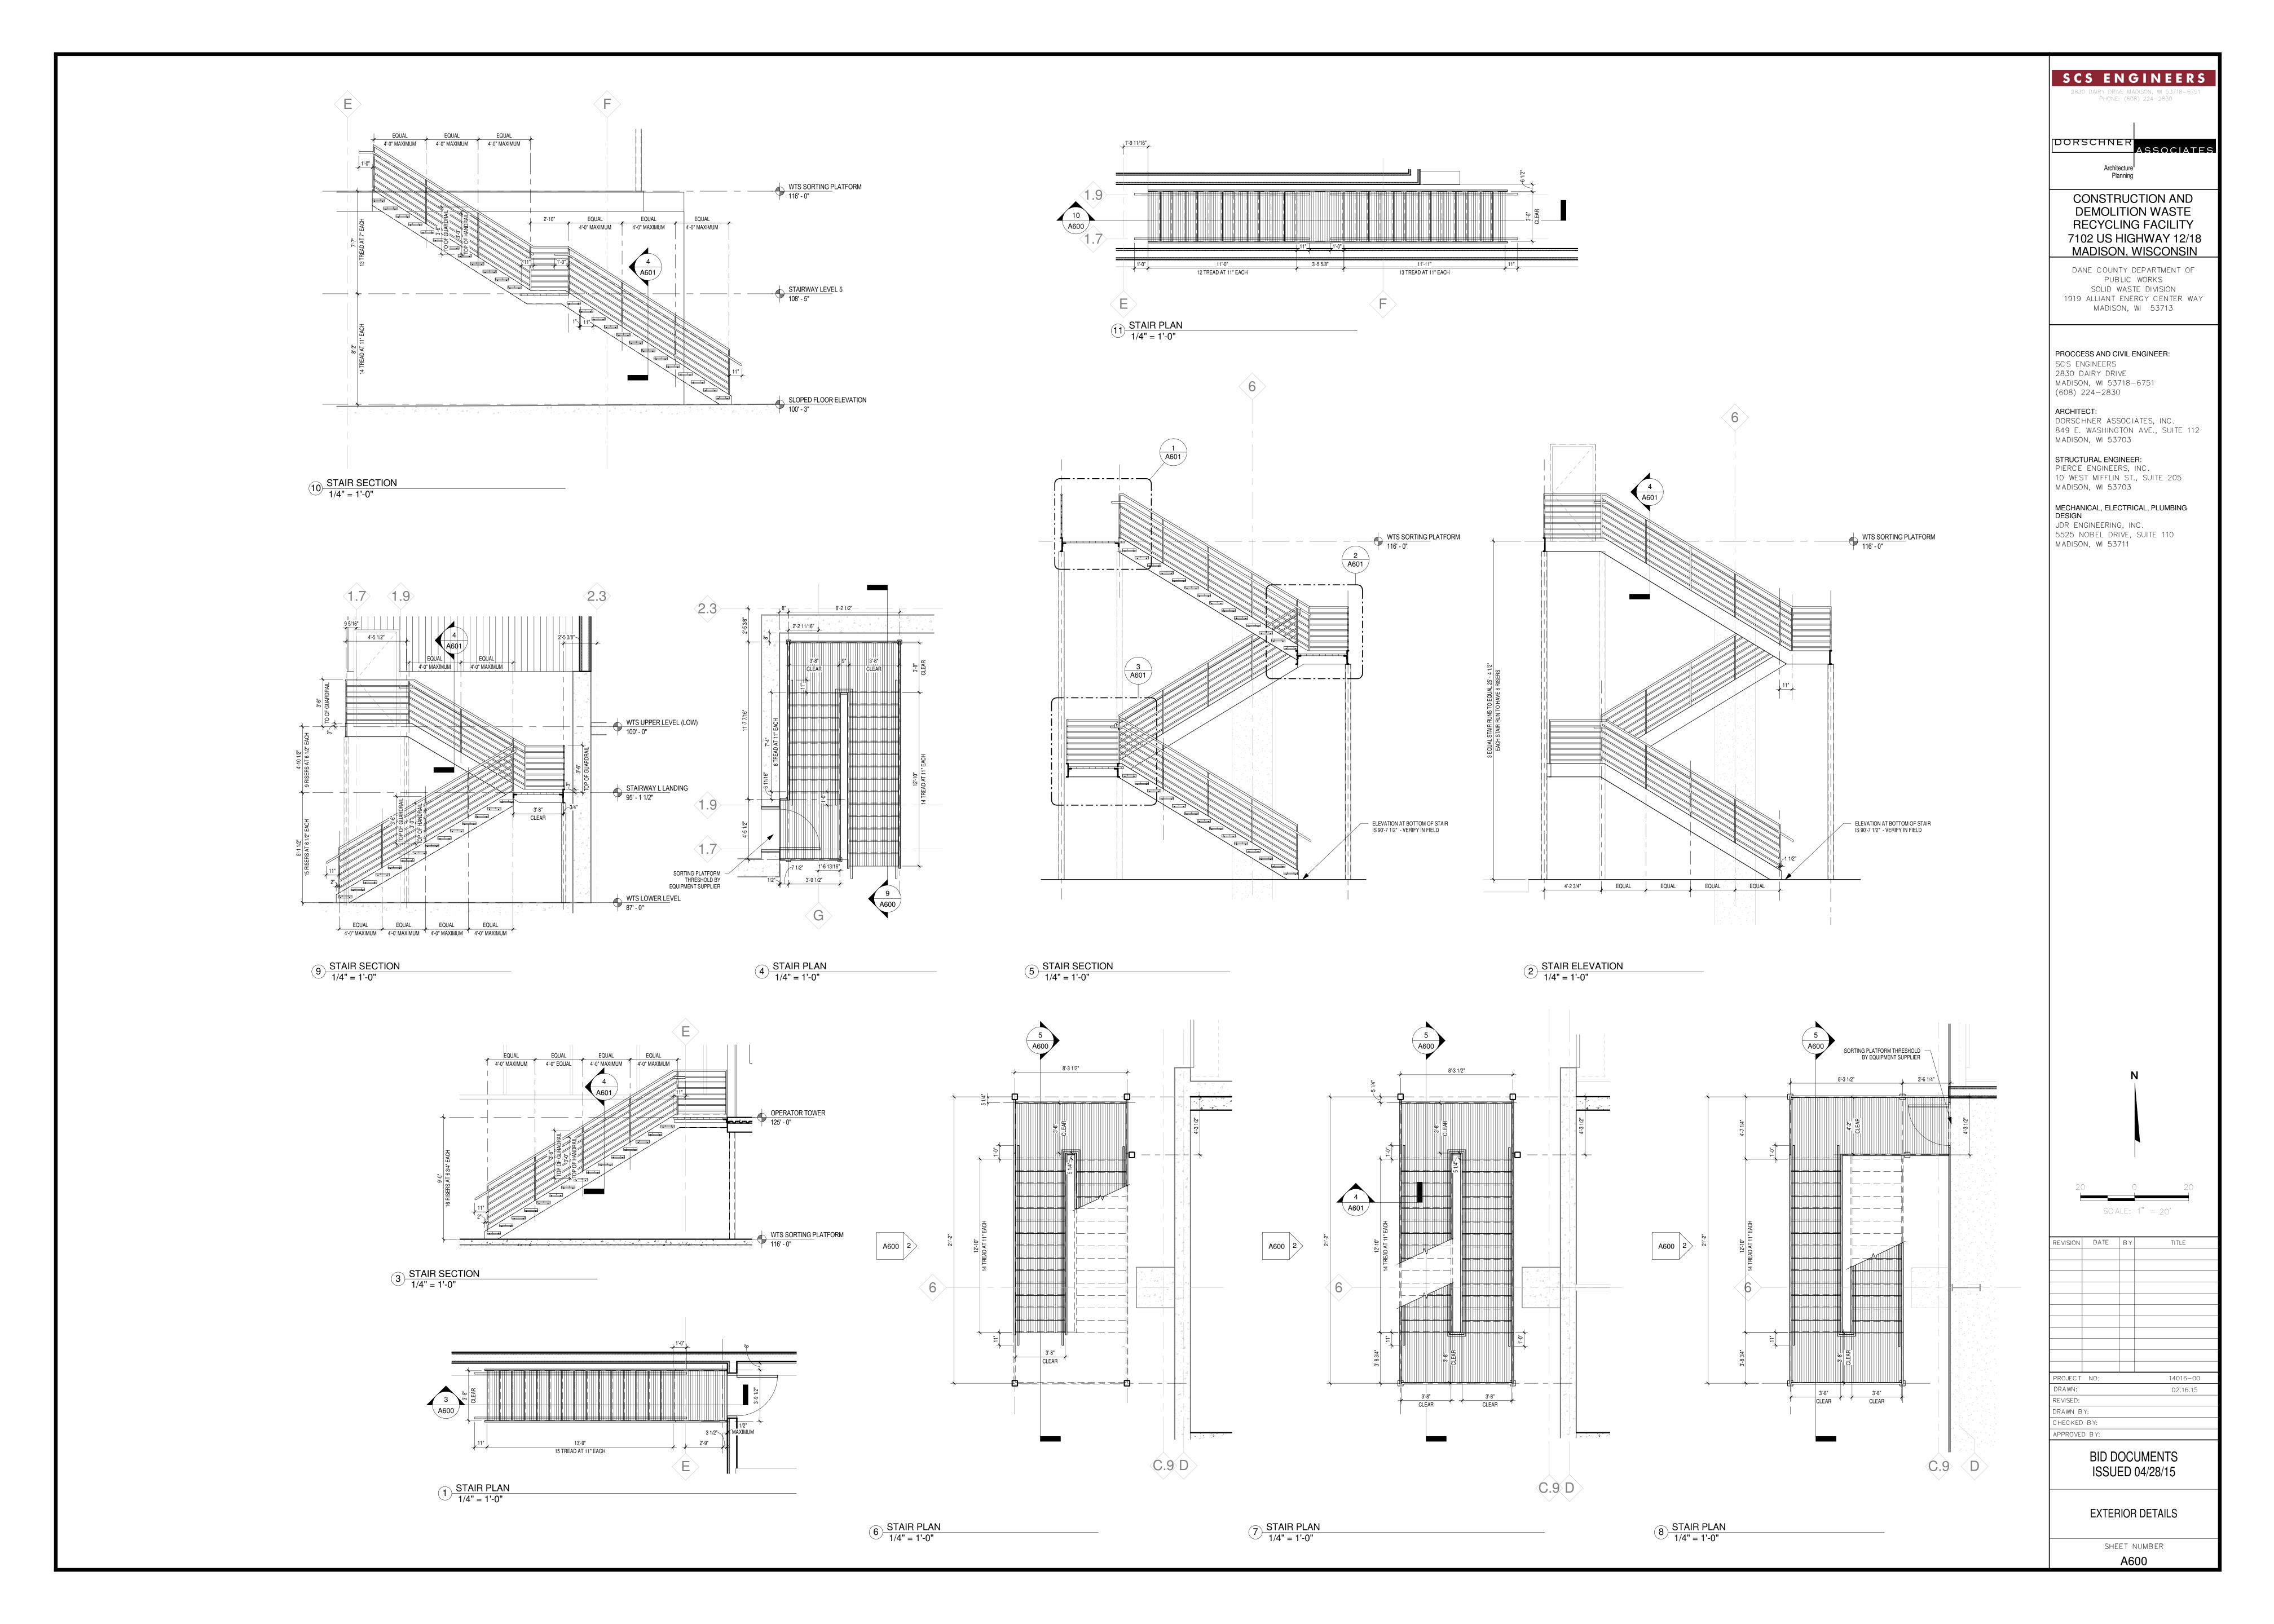
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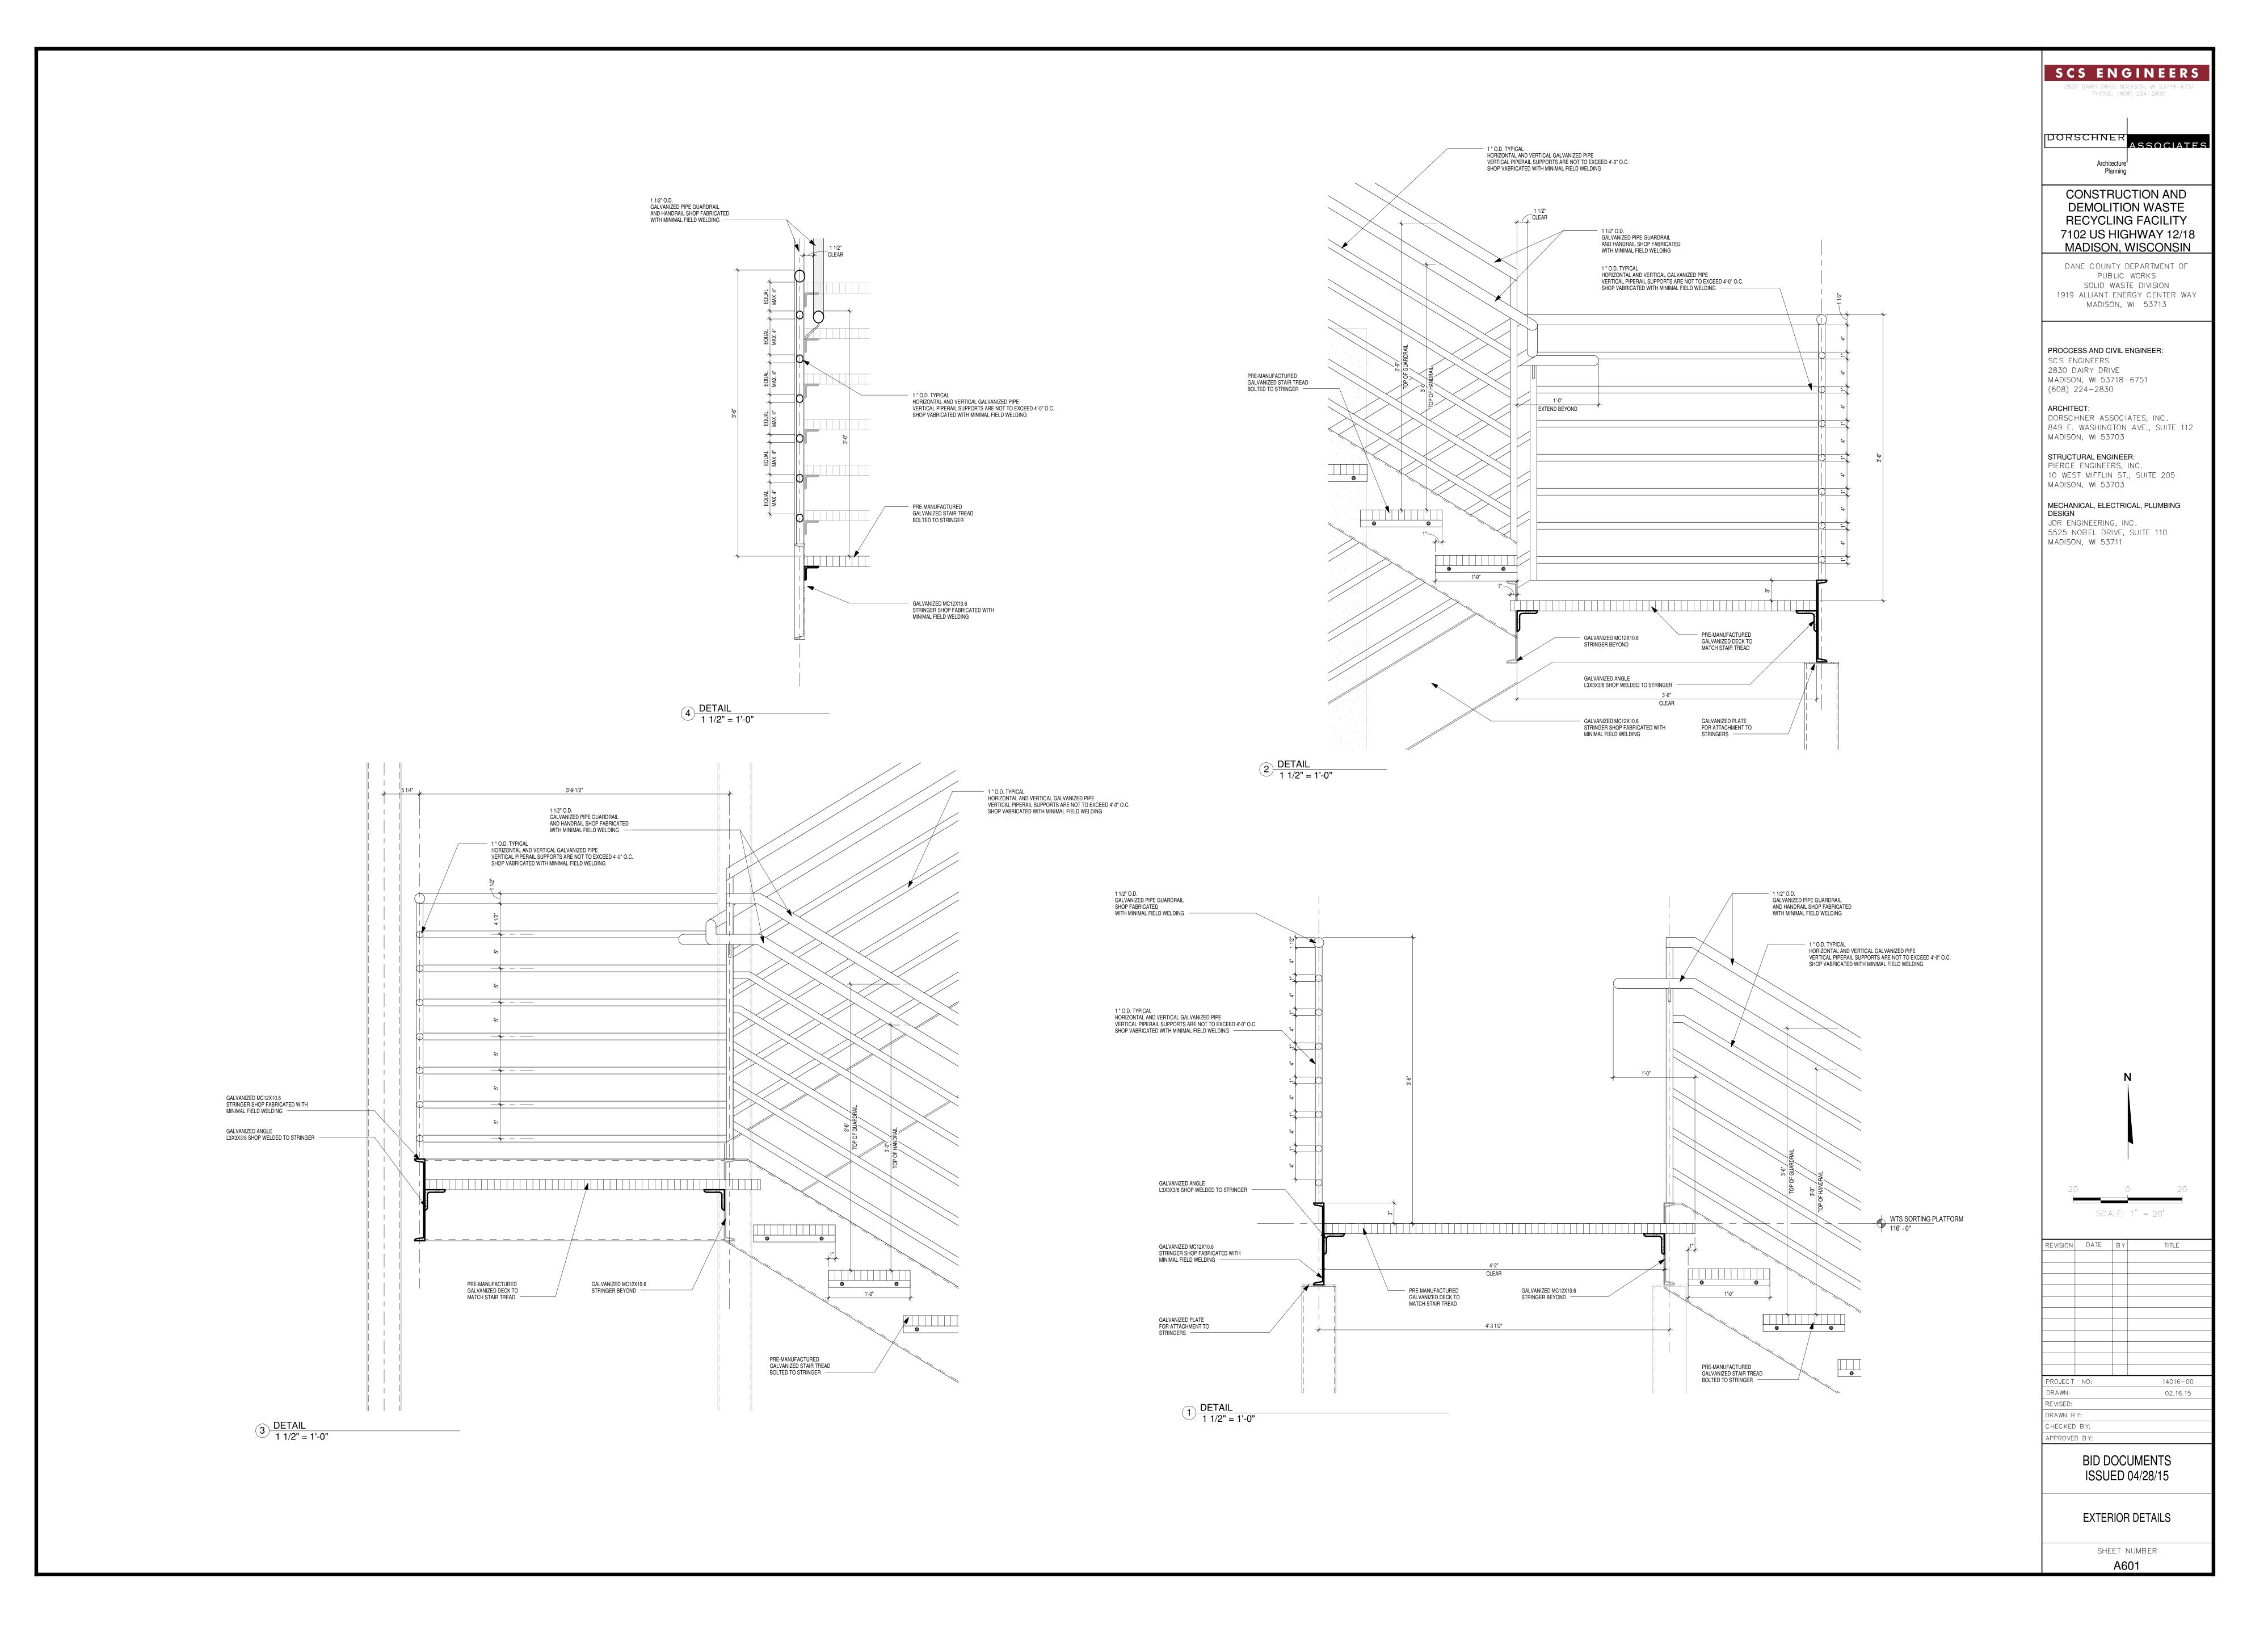
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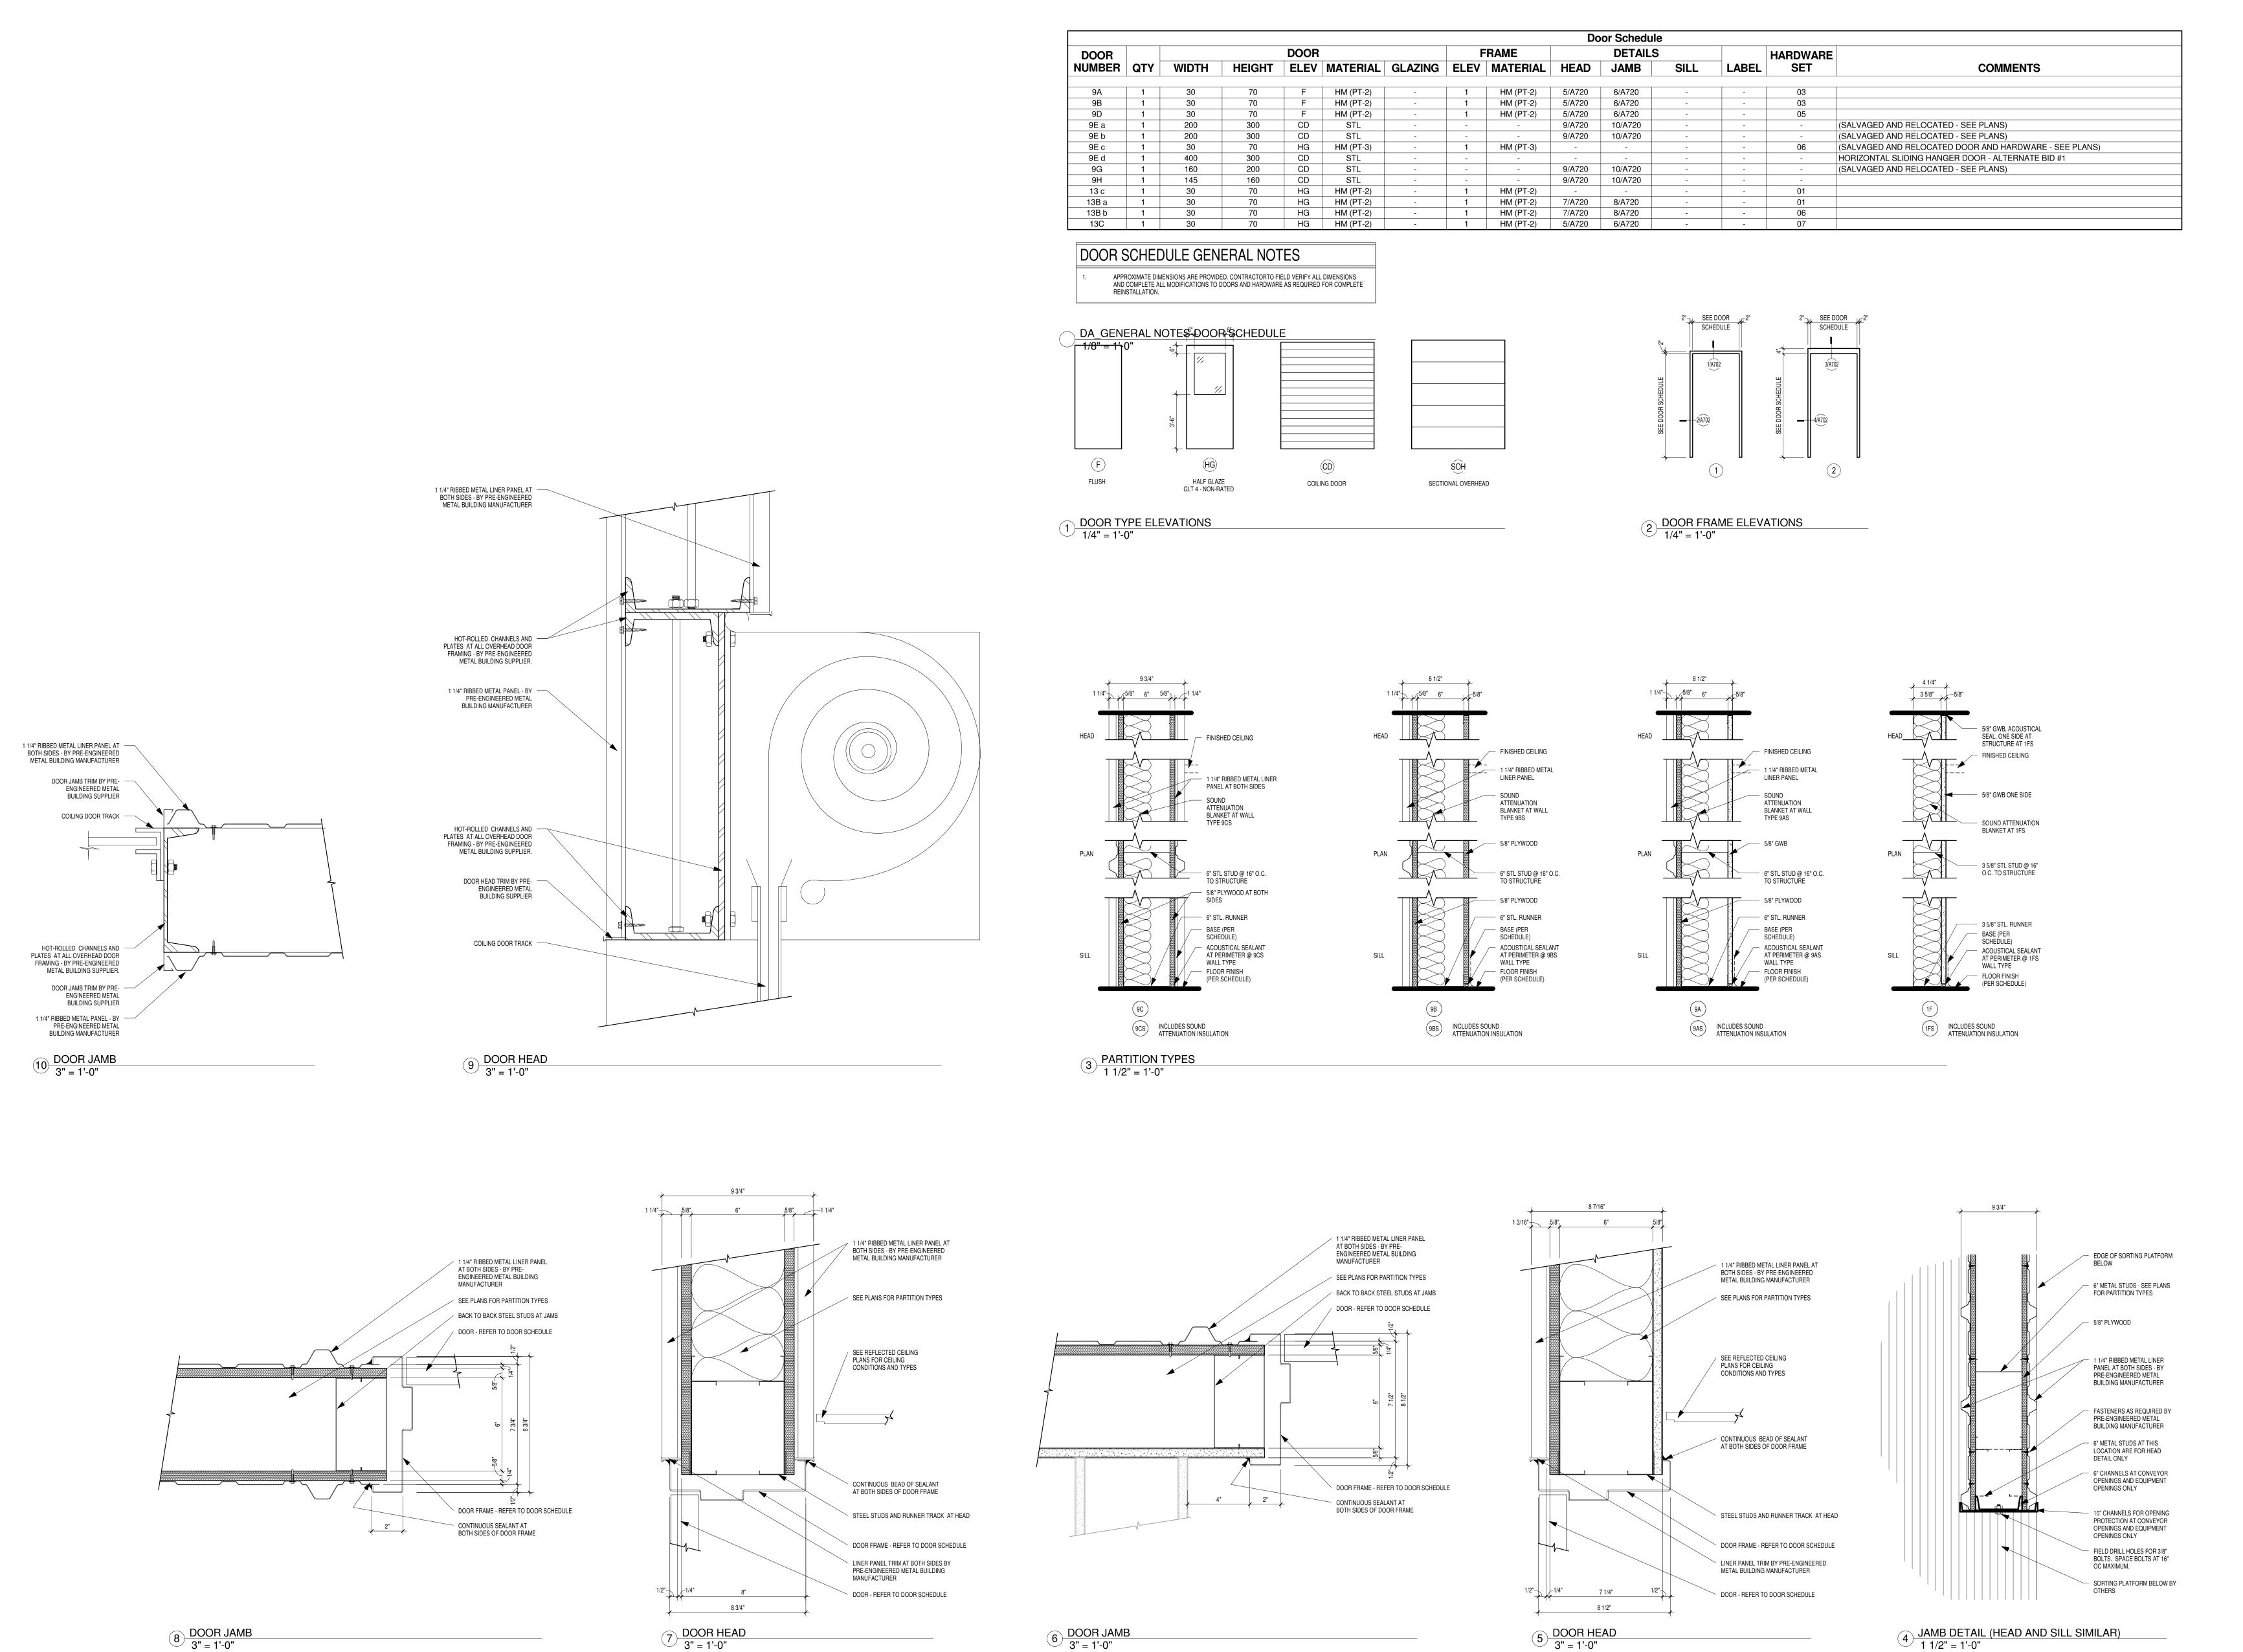
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WALL SECTIONS







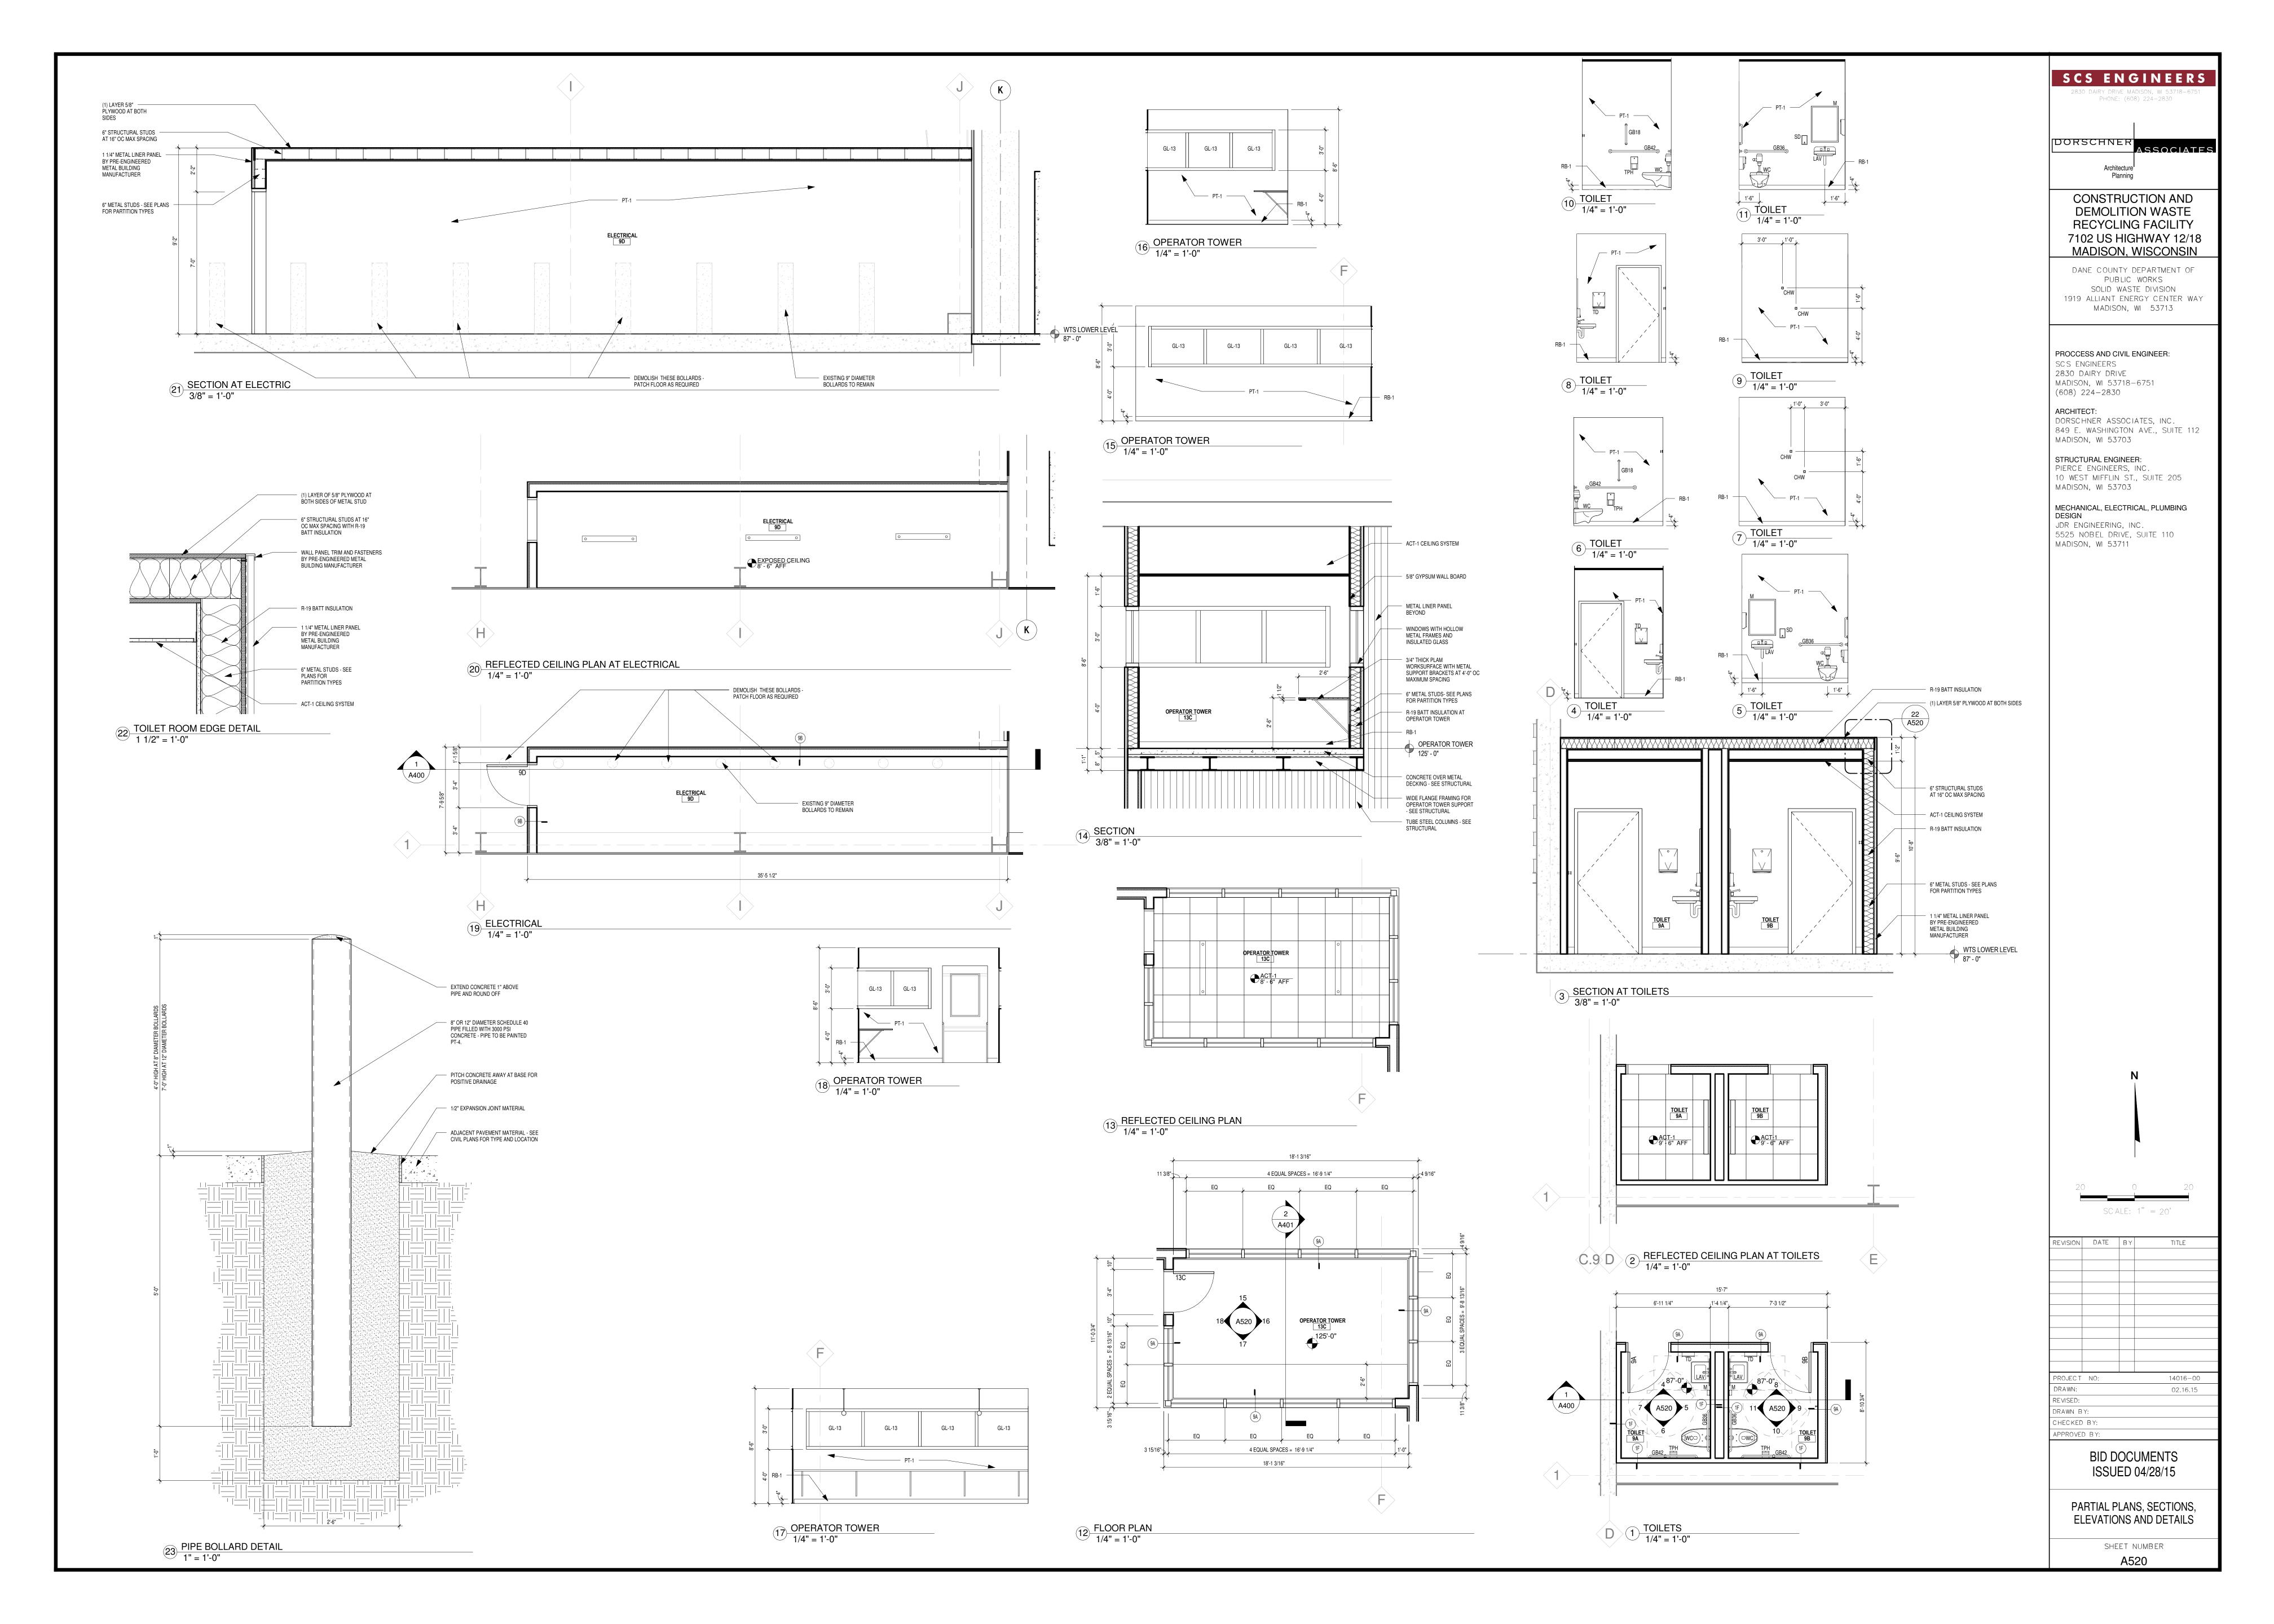

SCS ENGINEERS

2830 DAIRY DRIVE MADISON, WI 53718-6751
PHONE: (608) 224-2830

DORSCHNER ASSOCIATES

Architecture Planning

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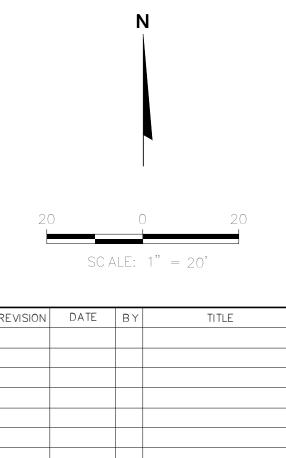
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PROJECT NO: 14016-00
DRAWN: 02.16.15
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HECKED BY:

DOOR SCHEDULES, DETAILS, AND PARTITION TYPES

DECICN DATA

DESIGN DAT	Ā		
DESIGN CODE: INTERNATIONAL BUILDING CODE 2006 (IBC)			
INTERNATIONAL BUILDING CODE 2000 (IBC)			
WIND LOAD INFORMATION:			
BASIC WIND SPEED	90 N	1PH	
BUILDING OCCUPANCY CATEGORY			
WIND LOAD IMPORTANCE FACTOR (IW) WIND EXPOSURE	1.00 C		
INTERNAL PRESSURE COEFFICIENTS	± .18	3	
COMPONENTS AND CLADDING (GROSS WIND PRESSURE)			
(FOR ZONE DEFINITIONS & DIAGRAMS SEE DESIGN (7 SECTION 6)	
WIDTH OF PRESSURE COEFFICIENT ZONE (a)	12.2		
TRIBUTARY WIND LOAD AREAS:	10 ft ²	<u>50 ft</u> 2	100 ft ²
ROOF (GABLE/HIP/MONOSLOPE):			
NEGATIVE ZONE 1	-22.7 psf	-21.4 psf	-20.8 ps
NEGATIVE ZONE 2	-38.2 psf	-28.7 psf	-24.7 ps
NEGATIVE PRESCUES ALL ZONES	-57.4 psf	-34.5 psf	-24.7 ps
POSITIVE PRESSURE ALL ZONES	10.0 psf	10.0 psf	10.0 ps
	<u>10 ft</u> 2	100 ft ²	500 ft ²
WALLS:	00.0	40.5	47.4
ZONE 4	-22.6 psf	-19.5 psf	-17.4 ps
ZONE 5	-27.8 psf	-21.6 psf	-17.4 ps
SEISMIC LOAD INFORMATION:			
SEISMIC USE GROUP / OCCUPANCY CATEGORY	II		
SEISMIC LOAD IMPORTANCE FACTOR (Ie)	1.00		
SEISMIC SITE CLASS	E	•	
MAPPED SPECTRAL RESPONSE ACCELERATION (Ss)	0.10		
MAPPED SPECTRAL RESPONSE ACCELERATION (S1) SPECTRAL RESPONSE COEFFICIENT (Sds)	0.04 0.18		
SPECTRAL RESPONSE COEFFICIENT (SdS) SPECTRAL RESPONSE COEFFICIENT (Sd1)	0.10		
SEISMIC DESIGN CATEGORY	B	3	
BASIC SEISMIC FORCE RESISTING SYSTEM		EL ORDINARY	
		MENT FRAMES	
RESPONSE MODIFICATION FACTOR	3.5		
SEISMIC RESPONSE COEFFICIENT (Cs)	0.05	1	
DESIGN BASE SHEAR	0.05	1W	
ANALYSIS PROCEDURE	EQU	IIVALENT LATE	ERAL FORC
SNOW LOAD INFORMATION:			
GROUND SNOW LOAD (Pg)	30 p	sf	
SNOW EXPOSURE FACTOR (Ce)	1.00		
SNOW LOAD IMPORTANCE FACTOR (Is)	1.00		
THERMAL FACTOR (Ct)	1.10		
DAIN ON ONOW OUR OUR DOE	1.20	AT OVERHAN	GS

MATERIAL DESIGN PROPERTIES

0 psf

0.32

35 pcf

55 pcf

200 pcf

Qa = 3,000psf

30 psf

RAIN ON SNOW SURCHARGE

LATERAL EARTH PRESSURE:

ACTIVE

AT-REST

PASSIVE

DESIGN/BALANCED SNOW LOAD (Ps)

ALLOWABLE NET SOIL BEARING PRESSURE

SOIL LOAD INFORMATION:
COEFFICIENT OF SLIDING FRICTION (µ)

IP CONCRETE STRENGTHS:	
FOOTINGS	f'c = 3000 psi
CONCRETE WALLS / PIERS / COLUMNS	f'c = 4000 psi
SLAB ON GRADE, UNO	f'c = 4000 psi
EXTERIOR SLAB ON GRADE	f'c = 4500 psi
TIPPING SLAB	f'c = 6000 psi
EINFORCING STEEL STRENGTHS:	
BARS (ASTM A 615, grade 60)	Fy = 60,000 psi
WWF (ASTM A 185)	Fy = 65,000 psi
TRUCTURAL STEEL STRENGTHS:	
WF SHAPES (ASTM A992)	Fy = 50,000 psi
ANGLES, CHANNELS, PLATES, & BARS (ASTM A36)	Fy = 36,000 psi
SQUARE & RECTANGULAR TS OR HSS SECTIONS (ASTM A500, grade B)	Fy = 46,000 psi
ROUND HSS SECTIONS (ASTM A500, grade B)	Fy = 42,000 psi
STEEL PIPE (ASTM A53, grade B)	Fy = 35,000 psi
HIGH STRENGTH BOLTS (ASTM A325)	•
ANCHOR BOLTS (ASTM F1554)	Fy = 36,000 psi
WELD ELECTRODES	E70 XX
HEADED WELDED STUDS (ASTM A108)	Fu = 55,000 psi
PRE-ENGINEERED METAL BUILDING	PER MANUFACTURE

EXISTING CONDITIONS NOTE

1. FIELD VERIFY ALL EXISTING CONDITIONS AS REQUIRED PRIOR TO DEMOLITION. REPORT DISCREPANCIES BETWEEN EXISTING CONDITIONS AND INFORMATION NOTED ON THE STRUCTURAL DRAWINGS TO THE STRUCTURAL ENGINEER FOR EVALUATION.

GENERAL FOUNDATION NOTES

- 1. ANCHOR BOLTS SHALL BE SET TO THE FOLLOWING TOLERANCES: ELEVATION OF TOP OF BOLTS +1" TO -3/8"
- OUT OF POSITION OF ANCHOR BOLTS ± 1/8" PROTECT IN-PLACE FOUNDATIONS AND SLABS ON GRADE FROM FROST PENETRATION UNTIL
- PROJECT COMPLETION WHERE FILL MATERIAL IS REQUIRED ON BOTH SIDES OF GRADE BEAMS OR WALLS, IT SHALL BE PLACED SIMULTANEOUSLY. REFER TO PLANS AND SPECIFICATIONS FOR TYPE AND PLACING OF
- WHERE FILL MATERIAL IS PLACED ON ONE SIDE OF A WALL (OR GRADE BEAM), THE WALL (OR BEAM) SHALL BE ADEQUATELY SHORED AND BRACED OR THE MATERIAL SHALL NOT BE PLACED UNTIL SUPPORTING FLOOR SLABS HAVE BEEN POURED AND SET. REFER TO ARCHITECTURAL DRAWINGS OR PLUMBING DRAWINGS FOR SPECIFIC FLOOR DRAIN
- LOCATIONS & ELEVATIONS. NO PROVISION HAS BEEN MADE FOR FUTURE EXPANSION. 7. VERIFY SIZES OF ALL STOOPS WITH ARCHITECT PRIOR TO CONSTRUCTION.

CAST-IN-PLACE CONCRETE NOTES

- 1. DESIGN AND CONSTRUCTION SHALL BE IN ACCORDANCE WITH THE LATEST PROVISIONS OF ACI
- CONTRACTOR SHALL NOTIFY THE ARCHITECT/ENGINEER AT LEAST 48 HOURS PRIOR TO PLACING CONCRETE TO FACILITATE ON SITE OBSERVATION OF REBAR. ARRANGEMENT AND BENDING OF REINFORCING STEEL SHALL BE IN ACCORDANCE WITH ACI DETAILING MANUAL (ACI SP-66), LATEST EDITION.

WHEN THE AVERAGE TEMPERATURE FROM MIDNIGHT TO MIDNIGHT IS EXPECTED TO DROP BELOW

40 DEGREES FAHRENHEIT FOR THREE SUCCESSIVE DAYS, COLD WEATHER CONCRETING REQUIREMENTS MUST BE FOLLOWED. WHEN AMBIENT AIR OR CONCRETE TEMPERATURES EXCEED 90 DEGREES FAHRENHEIT, STEEL REINFORCING AND/OR FORMING SURFACES ARE ABOVE 120 DEGREES, OR WHEN WIND VELOCITY,

HUMIDITY, OR SOLAR RADIATION CREATE CONDITIONS OF ACCELERATED MOISTURE LOSS AND

- INCREASED RATE OF HYDRATION, HOT WEATHER CONCRETING REQUIREMENTS SHALL BE FOLLOWED. 6. ALL HOOKS IN STEEL REINFORCING SHALL BE ACI STANDARD HOOKS, UNLESS NOTED OTHERWISE
- IN CONSTRUCTION DOCUMENTS. ALL CONCRETE SURFACES SHALL BE FORMED, UNLESS OTHERWISE NOTED. CONTROL JOINTS SHALL BE PLACED IN SLAB ON GRADE AND SLAB ON METAL DECK CONSTRUCTION WITHIN 24 HOURS OF INITIAL POUR.
- WIRE SPACERS, CHAIRS, TIES, ETC., FOR SUPPORT OF STEEL REINFORCING SHALL BE PROVIDED BY THE CONTRACTOR TO ENSURE REINFORCING IS PLACED IN THE PROPER POSITION DURING CONCRETE PLACEMENT. 10. STEEL REINFORCING SPLICES OF ADJACENT BARS SHALL BE STAGGERED SUCH THAT SPLICES ARE
- 4 FEET APART, MINIMUM. 11. PROVIDE (2) #5 BARS AROUND ALL OPENINGS AND (2) #5 DIAGONALLY AT ALL OPENING CORNERS UNLESS OTHERWISE SPECIFIED. EXTEND 2'-6" PAST OPENING TYPICALLY. 12. WELDED WIRE REINFORCING SHALL BE IN FLAT SHEETS ONLY, AND LAPPED A MINIMUM OF 6
- 13. WELDING OF STEEL REINFORCING IS NOT PERMITTED. 14. SLEEVES, CONDUITS, OR PIPES THROUGH SLABS AND WALLS SHALL BE PLACED AT THREE DIAMETERS ON CENTER, OR 4 INCHES MINIMUM.

15. ALUMINUM CONDUIT OR PIPING SHALL NOT BE CAST IN CONCRETE.

UNO OR SPECIFIED OTHERWISE.

16. PROVIDE A ¾" CHAMFER ON EXPOSED CORNERS OF CONCRETE UNO. TOP EDGES OF WALLS SHALL BE TOOLED UNO. 17. FINISH & COVER CONCRETE SLABS w/ FILM FORMING CURING COMPOUND OR VAPOR RETARDER

HOT WEATHER CONCRETING NOTES

- CONCRETE MIXES TO BE PLACED DURING DRY AND WINDY CONDITIONS SHALL BE MODIFIED BY THE ADDITION OF RETARDING ADMIXTURES OR SLOWER CURING CEMENT SUBSTITUTES TO MINIMIZE THE EFFECTS OF ACCELERATED CURING. WATER SHALL NOT BE ADDED TO CONCRETE MIXES ON SITE FOR WORKABILITY. MID OR HIGH
- RANGE WATER REDUCERS SHALL BE APPROVED BY ENGINEER BEFORE ADDING TO CONCRETE MIX FOR INCREASED WORKABILITY. INGREDIENTS USED IN CONCRETE MIXES SHALL BE COOLED TO MAINTAIN A CONCRETE
- TEMPERATURE BELOW 90 DEGREES FAHRENHEIT AT TIME OF PLACEMENT. 4. CHILLED WATER AND CHOPPED ICE MAY BE USED IN CONCRETE MIXTURES TO CONTROL CONCRETE TEMPERATURES. AMOUNT OF CHOPPED ICE SHALL NOT EXCEED THE EQUIVALENT
- AMOUNT OF MIXING WATER REQUIRED FOR THE DESIGN MIX. RETARDING ADMIXTURES SHALL NOT BE USED IN CONCRETE MIXES WITHOUT THE APPROVAL OF THE ENGINEER.

COLD WEATHER CONCRETING NOTES

- 1. SNOW, FROST, AND ICE SHALL BE REMOVED FROM ALL SURFACES, INCLUDING REINFORCING, AGAINST WHICH THE CONCRETE IS TO BE PLACED DO NOT PLACE CONCRETE ON FROZEN SUBGRADE.
- THE MINIMUM PLACEMENT AND PROTECTION TEMPERATURE OF CONCRETE SHALL BE AS MINIMUM TEMP OF CONCRETE AS PLACED AND MAINTAINED **DURING PROTECTION PERIOD**
- LEAST DIMENSION OF SECTION (DEGREES FAHRENHEIT) LESS THAN 12" 12" TO LESS THAN 36 36" TO 72" **GREATER THAN 72"**
- TEMPERATURES OF CONCRETE SHALL BE MEASURED AT THE CONCRETE SURFACE. 5. CONCRETE TEMPERATURES SHALL BE MEASURED AND RECORDED FOR THE FIRST 3 DAYS UPON PLACEMENT OF CONCRETE, AT THE BEGINNING, MIDDLE, AND END OF EACH WORK DAY AT 4 HOUR INTERVALS. OVERNIGHT TEMPERATURE MEASUREMENTS ARE NOT REQUIRED. 6. HEATED AIR TEMPERATURES SHALL NOT EXCEED THE REQUIRED CONCRETE TEMPERATURES
- LISTED IN TABLE ABOVE BY MORE THAN 20 DEGREES. 7. CONCRETE SHALL BE CURED AND PROTECTED AGAINST DAMAGE FROM FREEZING FOR A MINIMUM PERIOD OF 3 DAYS.
- 8. DURING PERIODS NOT DEFINED AS COLD WEATHER, BUT WHEN FREEZING TEMPERATURES MAY OCCUR, PROTECT CONCRETE SURFACES FROM FREEZING FOR THE FIRST 24 HOURS AFTER PLACEMENT.
- 9. IF TEMPERATURE REQUIREMENTS DURING PROTECTION PERIOD ARE NOT MET, BUT CONCRETE WAS PREVENTED FROM FREEZING, CONTACT ARCHITECT/ENGINEER FOR EXTENT OF ADDITIONAL PROTECTION TIME REQUIRED.

CLASS 'B' TENSION LAP SPLICE LENGTHS (INCHES)

BAR SIZE	fc=	3000	fc = 4000		
CLASS	вот	TOP	вот	TOP	
#3	22	28	19	24	
#4	29	37	25	33	
#5	36	47	31	41	
#6	43	56	37	49	
#7	63	81	54	71	
#8	72	93	62	81	
#9	81	105	70	91	
#10	91	118	79	102	
#11	101	131	87	113	

- NOTES (d_b = BAR DIAMETER, C-C = CENTER TO CENTER):
- 1. SCHEDULE BASED ON CLEAR COVER >1 d_b AND C-C > 2d_b 2. TOP BARS OF BEAMS AND JOIST AND HORIZONTAL WALL REINFORCING THIS SCHEDULE IS PROVIDED FOR THE CONVENIENCE OF THE CONTRACTOR AND IS NOT INTENDED TO COVER ALL SITUATIONS. SHOP DRAWINGS SHALL CLEARLY INDICATE ALL REQUIRED LAP LENGTHS

CAST-IN-PLACE CONCRETE TOLERANCES

- 1. CONCRETE COVER MEASURED PERPENDICULAR FROM THE SURFACE IN DIRECTION OF TOLERANCES: MEMBERS 12" OR LESS MEMBERS OVER 12"
- 2. STEEL REINFORCEMENT SPACING SHALL BE WITHIN THE FOLLOWING TOLERANCES: 1/4" SPACING DISTANCE, NOT TO EXCEED 1" 3. PLACEMENT OF EMBEDDED ITEMS SHALL BE WITHIN THE FOLLOWING TOLERANCES:
- VERTICAL ALIGNMENT LATERAL ALIGNMENT LEVEL ALIGNMENT
- 4. PLACEMENT OF FOOTINGS SHALL BE WITHIN THE FOLLOWING TOLERANCES: LATERAL ALIGNMENT +½" TO -2" LEVEL ALIGNMENT
- (LEVEL ALIGNMENT SUPPORTING MASONRY) CROSS-SECTIONAL DIMENSION OF FOOTINGS SHALL BE WITHIN THE FOLLOWING TOLERANCES FORMED FOOTINGS +2" TO -½"
- EARTHCAST FOOTINGS: +3" TO -½" 2' OR LESS GREATER THAN 2' BUT LESS THAN 6' +6" TO -½" +12" TO -½" **GREATER THAN 6'** FOOTING THICKNESS
- TOP OF FOOTING SLOPE 7. SEE DRILLED PIER NOTES FOR ADDITIONAL INFORMATION AT DRILLED PIER FOUNDATIONS.

MILD STEEL PROTECTION

FOOTINGS - BOTTOM & SIDES	3"
FOOTING - TOP	2"
PERIMETER WALLS - #5 & SMALLER PERIMETER WALLS - #6 & LARGER	1½" 2"
INTERIOR WALLS	3/4"
BEAMS, PIERS, & COLUMNS SLABS - BOTTOM & SIDES	1½" 1"
SLABS - TOP	3/4"

STRUCTURAL STEEL NOTES

- 1. FABRICATION AND ERECTION OF STRUCTURAL STEEL SHALL CONFORM WITH THE AISC (AMERICAN INSTITUTE OF STEEL CONSTRUCTION), "MANUAL OF STEEL CONSTRUCTION", LATEST EDITION. ALL STEEL DETAILS AND CONNECTIONS SHALL BE IN ACCORDANCE WITH THE REQUIREMENTS OF THE AISC "SPECIFICATIONS FOR STRUCTURAL STEEL BUILDINGS, ALLOWABLE STRESS DESIGN AND PLASTIC DESIGN", LATEST EDITION.
- FABRICATORS SHALL DESIGN CONNECTIONS NOT SPECIFICALLY DETAILED ON PLANS AS FOLLOWS: A. GENERAL: MEMBERS REQUIRING END MOMENT CONNECTIONS SHALL MEET THE REQUIREMENTS OF TYPE 1 "RIGID FRAME" CONSTRUCTION INCLUDING FRICTION
- BOLTS IF UTILIZED. ALL OTHER MEMBERS SHALL FOLLOW THE REQUIREMENTS OF TYPE 2 "SIMPLE" CONSTRUCTION. B. MEMBER SHEAR CONNECTIONS: UNLESS A LARGER END VERTICAL REACTION IS SHOWN

OTHERWISE ON THE DRAWINGS (IE R = 85k), MINIMUM DESIGN SHEAR FORCES SHALL BE I. NON-COMPOSITE BEAMS: SUPPORT A REACTION "R" EQUAL TO ONE HALF THE TOTAL

UNIFORM LOAD CAPACITY FROM THE TABLE OF UNIFORM LOAD CONSTANTS IN THE

- AISC MANUAL PART 2 FOR GIVEN SHAPE, SPAN, AND GRADE OF STEEL. 4. USE A325N BOLTS UNLESS NOTED OTHERWISE. 5. SPLICES SHALL BE ALLOWED ONLY AT LOCATIONS SPECIFICALLY INDICATED ON THE STRUCTURAL DRAWINGS UNLESS APPROVED OTHERWISE BY THE ENGINEER. 6. OVERSIZED OR SLOTTED HOLES SHALL NOT BE USED FOR ANY CONNECTIONS UNLESS
- SPECIFICALLY INDICATED ON THE DRAWINGS OR APPROVED BY THE ENGINEER. BEAM AND GIRDER CONNECTIONS SHALL BE AS NOTED ON PLANS AND IN DETAILS. 8. PROVIDE HOLES IN ALL STEEL AS REQUIRED TO PREVENT ANY ACCUMULATION OF WATER DURING ERECTION. ALL PENETRATIONS THROUGH MAIN MEMBERS SHALL NOT EXCEED 11/5" IN DIAMETER AND
- SHALL BE GROUND SMOOTH. CUTS, HOLES, COPING, ETC. REQUIRED FOR WORK OF OTHER TRADES SHALL BE SHOWN ON THE SHOP DRAWINGS AND MADE IN THE SHOP. CUTS OR BURNING OF HOLES IN STRUCTURAL STEEL MEMBERS IN THE FIELD WILL NOT BE PERMITTED. 10. PROVIDE ANY NECESSARY TEMPORARY BRACING OR GUYS TO PROVIDE LATERAL SUPPORT OF THE
- 11. STRUCTURAL STEEL FRAMING SHALL BE TRUE AND PLUMB BEFORE CONNECTIONS ARE FINALLY BOLTED OR WELDED. 12. THE DETAILS OF DESIGN, WORKMANSHIP, AND TECHNIQUE FOR WELDING, INSPECTION OF WELDING, AND QUALIFICATIONS OF WELDING OPERATORS SHALL CONFORM TO THE REQUIREMENTS OF THE

BUILDING UNTIL PERMANENT FRAME IS COMPLETELY INSTALLED.

SPECIFICATIONS LISTED IN IBC SECTIONS 2205, 2206, 2207, 2209, AND 2210.

STRUCTURAL ABBREVIATIONS

WORD OR PHRASE

ABBRV.

_ EDGE OF STEEL

__ EQUAL

_ EACH WAY

_EXISTING

_EXTERIOR

FINISH

__FLOOR

_ FRAMING

_FOOTING

_ GALVANIZED

_ GRADE BEAM

_ GIRDER TRUSS

_GYPSUM

_HEIGHT

_ JOIST

_ INSIDE FACE

_INFORMATION

__HORIZONTAL

_ GENERAL CONTRACTOR

_ HORIZONTAL INSIDE FACE

_ HEADED WELD STUD

_ KIPS PER SQUARE INCH

_ HORIZONTAL OUTSIDE FACE

_ HOLLOW STRUCTURAL SECTION VIF_

__ HEATING, VENTILATING & AIR COND. w/ ____

__ GAGE

_EXPANSION

_ FLOOR DRAIN

_ FOUNDATION

_ FINISH FLOOR

EXIST

FRMG

FTG _

GALV.

HORIZ_

INFO__

EOS_

<u> </u>	WORLD CITTIFICAL	7 (BB) (V.	
@	AT	LL	_ LIVE LOAD
&	AND		LONG LEG HORIZONTAL
AB	ANCHOR BOLT	LLV	LONG LEG VERTICAL
ALT	ALTERNATE	LSL	LAMINATED STRAND LUMBER
APA	AMERICAN PLYWOOD ASSOC.	LVL	LAMINATED VENEER LUMBER
ARCH	ARCHITECT(URAL)	LW	LONG WAY
BC	BOTTOM CHORD ^	MFR	MANUFACTURER
BLDG	BUILDING	MAX	MAXIMUM
BLKG	BLOCKING	MECH	MECHANICAL
BM	BEAM	MIN	MINIMUM
BOT	BOTTOM	MISC	MISCELLANEOUS
BRG			NOT IN CONTRACT
	CENTERLINE		NOT TO SCALE
	COLUMN BASE	OC	
CIP	CAST-IN-PLACE	O.F	OUTSIDE FACE
	CENTERLINE	OPP	
CLR		PARA	PARALLEL
CJ	_ CONTROL OR CONSTRUCTION JOINT		
CMU	CONCRETE MASONRY UNIT	PCF	POUNDS PER CUBIC FOOT
COL		PERP	PERPENDICULAR
	CONCRETE	ዊ	STEEL PLATE
	CONTINUOUS	PLY	
	DECK BEARING ANGLE		POUNDS PER SQUARE INCH
	DEFLECTION		POUNDS PER SQUARE FOOT
	DEMOLITION		PARALLEL STRAND LUMBER
DFL	DOUGLAS FIR LARCH		POST TENSIONED CONCRETE
DIA (Ø)	DIAMETER	PT	PRESSURE TREATED
DIM`	DIMENSION	REINF	REINFORCEMENT
	DEAD LOAD	REQD	REQUIRED
DTL	DETAIL	RTU	ROOF TOP UNIT
DWL	DOWEL	SCHD	SCHEDULE
DWG		SHT	
EA		SIM	SIMILAR
	EACH FACE		SHEET METAL SCREWS
	EXPANSION JOINT		SLAB ON GRADE
EL			SPECIFICATION
EMBED	EMBEDMENT		SPRUCE-PINE-FIR
	EDGE OF SLAB	SQ	SQUARE

SYM_

TRANS_

 UNO_-

VERT_

VOF___

w/o ____

_ STAINLESS STEEL

_ STRUCTURAL

 $_{-}$ SHORT WAY

_ SYMMETRICAL

_ TOP CHORD

_ TOP AND BOTTOM

SOUTHERN YELLOW PINE

TONGUE AND GROOVE

TOP OF FOOTING ELEVATION

TOP OF CONCRETE ELEVATION

TOP OF LEDGE ELEVATION

_ TOP OF SLAB ELEVATION

_ TOP OF STEEL ELEVATION

TOP OF PIER ELEVATION

_ TOP OF WALL ELEVATION

_ UNLESS NOTED OTHERWISE

_ VERTICAL INSIDE FACE

__ VERTICAL OUTSIDE FACE

_ TOP OF PILE CAP

TRANSVERSE

_ TUBE STEEL

TYPICAL

_ VERTICAL

 $_$ WITHOUT

_ WEIGHT

FRAME

WIDE FLANGE

_ Workpoint

_____ WELDED WIRE FABRIC

SCBF _____ SPECIAL CONCENTRIC BRACED

SLRS _____ SEISMIC LOAD RESISTING SYSTEM SMF _____ SPECIAL MOMENT FRAME

__ WITH

__ STEEL

PROCESS AND CIVIL ENGINEER: SCS ENGINEERS 2830 DAIRY DRIVE

SCS ENGINEERS

CONSTRUCTION AND

DEMOLITION WASTE

RECYCLING FACILITY

7102 US HWY 12/18

MADISON, WISCONSIN

DANE COUNTY DEPARTMENT OF

PUBLIC WORKS

SOLID WASTE DIVISION

1919 ALLIANT ENERGY CENTER WAY

MADISON, WI 53713

2830 DAIRY DRIVE MADISON, WI 53718-6751 PHONE: (608) 224-2830

MADISON, WI 53718-6751 (608) 224-2830

DORSCHNER ASSOCIATES, INC. 849 E. WASHINGTON AVE., SUITE 112

MADISON, WI 53703 STRUCTURAL ENGINEER:

PIERCE ENGINEERS, INC. 10 WEST MIFFLIN ST., SUITE 205 MADISON, WI 53703

MECHANICAL, ELECTRIC, PLUMBING JDR ENGINEERING, INC.



PIERCE ENGINEERS INC

CONSULTING STRUCTURAL ENGINEER 10 West Mifflin St, Suite 205 | Madison, WI 53703 Phone: 608.256.7304 | Fax: 608.256.7306


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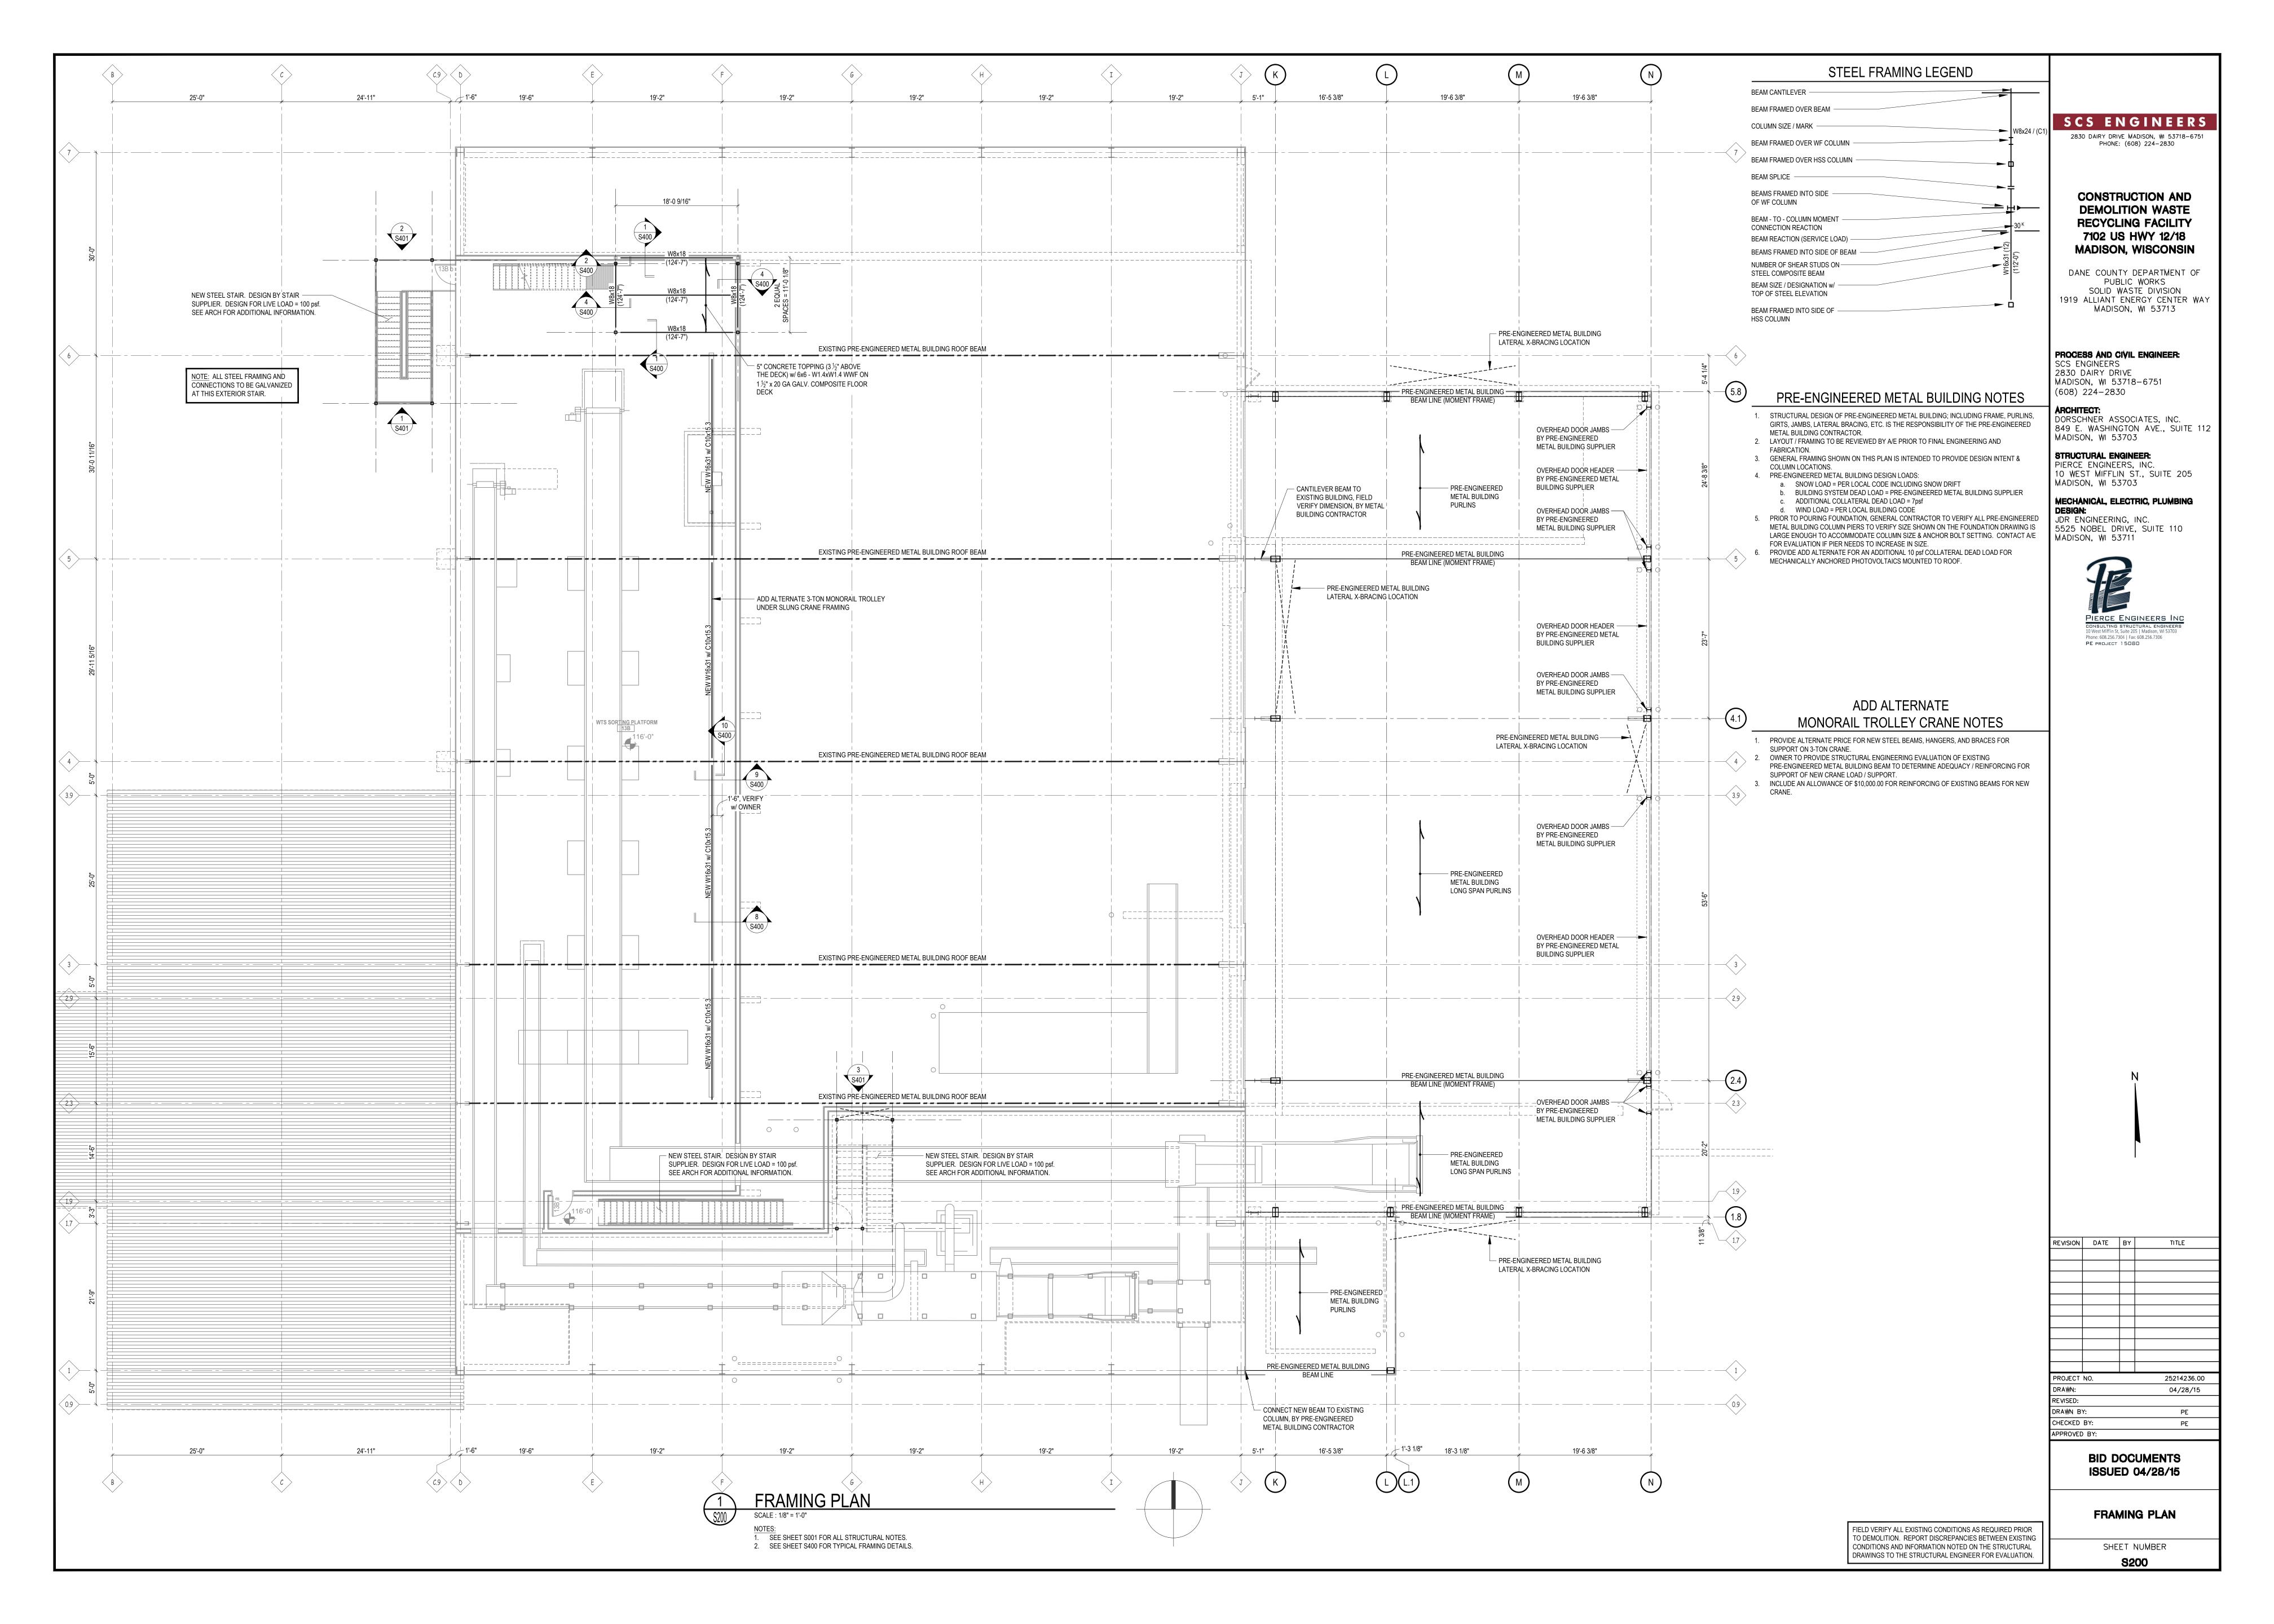
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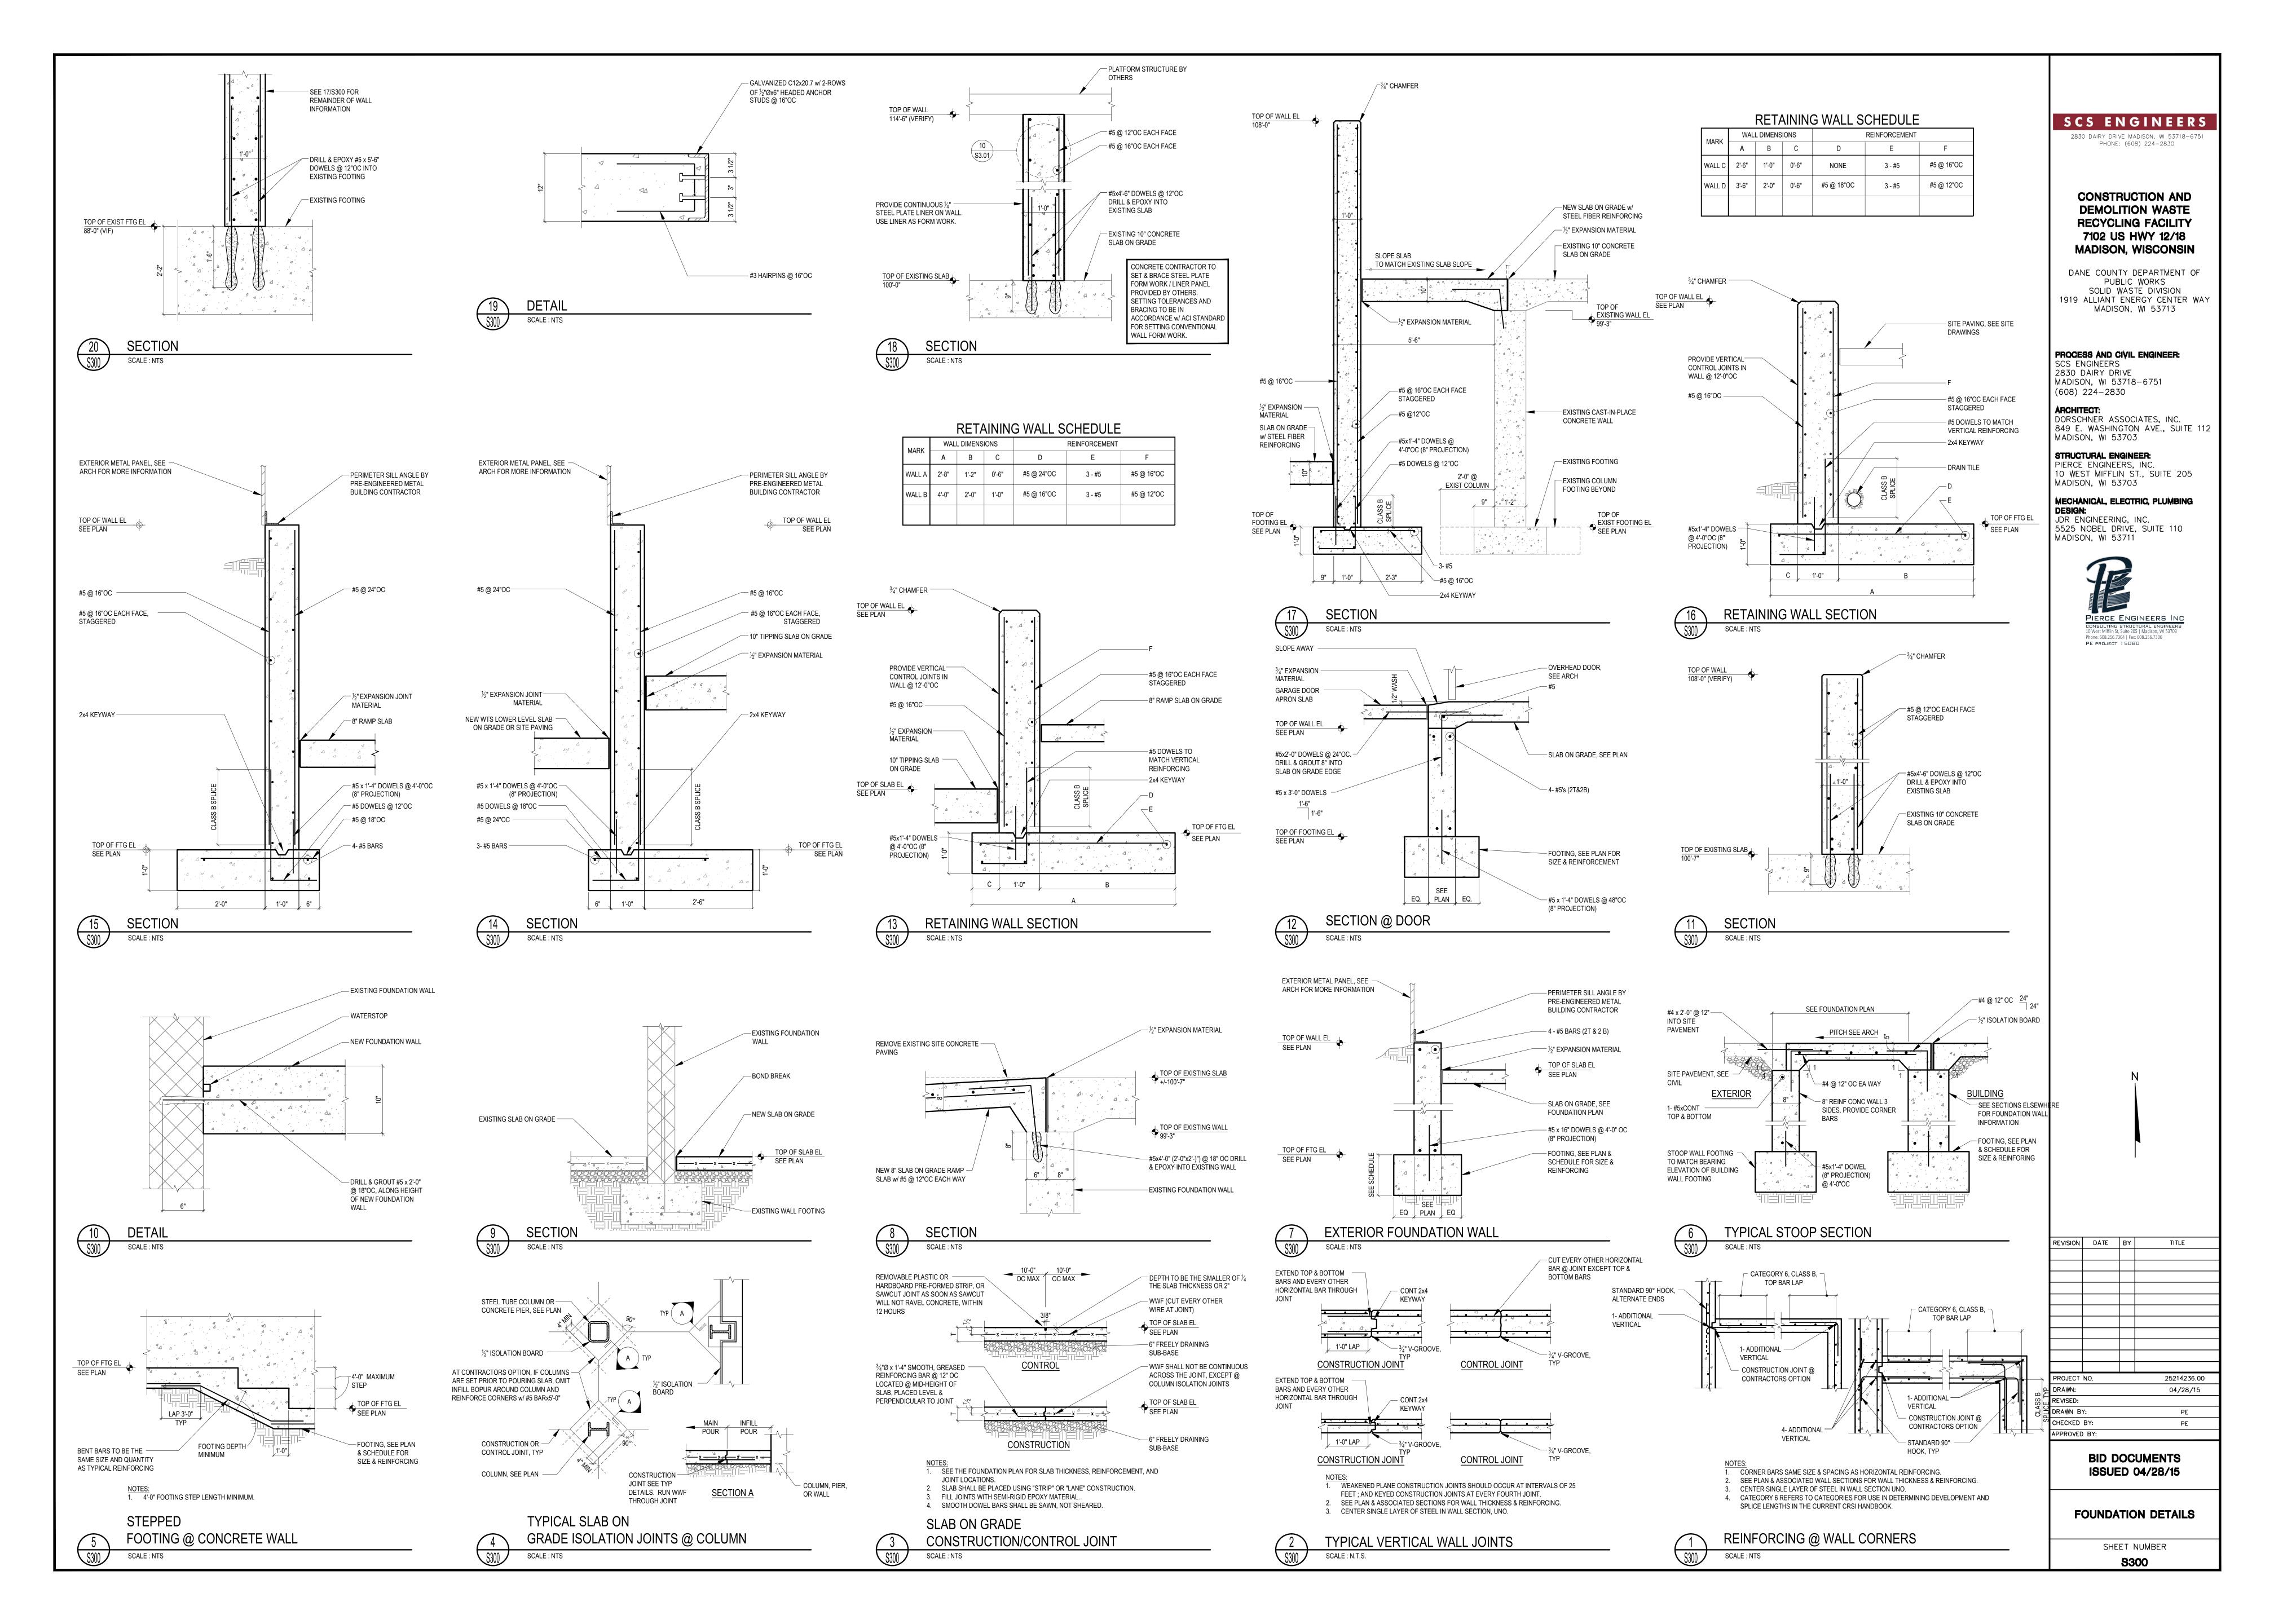
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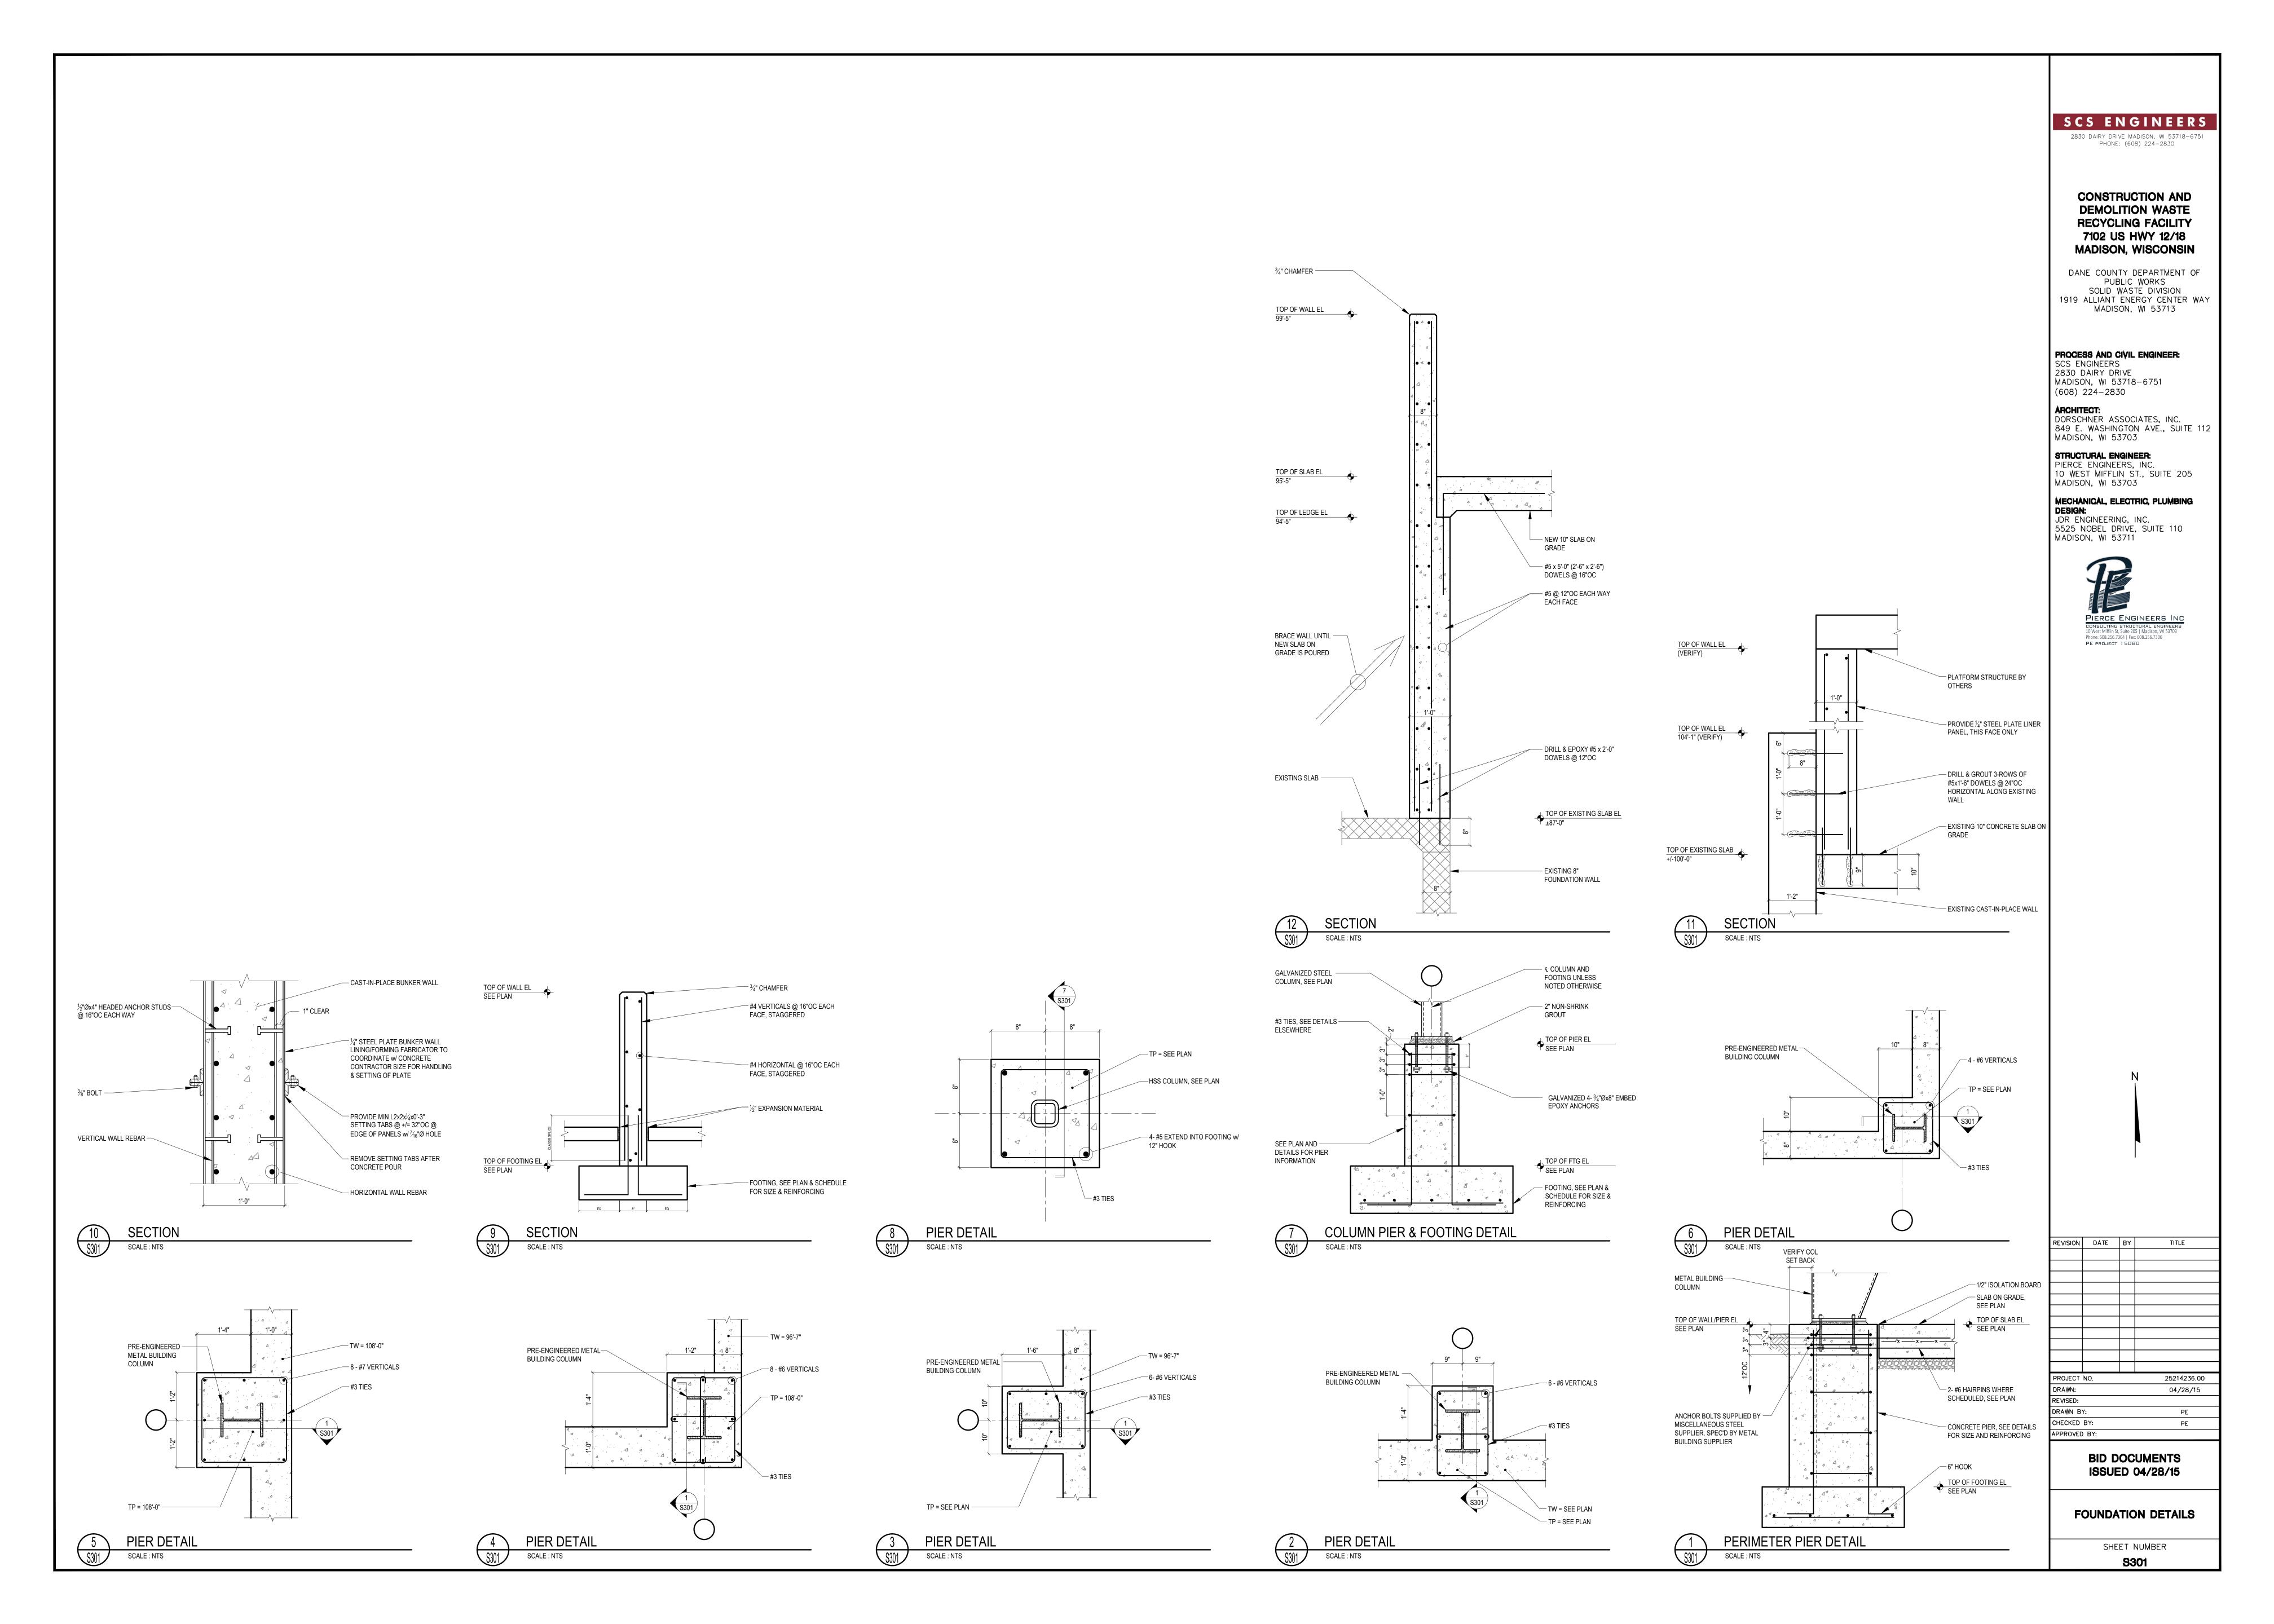
STRUCTURAL NOTES


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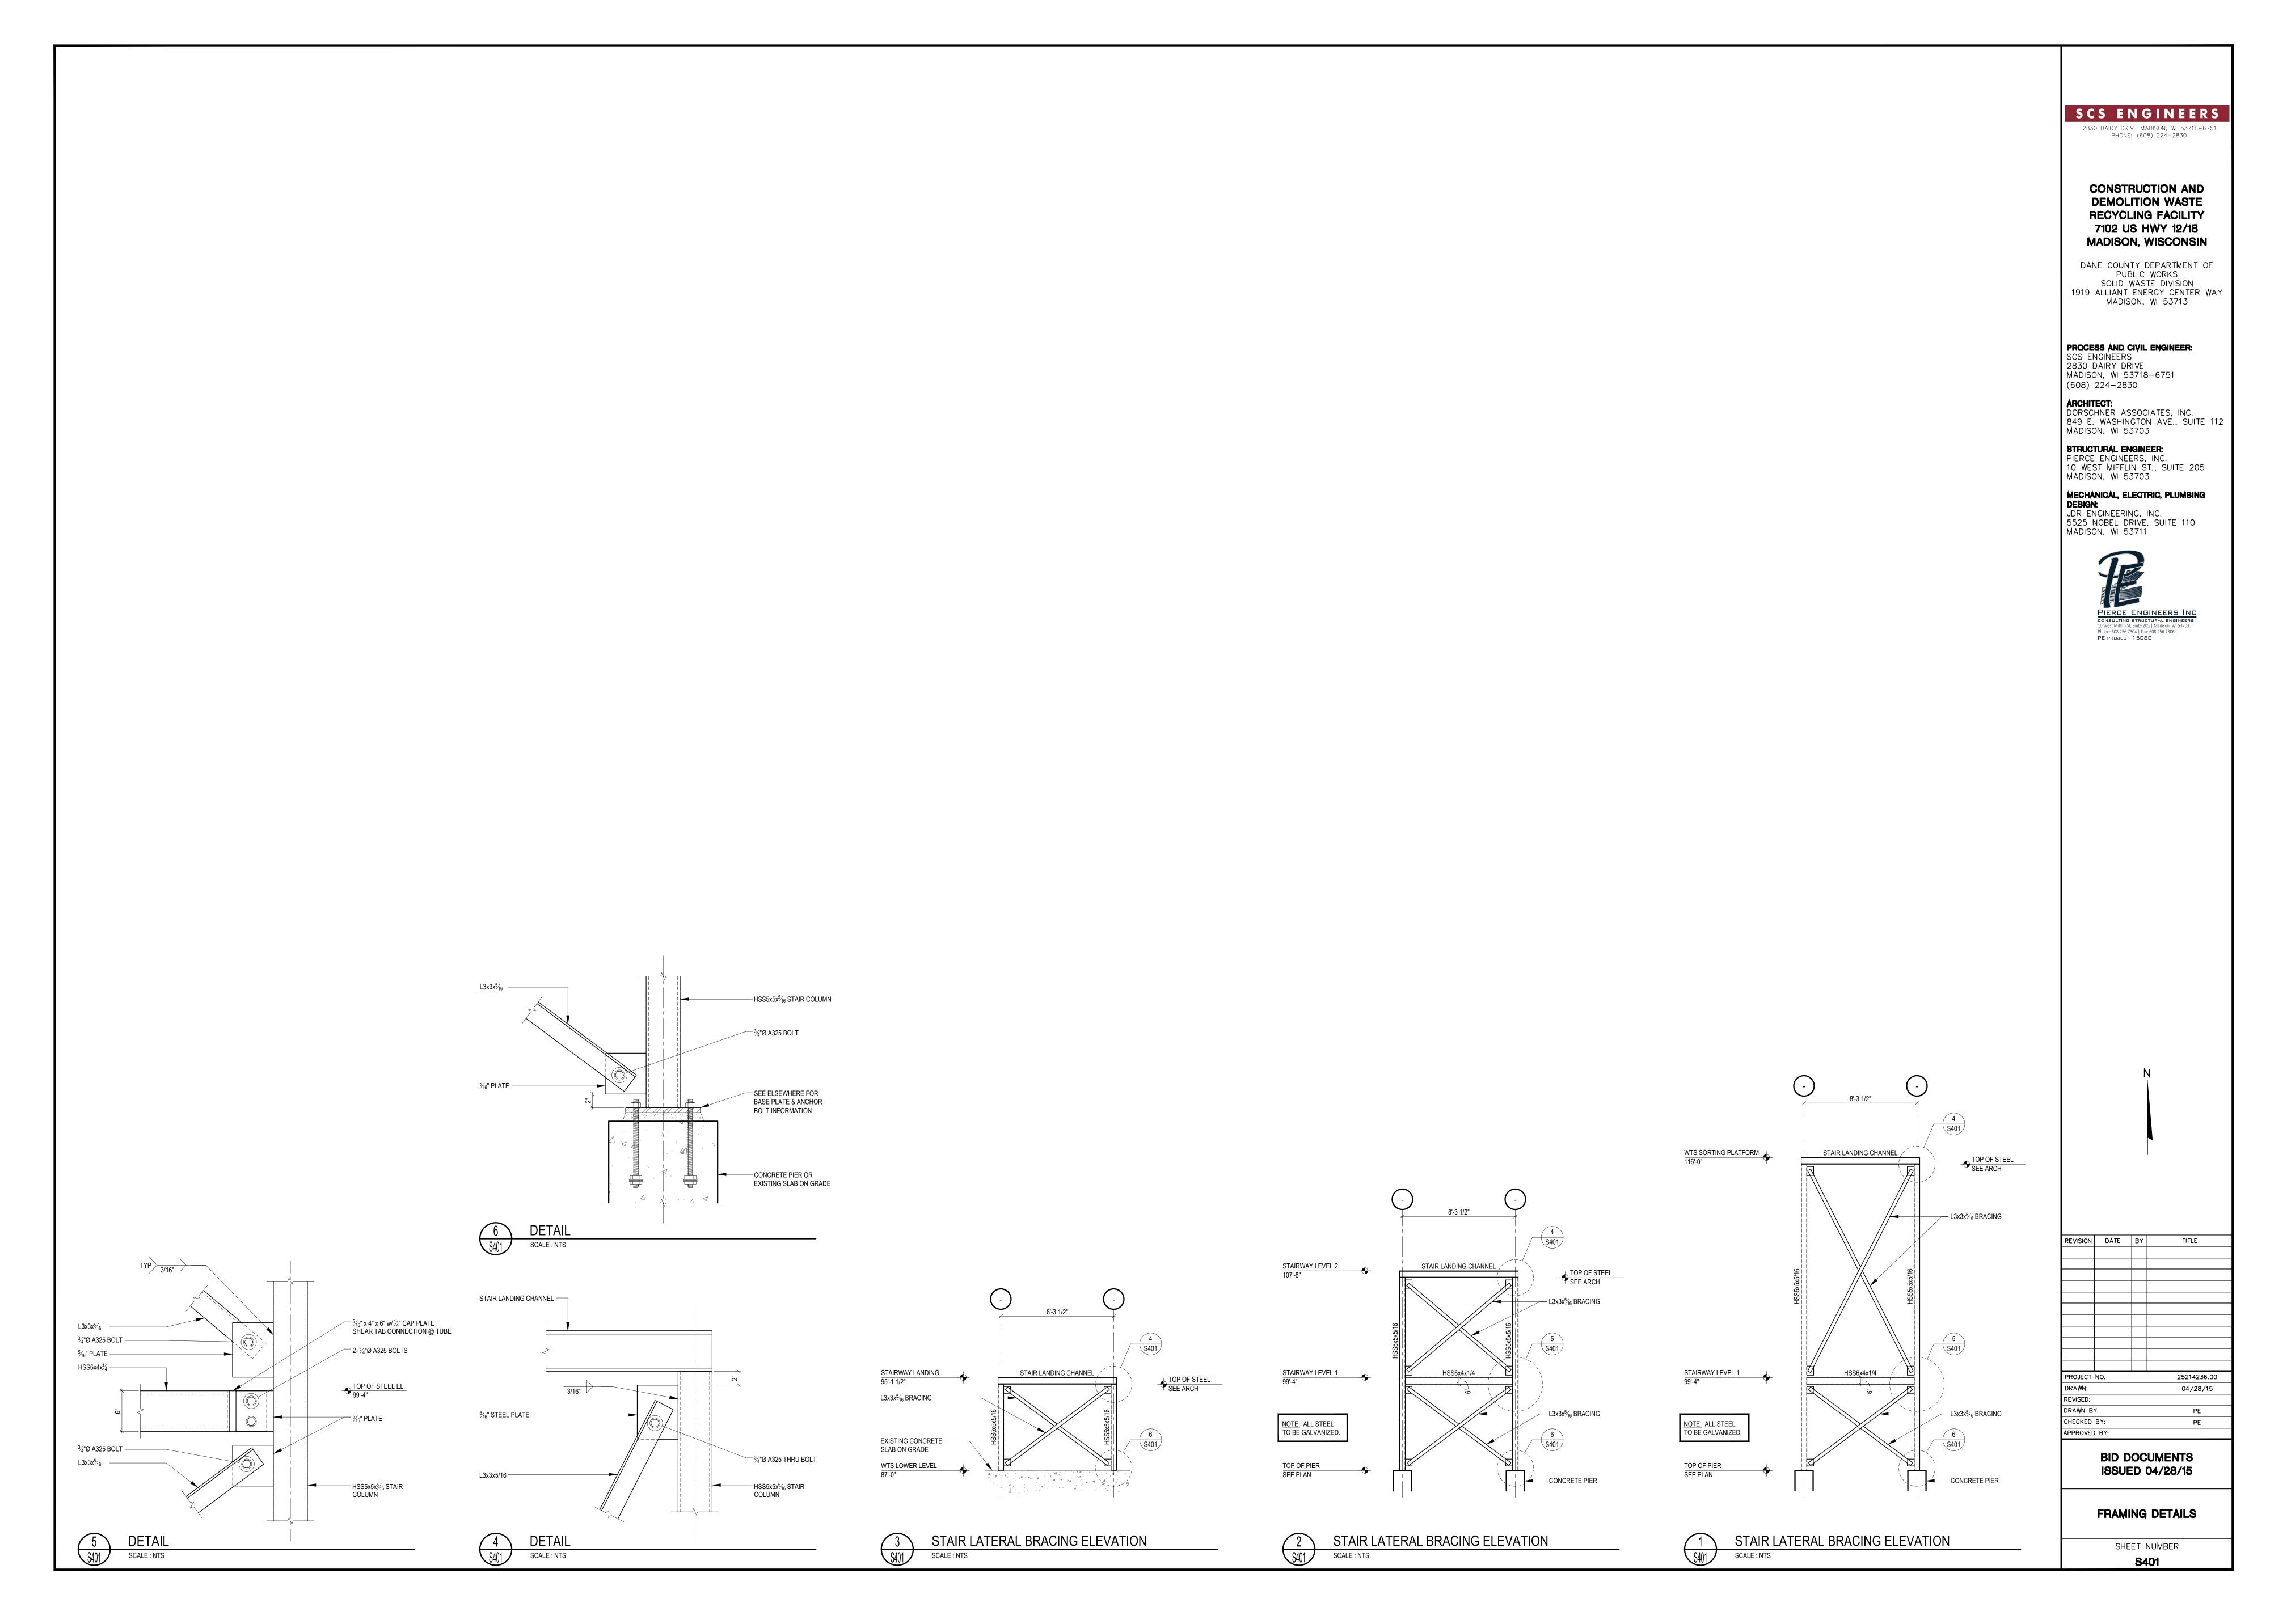









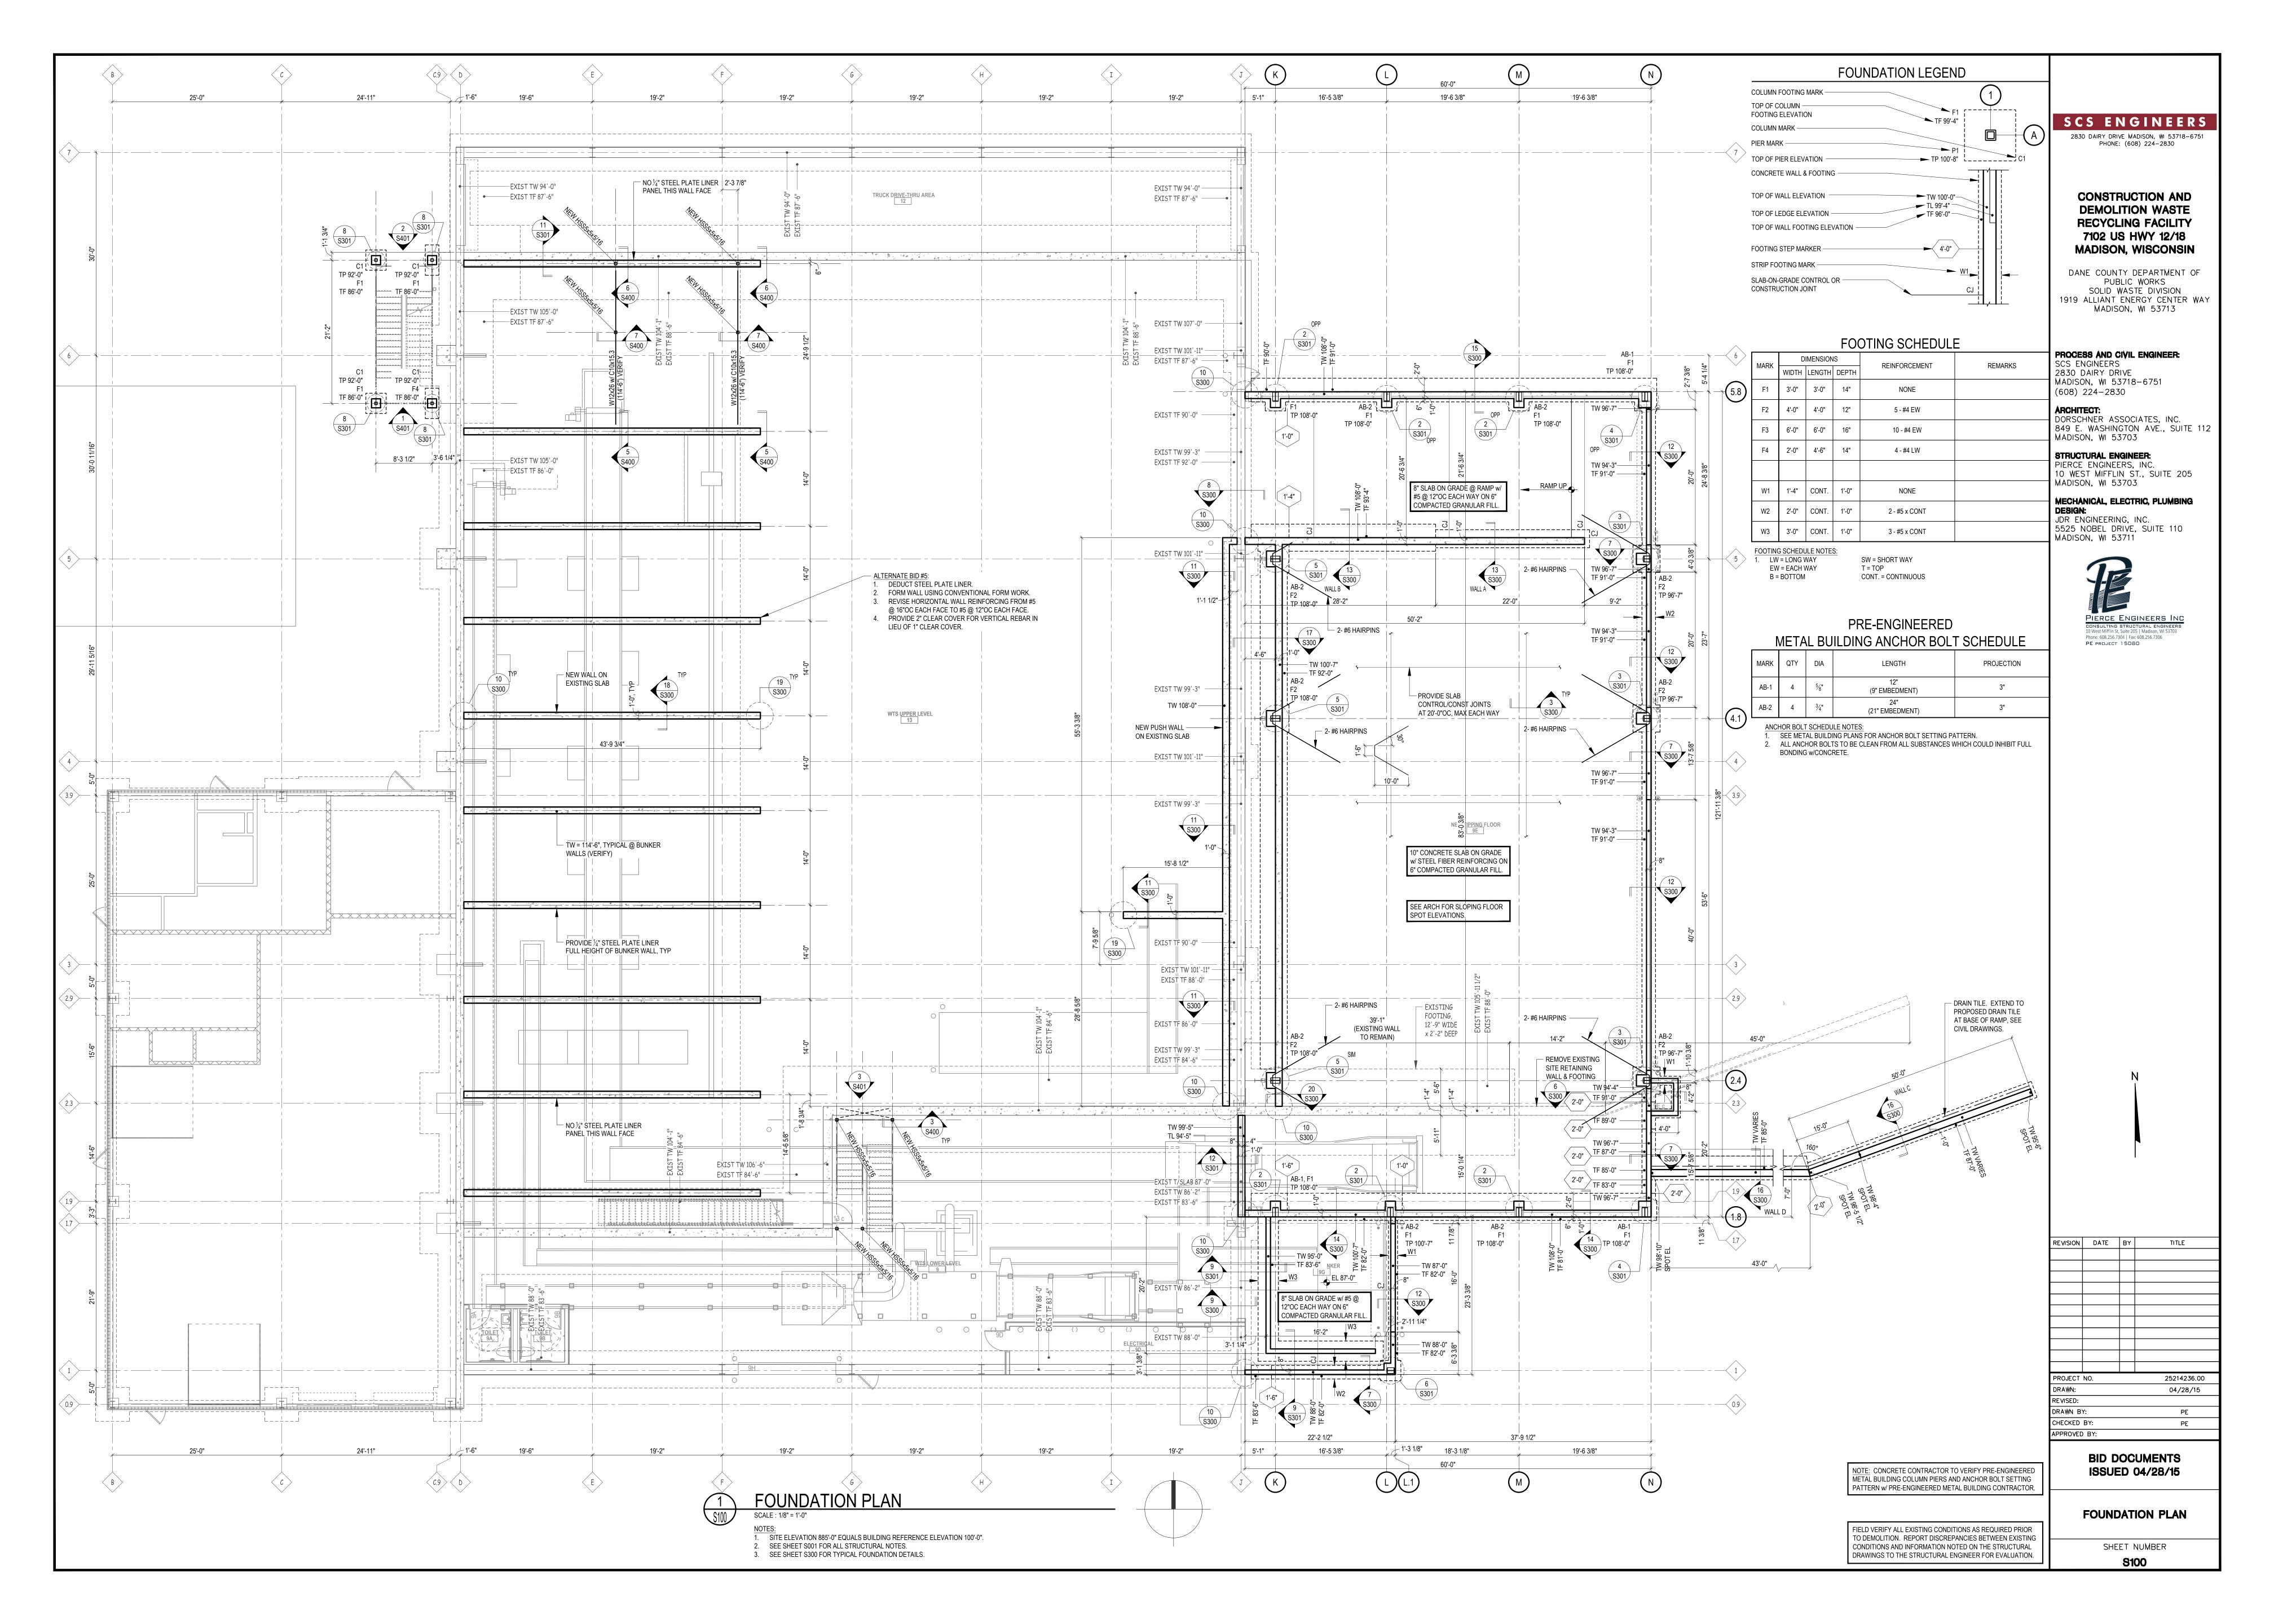

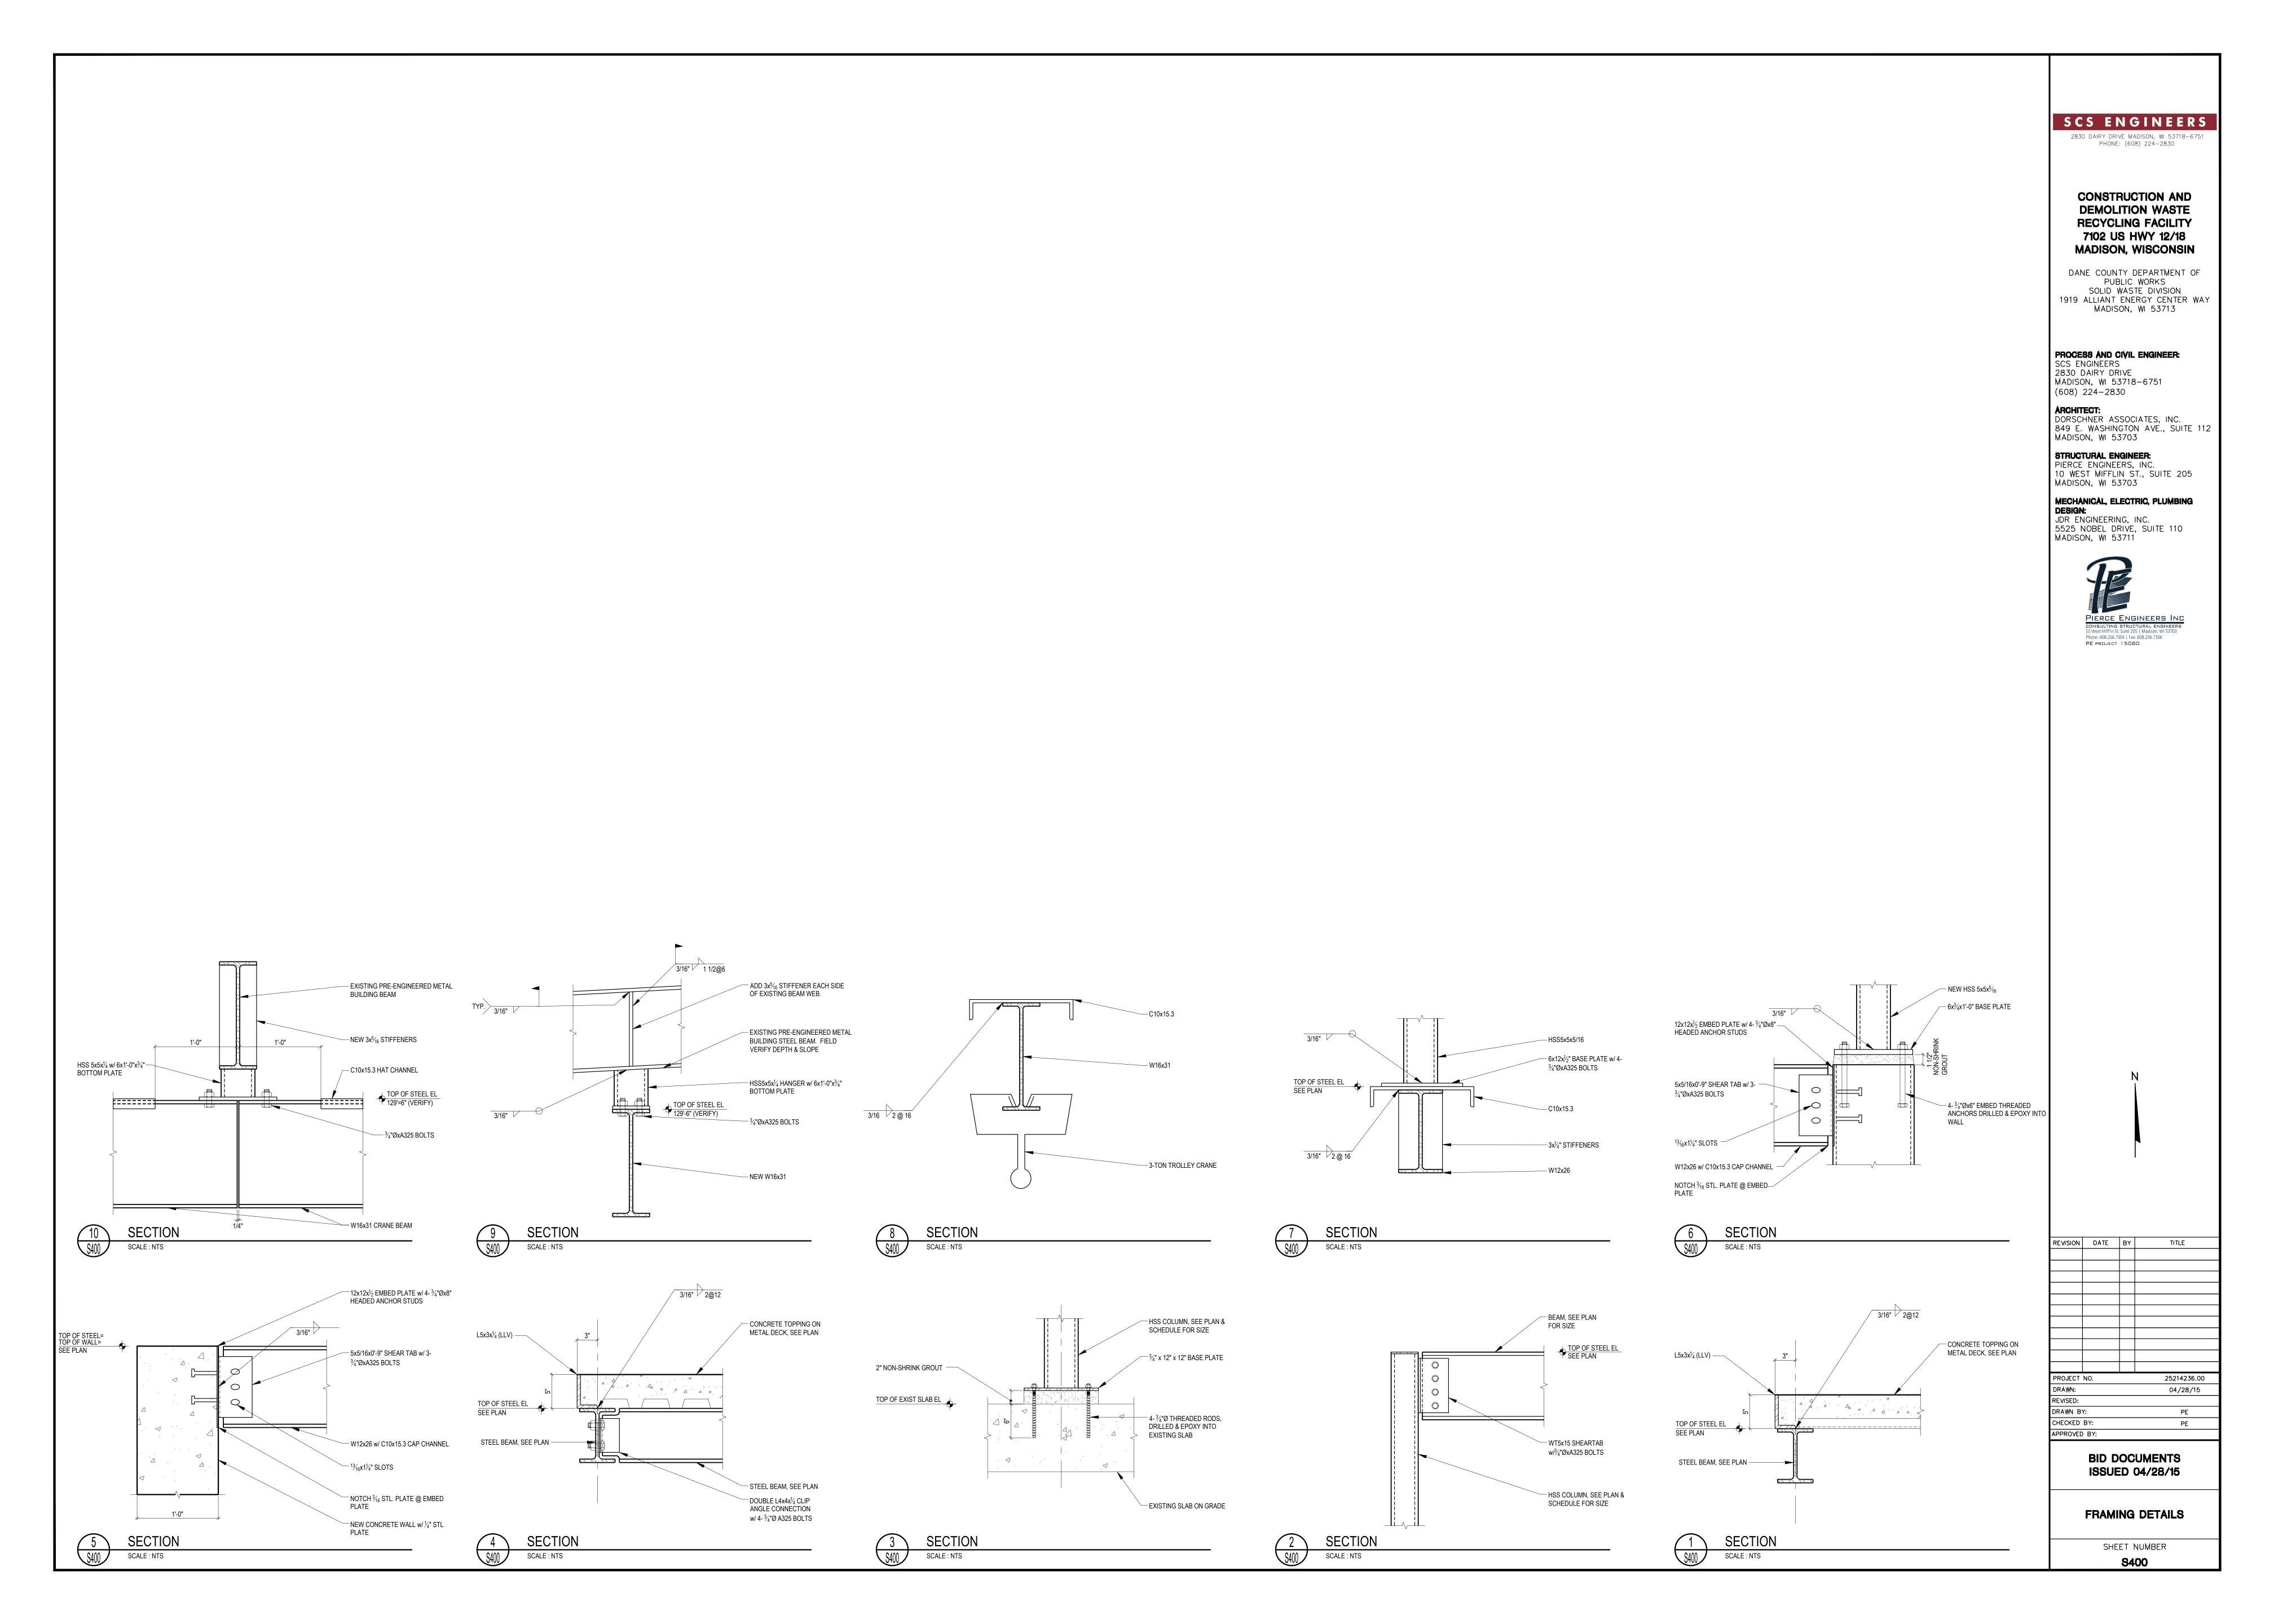

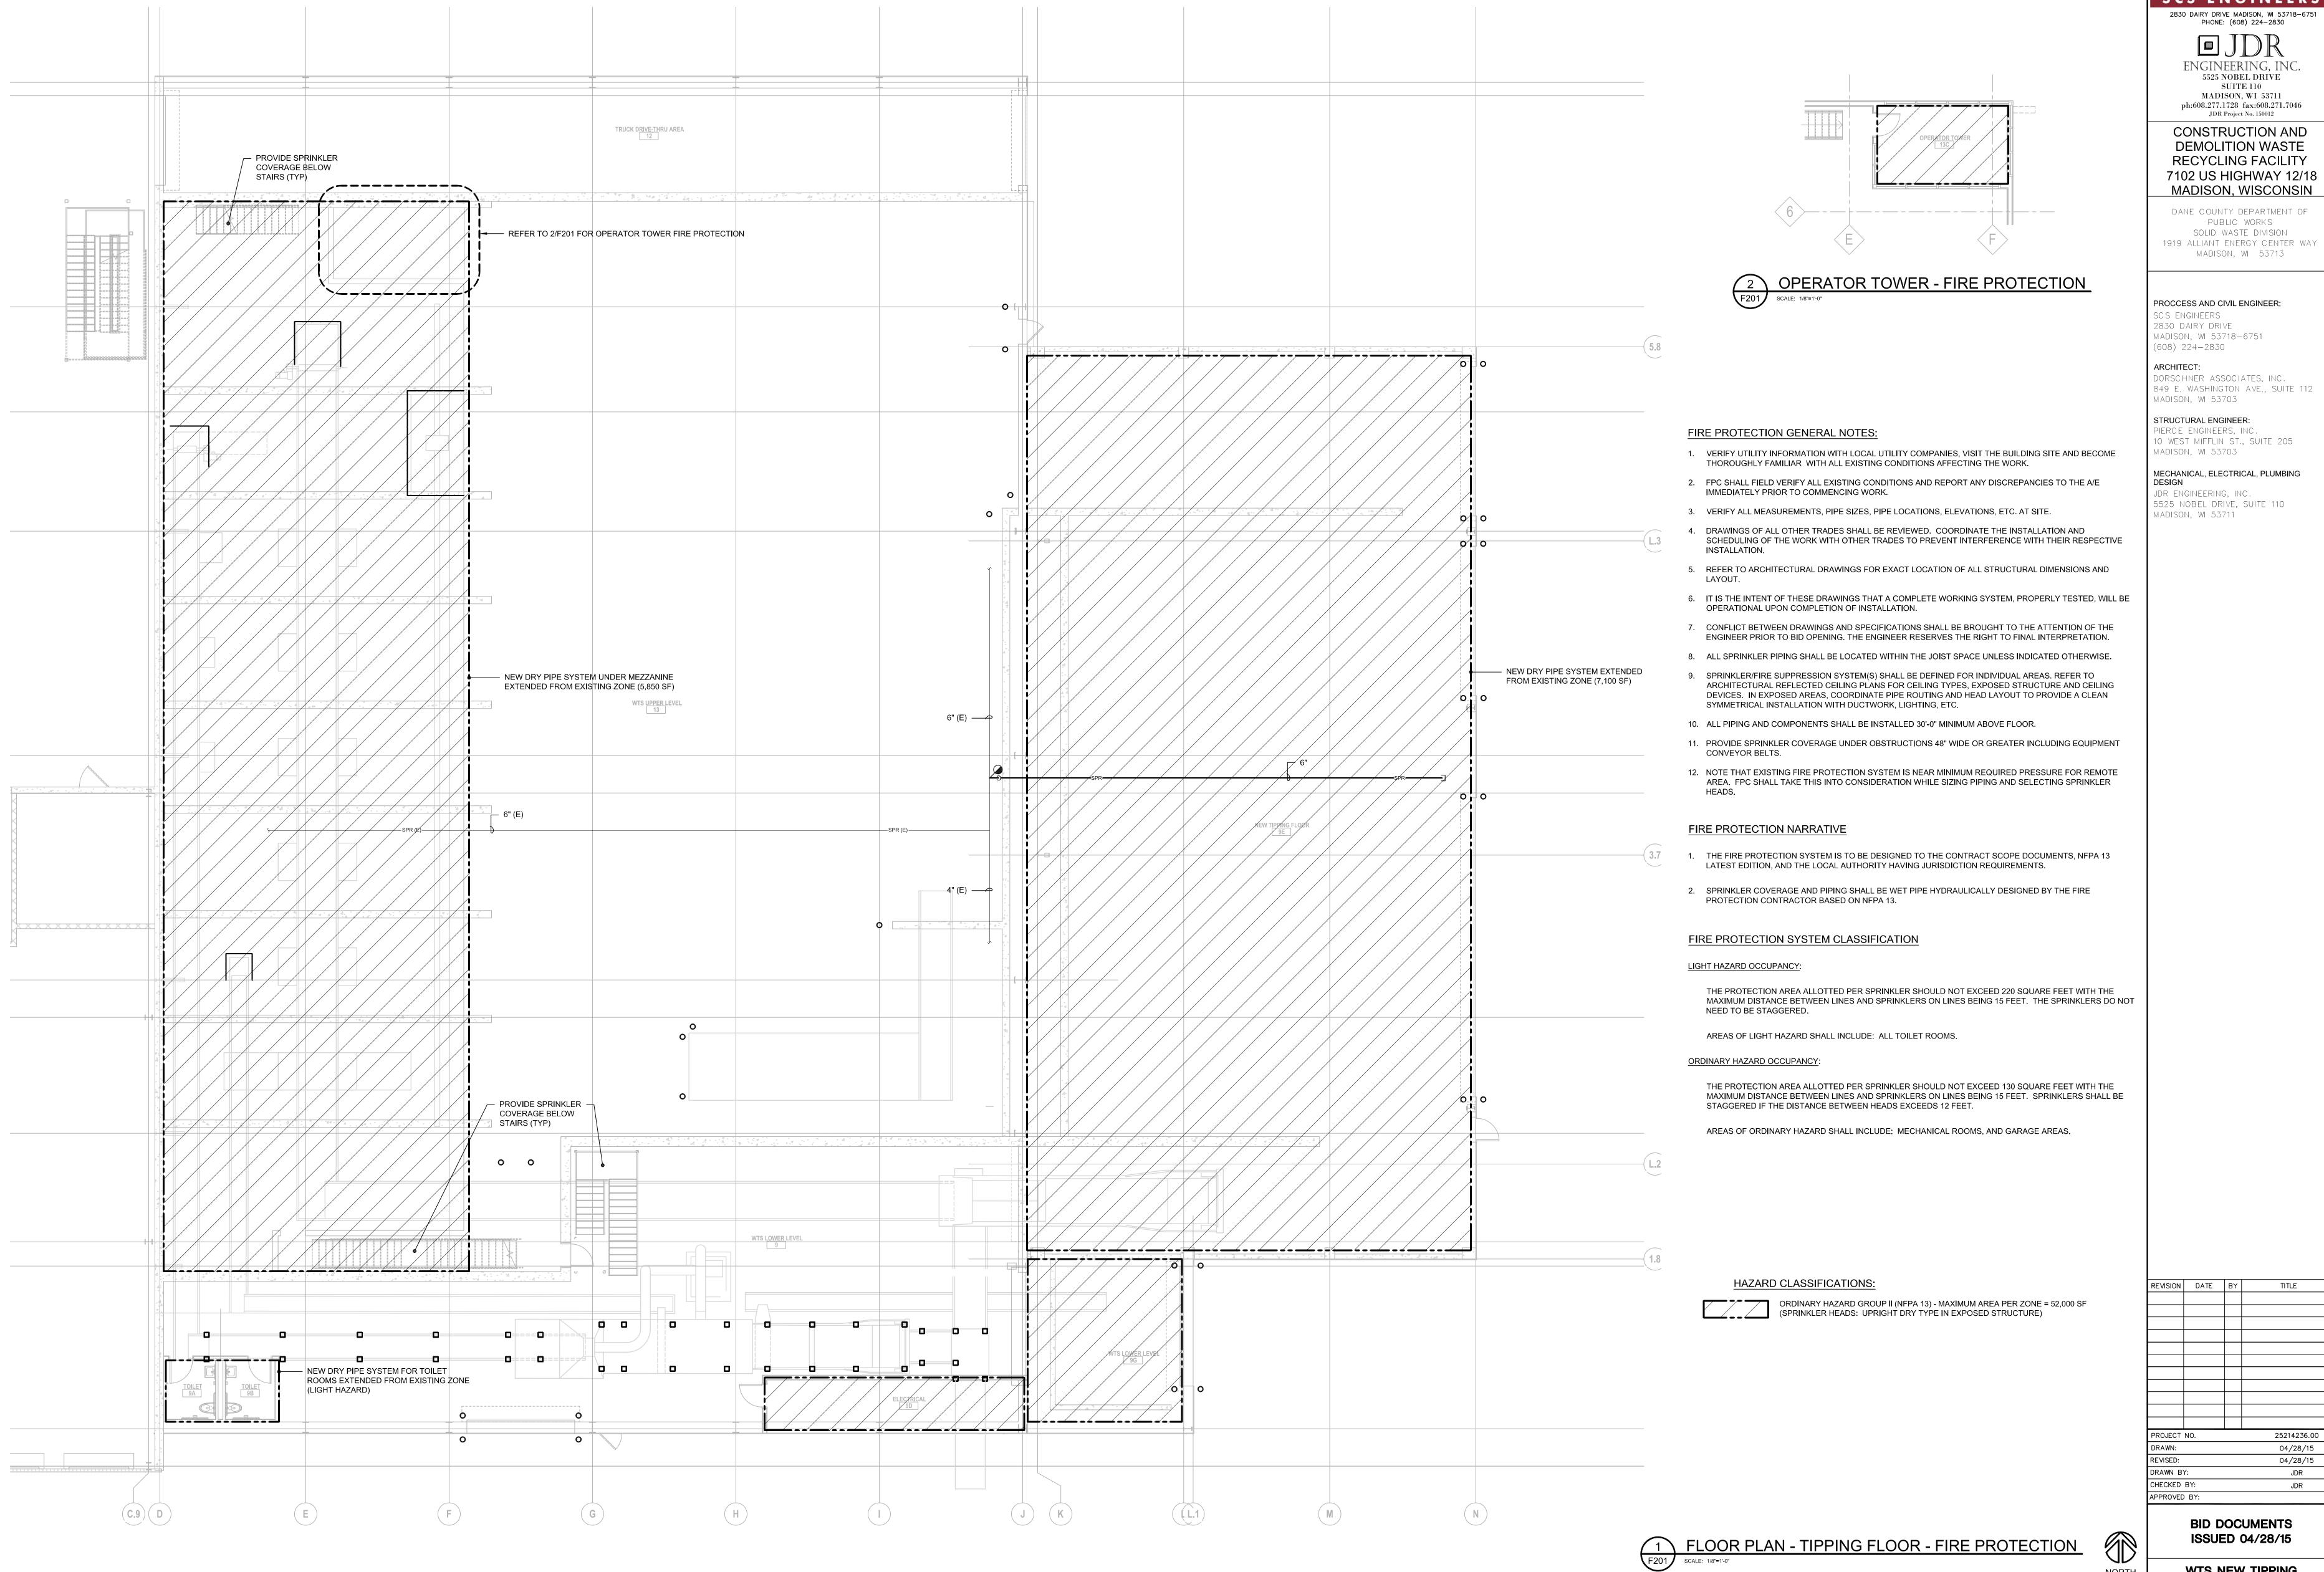

SCS ENGINEERS

5525 NOBEL DRIVE

CONSTRUCTION AND **DEMOLITION WASTE** RECYCLING FACILITY 7102 US HIGHWAY 12/18

DANE COUNTY DEPARTMENT OF PUBLIC WORKS SOLID WASTE DIVISION 1919 ALLIANT ENERGY CENTER WAY

849 E. WASHINGTON AVE., SUITE 112

O WEST MIFFLIN ST., SUITE 205


MECHANICAL, ELECTRICAL, PLUMBING

5525 NOBEL DRIVE, SUITE 110


25214236.00 04/28/15 04/28/15

WTS NEW TIPPING FLOOR PLAN - FIRE **PROTECTION**

	PLUMBING FIXTURE SCHEDULE									
	REFER TO SPECIFICATION SECTION 22 40 00 FOR ACCEPTABLE EQUAL MANUFACTURERS									
			WASTE			WATER				
ID	FIXTURE	DFU	TRAP	VENT	CC	OLD	H	ЮТ	DETAIL/ SHEET	DESCRIPTION/REMARKS
		DFU	IRAP	(MIN)	CWFU	SIZE	HWFU	SIZE		
										FIXTURE: KOHLER KINGSTON K-2005 WALL HUNG LAVATORY SINK, WHITE VITREOUS CHINA, THREE FAUCET HOLES ON 2" CENTERS, 21.25" x 18.125", WITH OVERFLOW, ADA COMPLIANT.
<u>L-1</u>	LAVATORY (ADA COMPLIANT)	1	1-1/4"	1-1/2"	0.5	1/2"	0.5	1/2"	2/P000	FAUCET: CHICAGO FAUCETS 2200-4-2300-4KCP MANUAL FAUCET, SINGLE LEVER, SOLID BRASS CONSTRUCTION, CHROME FINISH, CERAMIC CARTRIDGE, 1.5 GPM AERATOR, MOUNTED ON 4" CENTERS, ADA COMPLIANT.
										TRAP & DRAIN: PRE-WRAPPED OFFSET DRAIN & P-TRAP, WITH GRID STRAINER DRAIN.
										STOPS & SUPPLIES: McGUIRE H2167LK, LOOSE KEY QUARTER TURN ANGLE STOPS WITH CHROME PLATED ESCUTCHEONS & CHROME PLATED COPPER RISER SUPPLIES.
										FIXTURE: KOHLER KINGSTON K-4325, WALL HUNG, FLUSH VALVE TOILET, WHITE VITREOUS CHINA, ELONGATED BOWL, 1.6 GPF MAX, 2.25" TRAPWAY, 1-1/2" TOP SPUD.
MC 4	WATER OLOGET	WATER CLOSET 6 4" 2" 6.5 1-1/2"			FLUSH VALVE: SLOAN ROYAL 111-1.28 MANUAL FLUSH VALVE, EXPOSED VALVE, CHROME FINISH, 1.28 GPF, FOR 1-1/2" TOP SPUD, 1" SCREWDRIVER ANGLE STOP, RUBBER DIAPHRAGM, ADA COMPLIANT.					
<u>WC-1</u>	WATER CLOSET		6 4" 2"	2"	6.5	1 - 1/2"				SEAT: KOHLER LUSTRA K-4670-CA, OPEN FRONT TOILET SEAT, ELONGATED BOWL, INJECTION MOLDED, WITH ANTI-MICROBIAL AGENT.
										SUPPORT: COMMERCIAL GRADE, WALL HUNG WATER CLOSET SUPPORT, STEEL STANCHIONS, IRON WELDED FEET, STEEL SLEEVES, FASTEN TO FLOOR.

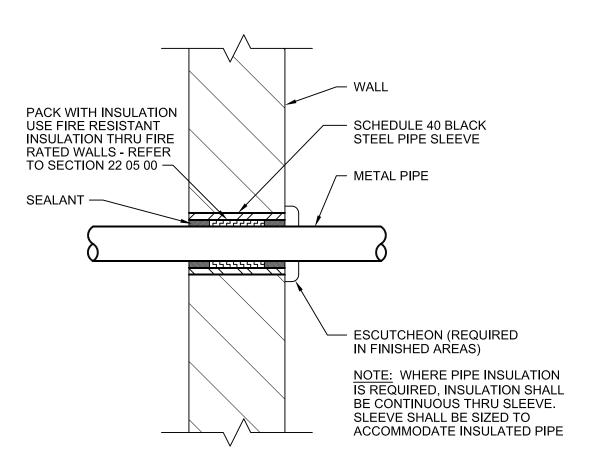



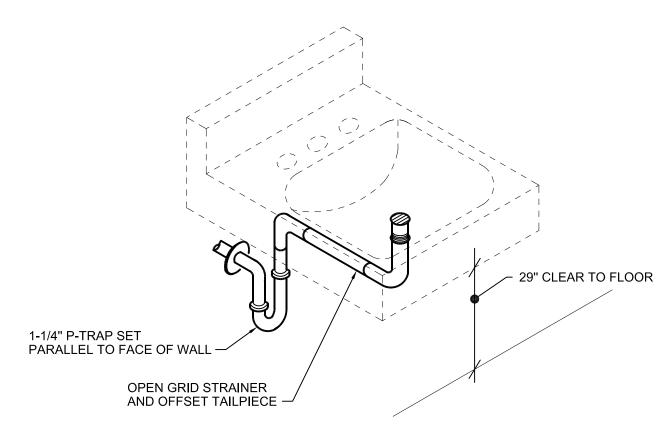

NOTE: PROVIDE SAME WASTE PIPE TRAP CONFIGURATION FOR SELF-RIMMING COUNTERTOP LAVATORIES WITH OPEN SPACE BELOW COUNTER.

2 BARRIER FREE LAVATORY DETAIL
P000 SCALE: NONE

	EXISTING PIPING TO BE REMOVED/DEMOLISHED
CW (E) ———	EXISTING PIPING (SERVICE DESIGNATED)
	SANITARY DRAIN, WASTE OR SEWER (SAN)
ST-	STORM DRAIN CONDUCTOR OR SEWER
SD	SUBSOIL DRAIN (FOOTING DRAIN) VENT (V)
CW-	COLD WATER
HW	HOT WATER
HWR———	HOT WATER RECIRCULATION
NPC-	NON-POTABLE COLD WATER
	COMPRESSED AIR DOMESTIC WATER SERVICE
	TEE (BRANCH TO SIDE)
	TEE (BRANCH DOWN)
	RISER UP RISER DOWN
OR	CLEANOUT (CO) WALL CLEANOUT (WCO)
	FLOOR CLEANOUT (FCO) YARD CLEANOUT (YCO)
2	
	DOWNSPOUT NOZZLE (DSN) UNION
	FLANGE
	FLOW
<u> </u>	CHECK VALVE
 	HOSE BIBB (HB) OR WALL HYDRANT (WH)
EXISTING NEW	POINT OF CONNECTION (POC)
	CAP
——Ф——	BALANCING VALVE
	SHUT-OFF VALVE PIPE STRAINER
— ×	FIXTURE STOP
^ ○ ≯	VALVE IN RISER
Щ ®	THERMOMETER
Ϋ́	PRESSURE GAUGE
부 &_	WATER HAMMER ARRESTOR
→ →	RELIEF VALVE
	RPBP - REDUCED PRESSURE ZONE BACKFLOW PREVENTER
	FLOOR DRAIN (FD)
© +	HUB DRAIN (HD)
•	FINISHED FLOOR ELEVATION
(XX)	FIXTURE UNITS - DRAINAGE OR SUPPLY (DFU OF WSFU
(#)	DEMOLITION KEYED NOTE
<u>\(# \)</u>	NEW WORK KEYED NOTE
<u>/#\</u>	REVISION KEYED NOTE
(X PX)	TAG FOR CONTINUATION MATCH POINTS
ABBR	EVIATIONS
A AFF	COMPRESSED AIR ABOVE FINISHED FLOOR
CB CO	CATCH BASIN CLEANOUT
CW DSN	COLD WATER DOWNSPOUT NOZZLE
E	EXISTING
EC ESEW	ELECTRICAL CONTRACTOR EMERGENCY SHOWER/EYEWASH
FCO FPC	FLOOR CLEANOUT FIRE PROTECTION CONTRACTOR
GC	GENERAL CONTRACTOR

PLUMBING SHEET INDEX

- SYMBOLS, ABBREVIATIONS, DETAILS, AND SCHEDULES PLUMBING WTS TIPPING FLOOR PLAN DEMOLITION - PLUMBING
- UNDERFLOOR PLAN PLUMBING
- P201 CLEAN SWEEP BUILDING - MAIN LEVEL - PLUMBING WTS NEW TIPPING FLOOR PLAN - PLUMBING

HOSE BIBB

HOT WATER

LAVATORY

MOP BASIN MANHOLE

SANITARY

URINAL

VENT

WHR WATER HEATER

YCO YARD CLEANOUT

SUBSOIL DRAIN SHOWER STORM

TEMPERED WATER

VENT THRU ROOF

WATER CLOSET

WALL CLEAN OUT

WALL HYDRANT WHA WATER HAMMER ARRESTOR

THERMOSTATIC MIXING VALVE

DOMESTIC WATER SERVICE

HWR

SAN SD

WCO

WH

HVAC CONTRACTOR

INVERT ELEVATION

HOT WATER RECIRCULATION

NON-POTABLE COLD WATER

PRESSURE REGULATING VALVE

REDUCED PRESSURE ZONE BACKFLOW PREVENTER

PLUMBING CONTRACTOR

25214236.00 04/28/15 04/28/15 DRAWN BY: CHECKED BY: APPROVED BY:

REVISION DATE BY

TITLE

SCS ENGINEERS

2830 DAIRY DRIVE MADISON, WI 53718-6751 PHONE: (608) 224-2830

ENGINEERING, INC. 5525 NOBEL DRIVE SUITE 110 MADISON, WI 53711 ph:608.277.1728 fax:608.271.7046 JDR Project No. 150012

CONSTRUCTION AND DEMOLITION WASTE RECYCLING FACILITY 7102 US HIGHWAY 12/18 MADISON, WISCONSIN

DANE COUNTY DEPARTMENT OF PUBLIC WORKS SOLID WASTE DIVISION 1919 ALLIANT ENERGY CENTER WAY MADISON, WI 53713

PROCCESS AND CIVIL ENGINEER:

DORSCHNER ASSOCIATES, INC.

10 WEST MIFFLIN ST., SUITE 205

MECHANICAL, ELECTRICAL, PLUMBING

5525 NOBEL DRIVE, SUITE 110

849 E. WASHINGTON AVE., SUITE 112

MADISON, WI 53718-6751

SCS ENGINEERS 2830 DAIRY DRIVE

(608) 224-2830

MADISON, WI 53703

STRUCTURAL ENGINEER: PIERCE ENGINEERS, INC.

MADISON, WI 53703

JDR ENGINEERING, INC.

MADISON, WI 53711


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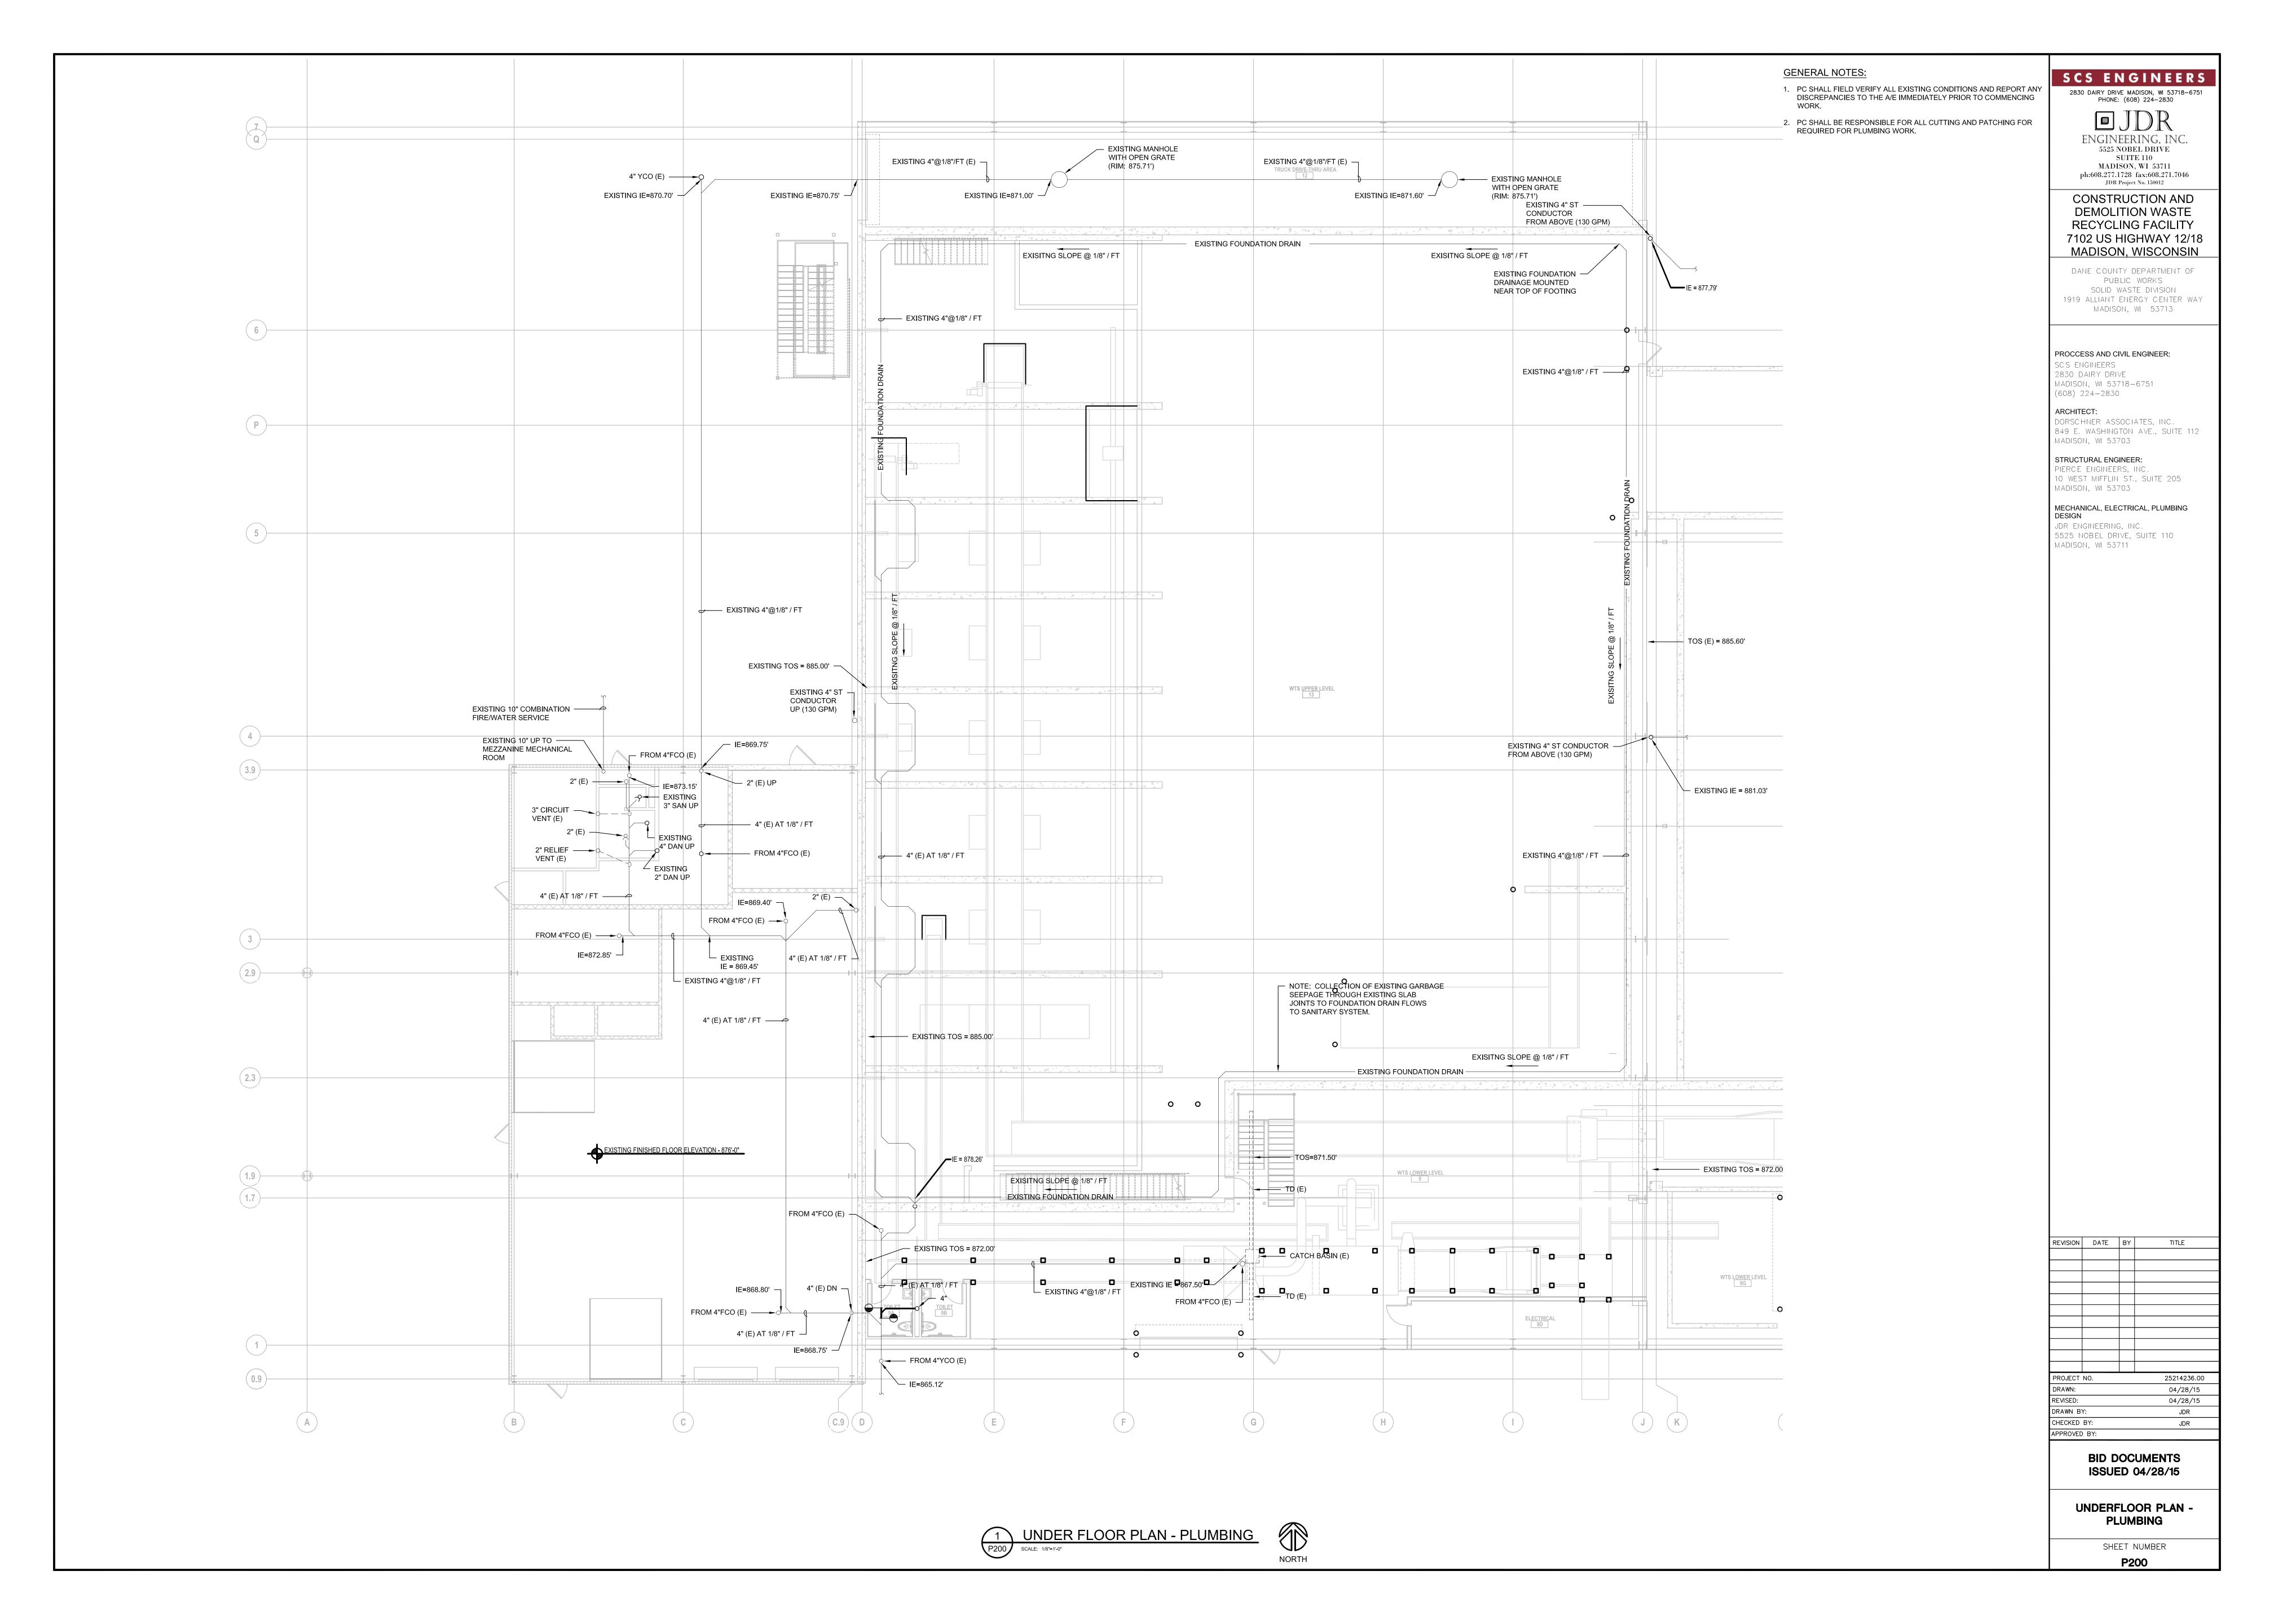
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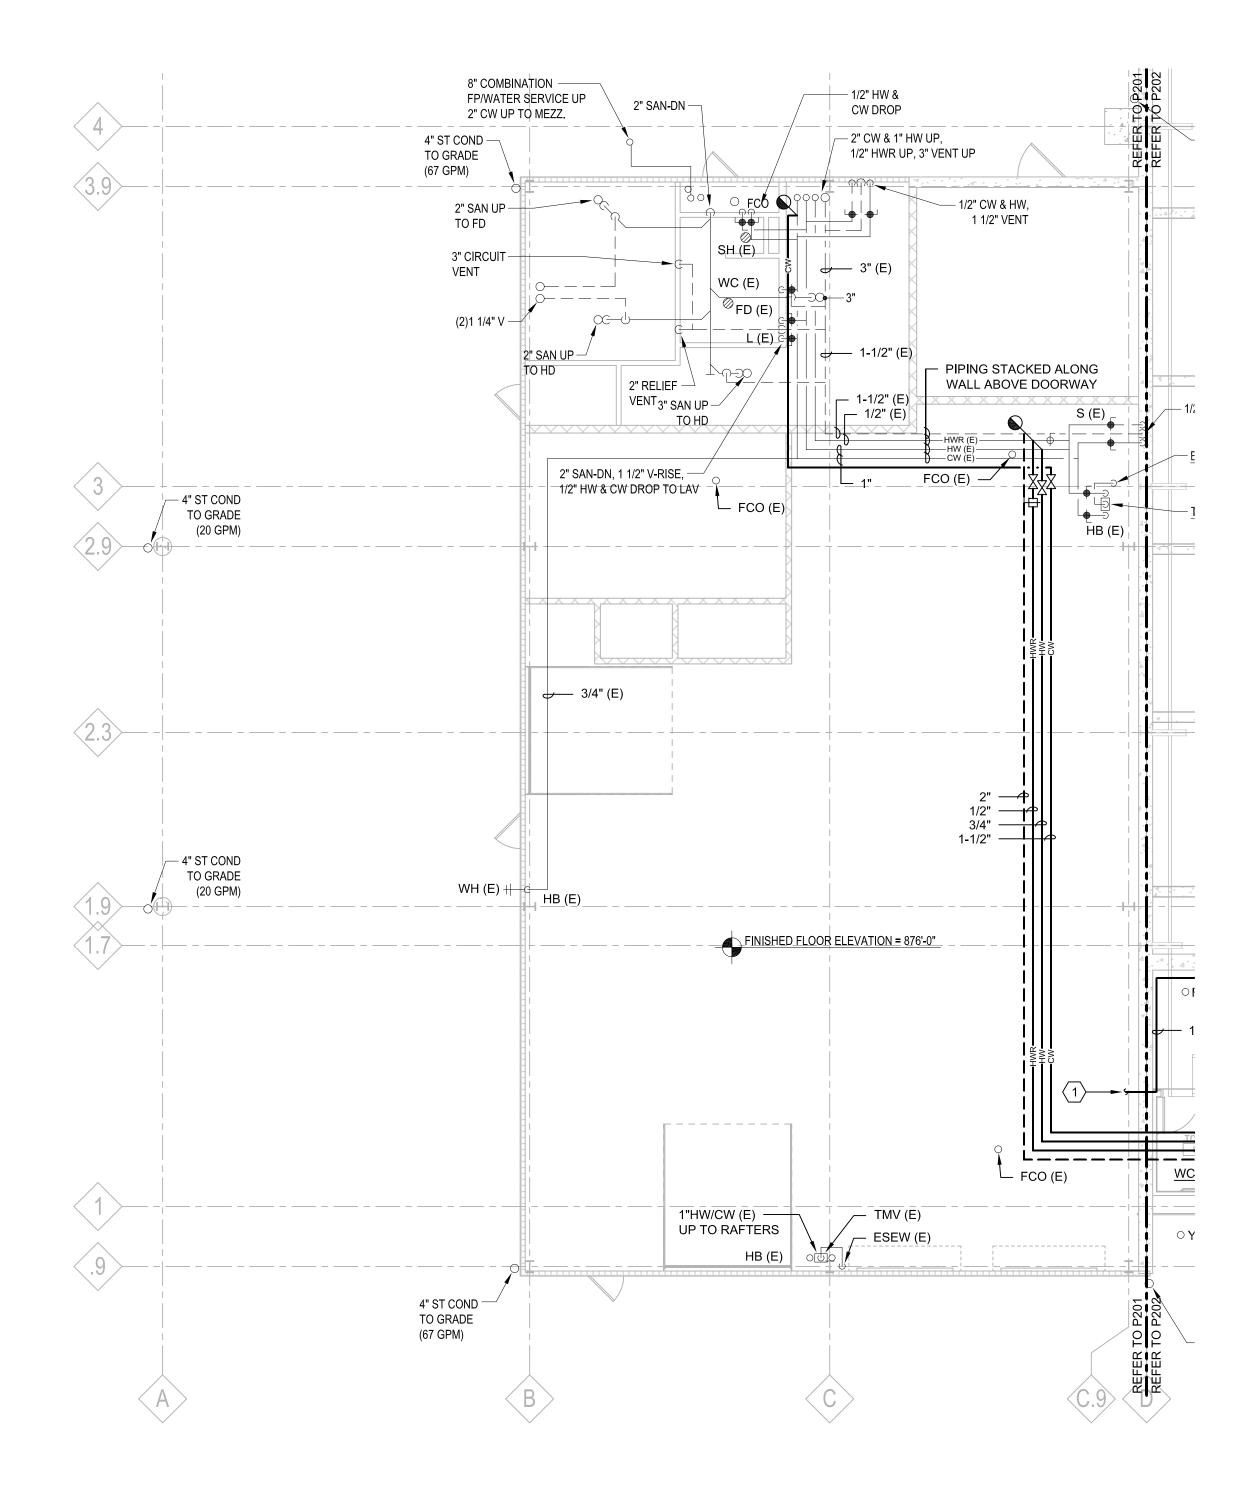
BID DOCUMENTS ISSUED 04/28/15

SYMBOLS, ABBREVIATIONS, DETAILS, AND SCHEDULES -PLUMBING SHEET NUMBER

P000





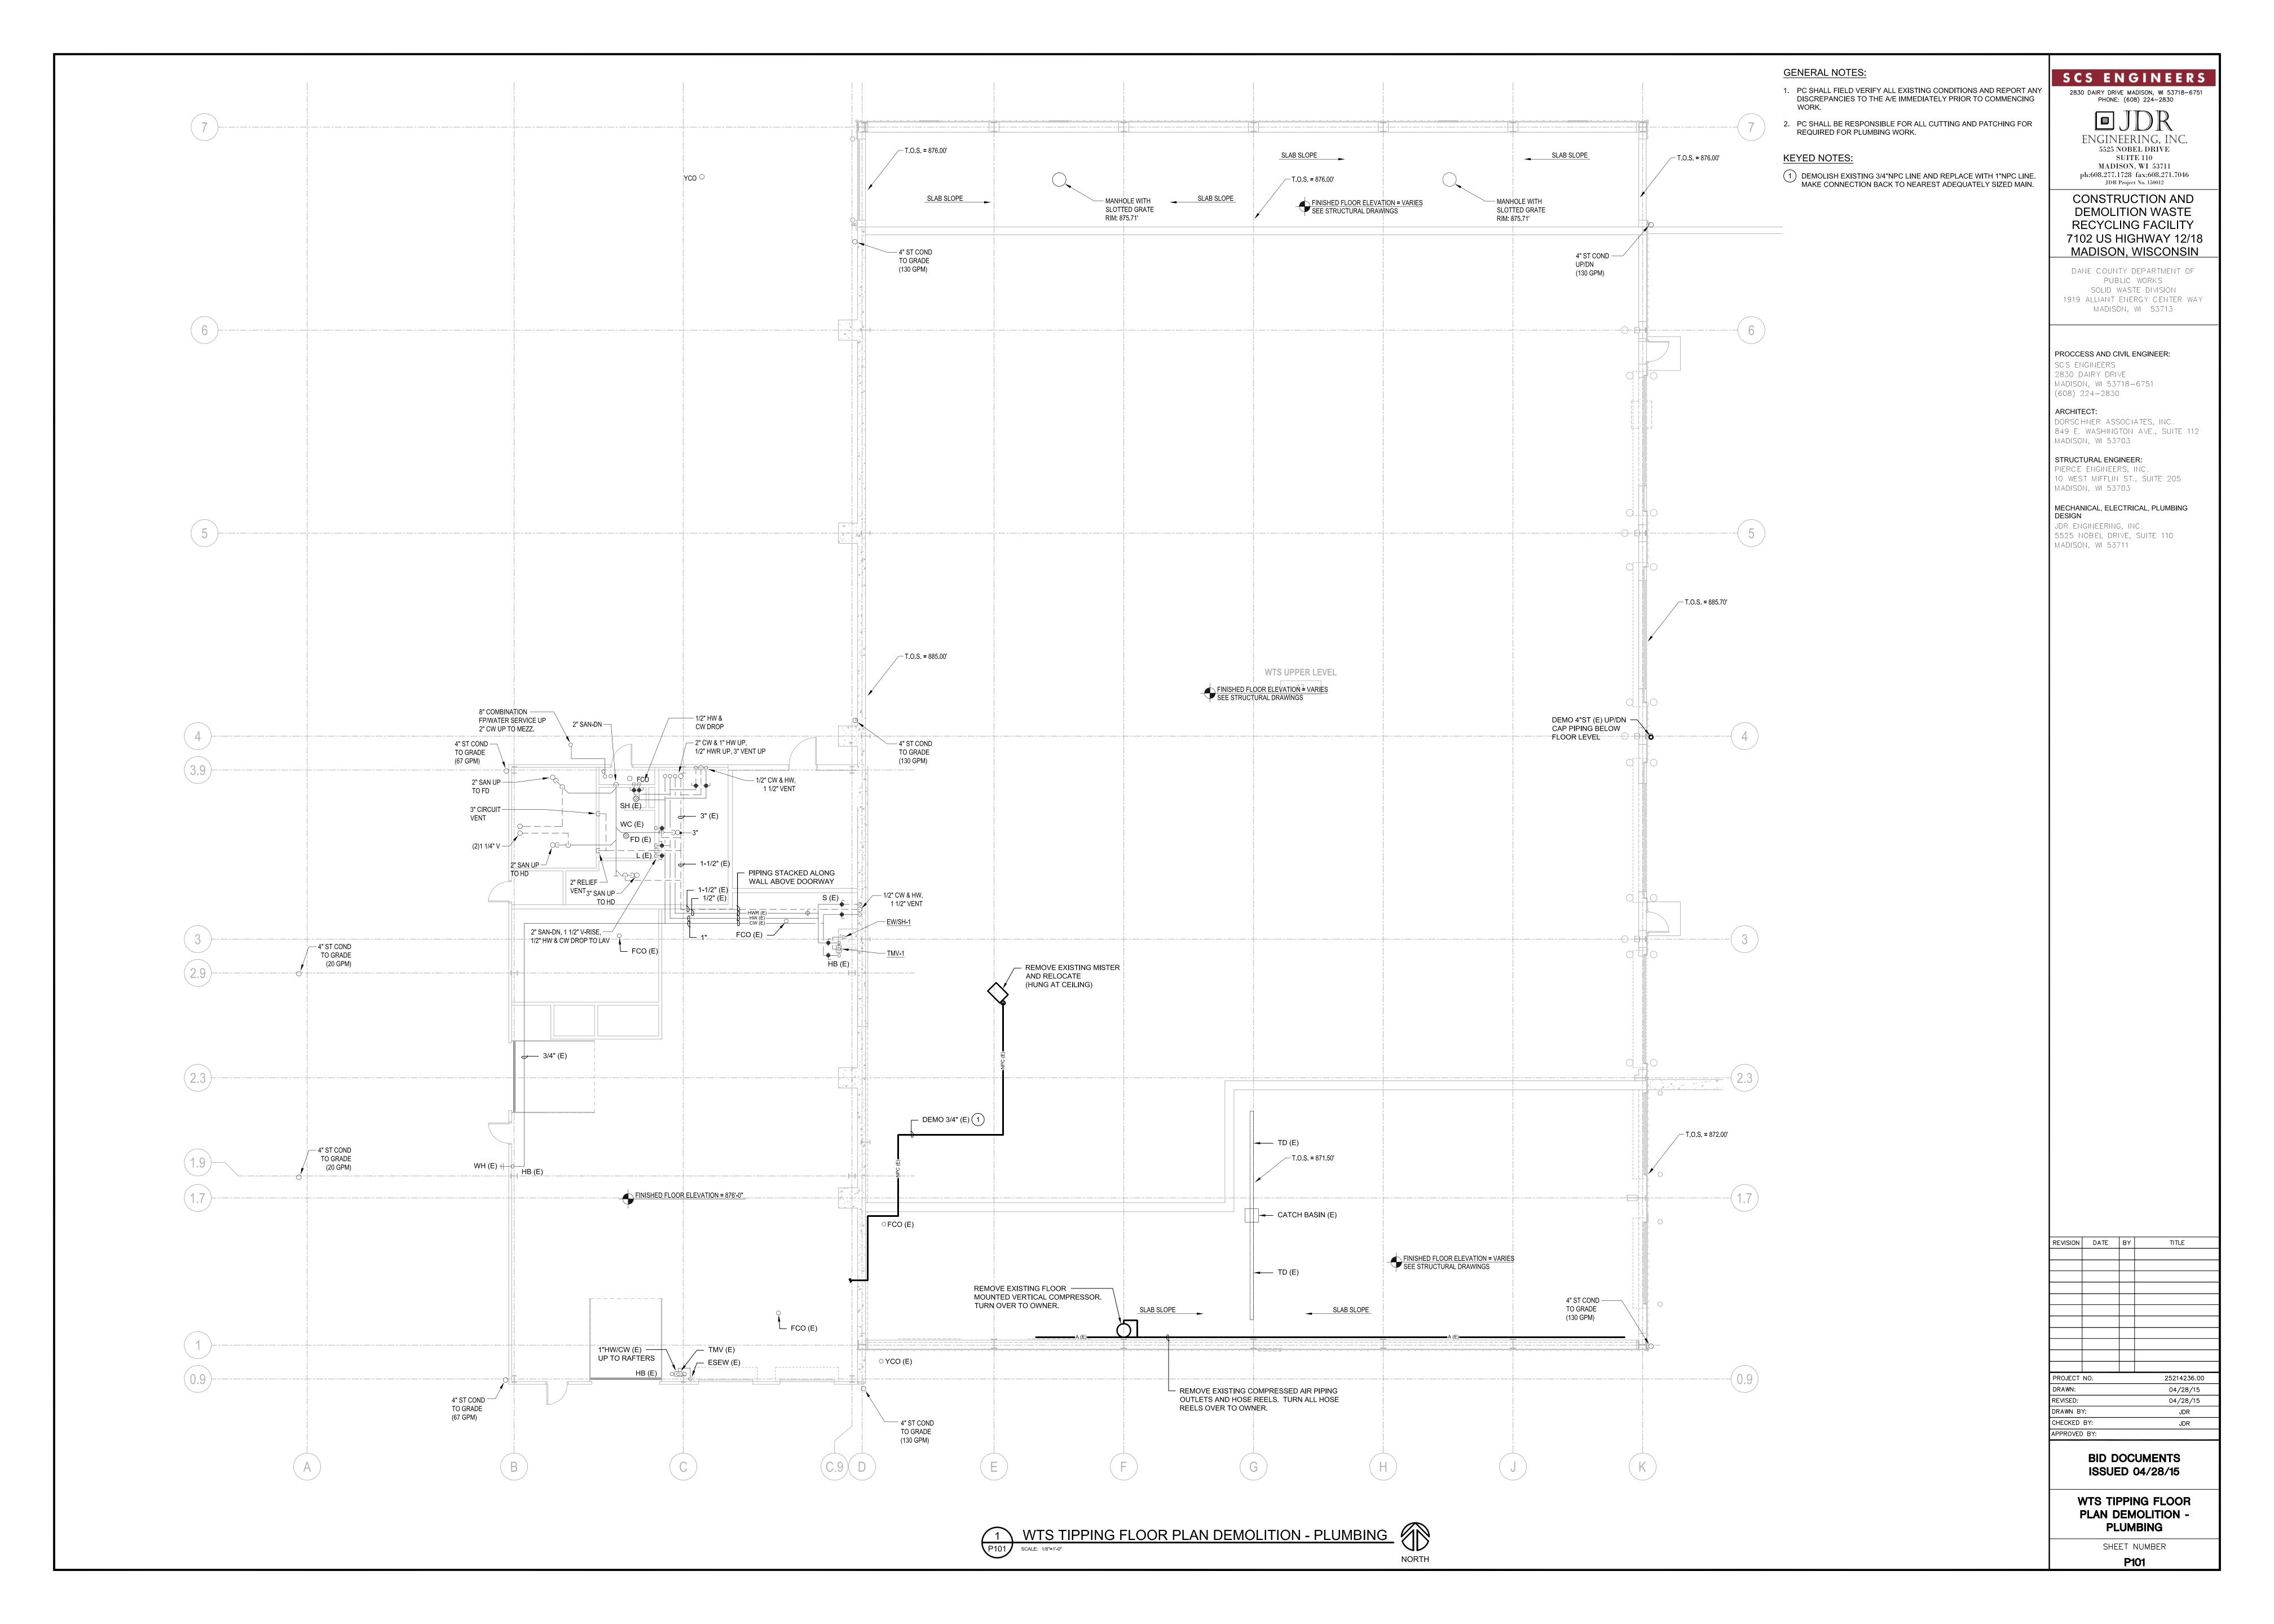



NORTH

GENERAL NOTES:

 PC SHALL FIELD VERIFY ALL EXISTING CONDITIONS AND REPORT ANY DISCREPANCIES TO THE A/E IMMEDIATELY PRIOR TO COMMENCING WORK.

KEYED NOTES:

CONNECT 1"NPC TO EXISTING ADEQUATELY SIZED NPC LINE. PROVIDE DRAIN VALVE IN HEATED SPACE AND PITCH 1"NPC LINE TO BE ABLE TO COMPLETELY DRAIN PRIOR TO FREEZING SEASON. PROVIDE ADDED DRAIN VALVES AT LOW POINTS IN LINE AS REQUIRED.

SCS ENGINEERS

MADISON, WI 53711

ph:608.277.1728 fax:608.271.7046 JDR Project No. 150012

2830 DAIRY DRIVE MADISON, WI 53718-6751 PHONE: (608) 224-2830

ENGINEERING, INC.
5525 NOBEL DRIVE
SUITE 110

CONSTRUCTION AND DEMOLITION WASTE RECYCLING FACILITY 7102 US HIGHWAY 12/18 MADISON, WISCONSIN

DANE COUNTY DEPARTMENT OF
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SOLID WASTE DIVISION
1919 ALLIANT ENERGY CENTER WAY
MADISON, WI 53713

PROCCESS AND CIVIL ENGINEER:

SCS ENGINEERS 2830 DAIRY DRIVE MADISON, WI 53718-6751 (608) 224-2830

ARCHITECT:

DORSCHNER ASSOCIATES, INC.

849 E. WASHINGTON AVE., SUITE 112

MADISON, WI 53703

STRUCTURAL ENGINEER:
PIERCE ENGINEERS, INC.
10 WEST MIFFLIN ST., SUITE 205

MECHANICAL, ELECTRICAL, PLUMBING DESIGN

JDR ENGINEERING, INC. 5525 NOBEL DRIVE, SUITE 110 MADISON, WI 53711

MADISON, WI 53703

REVISION	DATE	BY	TITLE
PROJECT NO.			25214236.00
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 PROJECT NO.
 25214236.00

 DRAWN:
 04/28/15

 REVISED:
 04/28/15


 DRAWN BY:
 JDR

 CHECKED BY:
 JDR

 APPROVED BY:

BID DOCUMENTS ISSUED 04/28/15

CLEAN SWEEP BUILDING - MAIN LEVEL - PLUMBING

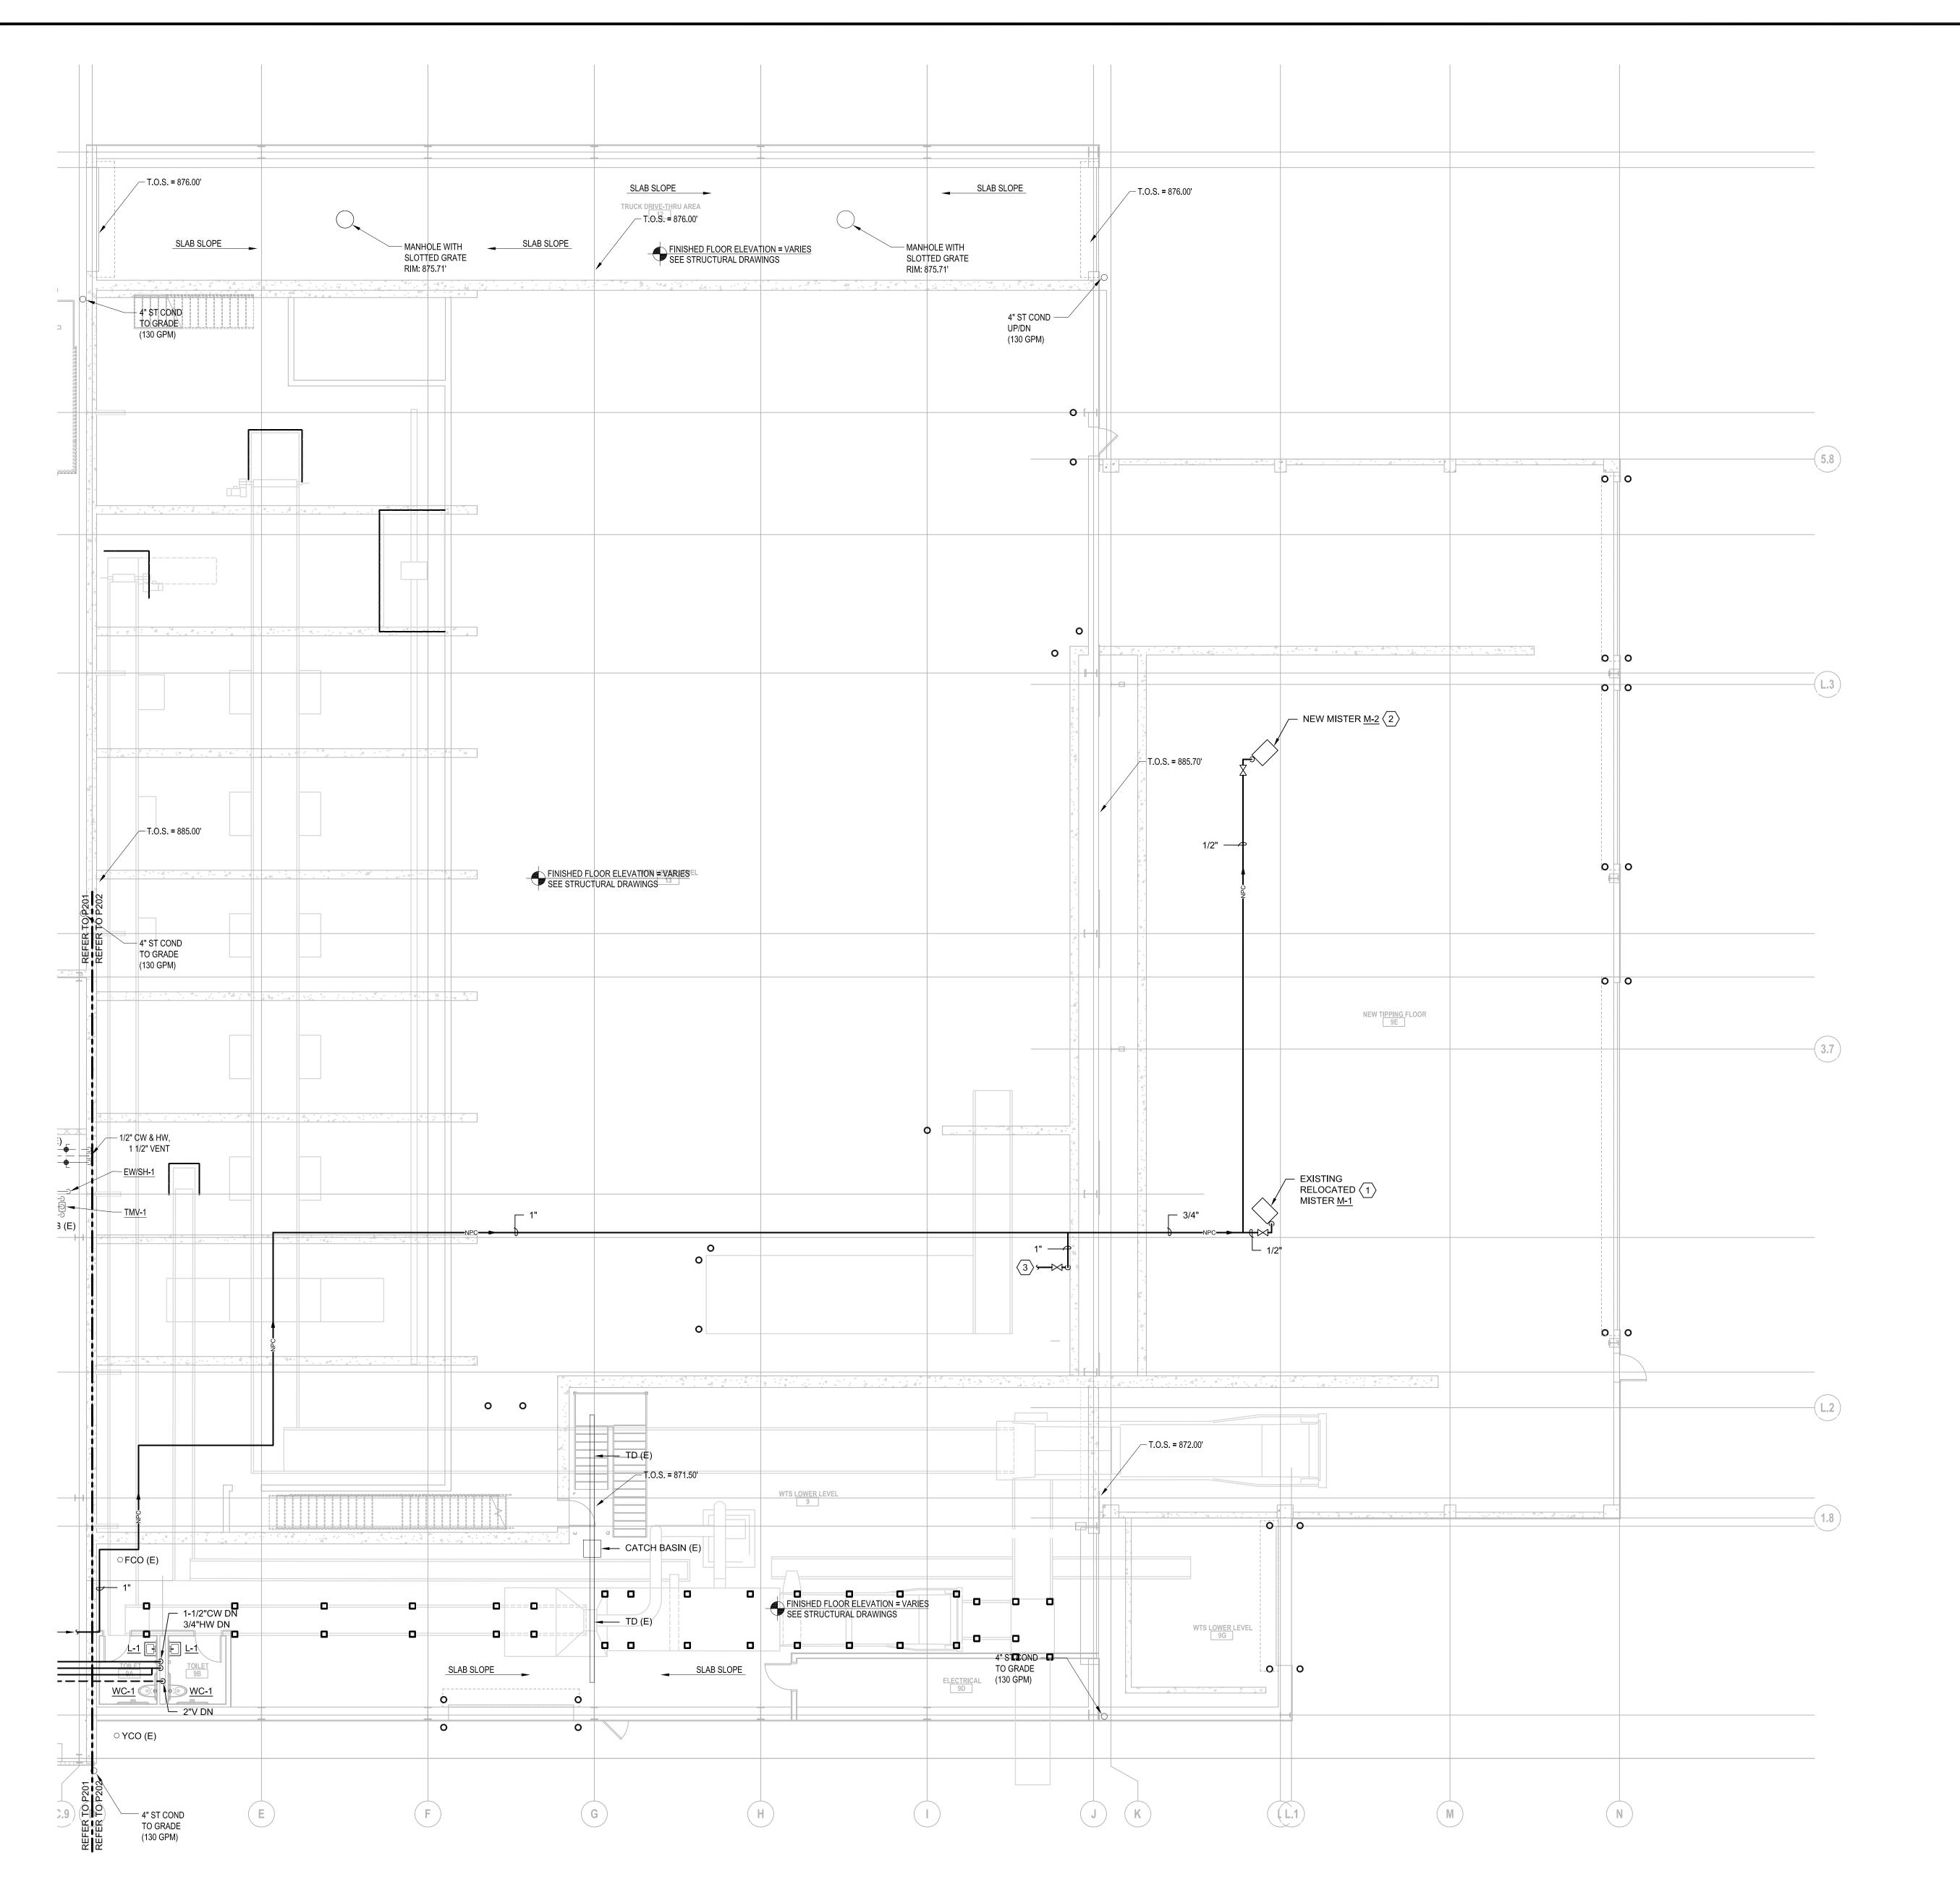

GENERAL NOTES:

 FPC SHALL FIELD VERIFY ALL EXISTING CONDITIONS AND REPORT ANY DISCREPANCIES TO THE A/E IMMEDIATELY PRIOR TO COMMENCING WORK.

2. ALL PIPING SHALL BE RAN 30'-0" MINIMUM ABOVE FLOOR.

KEYED NOTES:

- RELOCATE EXISTING DUST MISTER $\underline{\text{M-1}}$ AND CONNECT 1/2"NPC AS REQUIRED PER MANUFACTURER'S WRITTEN INSTRUCTIONS. SUPPORT MISTER FROM ROOF TRUSS.
- PROVIDE NEW DUST MISTER AND CONNECT 1/2"NPC AS REQUIRED PER MANUFACTURER'S WRITTEN INSTRUCTIONS. SUPPORT MISTER FROM ROOF TRUSS.

 MISTER M-2: PROBE AMERICA ATOMIZER UNIT, MOUNTED FROM STRUCTURE, 480V 3 PH POWER, CONTROLLER ON WALL, LOW VOLTAGE WIRING BY PC, LINE VOLTAGE WIRING BY EC.
- (3) CONNECT 1"NPC TO WOOD GRINDER PER MANUFACTURER'S WRITTEN INSTRUCTIONS.

SCS ENGINEERS

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ENGINEERING, INC.
5525 NOBEL DRIVE
SUITE 110
MADISON, WI 53711

CONSTRUCTION AND DEMOLITION WASTE RECYCLING FACILITY 7102 US HIGHWAY 12/18 MADISON, WISCONSIN

ph:608.277.1728 fax:608.271.7046

JDR Project No. 150012

DANE COUNTY DEPARTMENT OF
PUBLIC WORKS
SOLID WASTE DIVISION
1919 ALLIANT ENERGY CENTER WAY
MADISON, WI 53713

PROCCESS AND CIVIL ENGINEER:

SCS ENGINEERS 2830 DAIRY DRIVE MADISON, WI 53718-6751 (608) 224-2830

ARCHITECT:

DORSCHNER ASSOCIATES, INC.

849 E. WASHINGTON AVE., SUITE 112

MADISON, WI 53703

STRUCTURAL ENGINEER:
PIERCE ENGINEERS, INC.
10 WEST MIFFLIN ST., SUITE 205
MADISON, WI 53703

MECHANICAL, ELECTRICAL, PLUMBING DESIGN

JDR ENGINEERING, INC.

5525 NOBEL DRIVE, SUITE 110 MADISON, WI 53711

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 APPROVED BY:

BID DOCUMENTS


ISSUED 04/28/15
WTS NEW TIPPING

FLOOR PLAN - PLUMBING

SHEET NUMBER

P202

1 WTS NEW TIPPING FLOOR PLAN - PLUMBING
P202 SCALE: 1/8"=1"-0"
NORTH

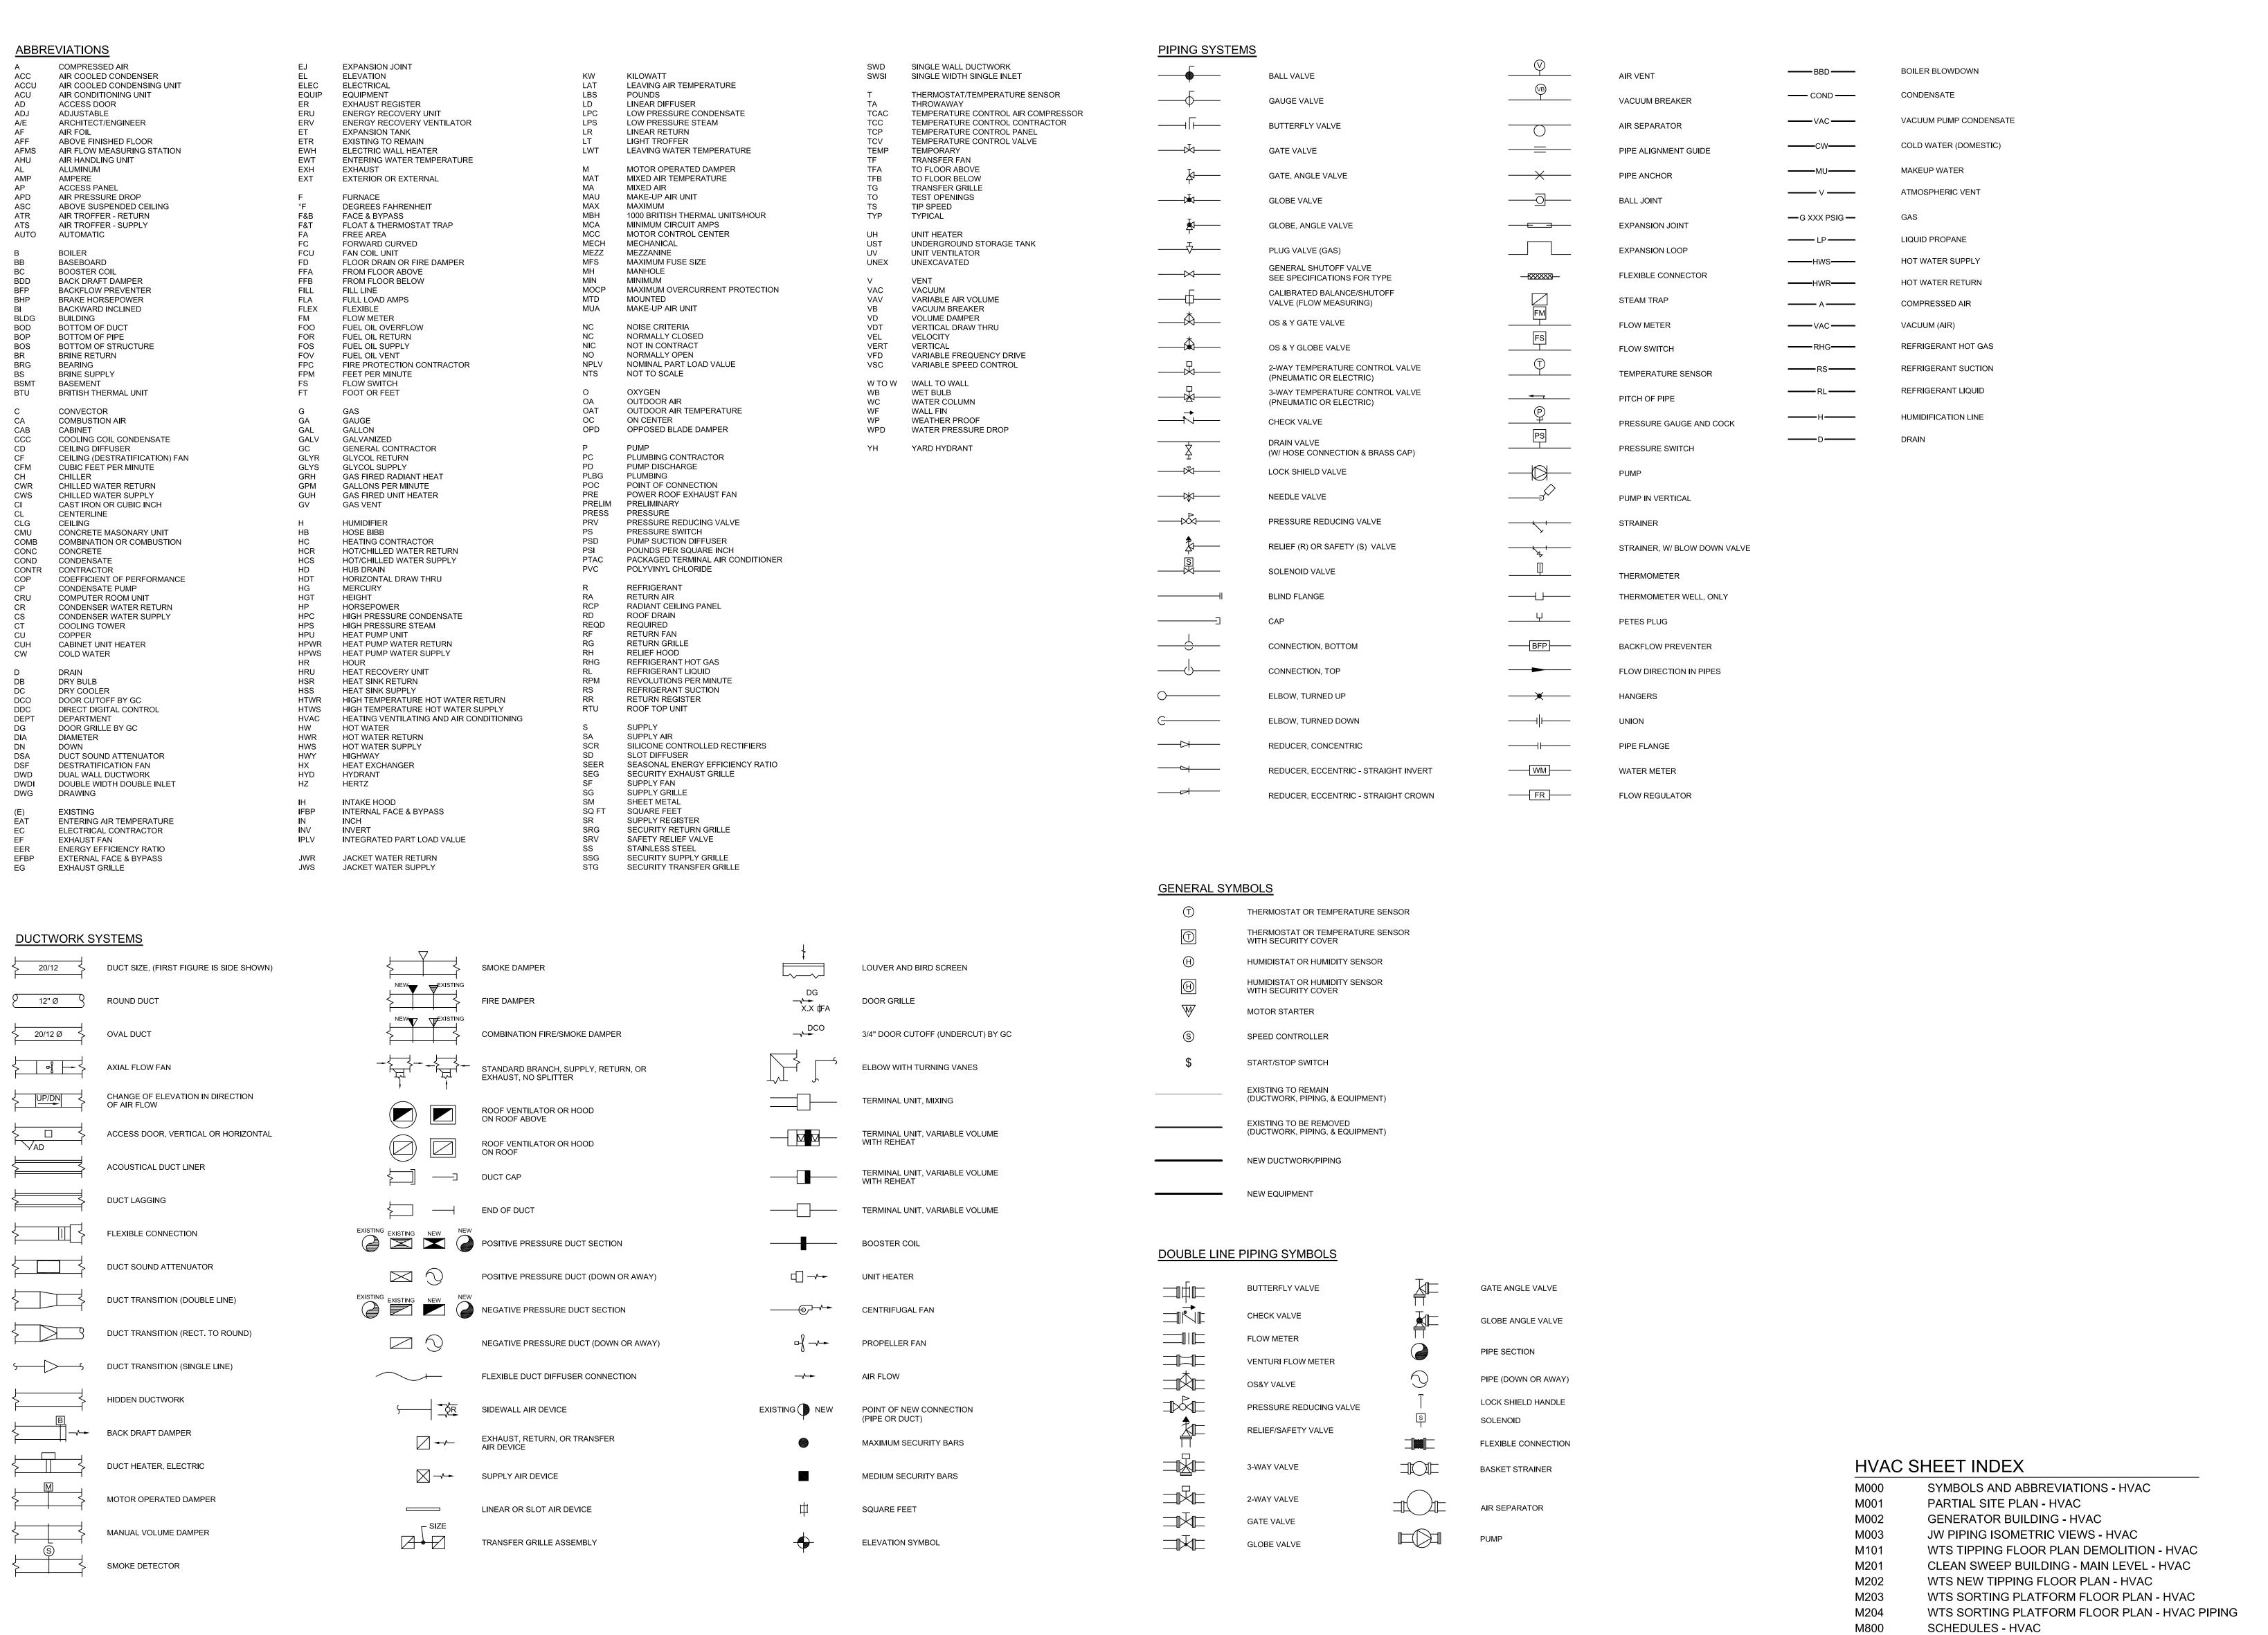

SCS ENGINEERS

2830 DAIRY DRIVE MADISON, WI 53718-6751

PHONE: (608) 224-2830

ENGINEERING, INC.
5525 NOBEL DRIVE
SUITE 110
MADISON, WI 53711
ph:608.277.1728 fax:608.271.7046
JDR Project No. 150012

CONSTRUCTION AND DEMOLITION WASTE RECYCLING FACILITY 7102 US HIGHWAY 12/18 MADISON, WISCONSIN

DANE COUNTY DEPARTMENT OF
PUBLIC WORKS
SOLID WASTE DIVISION
1919 ALLIANT ENERGY CENTER WAY
MADISON, WI 53713

PROCCESS AND CIVIL ENGINEER:

SCS ENGINEERS
2830 DAIRY DRIVE
MADISON, WI 53718-6751
(608) 224-2830

ARCHITECT:

DESIGN

DORSCHNER ASSOCIATES, INC.
849 E. WASHINGTON AVE., SUITE 112
MADISON, WI 53703

STRUCTURAL ENGINEER:

0 WEST MIFFLIN ST., SUITE 205

MADISON, WI 53703

MECHANICAL, ELECTRICAL, PLUMBING

JDR ENGINEERING, INC. 5525 NOBEL DRIVE, SUITE 110 MADISON, WI 53711

PIERCE ENGINEERS, INC.

REVISION DATE BY TITLE

PROJECT NO. 25214236.00

 PROJECT NO.
 25214236.00

 DRAWN:
 04/28/15

 REVISED:
 04/28/15

 DRAWN BY:
 JDR

 CHECKED BY:
 JDR

 APPROVED BY:

ISSUED 04/28/15


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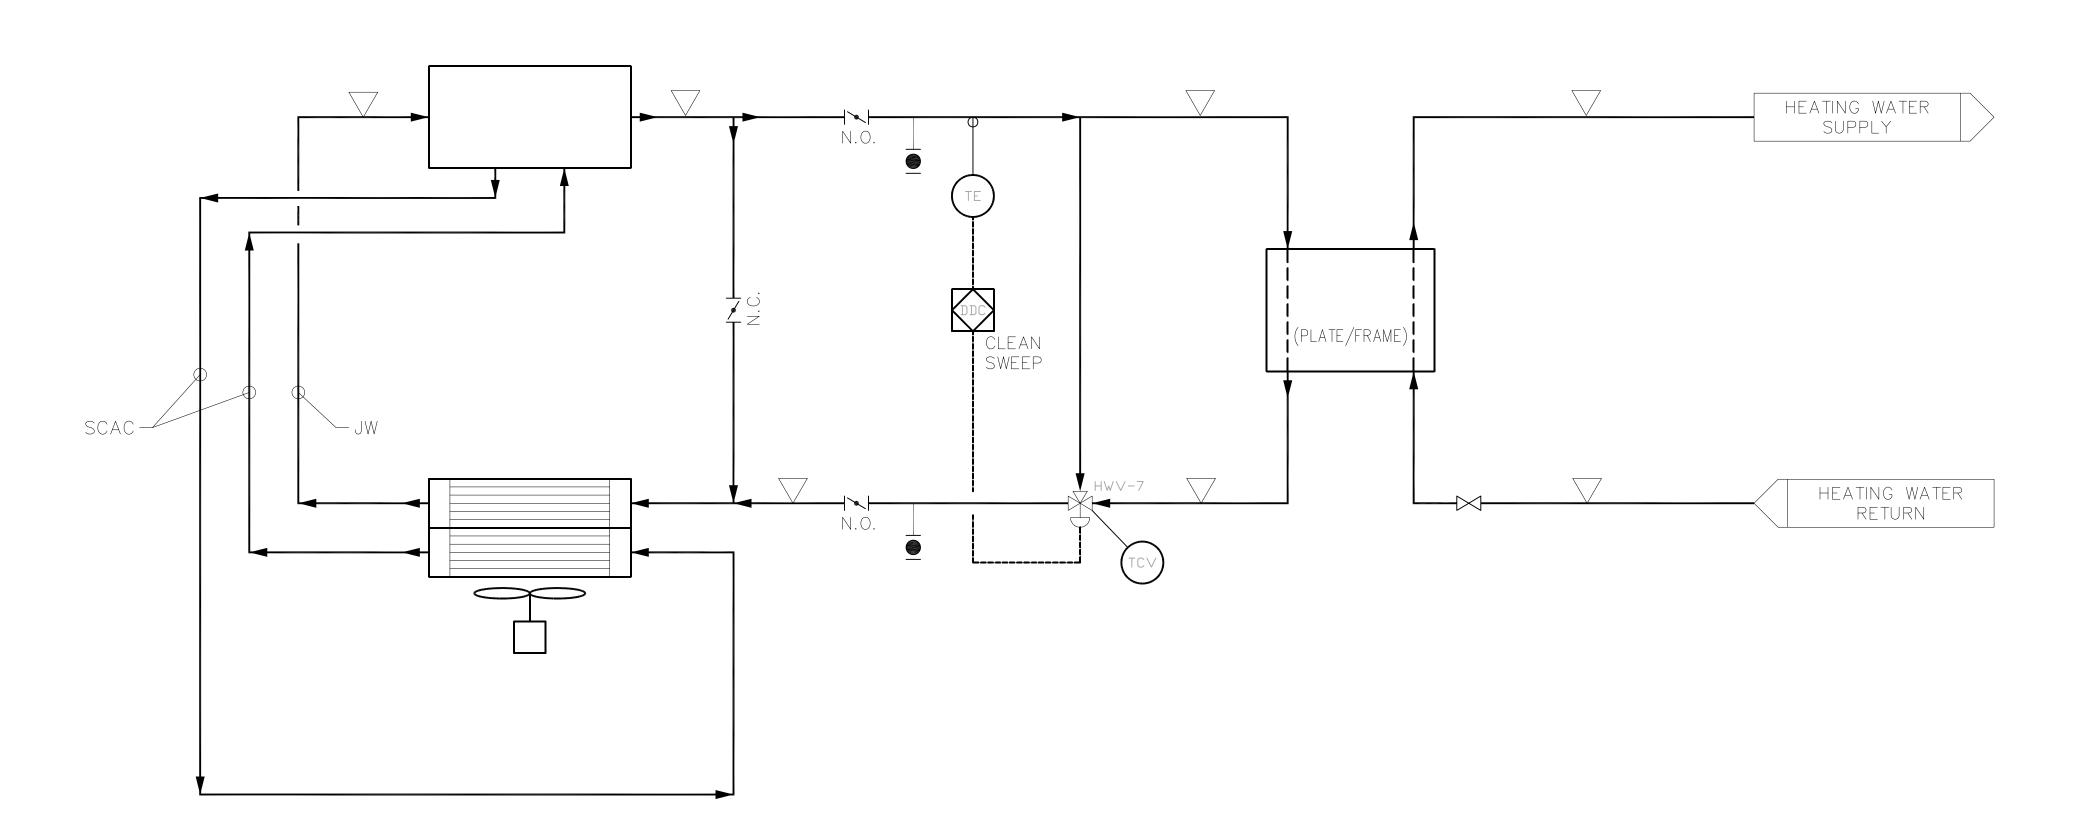
SYMBOLS AND ABBREVIATIONS - HVAC

DETAILS AND SCHEMATICS - HVAC


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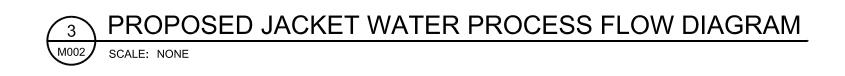
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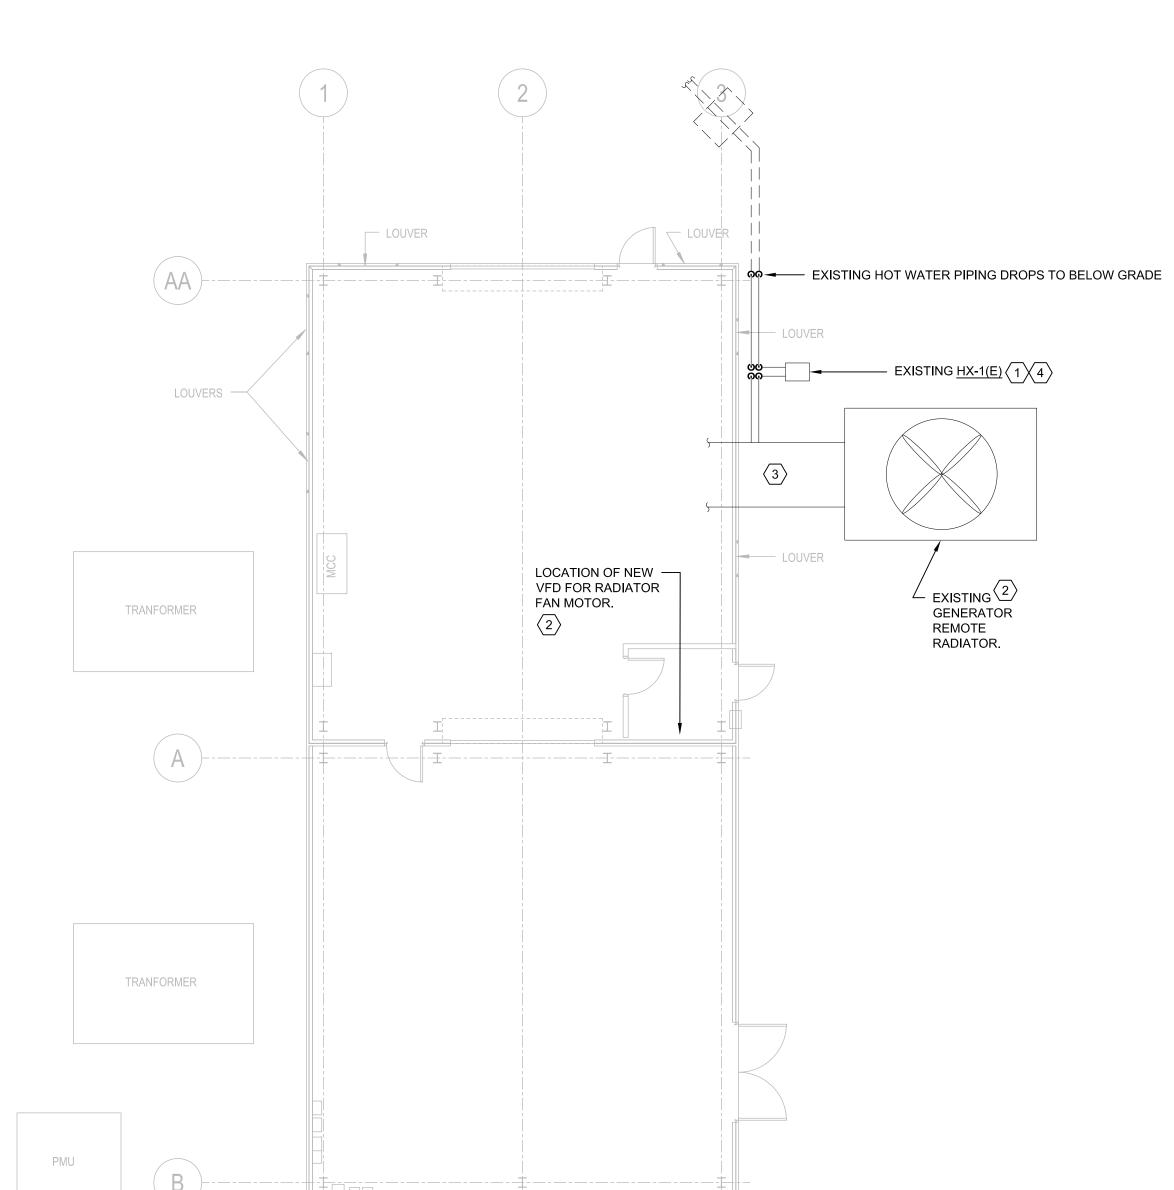






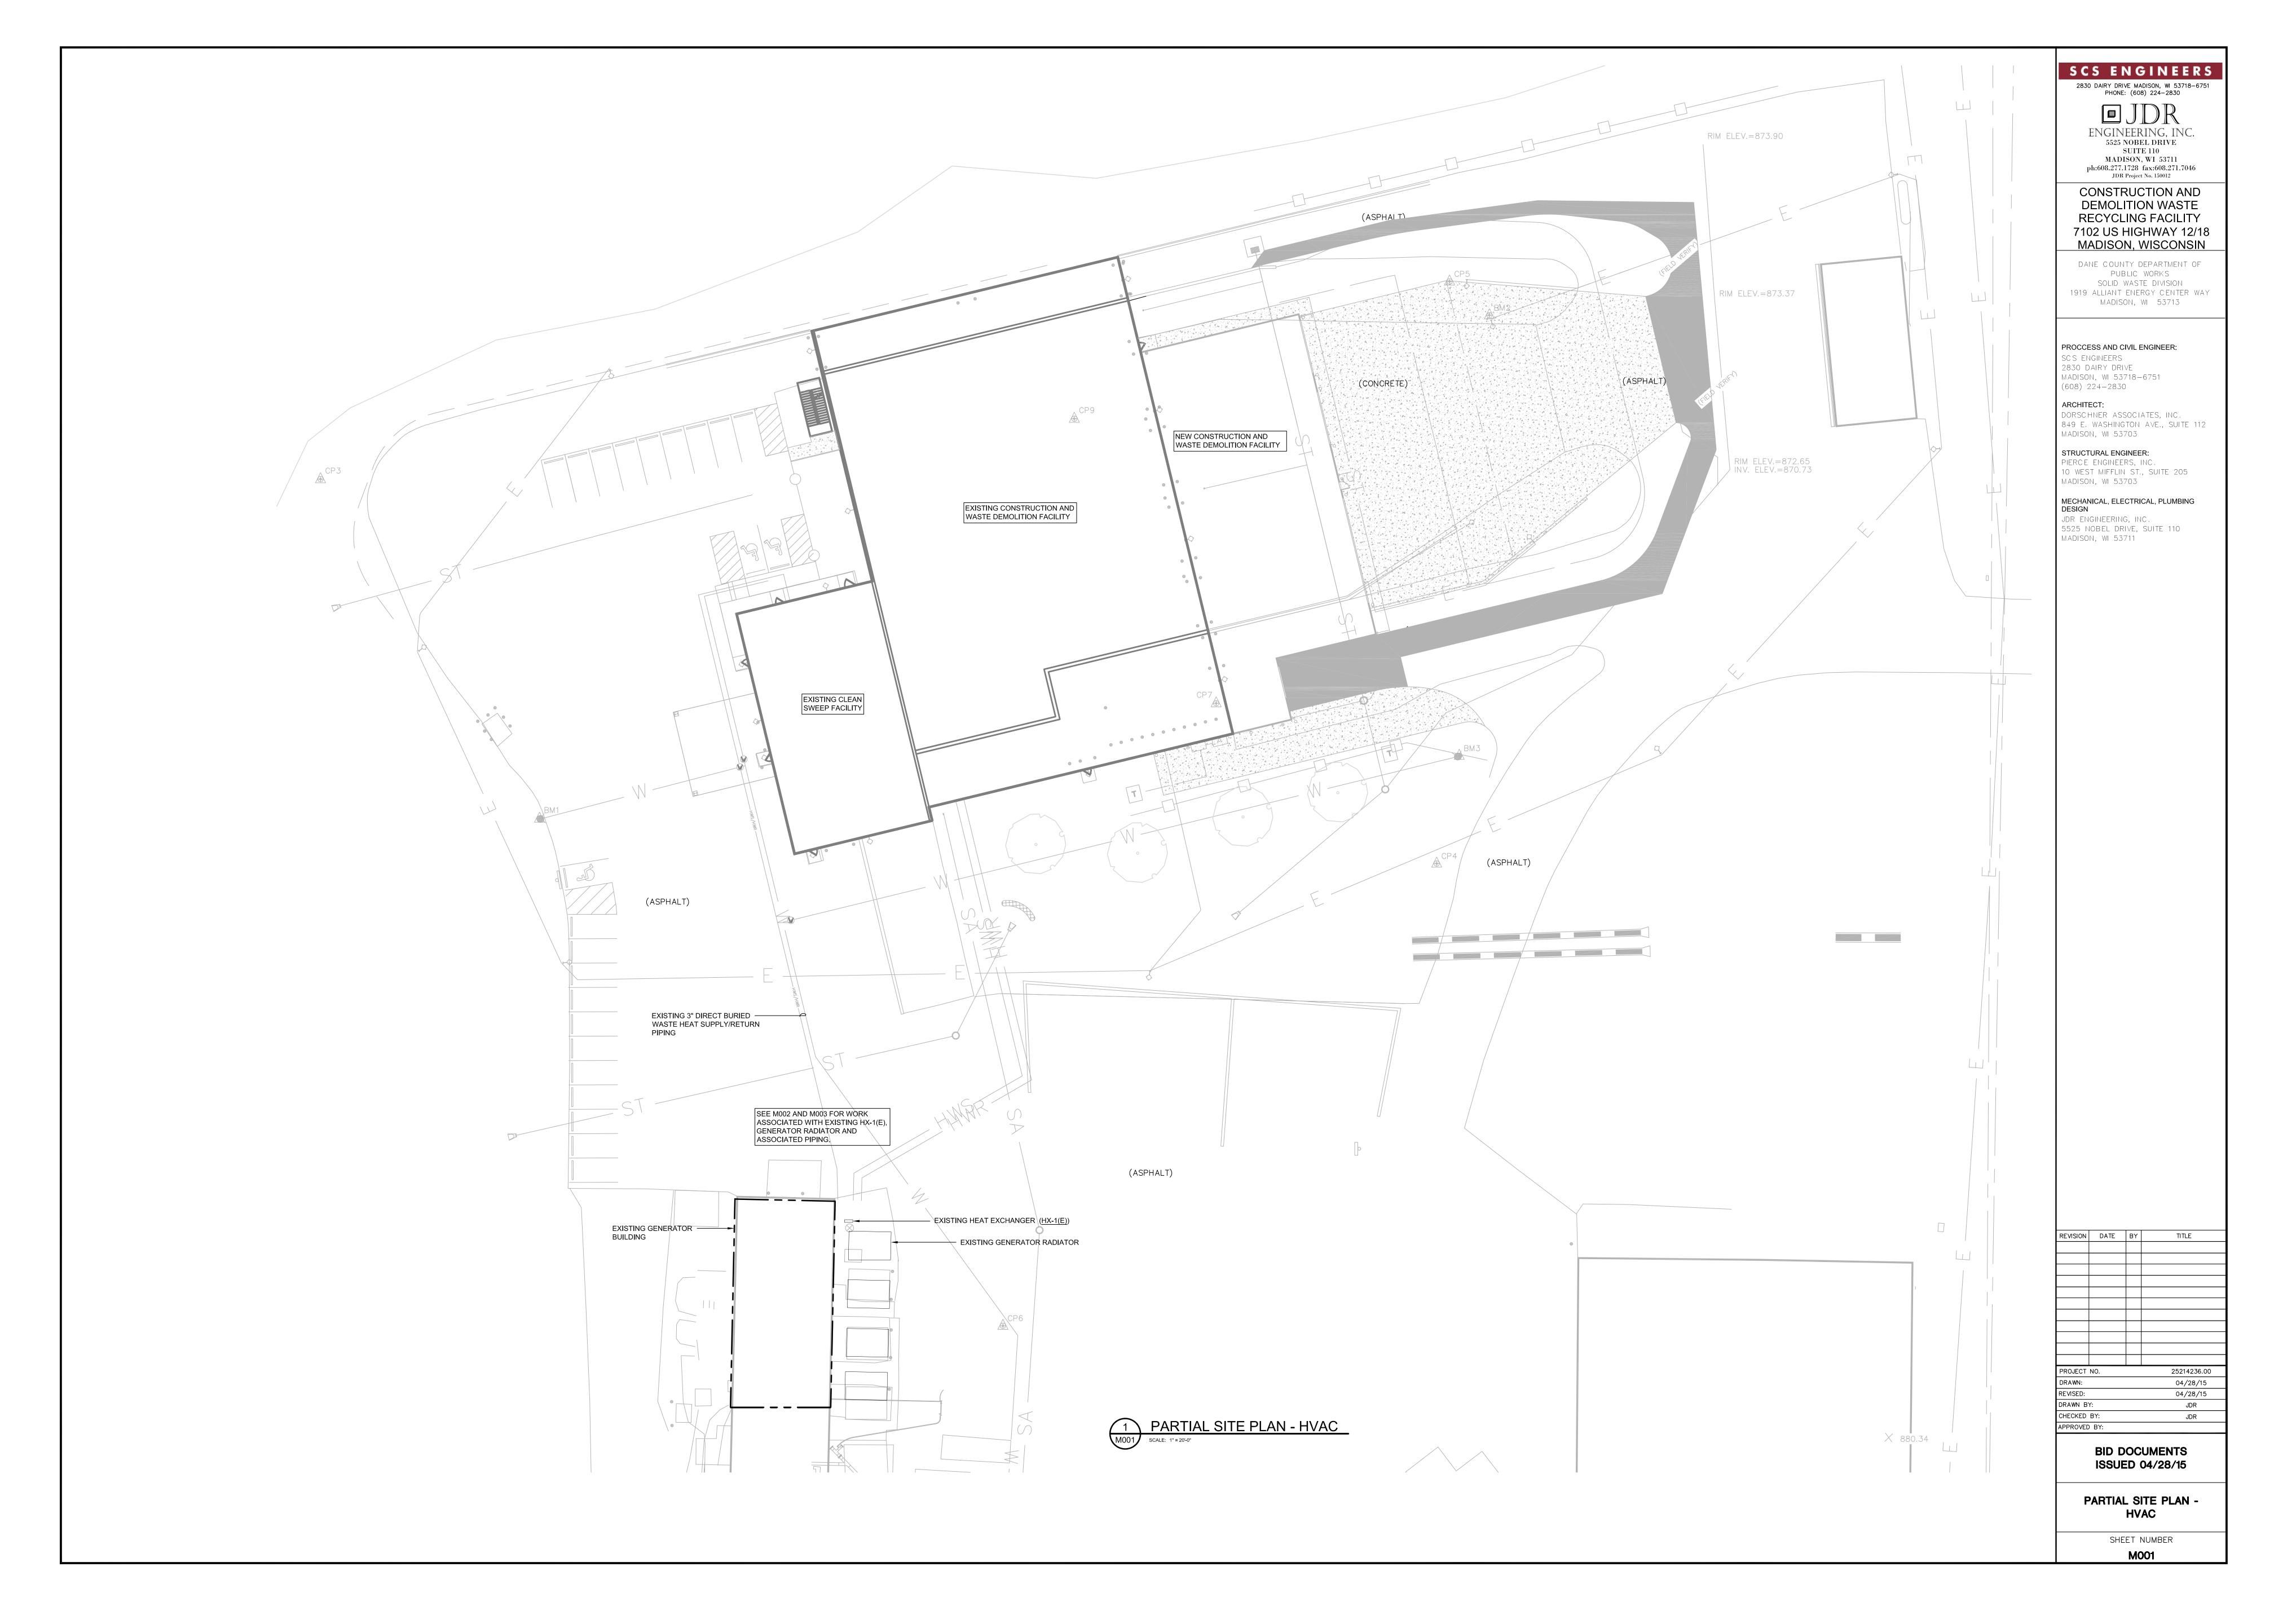



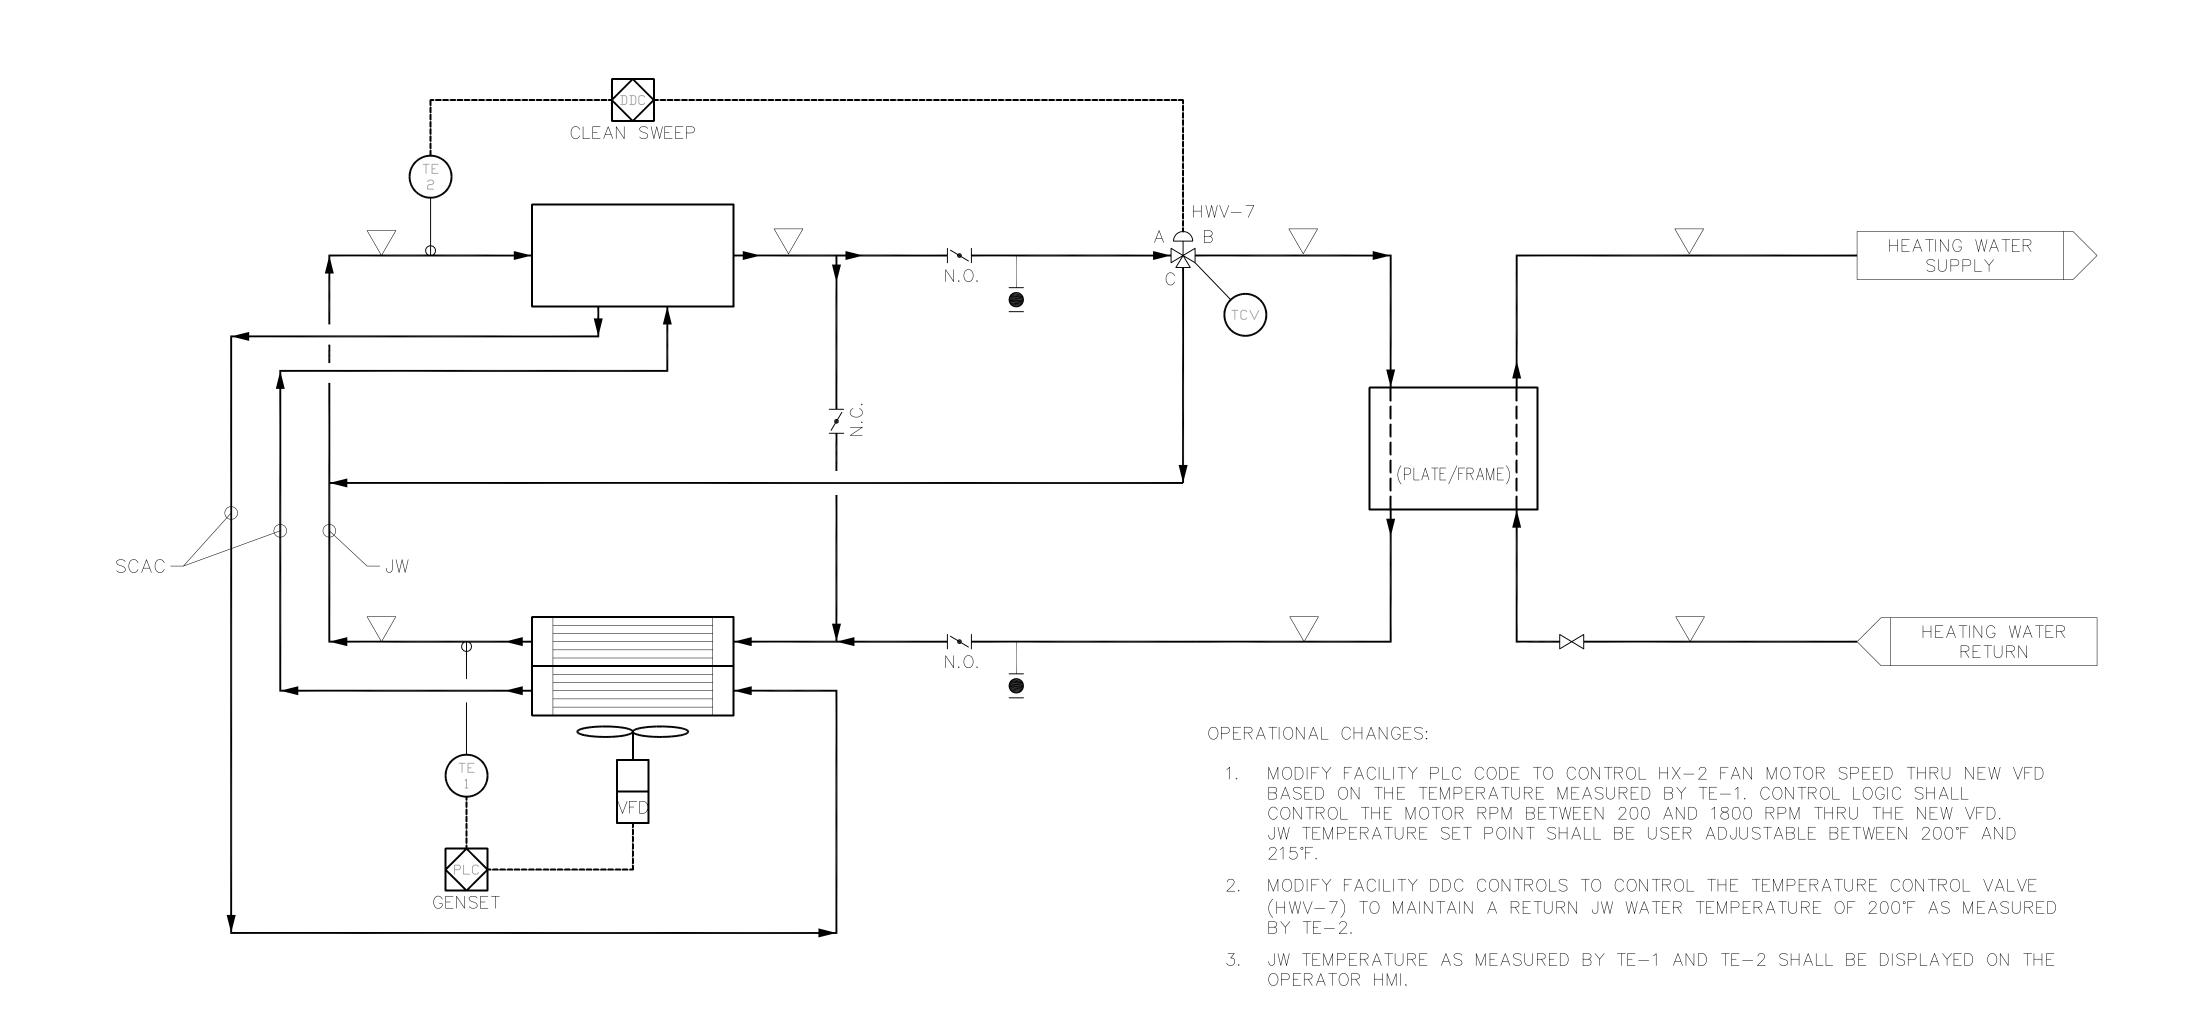

GENERATOR BUILDING - HVAC M002 SCALE: 1/8"=1"-0" KEYED NOTES:

- EXISTING WATER TO WATER PLATE AND FRAME HEAT EXCHANGER (ITT/XYLEM, MODEL P22-27-TK). PROVIDE AND INSTALL (22) ADDITIONAL PLATES FOR A TOTAL OF (49) PLATES (MAXIMUM) AT THE HEAT EXCHANGER. PLATES SHALL BE 304 STAINLESS STEEL WITH EPDM GASKETS COMPATIBLE WITH GENERATOR JACKET WATER TEMPERATURE RANGE. MECHANICAL CONTRACTOR SHALL FLUSH HEAT EXCHANGER AFTER INSTALLATION OF NEW PLATES AND PURGE SYSTEM OF ALL AIR. SEE DEMOLITION AND NEW WORK SCHEMATIC PIPING DIAGRAMS FOR ADDITIONAL PIPING, SENSOR AND CONTROL MODIFICATIONS.
- 2 EXISTING GENERATOR RADIATOR. MECHANICAL CONTRACTOR SHALL REMOVE EXISTING SIEMENS 20 HP, 460V/3P FAN MOTOR, TYPE RGZPSD, 256T FRAME, INSULATION CLASS 'F'. INSTALL BEARING PROTECTION GROUNDING RINGS ON EXISTING FAN MOTOR TO BLEED CURRENT FROM THE MOTOR SHAFT TO THE MOTOR CASING AND BE COMPATIBLE WITH NEW VARIABLE SPEED DRIVE. PROVIDE AND INSTALL 20 HP VARIABLE FREQUENCY DRIVE FOR FAN MOTOR. COORDINATE FINAL VFD LOCATION WITH OWNER AND EC. EC SHALL WIRE NEW VFD. MECHANICAL CONTRACTOR SHALL REINSTALL EXISTING FAN MOTOR AT SAME LOCATION. EC SHALL DISCONNECT AND RECONNECT POWER TO FAN MOTOR.
- SEE DEMOLITION AND NEW WORK SCHEMATIC PIPE DIAGRAMS ON M003 FOR ADDITIONAL PIPING, SENSOR AND CONTROL MODIFICATIONS.
- PIPING, SENSOR AND CONTROL MODIFICATIONS.

 4 PROVIDE INSULATION PER SPECIFICATIONS ON EXISTING HEAT EXCHANGER HX-1 (E).

SCS ENGINEERS

2830 DAIRY DRIVE MADISON, WI 53718-6751 PHONE: (608) 224-2830

ENGINEERING, INC.

5525 NOBEL DRIVE
SUITE 110

MADISON, WI 53711

ph:608.277.1728 fax:608.271.7046

CONSTRUCTION AND
DEMOLITION WASTE
RECYCLING FACILITY
7102 US HIGHWAY 12/18

MADISON, WISCONSIN

MADISON, WI 53713

DANE COUNTY DEPARTMENT OF
PUBLIC WORKS
SOLID WASTE DIVISION
1919 ALLIANT ENERGY CENTER WAY

PROCCESS AND CIVIL ENGINEER:

SCS ENGINEERS 2830 DAIRY DRIVE MADISON, WI 53718-6751 (608) 224-2830

MADISON, WI 53703


MADISON, WI 53703

ARCHITECT:
DORSCHNER ASSOCIATES, INC.
849 E. WASHINGTON AVE., SUITE 112

STRUCTURAL ENGINEER:
PIERCE ENGINEERS, INC.
10 WEST MIFFLIN ST., SUITE 205

MECHANICAL, ELECTRICAL, PLUMBING DESIGN


JDR ENGINEERING, INC. 5525 NOBEL DRIVE, SUITE 110 MADISON, WI 53711

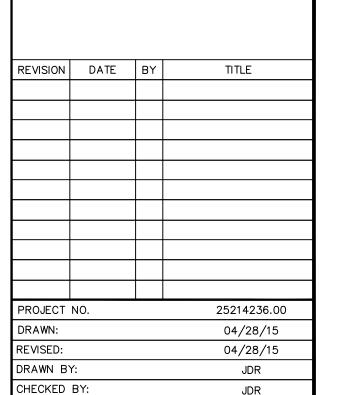


BID DOCUMENTS
ISSUED 04/28/15

GENERATOR BUILDING -HVAC

SHEET NUMBER MOO2

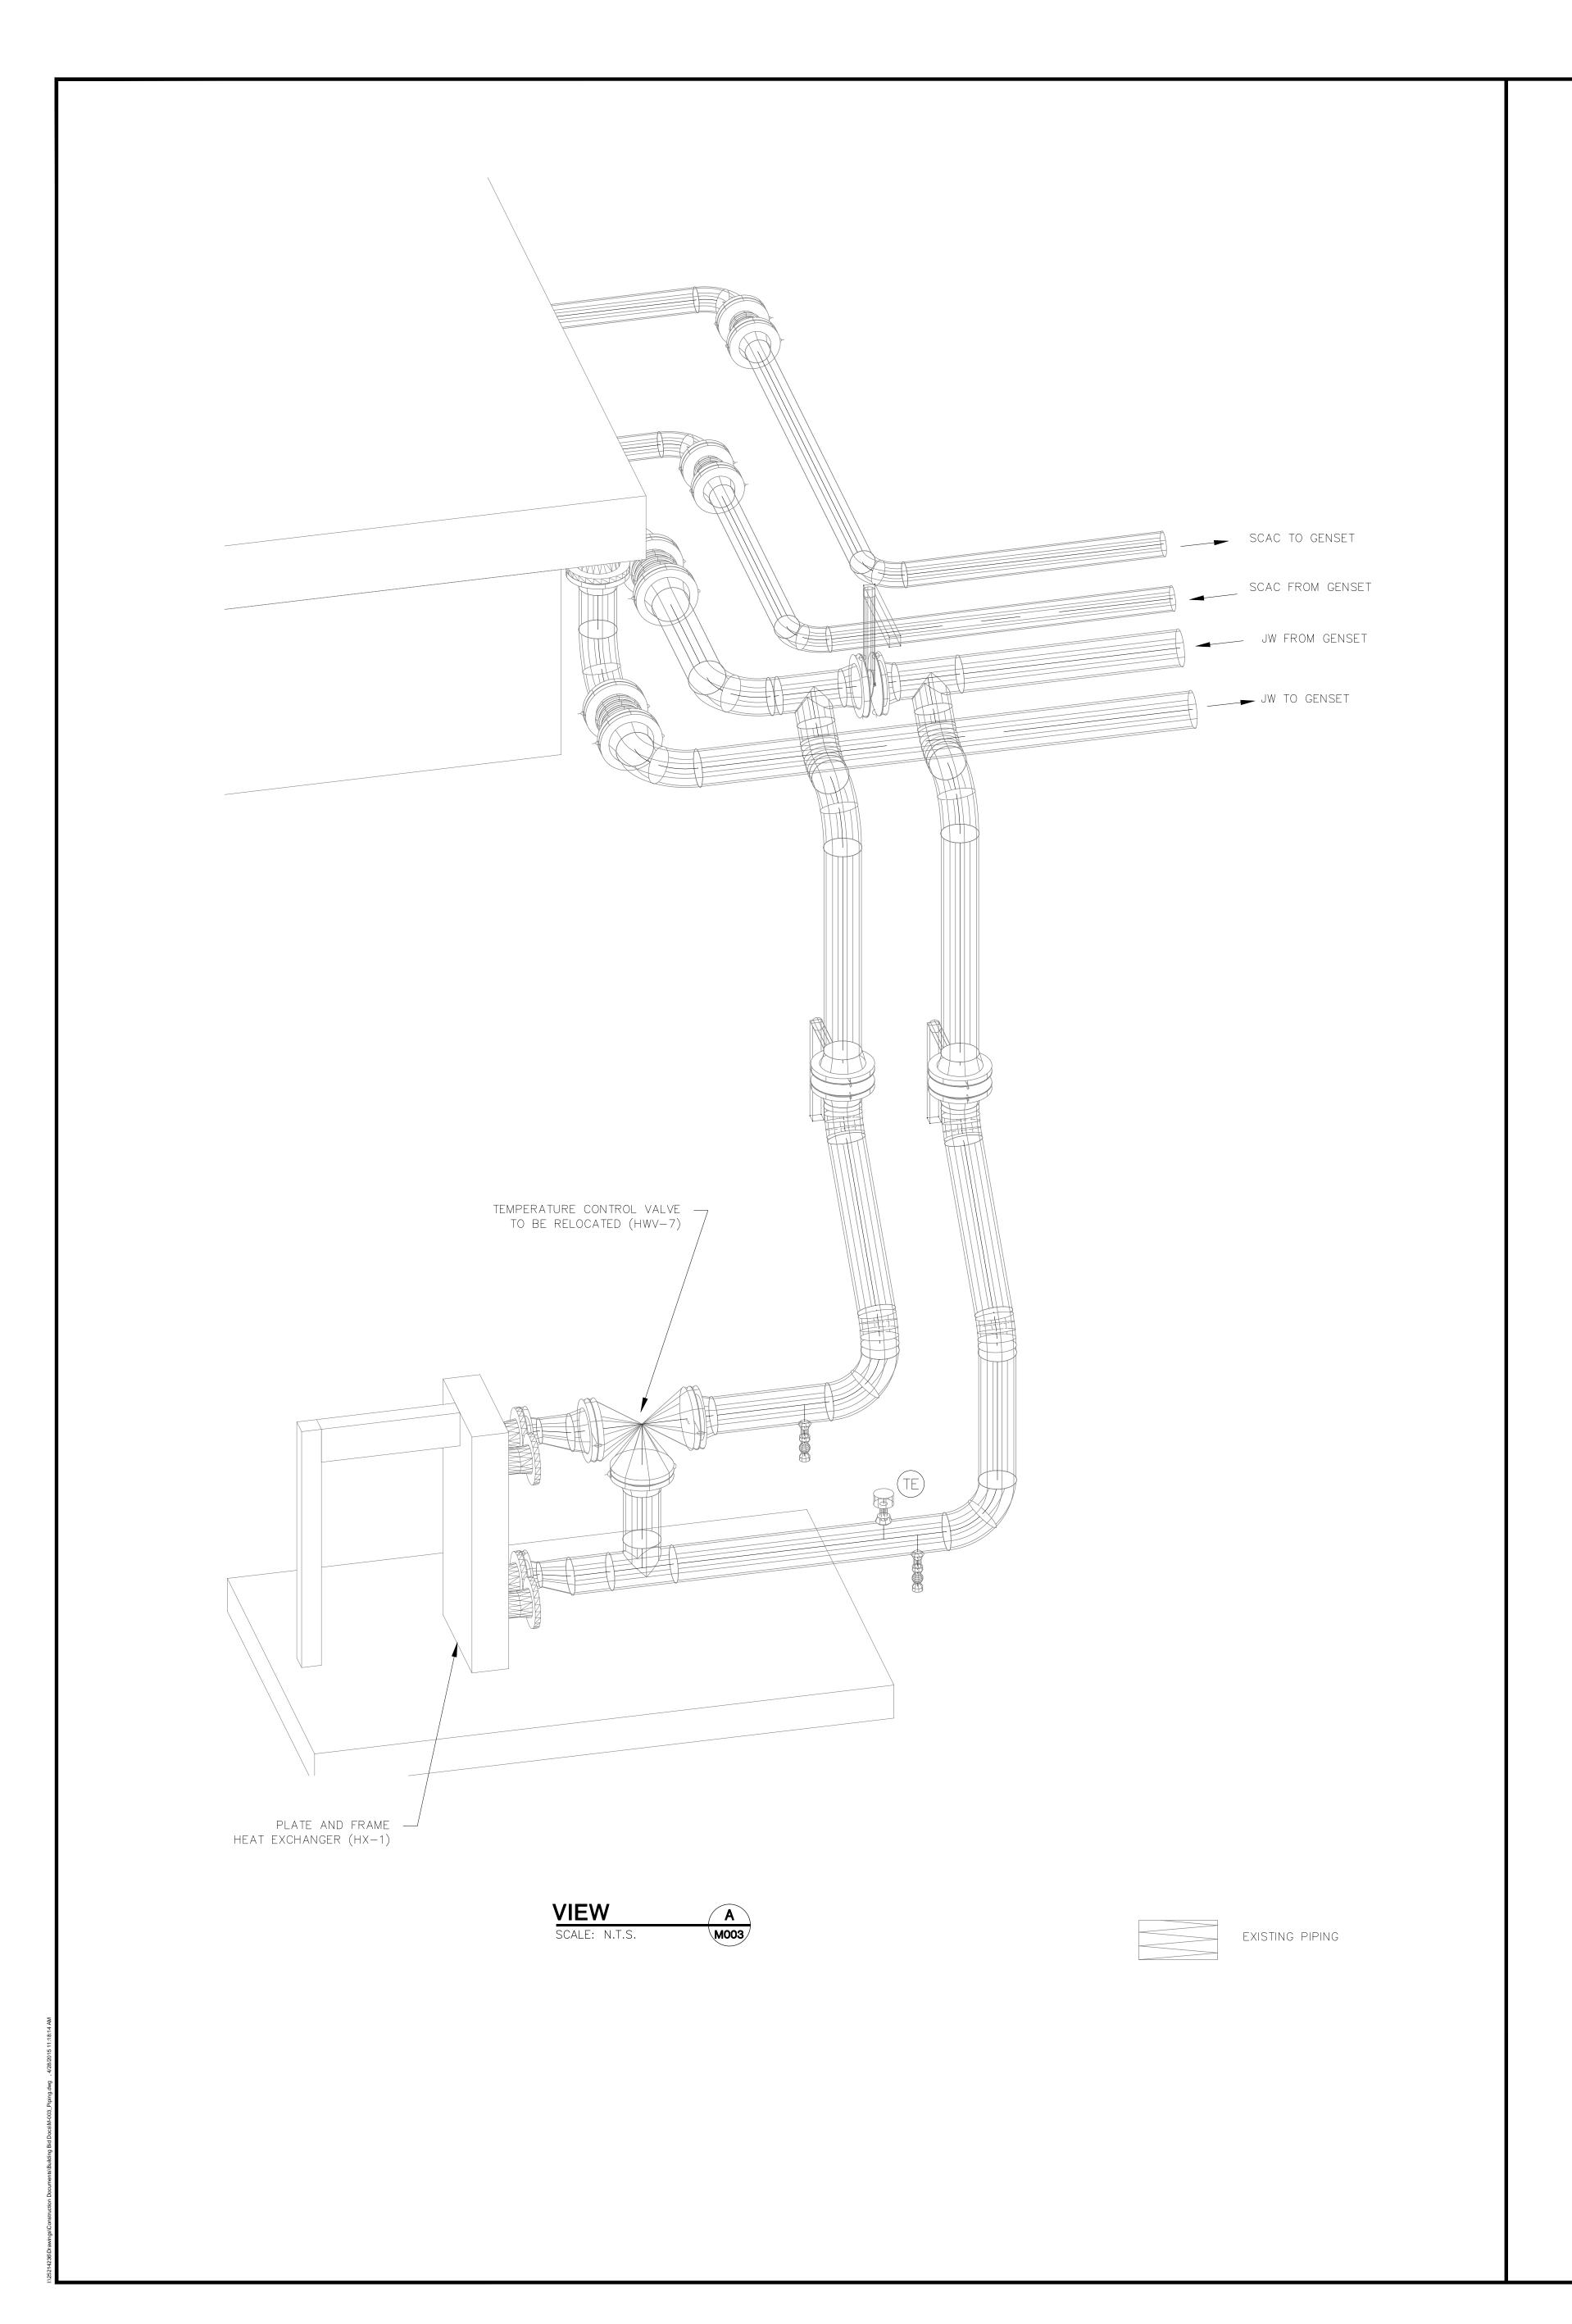

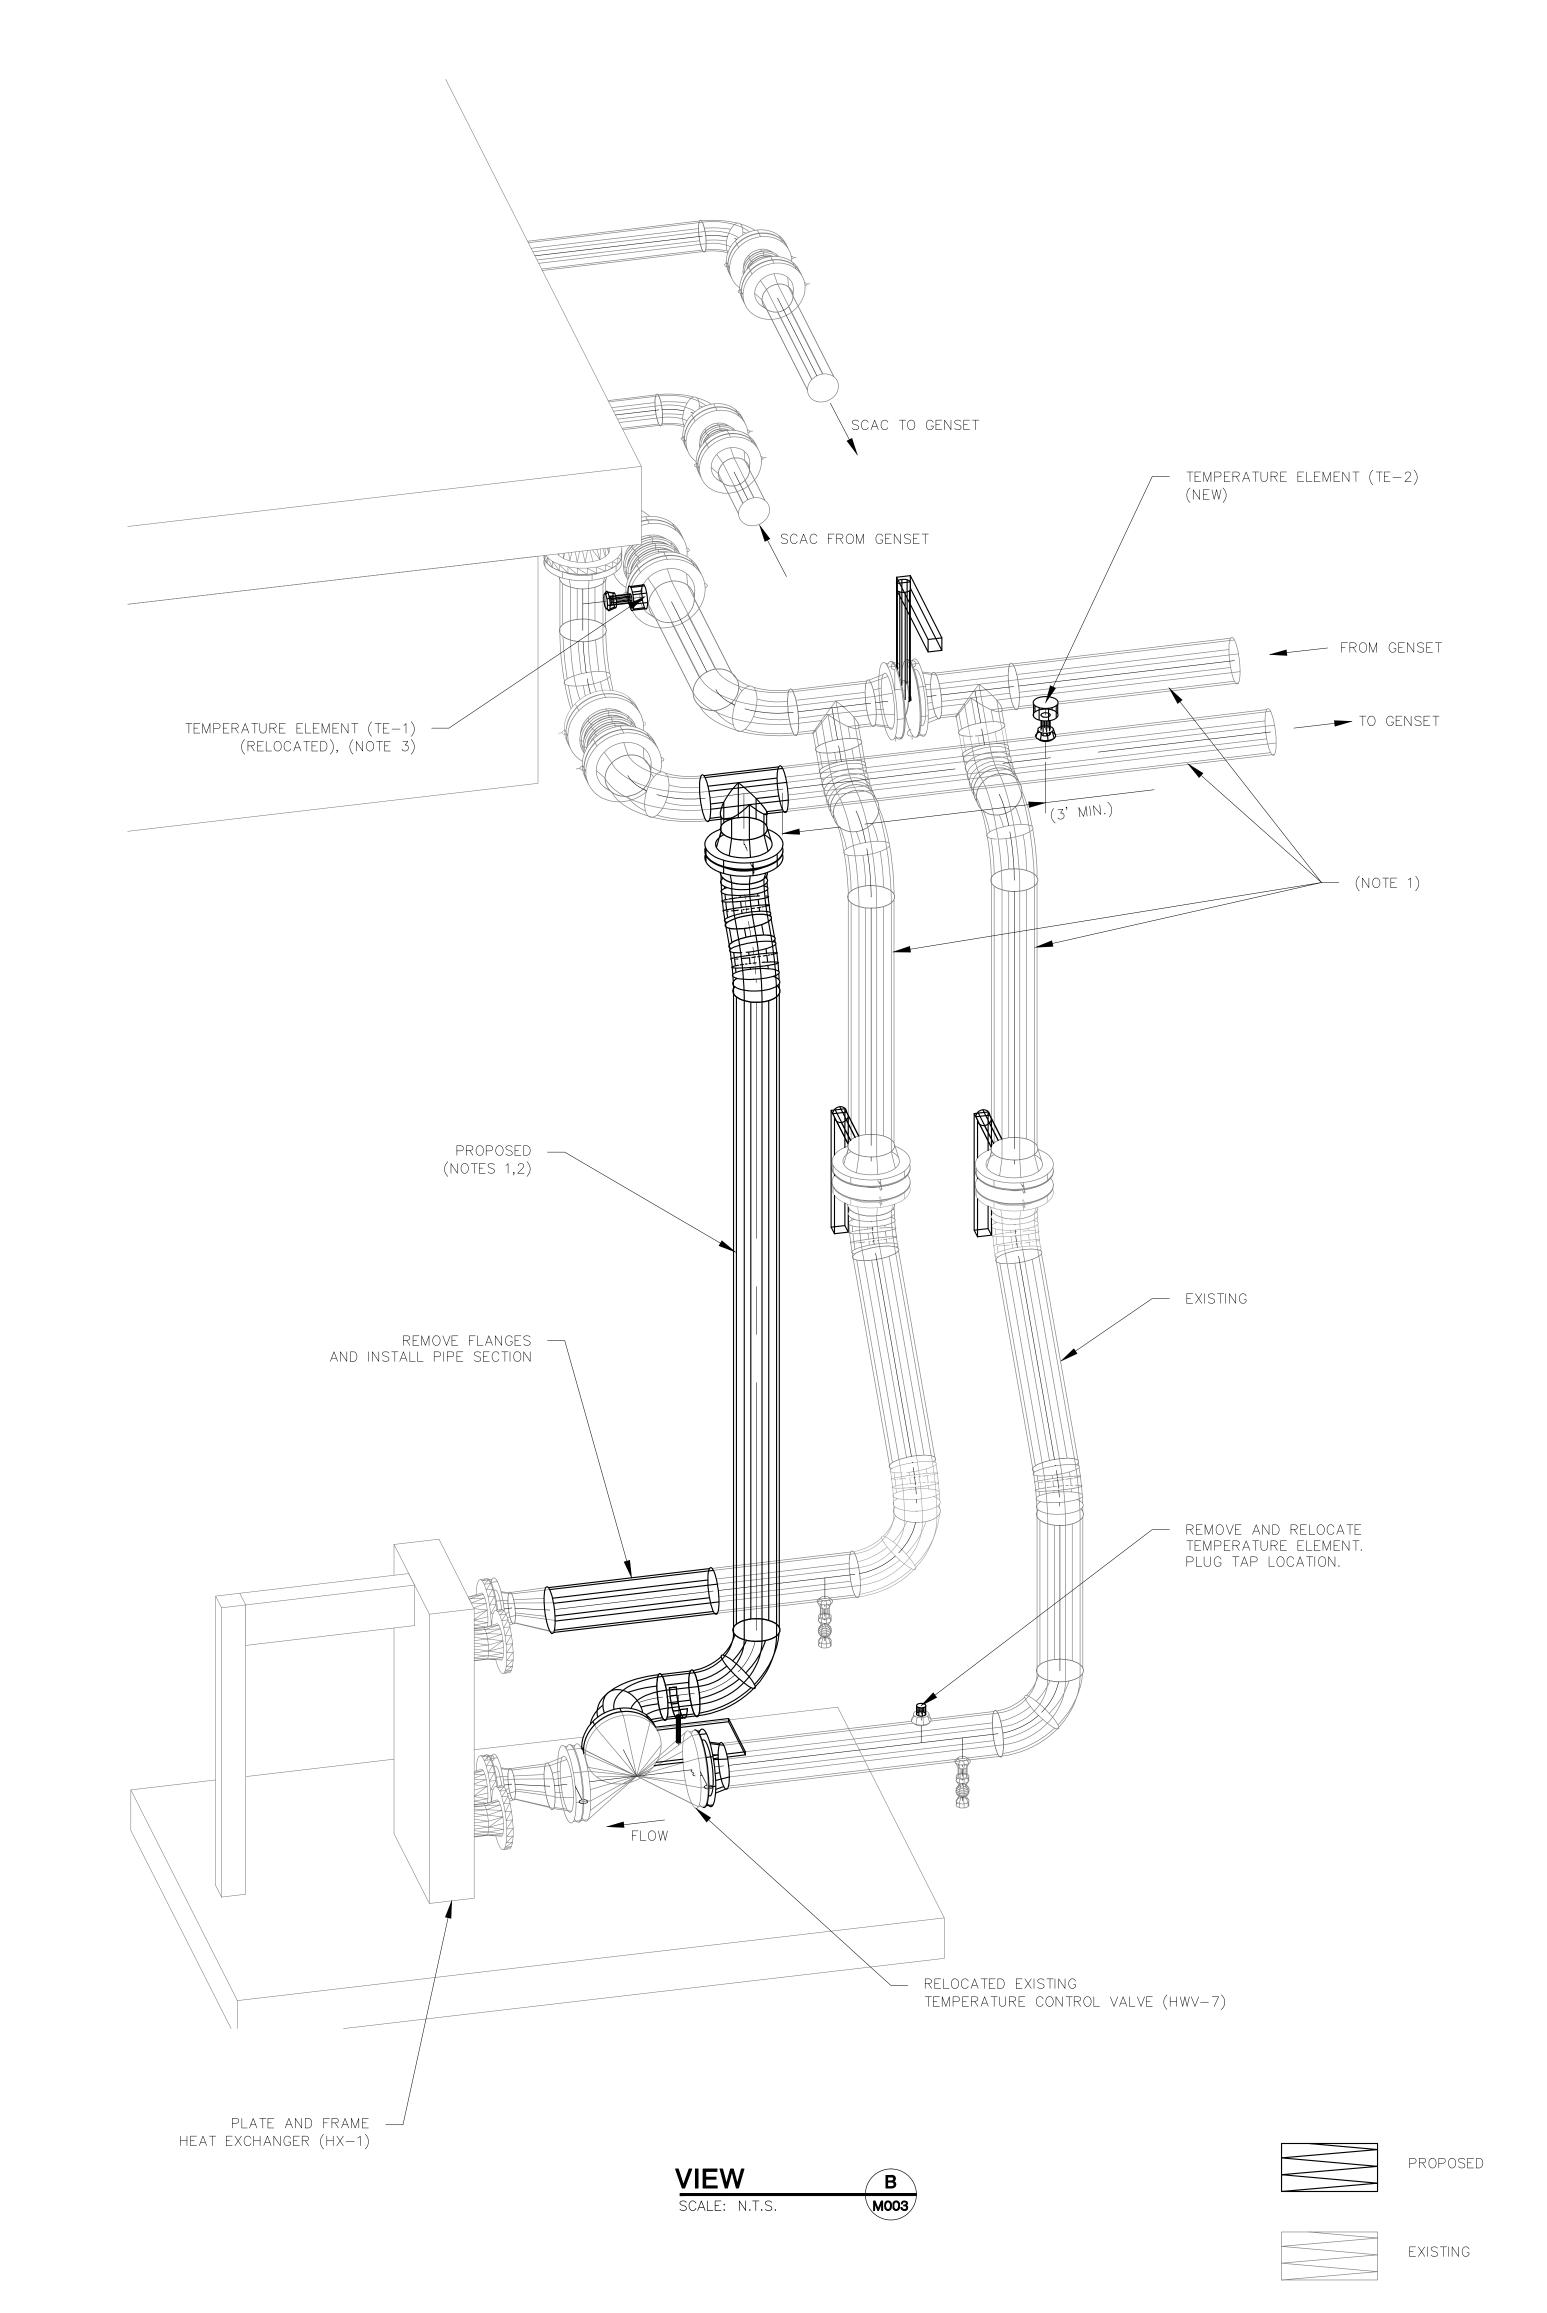

1. INSULATE ALL PIPE TO MATCH EXISTING.

CONDUIT TO BE RIGID GALVANIZED STEEL.

2. PIPE AND FITTINGS TO BE SCH 40 CS. MATCH EXISTING PIPE DIAMETER. 3. FIELD VERIFY THERMOCOUPLE EXTENSION WIRE (TEW), MATCH EXISTING.
PROVIDE CONTINUOUS LENGTH OF TEW FROM TEMPERATURE ELEMENT TO VALVE.

SCS ENGINEERS 2830 DAIRY DRIVE MADISON, WI 53718-6751 PHONE: (608) 224-2830

CONSTRUCTION AND **DEMOLITION WASTE** RECYCLING FACILITY 7102 US HWY 12/18 MADISON, WISCONSIN

DANE COUNTY DEPARTMENT OF PUBLIC WORKS SOLID WASTE DIVISION 1919 ALLIANT ENERGY CENTER WAY MADISON, WI 53713

PROCESS AND CIVIL ENGINEER:
SCS ENGINEERS
2830 DAIRY DRIVE
MADISON, WI 53718-6751

(608) 224-2830

ARCHITECT: DORSCHNER ASSOCIATES, INC. 849 E. WASHINGTON AVE., SUITE 112 MADISON, WI 53703

STRUCTURAL ENGINEER:
PIERCE ENGINEERS, INC.
10 WEST MIFFLIN ST., SUITE 205
MADISON, WI 53703

MECHANICAL, ELECTRIC, PLUMBING DESIGN:

JDR ENGINEERING, INC. 5525 NOBEL DRIVE, SUITE 110 MADISON, WI 53711


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01/22/15 CHECKED BY: APPROVED BY:

BID DOCUMENTS ISSUED 04/28/15

JACKET WATER AND

SCAC PIPING SHEET NUMBER M003

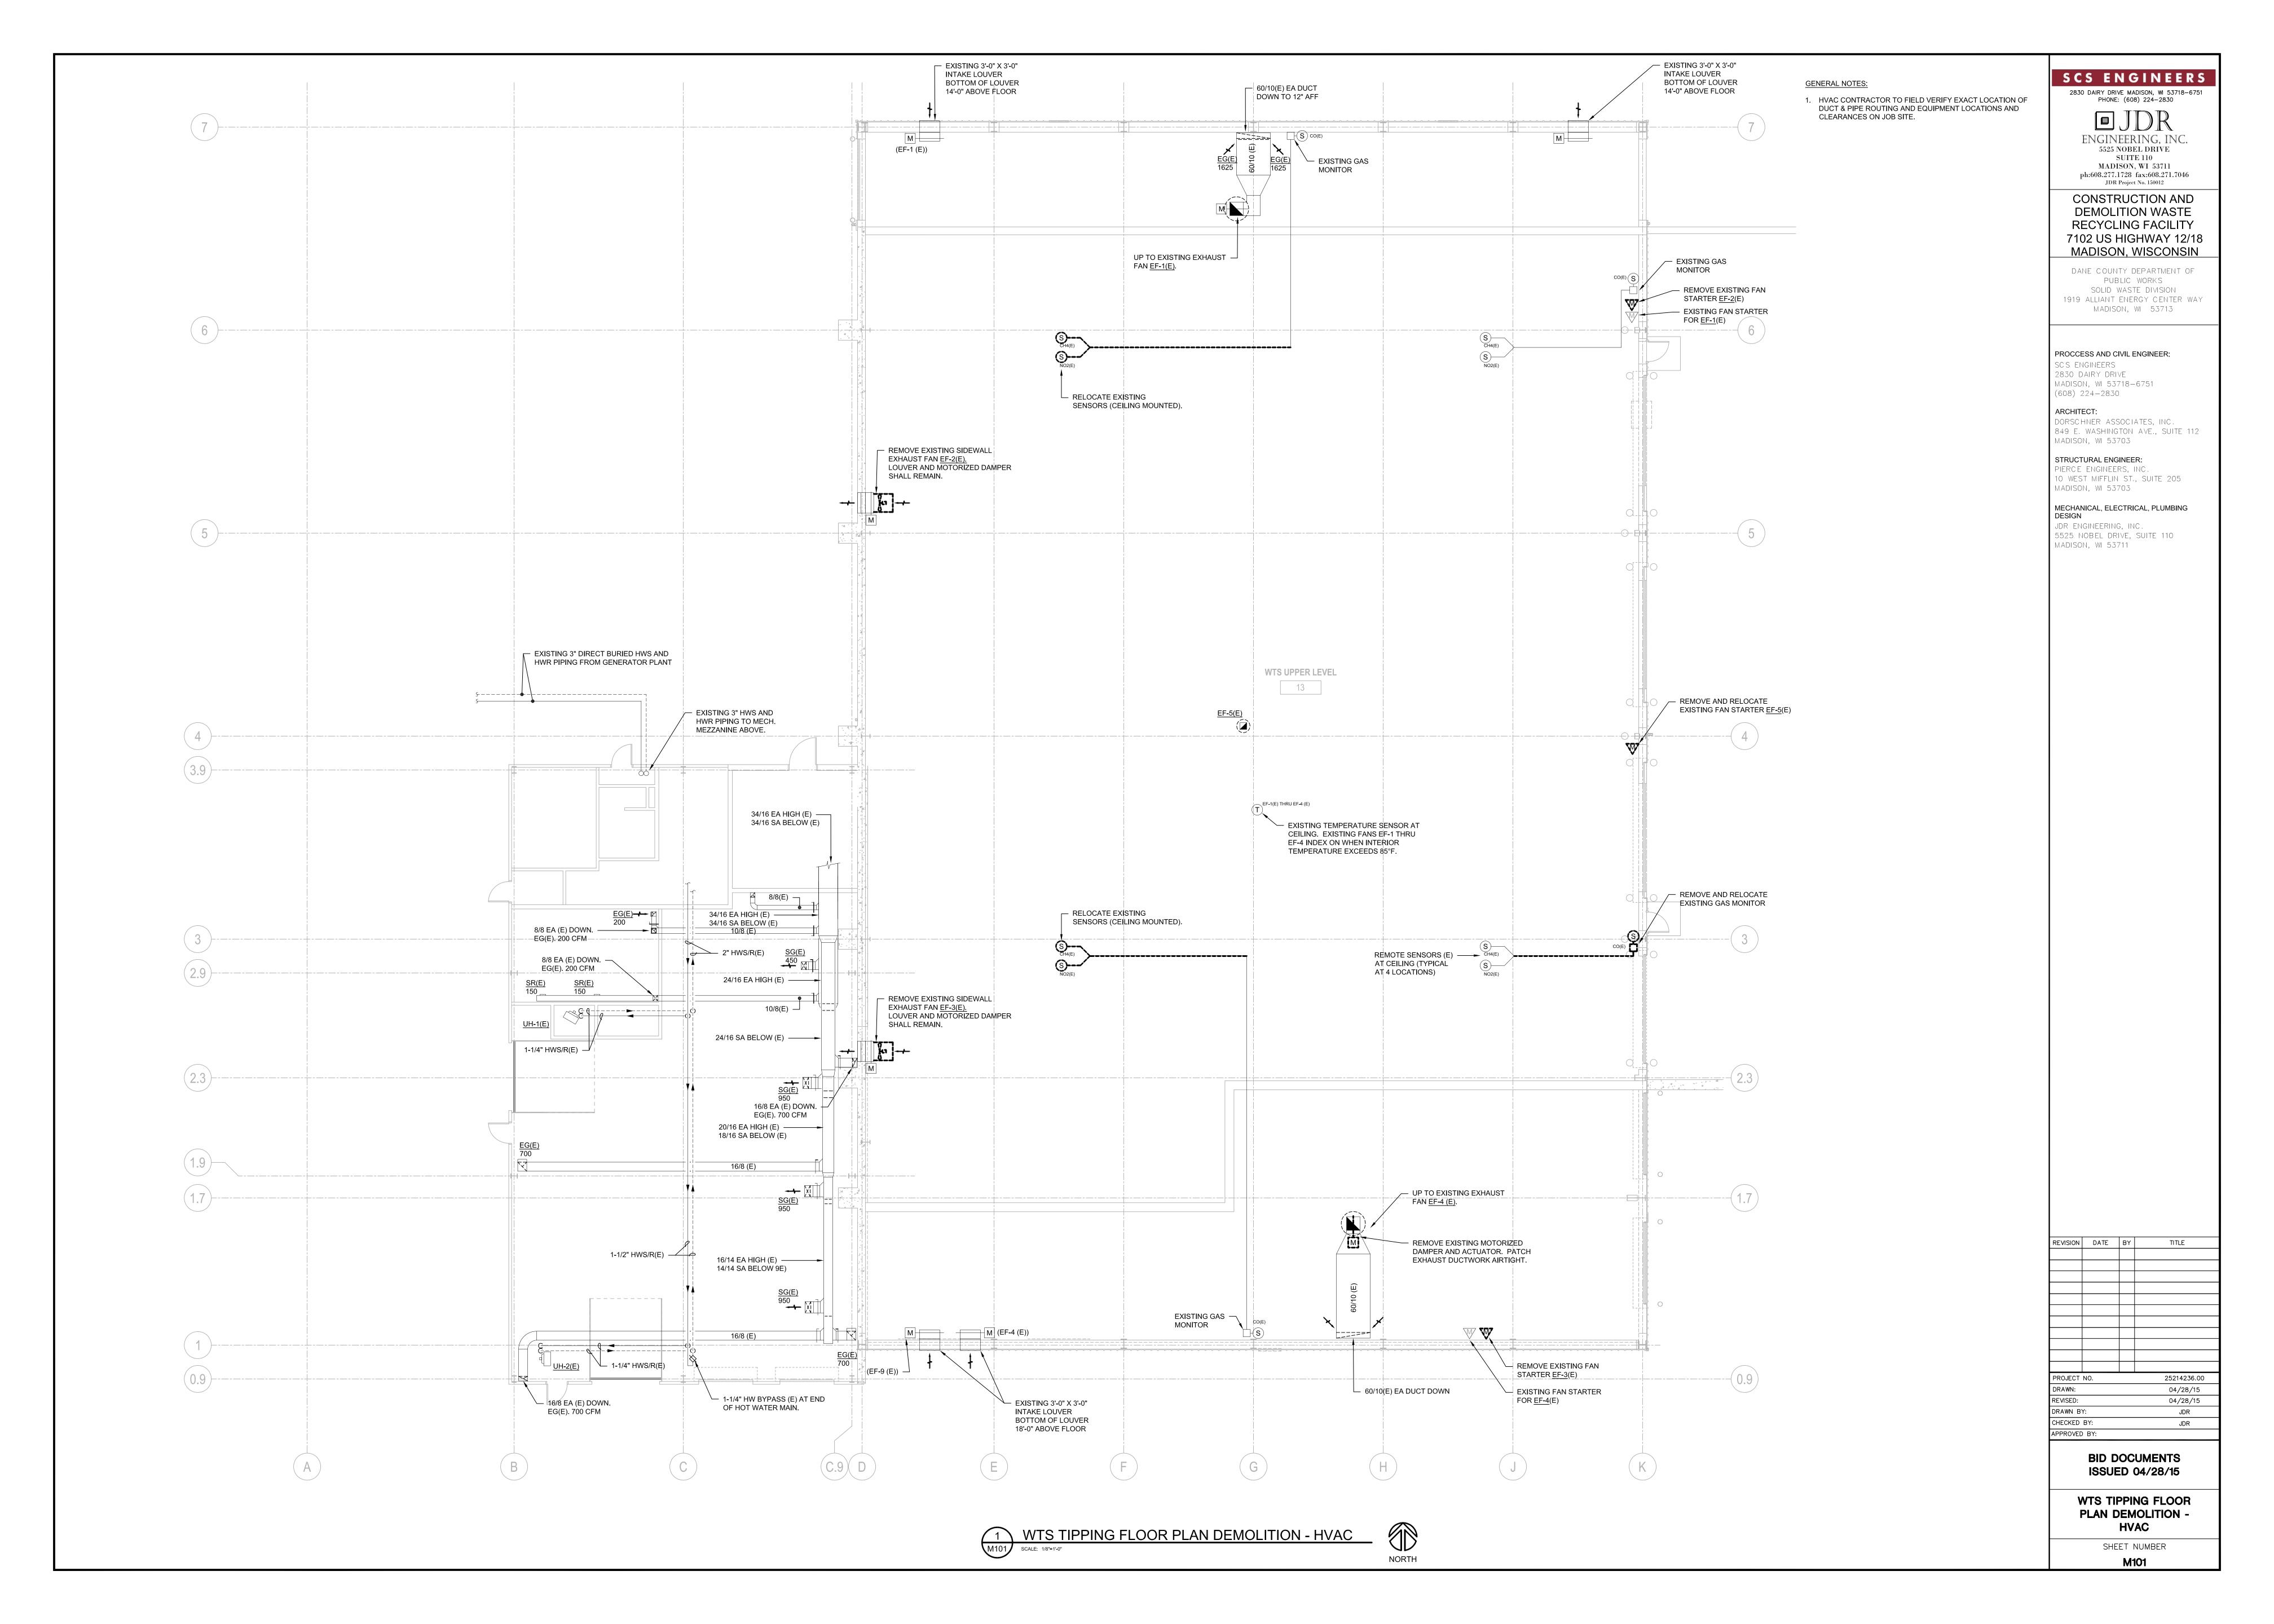

GENERAL NOTES:

- HVAC CONTRACTOR TO FIELD VERIFY EXACT LOCATION OF DUCT & PIPE ROUTING AND EQUIPMENT LOCATIONS AND CLEARANCES ON JOB SITE.
 KEYED NOTES:
 - CONNECT NEW 8" SUPPLY AIR DUCT INTO EXISTING 14/14 SUPPLY AIR DUCT. PATCH INSULATION AT CONNECTION POINT TO PROVIDE CONTINUOUS INSULATION AND VAPOR BARRIER.
- 2 CONNECT NEW 8" EXHAUST AIR DUCT INTO EXISTING 16/14 EXHAUST AIR DUCT.
- (3) LOCATION FOR TIE INTO EXISTING HOT WATER SYSTEM TO SERVE NEW UNISEX TOILET ROOMS HOT WATER UNIT HEATERS.

SCS ENGINEERS

2830 DAIRY DRIVE MADISON, WI 53718-6751 PHONE: (608) 224-2830



CONSTRUCTION AND
DEMOLITION WASTE
RECYCLING FACILITY
7102 US HIGHWAY 12/18

MADISON, WISCONSIN

MADISON, WI 53711 ph:608.277.1728 fax:608.271.7046

DANE COUNTY DEPARTMENT OF
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SOLID WASTE DIVISION
1919 ALLIANT ENERGY CENTER WAY
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PROCCESS AND CIVIL ENGINEER:

SCS ENGINEERS 2830 DAIRY DRIVE MADISON, WI 53718-6751 (608) 224-2830

ARCHITECT:

DORSCHNER ASSOCIATES, INC.

849 E. WASHINGTON AVE., SUITE 112


MADISON, WI 53703

STRUCTURAL ENGINEER:
PIERCE ENGINEERS, INC.
10 WEST MIFFLIN ST., SUITE 205

MECHANICAL, ELECTRICAL, PLUMBING DESIGN

JDR ENGINEERING, INC. 5525 NOBEL DRIVE, SUITE 110 MADISON, WI 53711

MADISON, WI 53703

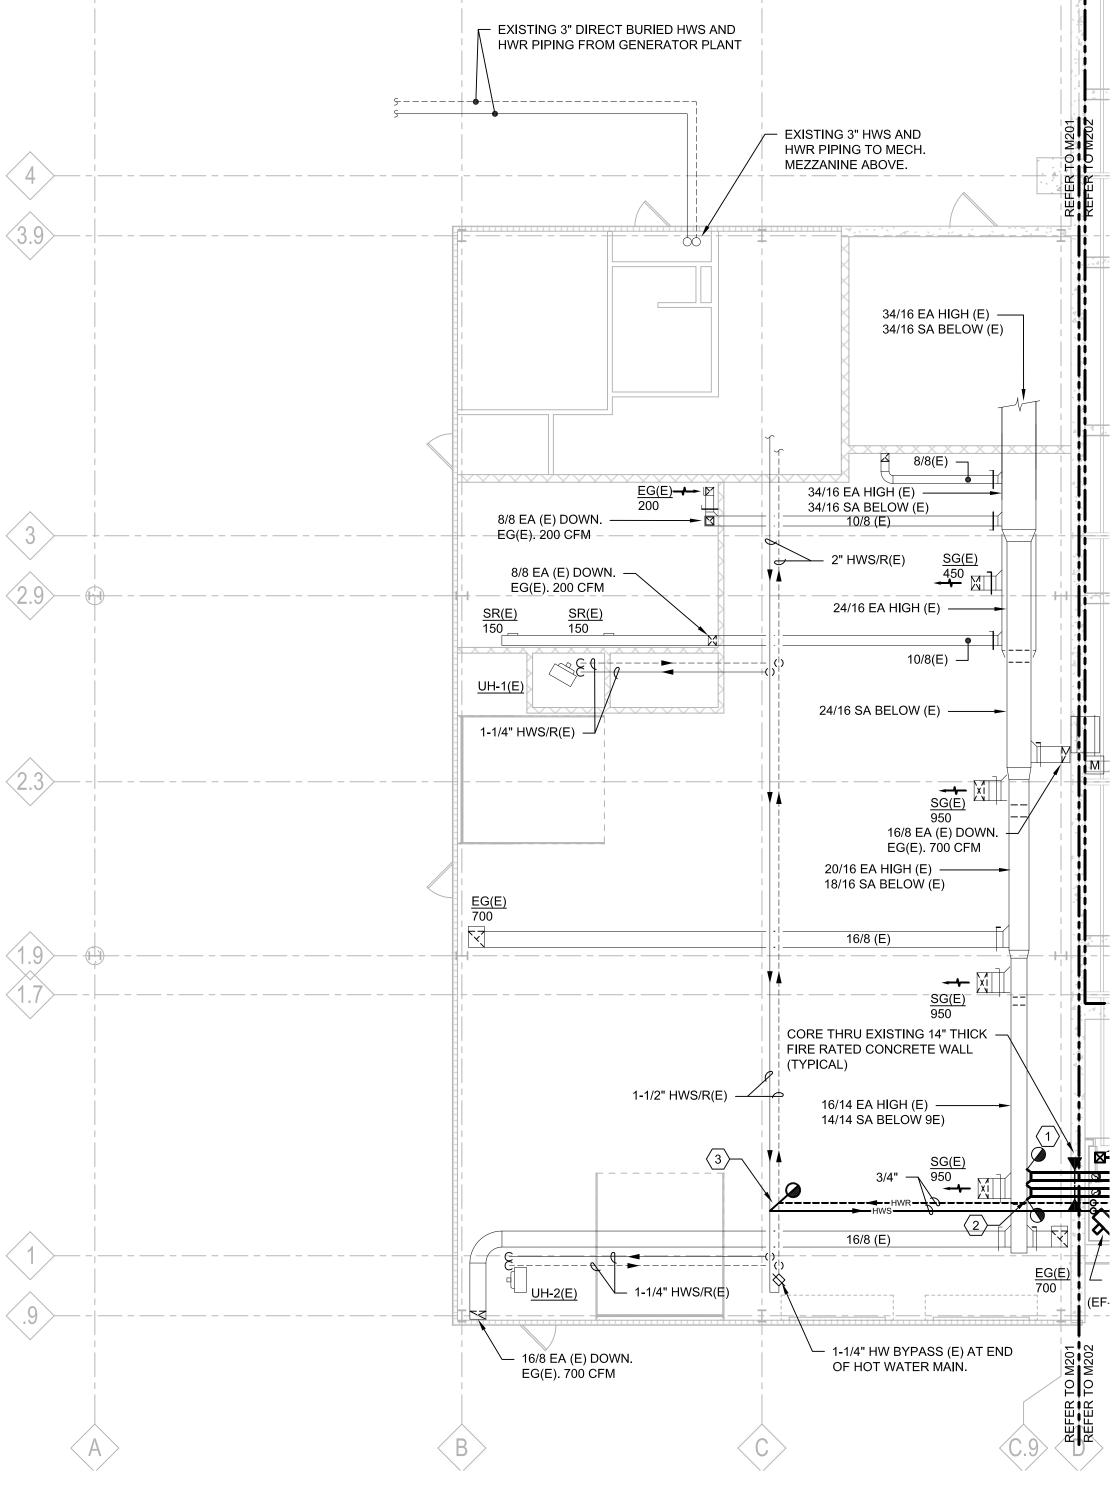

1 CLEAN SWEEP BUILDING - MAIN LEVEL - HVAC

M201 SCALE: 1/8"=1"-0"



REVISION	DATE	BY	TITLE
PROJECT N	١٥.		25214236.00
DRAWN:			04/28/15

DRAWN: 04/28/15

REVISED: 04/28/15

DRAWN BY: JDR


CHECKED BY: JDR

APPROVED BY:

BID DOCUMENTS ISSUED 04/28/15

CLEAN SWEEP BUILDING - MAIN LEVEL - HVAC

SHEET NUMBER **M201**

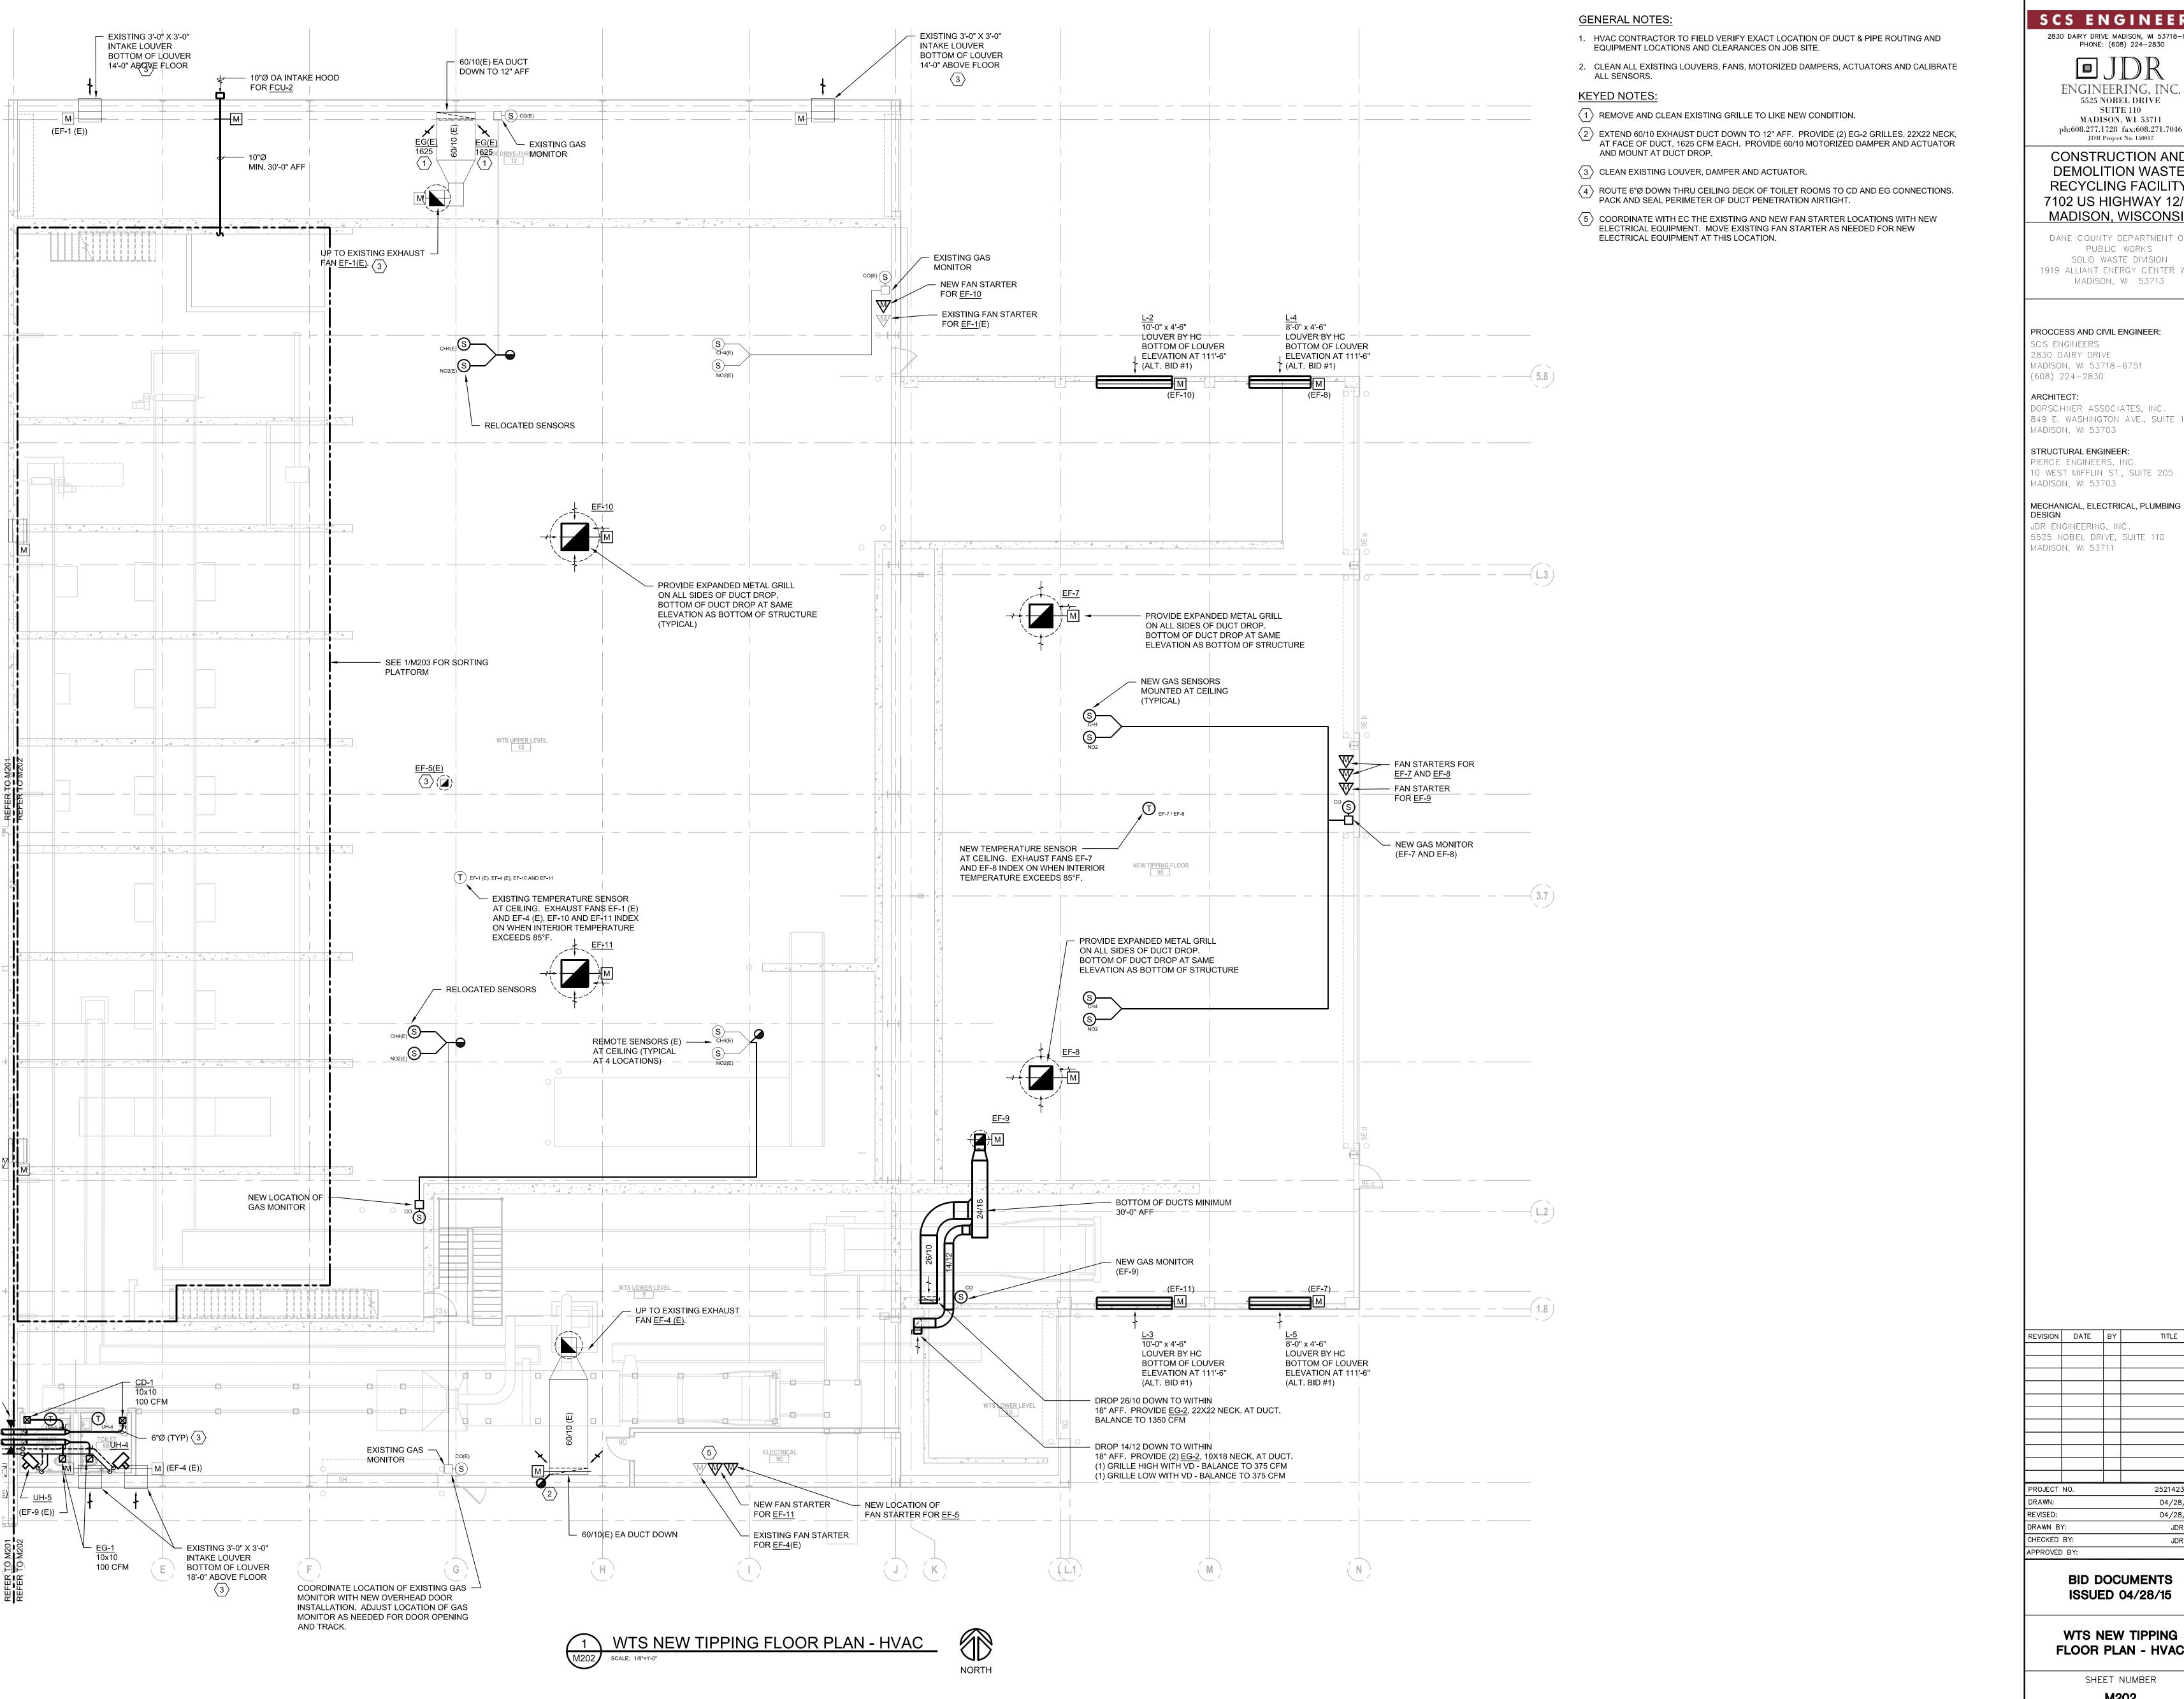

2830 DAIRY DRIVE MADISON, WI 53718-6751 PHONE: (608) 224-2830

ph:608.277.1728 fax:608.271.7046

ENGINEERING, INC. 5525 NOBEL DRIVE SUITE 110 MADISON, WI 53711

JDR Project No. 150012 CONSTRUCTION AND **DEMOLITION WASTE** RECYCLING FACILITY 7102 US HIGHWAY 12/18 MADISON, WISCONSIN

DANE COUNTY DEPARTMENT OF PUBLIC WORKS SOLID WASTE DIVISION 1919 ALLIANT ENERGY CENTER WAY MADISON, WI 53713

PROCCESS AND CIVIL ENGINEER:

SCS ENGINEERS 2830 DAIRY DRIVE MADISON, WI 53718-6751 (608) 224-2830

ARCHITECT: DORSCHNER ASSOCIATES, INC. 849 E. WASHINGTON AVE., SUITE 112 MADISON, WI 53703

PIERCE ENGINEERS, INC. O WEST MIFFLIN ST., SUITE 205 MADISON, WI 53703

DESIGN JDR ENGINEERING, INC. 5525 NOBEL DRIVE, SUITE 110 MADISON, WI 53711


REVISION DATE BY TITLE

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> **BID DOCUMENTS** ISSUED 04/28/15


WTS NEW TIPPING FLOOR PLAN - HVAC

> SHEET NUMBER M202

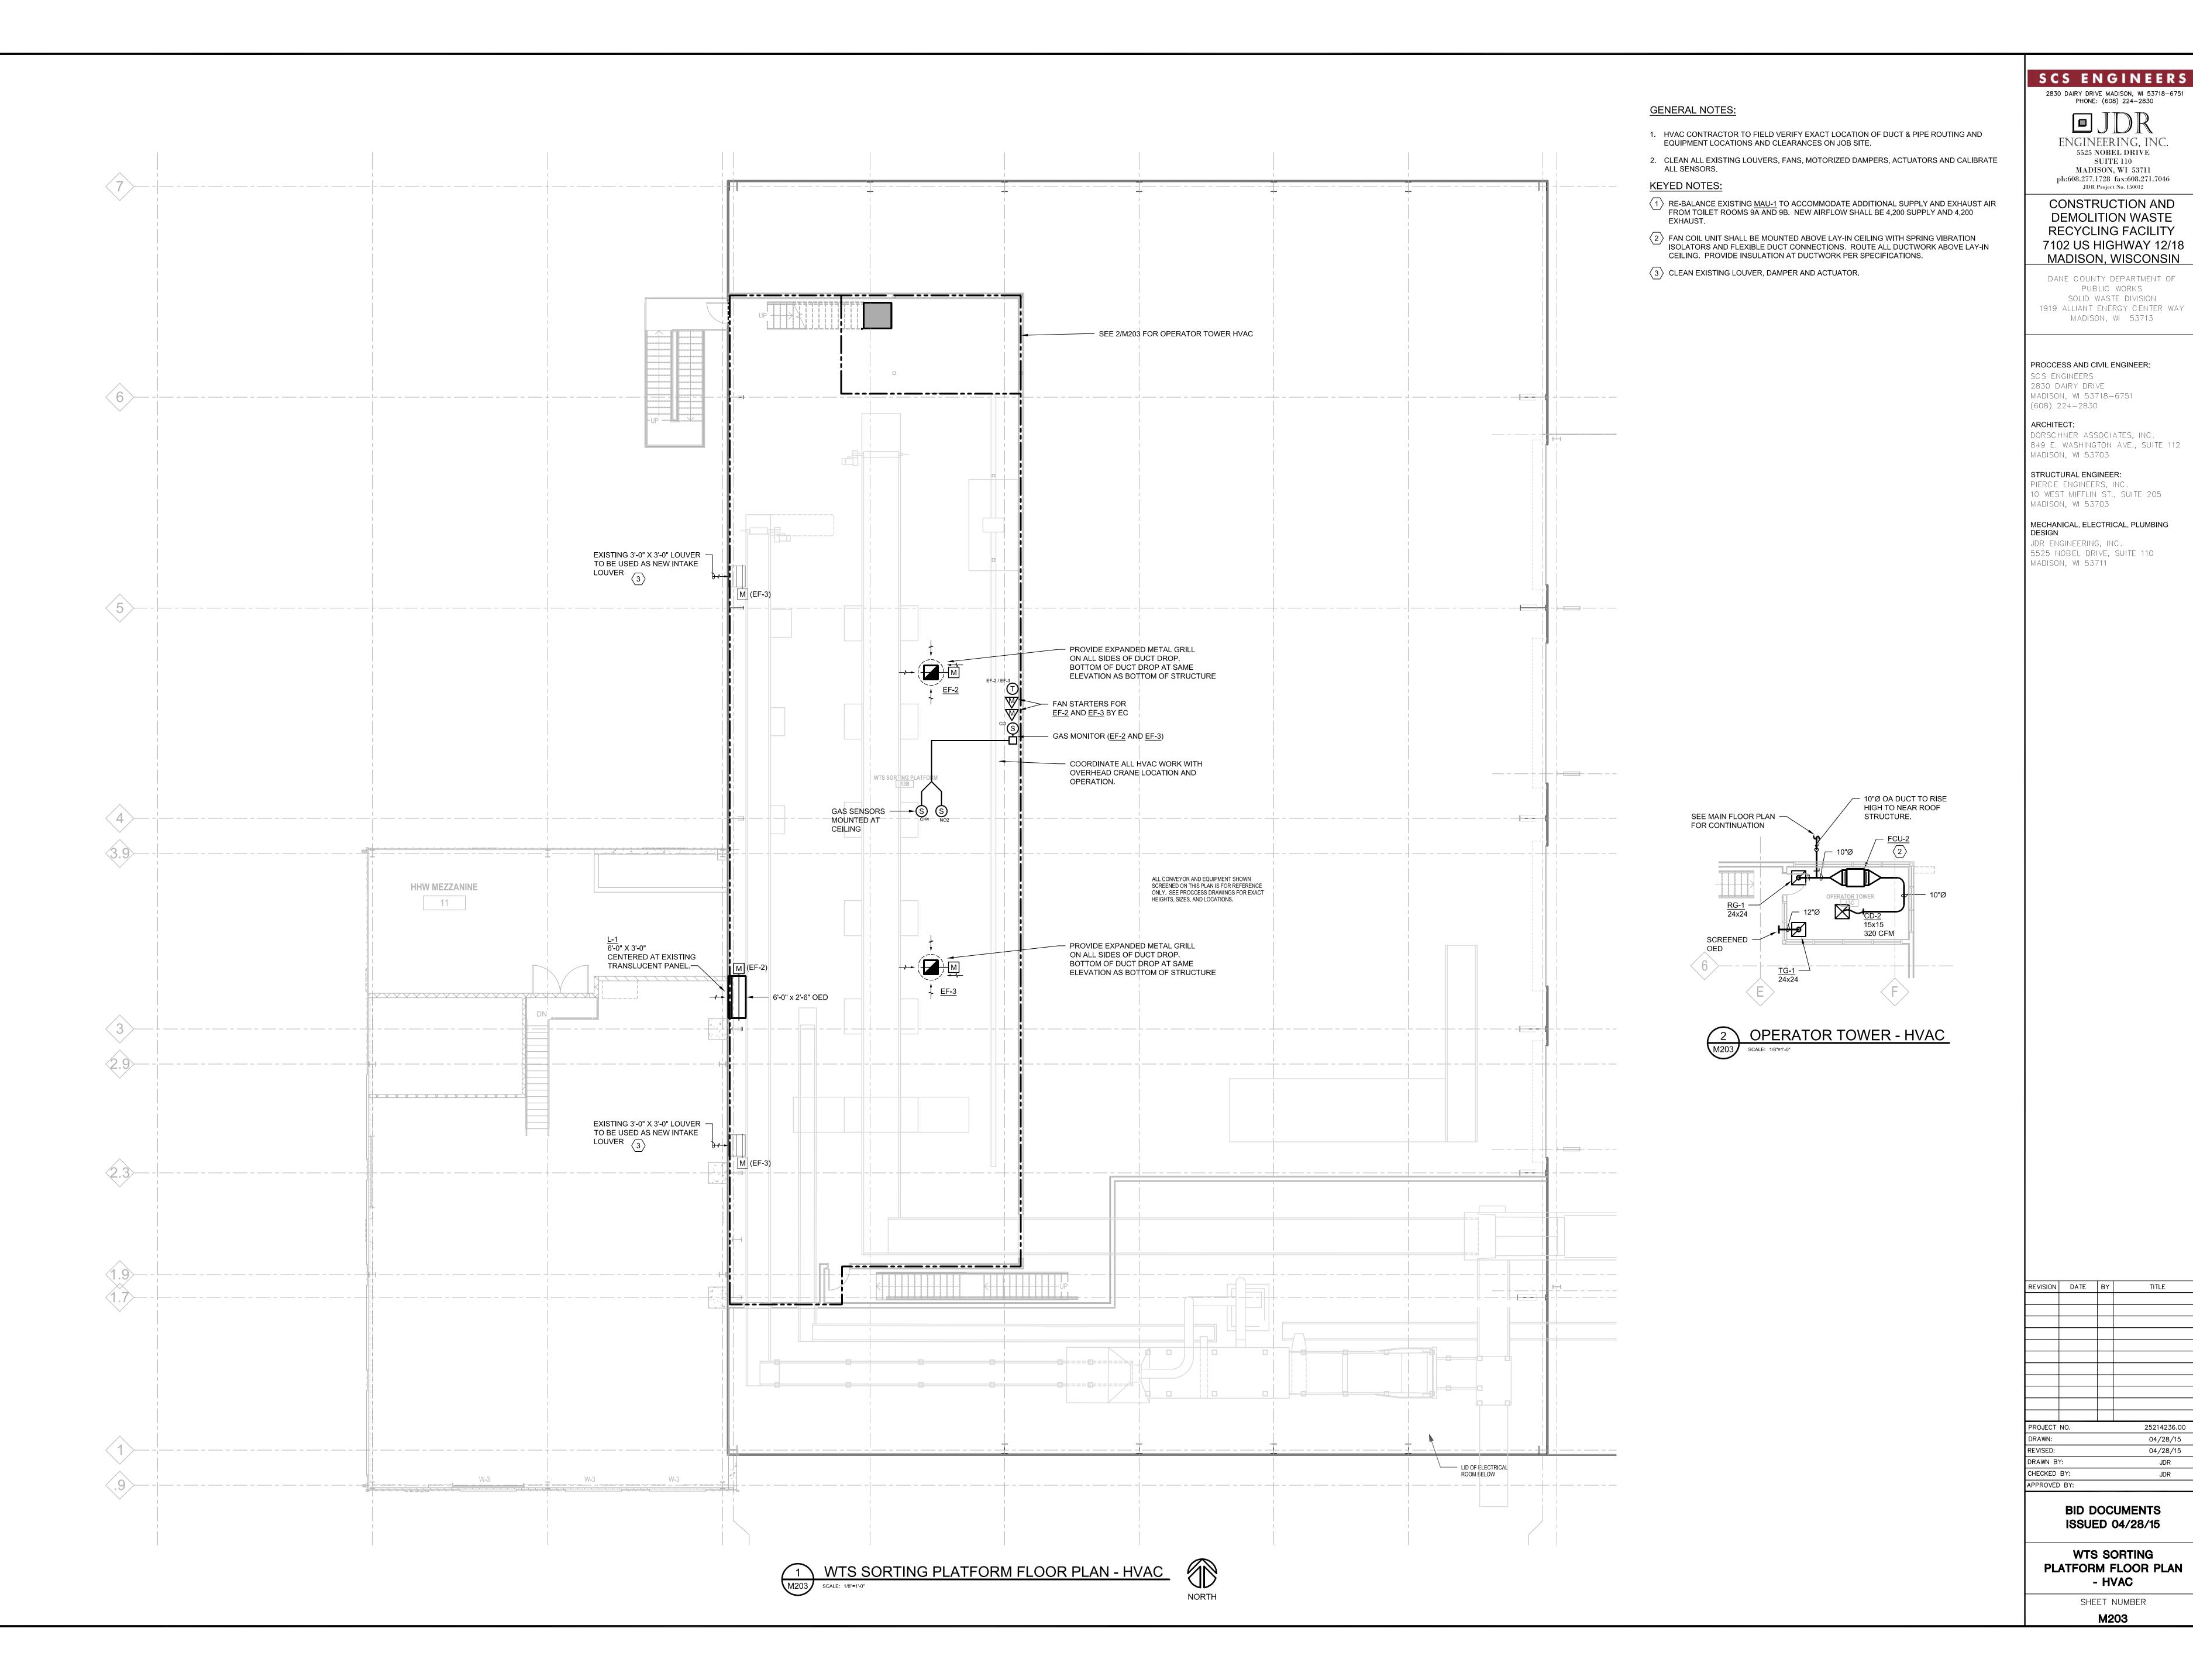

TITLE

25214236.00 04/28/15 04/28/15

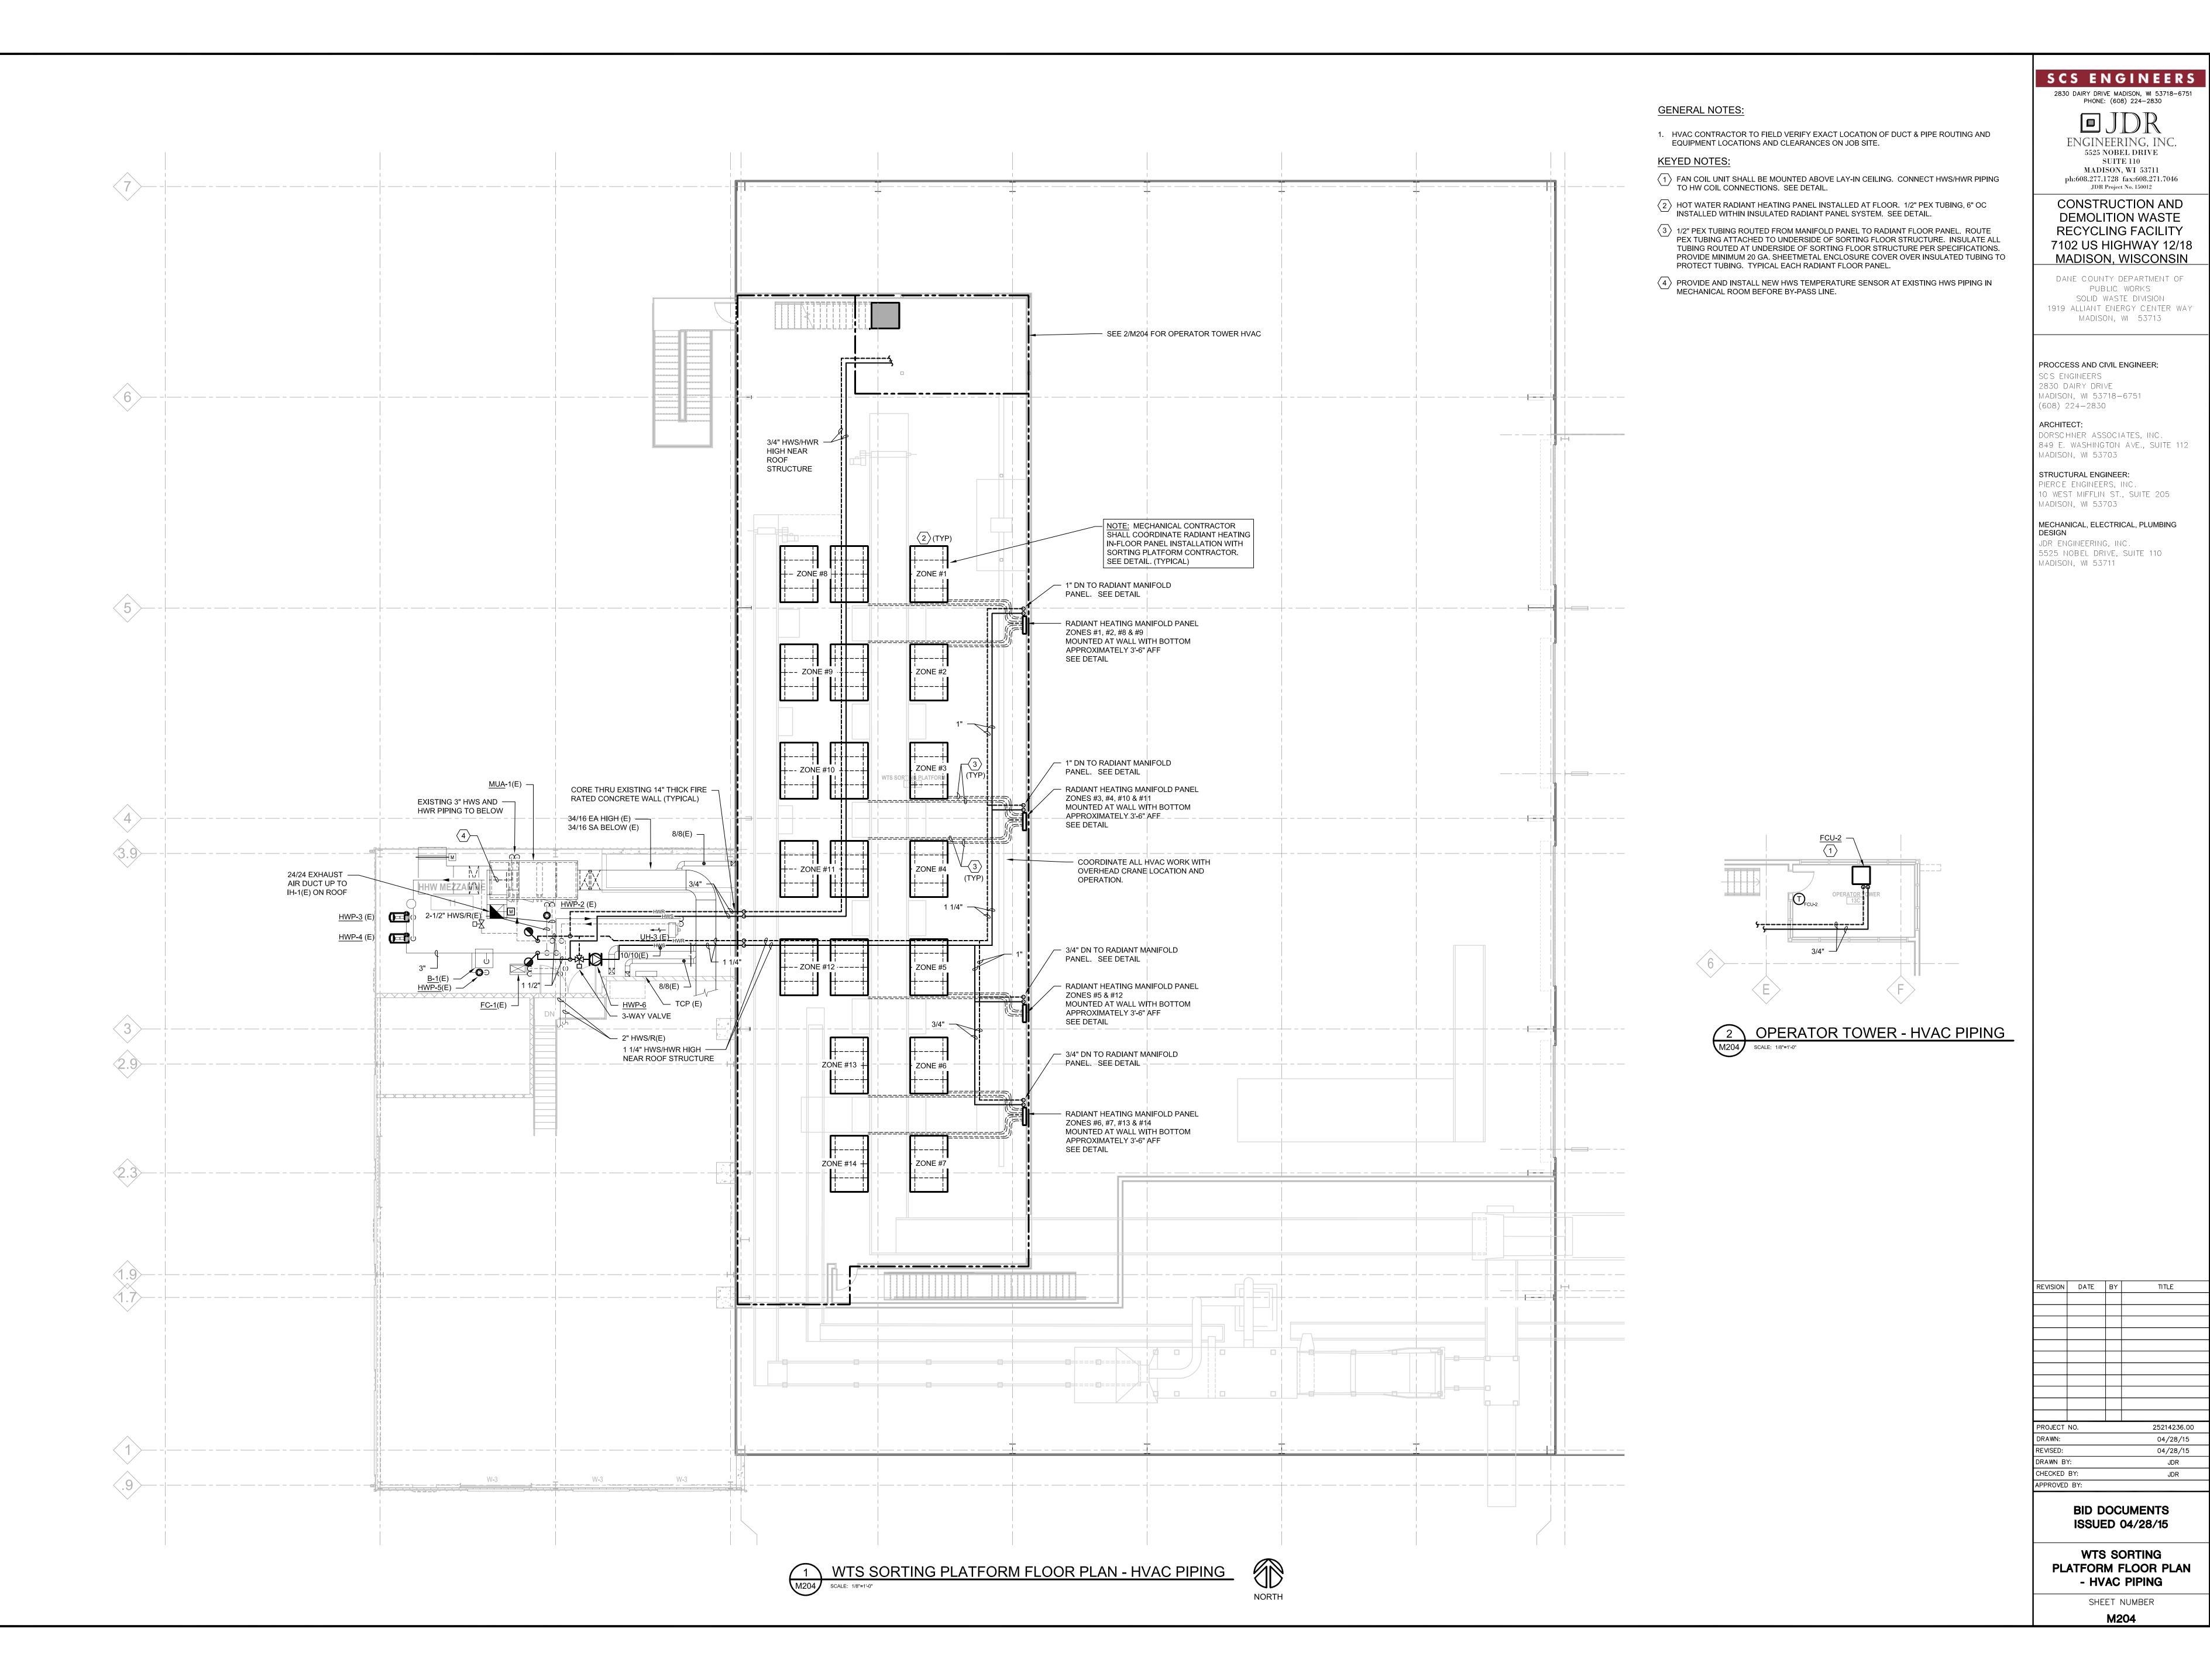

FAN COIL UNIT SCHEDULE MANUFACTURER **ENVIRO-TEC** MODEL NO. SERVICE CONTROL TOWER LOCATION CONTROL TOWER HORIZ. DUCTED SUPPLY CFM 320 MIN. OA CFM 25 EXT. SP (IN WC) 0.50 SUPPLY FAN HP 1/6 VOLTAGE/PHASE 208 / 1 SUPPLY FAN TYPE SUPPLY FAN SPEED MED. CAPACITY (MBH) 22.0 EAT (°F) DB/WB 45.0 LAT (°F) DB/WB 115.0 EWT (°F) LWT (°F) 2.5 MAX. FACE VELOCITY (FPM)

KEYED NOTES:

REMARKS

UNIT WEIGHT (LBS)

MAX. AIR PD (FT)

MIN. ROWS/MAX FINS

1 HOT WATER PERFORMANCE BASED ON 50% ETHYLENE GLYCOL.

0.10

2 / 10

80.0

PUMP SC	CHED	ULE
UNIT NO.	HWP-6	HWP-3 (E) & 4 (E)
MANUFACTURER	B&G	TACO
MODEL NO.	PL-55	FI 1506
LOCATION	MECH ROOM	MECH ROOM
SERVICE	SORTING FLOOR RADIANT	BUILDING HEATING LOOP
TYPE	INLINE	BASE MTD
CAPACITY GPM	9.0	80.0
PRESSURE HEAD (FT)	35.0	35.0
SHUT-OFF PRESSURE HEAD (FT)	-	-
MIN. NPSH REQUIRED (FT)	-	-
INLET/OUTLET (IN)	1.5 / 1.5	-
IMPELLER DIAMETER	3.8	6.25
MIN. EFF. %	-	-
RPM	3250	1760
ВНР	-	-
HP	0.40	1.5
VOLTAGE/PHASE	208 / 1	-
VFD	NO	YES (E)
UNIT WEIGHT (LBS)	-	-
REMARKS	1	2

KEYED NOTES:

- 1 PUMP PERFORMANCE BASED ON 50% ETHYLENE GLYCOL.
- EXISTING PUMPS (100% STAND-BY). REBALANCE EXISTING PUMPS TO LISTED FLOW.

HOT WATER UNIT HEATER SCHEDULE SERVICE TOILET ROOMS TOILET ROOMS MANUFACTURER VULCAN MODEL NO. HV-108A HORIZONTAL HORIZONTAL THROW (FT) AIRFLOW (CFM) 210 60.0 60.0 CAPACITY (MBH) 4.5 0.50 0.50 160 16.0 WATTS 16.0 WATTS VOLTAGE/PHASE 120 / 1

 $\langle 1 \rangle \langle 2 \rangle$

 $\langle 1 \rangle \langle 2 \rangle$

KEYED NOTES:

FAN SPEED

REMARKS

- 1 HOT WATER PERFORMANCE BASED ON 50% ETHYLENE GLYCOL.
- PROVIDE OPTIONAL MOTOR SPEED CONTROLLER MOUNTED TO UNIT. SET ON MED SPEED. WIRED BY EC.

				F	FANS	SCHE	DULE	<u> </u>				
SF = SUP RF = RET		EXHAUST FAN TRANSFER FAN	CF = CEILING (DES	STRATIFICATION) F.								
UNIT NO.		EF-1(E)	EF-2	EF-3	EF-4(E)	EF-5(E)	EF-6(E)	EF-7	EF-8	EF- 9	EF-10	EF-11
LOCATIO	N	ROOF	ROOF	ROOF	ROOF	ROOF	ROOF	ROOF	ROOF	ROOF	ROOF	ROOF
MANUFAC	CTURER	EXIST	GREENHECK	GREENHECK	EXIST	EXIST	EXIST	GREENHECK	GREENHECK	GREENHECK	GREENHECK	GREENHECK
MODEL N	O.	EXIST	CUBE-240-15	CUBE-240-15	EXIST	EXIST	EXIST	CUBE-240-15	CUBE-360-30	CUBE-161-5	CUBE-420-50	CUBE-420-50
SERVICE		TRUCK DRIVE THRU	SORTING PLATFORM	SORTING PLATFORM	WTS LOWER LEVEL	WTS UPPER LEVEL	MECH ROOM	NEW TIPPING FLOOR	NEW TIPPING FLOOR	NEW WTS LOWER ELVEL	WTS UPPER LEVEL	WTS UPPER LEVEL
FAN TYPE	Ξ	PRV	PRV	PRV	PRV	PRV	PRV	PRV	PRV	PRV	PRV	PRV
ARRANGI	EMENT	-	UPBLAST	UPBLAST	-	-	-	UPBLAST	UPBLAST	UPBLAST	UPBLAST	UPBLAST
DESIGN (CFM	3250	6000	6000	3250	1300	400	10,500	10,500	2100	15,500	15,500
EXT. SP (IN WC)	-	0.50	0.50	-	-	-	0.50	0.50	0.50	0.50	0.50
FAN WHE	EL TYPE	-	ВІ	ВІ	-	-	-	BI	BI	BI	BI	BI
FAN DIAM	1ETER	-	24"	24"	-	-	-	36"	36"	16"	42"	42"
APPROXI	MATE FAN RPM	-	793	793	-	-	-	483	483	969	438	438
ВНР		-	1.30	1.30	-	-	-	1.82	1.82	0.38	3.0	3.0
MOTOR H	IP	-	1.5	1.5	-	-	-	3.0	3.0	0.50	5.0	5.0
VOLTS/PH	HASE	-	460/3	460/3	-	-	-	460/3	460/3	460/3	460/3	460/3
DRIVE		-	BELT	BELT	-	-	-	BELT	BELT	BELT	BELT	BELT
TWO SPE	ED	-	-	-	-	-	-	-	-	-	-	-
VFD		-	-	-	-	-	-	-	-	-	-	-
MAX. SON	NES	-	17.0	17.0	-	-	-	17.0	17.0	11.0	15.0	15.0
	1	-	79	79	-	-	-	84	84	72	88	88
\	2	-	88	88	-	-	-	91	91	78	84	84
LET ATA R B)	3	-	82	82	-	-	-	79	79	74	78	78
MAX. FAN INLET AIR SOUND DATA SOUND POWER BY OCTAVE BAND (dB)	4	-	74	74	-	-	-	70	70	71	73	73
K. FA SOUI ND P! NVE E	5	-	73	73	-	-	-	69	69	67	69	69
MAX AIR S	6	-	68	68	-	-	-	64	64	64	65	65
100	7	-	60	60	-	-	-	56	56	59	57	57
	8	-	55	55	-	-	-	52	52	55	52	52

KEYED NOTES:

REMARKS

PROVIDE FAN WITH EXPLOSION PROOF MOTOR, ALL ALUMINUM WHEEL AND RUB RING, STAINLESS STEEL SHAFT AND STAINLESS STEEL FASTENERS.

		AIR D	EVICE	SCHE	EDULE	•				
EG - 1 (3) 12x12/10"Ø THROW 300 THAN N	NUMBER W (IF OTHER SG = SUPPLY GRILLE LD = LINEAR DIFFUSER (SUPPLY) NORMAL) RG = RETURN GRILLE CD = CEILING DIFFUSER (SUPPLY) SIZE (SQ/RO) EG = EXHAUST GRILLE TG = TRANSFER GRILLE									
UNIT NO.	CD-1	CD-2	RG-1	EG-1	EG-2	TG-1				
SERVICE	SUPPLY	SUPPLY	RETURN	EXHAUST	EXHAUST	TRANSFER				
MANUFACTURER	TITUS	TITUS	TITUS	TITUS	TITUS	TITUS				
MODEL NO.	TDCA-AA	TDCA-AA	350FL	350FL	60FL	350FL				
FACE STYLE	LOUVERED	LOUVERED	LOUVERED	LOUVERED	HEAVY DUTY	LOUVERED				
PATTERN	SEE PLANS	SEE PLANS	SINGLE DEFLECTION	SINGLE DEFLECTION	SINGLE DEFLECTION	SINGLE DEFLECTION				
FINISH	STANDARD	STANDARD	STANDARD	STANDARD	STANDARD	STANDARD				
MATERIAL	ALUMINUM	ALUMINUM	ALUMINUM	ALUMINUM	ALUMINUM	ALUMINUM				
SIZE (FACE/NECK)	SEE PLANS	SEE PLANS	SEE PLANS	SEE PLANS	SEE PLANS	SEE PLANS				
CFM RANGE	SEE PLANS	SEE PLANS	SEE PLANS	SEE PLANS	SEE PLANS	SEE PLANS				
MOUNTING	SURFACE	LAY-IN	LAY-IN	SURFACE	SURFACE	SURFACE				
DAMPER	NO	NO	NO	NO	NO	NO				
REMARKS	1	1								

GENERAL NOTES

- CONTRACTOR SHALL VERIFY MOUNTING SURFACE / FRAME REQUIREMENTS.
 BRANCH DUCT SIZE TO DIFFUSER SHALL BE THE NECK SIZE OF THE DIFFUSER UNLESS NOTED OTHERWISE.
- SEE SPECIFICATION FOR GRILLE, REGISTER, AND DIFFUSER FINISHES.
 MAXIMUM STATIC PRESSURE DROP THROUGH GRILLE, REGISTER, OR DIFFUSER SHALL NOT EXCEED 0.1".
- 5. MAXIMUM NC LEVELS FOR GRILLES, REGISTERS, OR DIFFUSERS SHALL NOT EXCEED 25.6. UNLESS THROW IS NOTED OTHERWISE, ALL DIFFUSERS SHALL BE 4-WAY THROW.

LOU	LOUVER SCHEDULE											
UNIT NO.	L-1	L-2 AND L-3	L-4 AND L-5									
MANUFACTURER	GREENHECK	GREENHECK	GREENHECK									
MODEL NO.	ESD-635	ESD-635	ESD-635									
SERVICE	SORTING AREA	SORTING AREA	SORTING AREA									
AIRFLOW (CFM)	6,000	15,500	10,500									
SIZE WxH (IN)	72 X 36	120 X 54	96 X 54									
MIN. FREE AREA (FT²)	9.9	26.5	18.5									
FREE AREA VEL. (FPM)	625	585	570									
STATIC PRESSURE (IN W.C.)	0.08	0.08	0.08									
REMARKS		1	1									

KEYED NOTES:

PROVIDE LOUVERS AND MOTORIZED DAMPER/ACTUATORS AS PART OF ALTERNATE BID #1.

SCS ENGINEERS

2830 DAIRY DRIVE MADISON, WI 53718-6751 PHONE: (608) 224-2830

MADISON, WI 53711

ENGINEERING, INC.
5525 NOBEL DRIVE
SUITE 110

ph:608.277.1728 fax:608.271.7046

JDR Project No. 150012

CONSTRUCTION AND

DEMOLITION WASTE

RECYCLING FACILITY

7102 US HIGHWAY 12/18

MADISON, WISCONSIN

DANE COUNTY DEPARTMENT OF
PUBLIC WORKS
SOLID WASTE DIVISION
1919 ALLIANT ENERGY CENTER WAY
MADISON, WI 53713

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ARCHITECT:
DORSCHNER ASSOCIATES, INC.
849 E. WASHINGTON AVE., SUITE 112
MADISON, WI 53703

STRUCTURAL ENGINEER:
PIERCE ENGINEERS, INC.
10 WEST MIFFLIN ST., SUITE 205
MADISON, WI 53703

MECHANICAL, ELECTRICAL, PLUMBING DESIGN

JDR ENGINEERING, INC. 5525 NOBEL DRIVE, SUITE 110 MADISON, WI 53711

REVISION	DATE	BY	TITLE
PROJECT	NO.		25214236.00
DRAWN:	_		04/28/15

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 JDR

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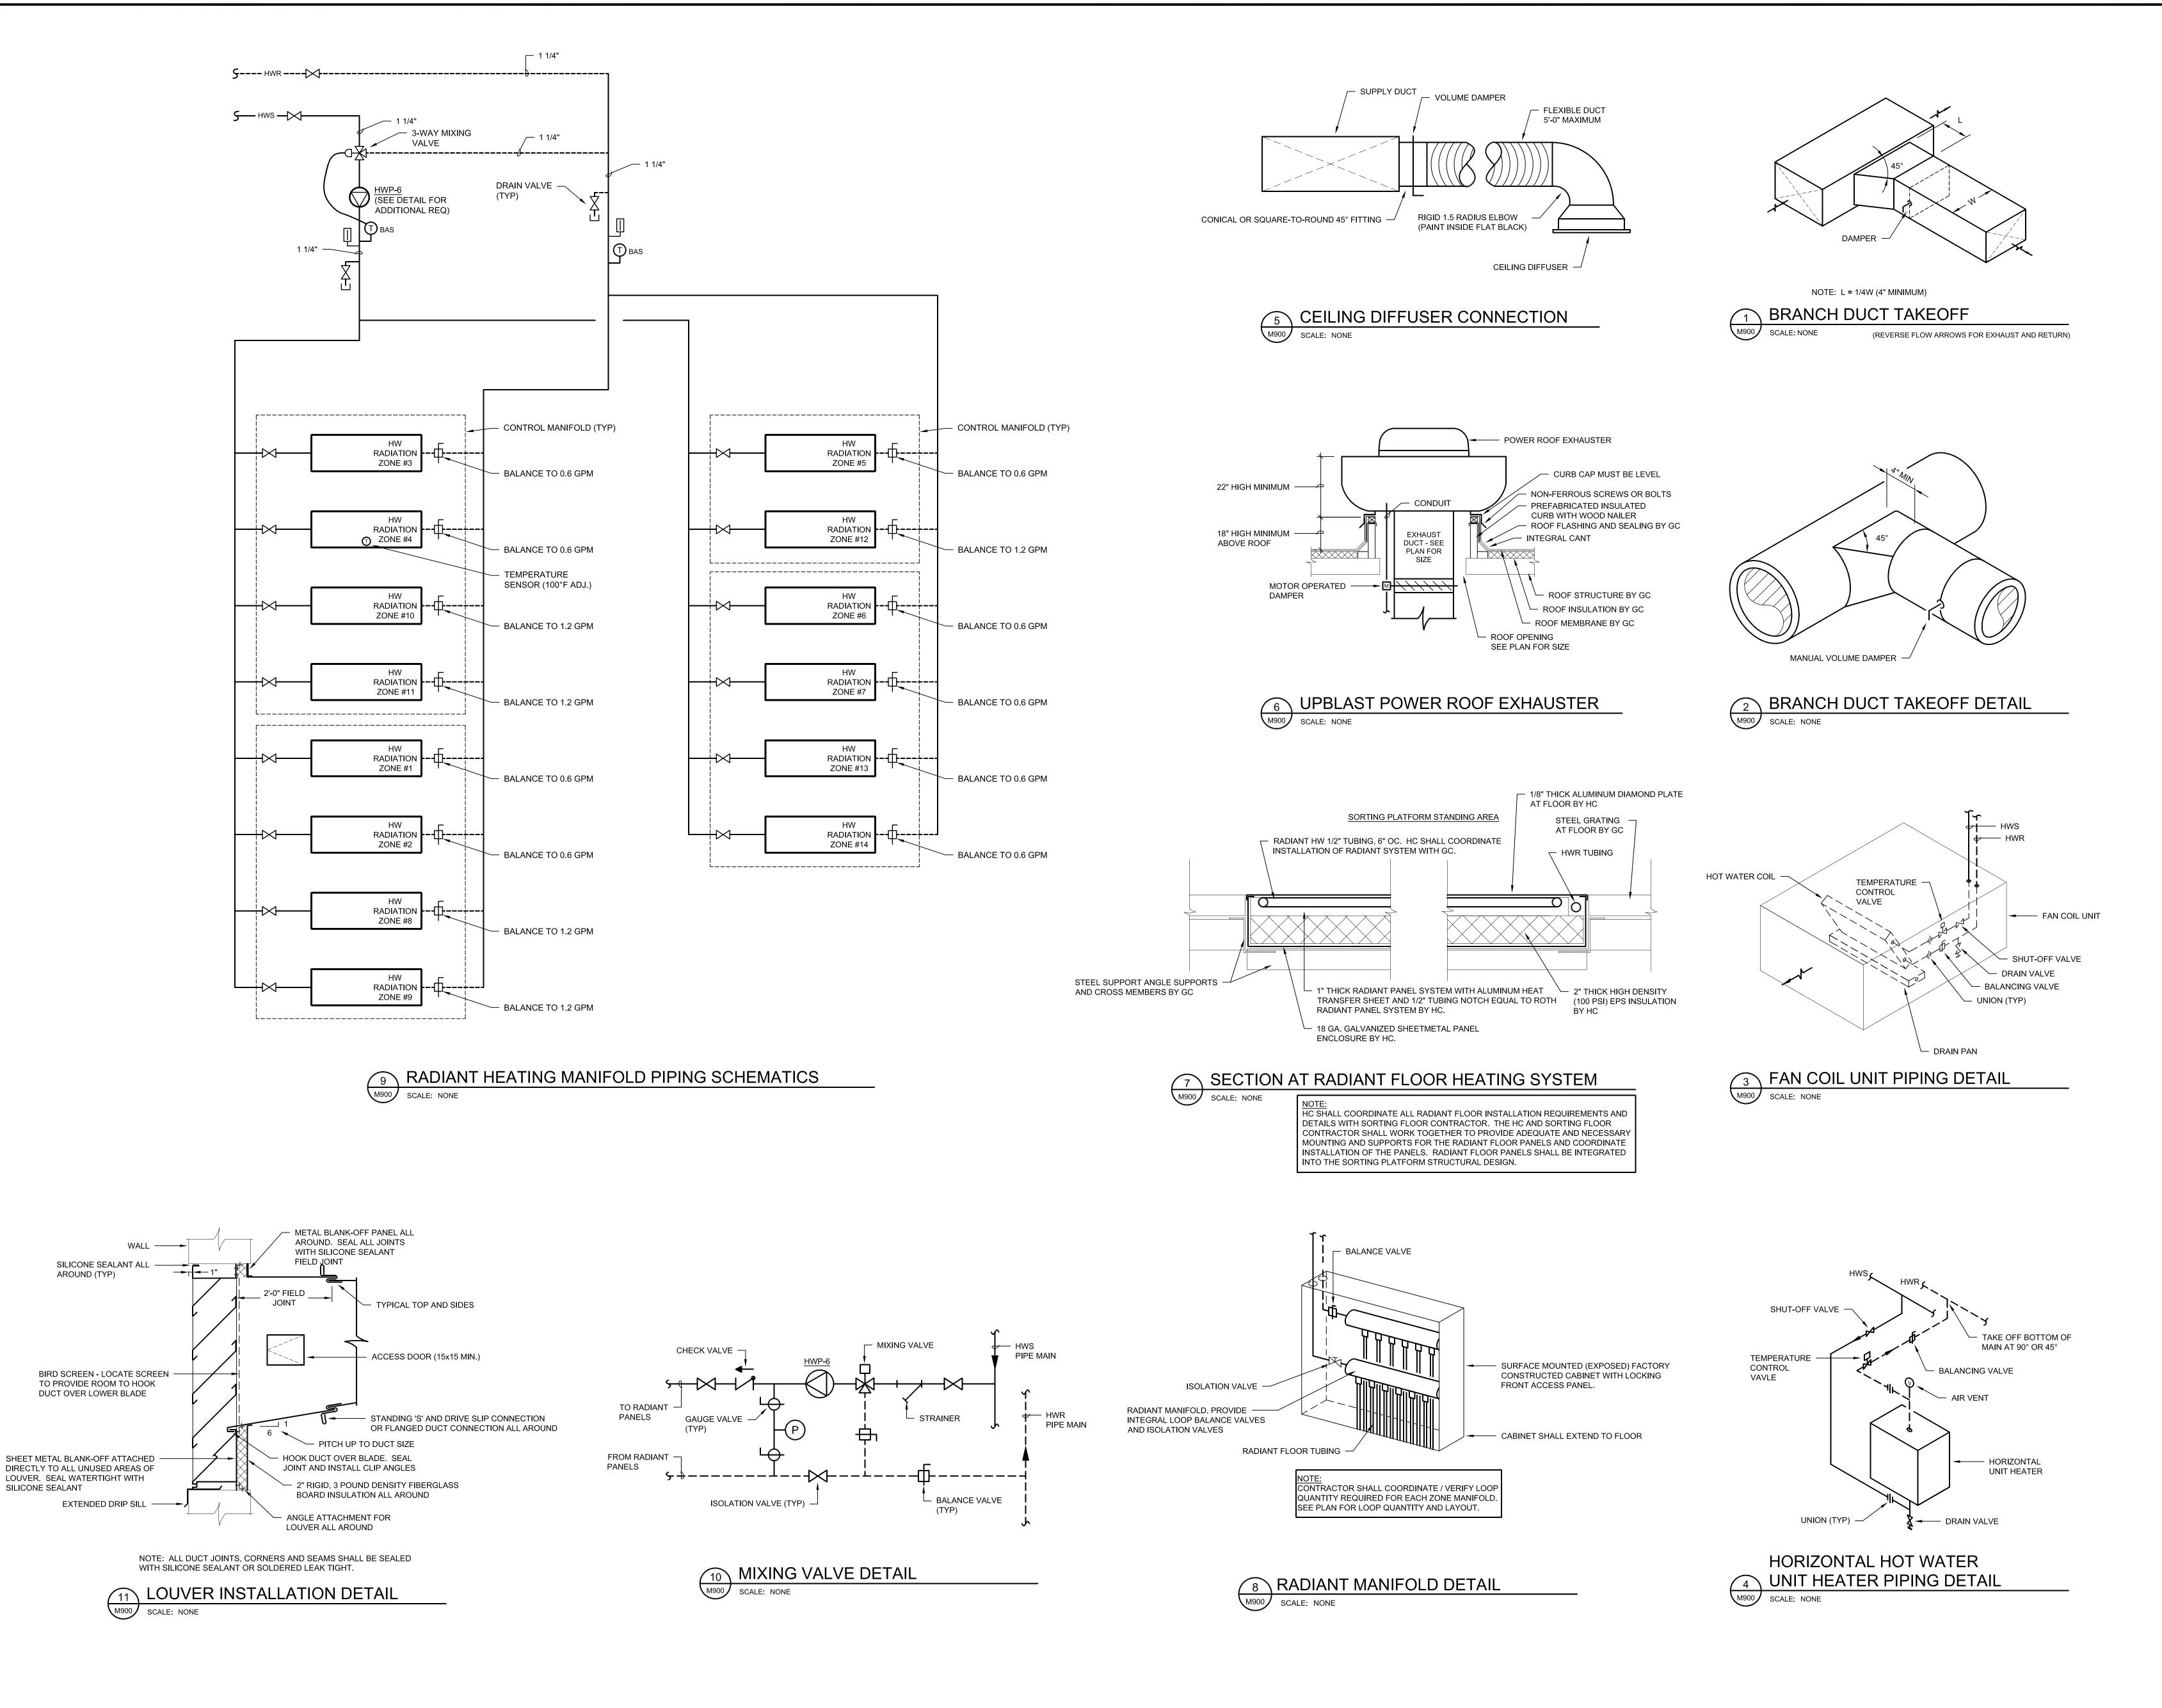
 APPROVED BY:

ISSUED 04/28/15

BID DOCUMENTS

SCHEDULES - HVAC

SHEET NUMBER **M800**



2830 DAIRY DRIVE MADISON, WI 53718-6751 PHONE: (608) 224-2830

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5525 NOBEL DRIVE
SUITE 110

CONSTRUCTION AND
DEMOLITION WASTE
RECYCLING FACILITY
7102 US HIGHWAY 12/18
MADISON, WISCONSIN

MADISON, WI 53711

ph:608.277.1728 fax:608.271.7046

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MADISON, WI 53703

MECHANICAL, ELECTRICAL, PLUMBING

DESIGN

JDR ENGINEERING, INC. 5525 NOBEL DRIVE, SUITE 110 MADISON, WI 53711

REVISION DATE BY TITLE

PROJECT NO. 25214236.00

DRAWN: 04/28/15

DRAWN BY: JDR

BID DOCUMENTS

CHECKED BY:

DETAILS AND

ISSUED 04/28/15

SCHEMATICS - HVAC

SHEET NUMBER

M900

LIGH	IT FIXT	URE SCHEDU	JLE				
CALLOUT	SYMBOL	LAMP	DESCRIPTION	MODEL	INPUT WATTS	VOLTS	NOTE 1
А	¤	(1) 320W PSMH	HID HIGHBAY	LUMARK MPLX-PD-PC3-FH-1 LITHONIA DAYBRITE	375	277V 1P 2W	PROVIDE CORD AND PLUG CONNECTION
A(ALT)		(1) 228W LED	LED HIGHBAY	METALUX HBLED-LD4-30-W-CL-277-L850-ED3-MP-MPC3 LITHONIA DAYBRITE	228	277V 1P 2W	ALTERNATE BID #2 - PROVIDE IN LIEU OF ALL TYPE A, A(EX) AND A(RE) FIXTURES
A(EX)	¤	(1) 320W PSMH	EXISTING HID HIGHBAY	LUMARK MPLX-PD-PC3-FH-1	375	277V 1P 2W	EXISTING FIXTURE REUSED IN PLACE
A(RE)	¤	(1) 320W PSMH	EXISTING HID HIGHBAY	LUMARK MPLX-PD-PC3-FH-1	375	277V 1P 2W	EXISTING FIXTURE RELOCATED
В		(2) 32W T8	4' WALL MOUNT BATHROOM VANITY	METAUX BAU EB LITHONIA DAYBRITE	64	277V 1P 2W	
С		(2) 32W T8	4' VAPORTIGHT INDUSTRIAL	METALUX VT3-232DR100-UNV-EB81 LITHONIA DAYBRITE	64	277V 1P 2W	
D		(4) 32W T8	HIGH BAY FLUORESCENT	METALUX 2HB-432-MPC3 LITHONIA DAYBRITE	128	277V 1P 2W	PROVIDE WITH CORD AND PLUG CONNECTION
EBU	4_4	(2) 20W MR16	EGRESS BATTERY UNIT	EMERGI-LITE B12SV24N-2MW-DA SURELITES LITHONIA	20	277V 1P 2W	
EG	3	(2) 20W MR16	DOUBLE HEAD REMOTE EGRESS	EMERGI-LITE EF39-MD SURELITES LITHONIA	3	MULTIPLE	
ОВ	æ	(6) 52W LED	EXTERIOR WALL MOUNT	McGRAW EDISON GLEON-AAE-6-LED-E1-T4W-BK-WM LITHONIA DAYBRITE	312	277V 1P 2W	
ОС	X -	(6) 52W LED	EXTERIOR POLE MOUNT	McGRAW EDISON GLEON-AAE-6-LED-E1-T4W-BK LITHONIA DAYBRITE	312	277V 1P 2W	REPLACE EXISTING POLE MOUNTED FIXTURE WITH NEW FIXTURE. REUSE EXISTING POLE.
Х	×	(2) 12W MR16	SELF POWERED EXIT LIGHT W/ EGRESS	EMERGI-LITE BBSVX24NRDA2MK SURELITES LITHONIA	3	MULTIPLE	

SYMBOL	CALLOUT	DESCRIPTION	VOLTS	AMPS	KVA	HP	CIRCUIT	STARTER DESCRIPTION	STARTER PROVIDED	STARTER INSTALLED	NOTES
6	EF-2	EXHAUST FAN	480V 3P 3W	3	2.49	1.5 HP	LPA2(X)-2,4,6	COMBINATION	EC BY	EC BY	SEE HVAC DRAWINGS FOR STARTER LOCATION
9 6	EF-3	EXHAUST FAN	480V 3P 3W	3	2.49	1.5 HP	LPA2(X)-2,4,6	COMBINATION	EC	EC	SEE HVAC DRAWINGS FOR STARTER LOCATION
6	EF-7	EXHAUST FAN	480V 3P 3W	4.8	3.99	3 HP	LPA2(X)-8,10,12	COMBINATION	EC	EC	SEE HVAC DRAWINGS FOR STARTER LOCATION
/	EF-8	EXHAUST FAN	480V 3P 3W	4.8	3.99	3 HP	LPA2(X)-8,10,12	COMBINATION	EC	EC	SEE HVAC DRAWINGS FOR STARTER LOCATION
	EF-9	EXHAUST FAN	480V 3P 3W	1.1	0.91	1/2 HP	LPA2(X)-8,10,12	COMBINATION	EC	EC	SEE HVAC DRAWINGS FOR STARTER LOCATION
,	EF-10	EXHAUST FAN	480V 3P 3W	7.6	6.32	5 HP	LPA2(X)-14,16,18	COMBINATION	EC	EC	SEE HVAC DRAWINGS FOR STARTER LOCATION
9	EF-11	EXHAUST FAN	480V 3P 3W	7.6	6.32	5 HP	LPA2(X)-14,16,18	COMBINATION	EC	EC	SEE HVAC DRAWINGS FOR STARTER LOCATION
9	FCU-5	FAN COIL UNIT	208V 2P 2W	0.5	0.1		RPA2(X)-2,4	PACKAGE	EC	EC	PROVIDE DISCONNECT SWITCH AT UNIT. CONNECT TO RECEPTACLE CIRCUIT THE SAME ROOM.
Ó	HWP-6	HOT WATER PUMP	208V 2P 2W	2.3	0.47	1/8 HP	RPA2(X)-2,4	N/A	EC	EC	PROVIDE DISCONNECT SWITCH AT UNIT
Ó	M-1	MISTER (EXISTING)	480V 3P 3W	4.8	3.99	3 HP		COMBINATION	EC	EC	RELOCATE EXISTING WIRING TO NEW LOCATION SHOWN ON FLOOR PLANS
9	M-2	MISTER (NEW)	480V 3P 3W	4.8	3.99	3 HP		COMBINATION	EC	EC	PROVIDE NEW WIRING FROM EXISTING BREAKER IN MDP
9	MC-1	MONORAIL CRANE	480V 3P 3W	11	9.15	7.5 HP	LPA2(X)-20,22,24	N/A	EC	EC	INCLUDE IN ALTERNATE BID 3. PROVIDE NONFUSED DISCONNECT NEAR CRANE RAIL CONNECTION POINT.
Ó	OHD-1	OVERHEAD DOOR OPERATOR	120V 1P 2W	9.8	1.18	1/2 HP		N/A	EC	EC	PROVIDE NONFUSED DISCONNECT AT DOOR. EXTEND EXISTING OHD CIRCUIT TO NEW LOCATION. INCLUDE INSTALLATION OF DOOR CONTROL WIRING. COORDINATE REQUIREMENTS WITH DOOR INSTALLER.
Ó	OHD-2	OVERHEAD DOOR OPERATOR	120V 1P 2W	9.8	1.18	1/2 HP		N/A	EC	EC	PROVIDE NONFUSED DISCONNECT AT DOOR. EXTEND EXISTING OHD CIRCUIT TO NEW LOCATION. INCLUDE INSTALLATION OF DOOR CONTROL WIRING. COORDINATE REQUIREMENTS WITH DOOR INSTALLER.
Ó	OHD-3	OVERHEAD DOOR OPERATOR	120V 1P 2W	9.8	1.18	1/2 HP		N/A	EC	EC	PROVIDE NONFUSED DISCONNECT AT DOOR. EXTEND EXISTING OHD CIRCUIT TO NEW LOCATION. INCLUDE INSTALLATION OF DOOR CONTROL WIRING. COORDINATE REQUIREMENTS WITH DOOR INSTALLER.
Ó	OHD-4	OVERHEAD DOOR OPERATOR	120V 1P 2W	9.8	1.18	1/2 HP		N/A	EC	EC	PROVIDE NONFUSED DISCONNECT AT DOOR. EXTEND EXISTING OHD CIRCUIT TO NEW LOCATION. INCLUDE INSTALLATION OF DOOR CONTROL WIRING. COORDINATE REQUIREMENTS WITH DOOR INSTALLER.
Ó	OHD-5	OVERHEAD HANGER DOOR OPERATOR	480V 3P 3W	2.1	1.75	1 HP		N/A	EC	EC	INCLUDE IN ALTERNATE BID 1. PROVIDE NONFUSED DISCONNECT AT DOOR. CONNECT TO SPARE BREAKER IN MDP. INCLUDE INSTALLATION OF DOOR CONTROL WIRING. COORDINATE REQUIREMENTS WITH DOOR INSTALLER
Ó	UH-4	UNIT HEATER	120V 1P 2W	0.8	0.1	F HP		N/A	EC	EC	CONNECT THROUGH VARIABLE SPEED CONTROL PROVIDED BY HC, INSTALLED BY EC. PROVIDE TOGGLE SWITCH AT UNIT. CONENCT TO SAME CIRCUIT SERVING RECEPTACLE IN ROOM.
Ó	UH-5	UNIT HEATER	120V 1P 2W	0.8	0.1	F HP		N/A	EC	EC	CONNECT THROUGH VARIABLE SPEED CONTROL PROVIDED BY HC, INSTALLED BY EC. PROVIDE TOGGLE SWITCH AT UNIT. CONENCT TO SAME CIRCUIT SERVING RECEPTACLE IN ROOM.

SYMBOLS LIST: MOUNTING HEIGHTS FOR DEVICES AND EQUIPMENT TO BE MEASURED FROM FINISHED FLOOR TO CENTERLINE OF DEVICE. LIGHTING: CEILING MOUNTED FIXTURE ALT SW ATS BFG BLDG BPC — CIRCUIT NUMBER. SEE PLANS FOR PANEL BOUNDARIES. CIRCUIT SWITCH LEG. NO DESIGNATION INDICATES PORTION OF BKR CIRCUIT SWITCHED FROM LOCAL SWITCH OR OCCUPANCY SENSOR. BOL CATV CCTV FIXTURE TYPE SHADING INDICATES FIXTURE WIRED TO EMERGENCY OR NIGHT LIGHTING CIRCUIT WALL MOUNTED FIXTURE DIR DISC STRIP LIGHT DOWNLIGHT - RECESSED ELEV LIGHTING FIXTURE - CEILING SURFACE LIGHTING FIXTURE - WALL SURFACE ACCENT LIGHT - RECESSED ERL ERLD ETR LIGHTING FIXTURE - CEILING PENDANT LIGHTING FIXTURE - POLE MOUNTED NOTE: SHADING OF ANY OF THE LIGHTING FIXTURES ABOVE INDICATES UNITS WIRED TO AN EMERGENCY OR NIGHT FACP LIGHTING CIRCUIT. FBO FDR F HP EXIT LIGHT. SHADING INDICATES FACE OF EXIT. FIXT FLR SINGLE POLE SWITCH - TOGGLE TYPE FLOOR FLA FLUOR — SWITCH DESIGNATION — SWITCH TYPE (3) 3 WAY GFI GRC GRD DIMMER SWITCH OSH LIGHTING CONTROL OCCUPANCY SENSOR. WALL MOUNTED. US LIGHTING CONTROL OCCUPANCY SENSOR. CEILING MOUNTED. REMOTE EGRESS L LIGHTING CONTROL STATION J-BOX POWER: DUPLEX RECEPTACLE - MOUNTED 18" AFF UNLESS NOTED OTHERWISE CIRCUIT NUMBER (SEE PLAN FOR PANEL BOUNDARIES) - TYPICAL RECEPTACLE TYPE OR EQUIPMENT SERVED. (D) DEDICATED CIRCUIT (EWC) ELECTRIC WATER COOLER (WP) WEATHERPROOF DUPLEX RECEPTACLE - MOUNTED AT 46" TO CENTER OF DEVICE UNLESS POLE NOTED OTHERWISE GROUND FAULT INTERRUPTING DUPLEX RECEPTACLE - MOUNTED AT 46" TO CENTER OF DEVICE UNLESS NOTED OTHERWISE PEND PE SW DUPLEX RECEPTACLE - MOUNTED ABOVE CEILING RELAY FLOOR MOUNTED ELECTRICAL BOX SEE DRAWINGS AND SCHEDULE FOR TYPES OF OUTLETS REQUIRED AT EACH BOX. RECESS RECEPTACLE RM RVS REDUCED VOLTAGE STARTING → SIMPLEX RECEPTACLE SELECTOR SWITCH SEL SW SPEED SWITCH () MOTOR CONNECTION SURF SW SURFACE MOTOR DESIGNATION. REFER TO BUILDING EQUIPMENT SCHEDULE TIME CLOCK FOR FEEDER AND STARTER INFORMATION. TEMPERATURE CONTROL PANEL ☐ DISCONNECT SWITCH TEMPERATURE CONTROL CONTRACTOR TAMPER SWITCH JUNCTION BOX UG UNIV USS UNDERGROUND UNIVERSAL COMBINATION STARTER UNIT SUBSTATION WEATHERPROOF TRANSFORMER

SYSTEMS:

COMMUNICATIONS ROUGH IN

COMMUNICATIONS ROUGH IN - MOUNTED AT HEIGHT INDICATED

W WALL PHONE ROUGH IN - MOUNTED AT HEIGHT INDICATED

FIRE ALARM MANUAL PULLSTATION FIRE ALARM AUDIO/VISUAL SIGNALLING DEVICE

FIRE ALARM VISUAL ONLY SIGNALLING DEVICE

S SMOKE DETECTOR (PHOTO-ELECTRIC TYPE) H HEAT DETECTOR - RATE OF RISE

ABBREVIATIONS: ABOVE FINISHED FLOOR ABOVE FINISHED GRADE AVAILABLE INTERRUPTING CURRENT ARCHITECT/ENGINEER ALTERNATE ALTERNATOR SWITCH ARCHITECT AUTOMATIC TRANSFER SWITCH BELOW FINAL GRADE BUILDING BOLTED PRESSURE CONTACT BREAKER **BUILT IN OVERLOAD** CABLE TELEVISION CLOSED CIRCUIT TELEVISION CIRCUIT BREAKER CIRCUIT CEILING CONTROL PANEL COMBINATION STARTER CURRENT TRANSFORMER DUAL ELEMENT FUSES DISCONNECT ELECTRICAL CONTRACTOR ELEVATION **EMERGENCY** ELECTRICAL NON-METALLIC TUBING ELECTRIC METALLIC TUBING END OF LINE RESISTOR EXPLOSION PROOF EXISTING TO BE REMOVED EXISTING TO BE RELOCATED EXISTING RELOCATED EXISTING TO REMAIN **EXISTING** ELECTRIC WATER COOLER FIRE ALARM ANNUNCIATOR PANEL FIRE ALARM CONTROL PANEL FURNISHED BY OTHERS FRACTIONAL HORSE POWER FIXTURE FULL LOAD AMPS FLUORESCENT FLOW SWITCH FULL VOLTAGE NON-REVERSING GENERAL CONTRACTOR GROUND FAULT INTERRUPTER GALVANIZED RIGID CONDUIT GROUND GYPSUM BOARD HIGH INTENSITY DISCHARGE HAND-OFF-AUTO SWITCH HORSEPOWER HIGH PRESSURE SODIUM HIGH VOLTAGE HEATING & VENTILATING - AIR CONDITIONING HEATING VENTILATING CONTRACTOR HEAVYWALL INDIRECT INTERLOCK INTERMEDIATE METAL CONDUIT INCANDESCENT JUNCTION BOX LAY-IN GRID LIGHTING LOW VOLTAGE LINE VOLTAGE THERMOSTAT MAGNETIC STARTER MANUAL STARTER MOTOR CONTROL CENTER MAIN DISTRIBUTION PANEL MAIN LUGS ONLY MAIN SWITCHBOARD NOT IN CONTRACT **NEAR UNIT** ON UNIT PUSHBUTTON PENDANT PHOTO CONTROL PNEUMATIC SWITCH PLUMBING CONTRACTOR REMAIN AS IS

ELECTRICAL SHEET INDEX

E000 SYMBOLS & SCHEDULES - ELECTRICAL

E001 SITE PLAN - ELECTRICAL

E101 WTS UPPER LEVEL FLOOR PLAN - DEMOLITION - ELECTRICAL

E201 PARTIAL FLOOR PLANS - ELECTRICAL E202 PARTIAL FLOOR PLANS - ELECTRICAL

E600 ONE LINE DIAGRAM - ELECTRICAL

E800 SCHEDULES - ELECTRICAL

APPROVED BY:

REVISION DATE BY

TITLE

SCS ENGINEERS 2830 DAIRY DRIVE MADISON, WI 53718-6751 PHONE: (608) 224-2830

ENGINEERING, INC.

5525 NOBEL DRIVE

SUITE 110

MADISON, WI 53711

ph:608.277.1728 fax:608.271.7046

JDR Project No. 150012

CONSTRUCTION AND

DEMOLITION WASTE

RECYCLING FACILITY

7102 US HIGHWAY 12/18

MADISON, WISCONSIN

DANE COUNTY DEPARTMENT OF

PUBLIC WORKS

SOLID WASTE DIVISION

1919 ALLIANT ENERGY CENTER WAY

MADISON, WI 53713

PROCCESS AND CIVIL ENGINEER:

DORSCHNER ASSOCIATES, INC.

O WEST MIFFLIN ST., SUITE 205

MECHANICAL, ELECTRICAL, PLUMBING

5525 NOBEL DRIVE, SUITE 110

849 E. WASHINGTON AVE., SUITE 112

MADISON, WI 53718-6751

SCS ENGINEERS

2830 DAIRY DRIVE

(608) 224-2830

MADISON, WI 53703

STRUCTURAL ENGINEER:

MADISON, WI 53703

JDR ENGINEERING, INC.

MADISON, WI 53711

PIERCE ENGINEERS, INC.

ARCHITECT:

DESIGN


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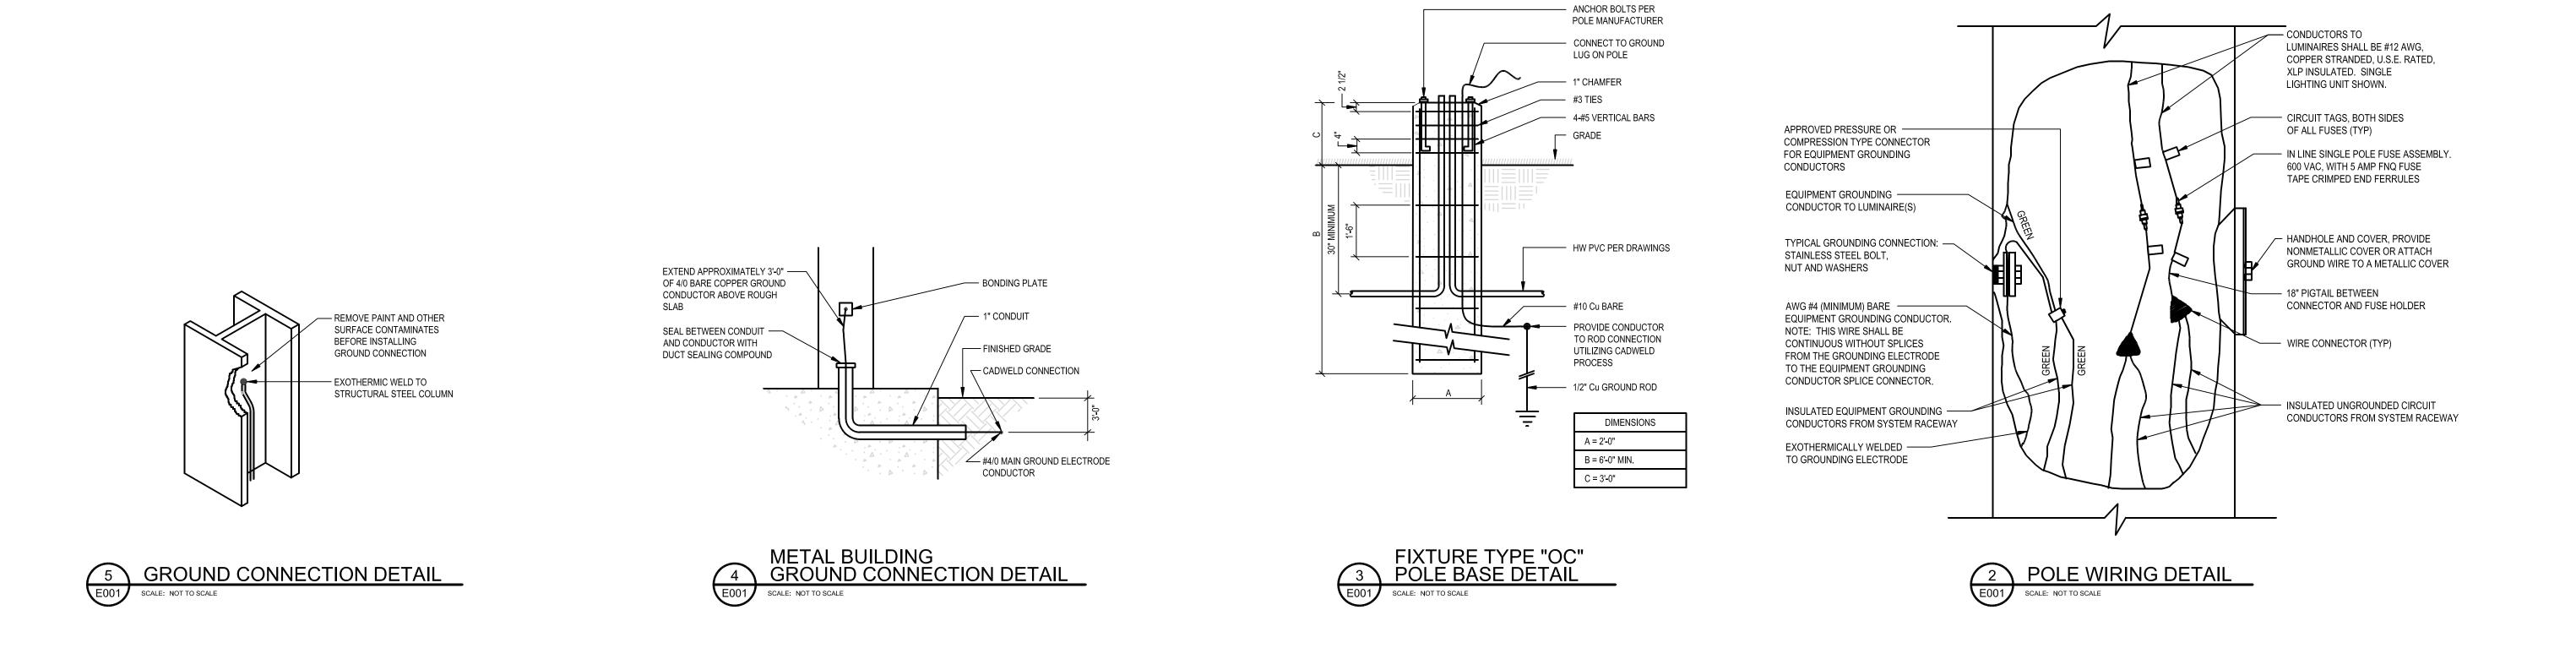
> **BID DOCUMENTS** ISSUED 04/28/15

> > SYMBOLS & SCHEDULES -**ELECTRICAL**

> > > SHEET NUMBER

E000



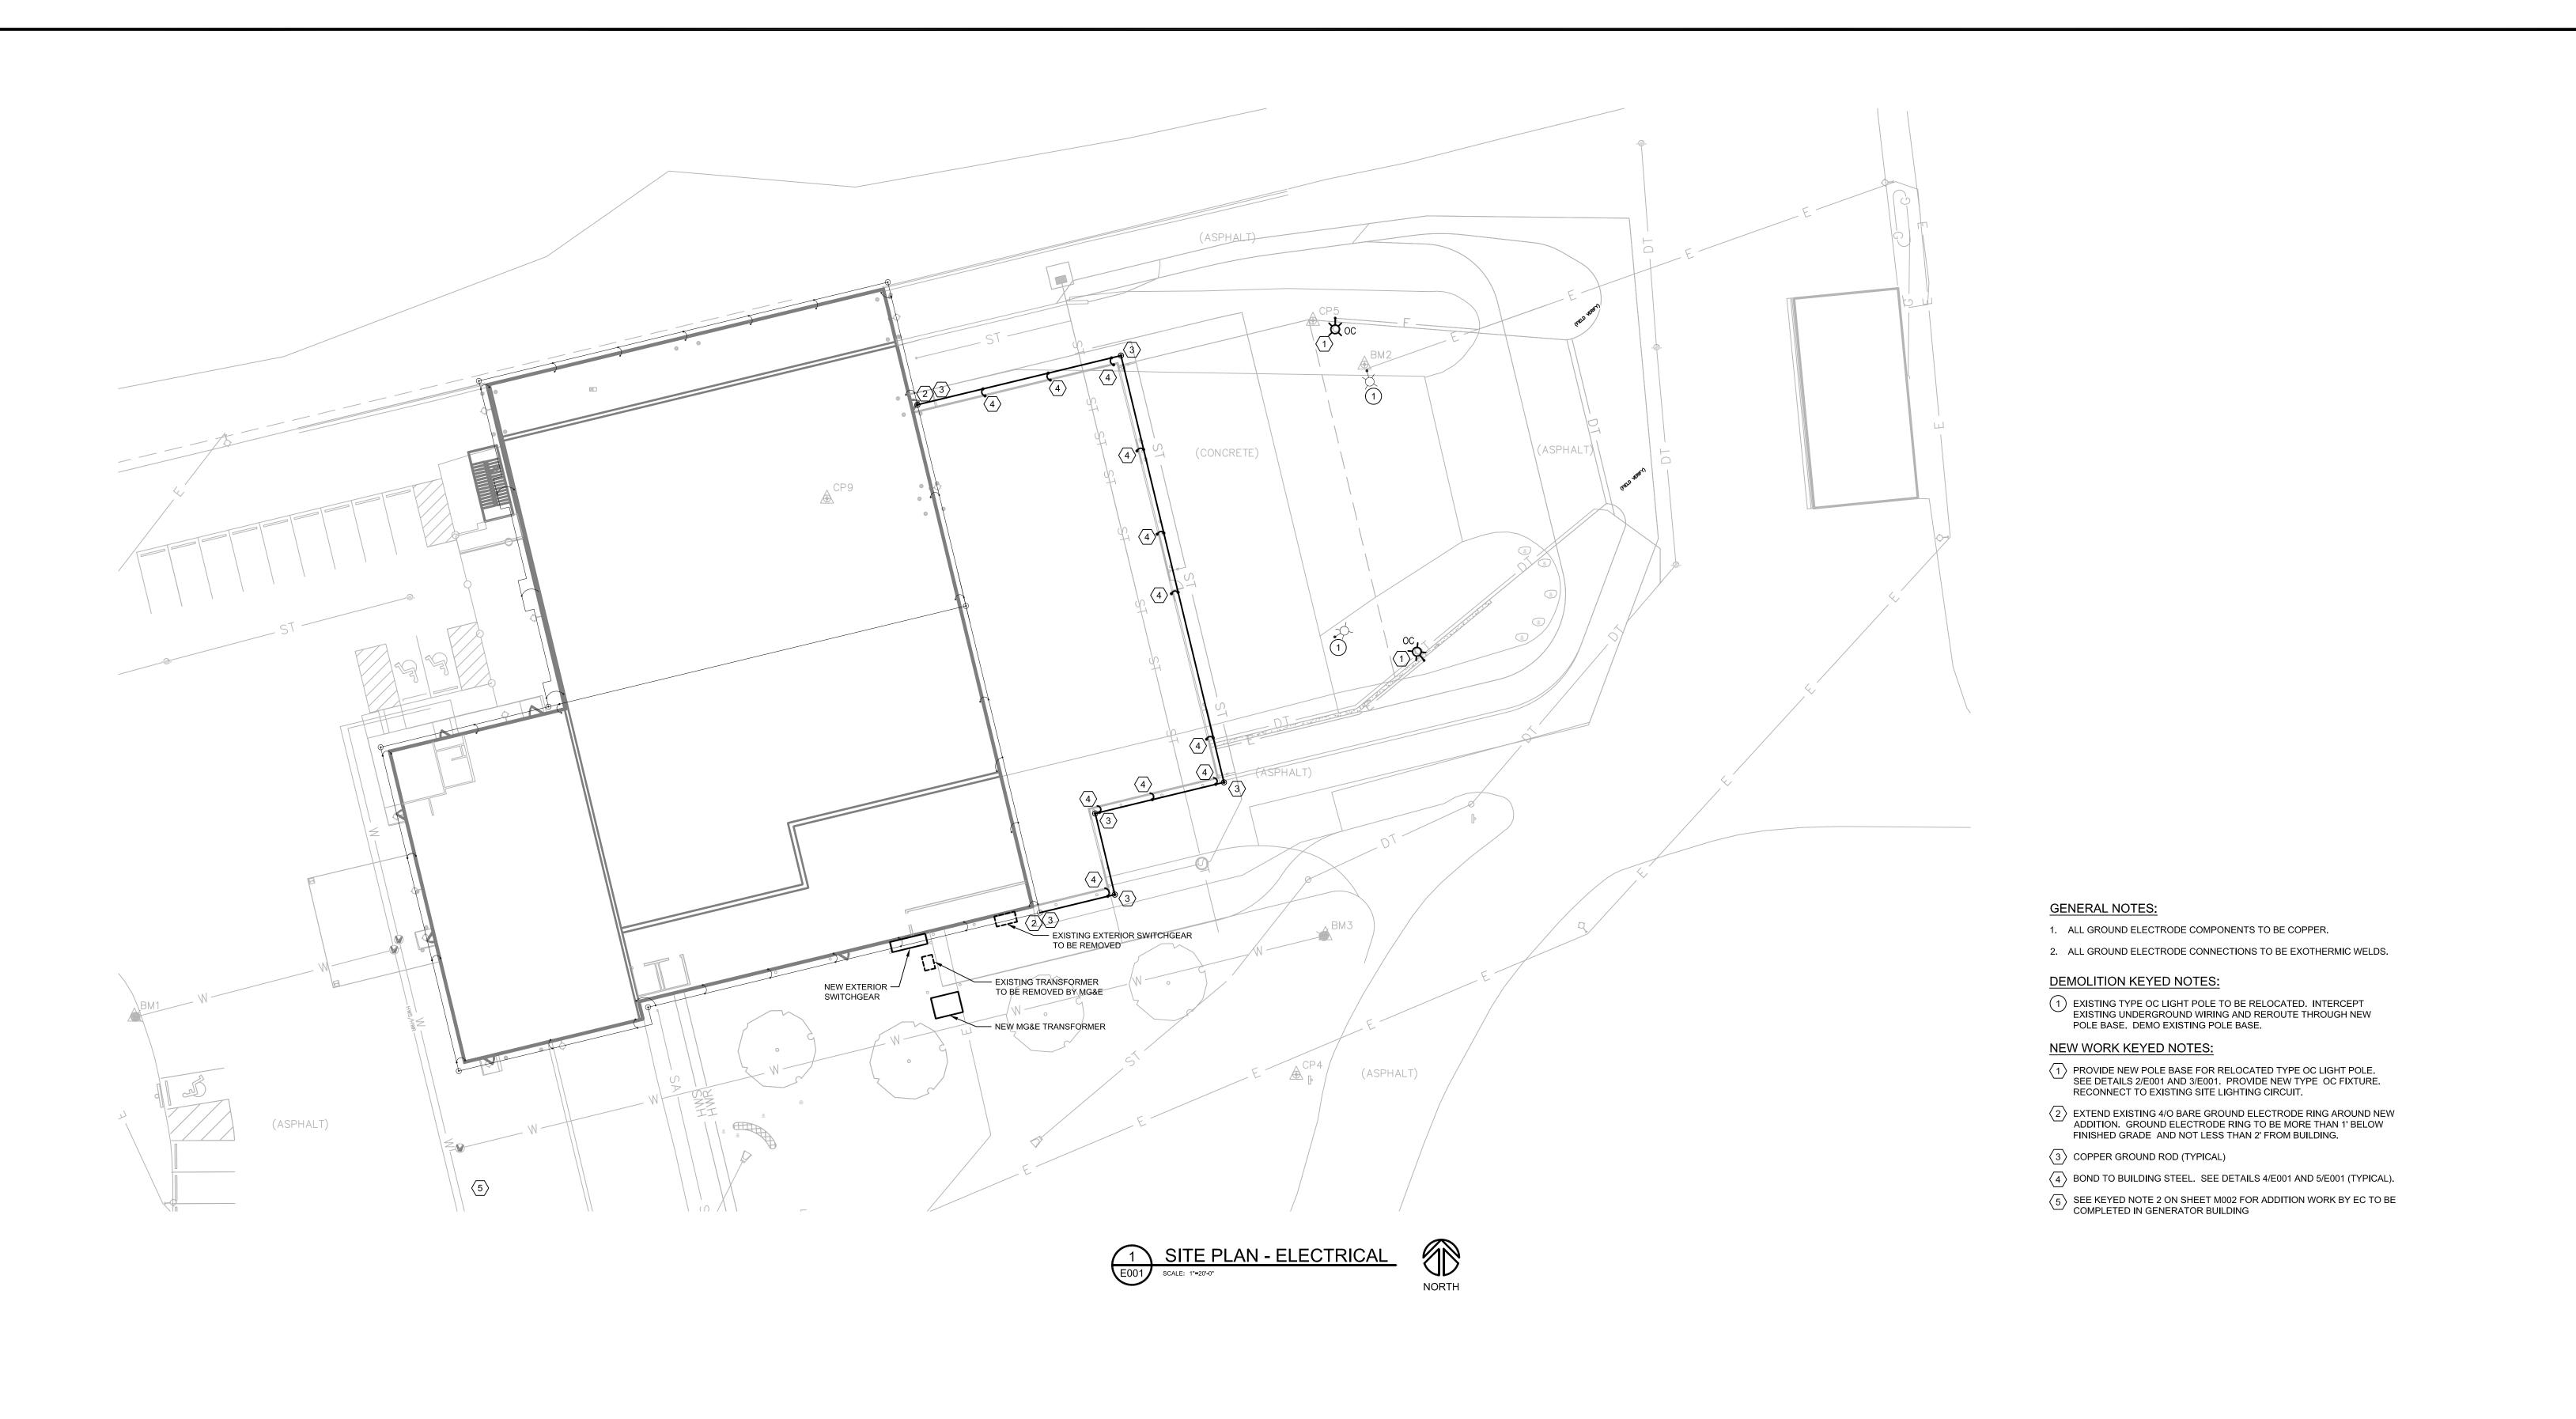

2830 DAIRY DRIVE MADISON, WI 53718-6751 PHONE: (608) 224-2830

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MADISON, WI 53713

PROCCESS AND CIVIL ENGINEER:

SCS ENGINEERS
2830 DAIRY DRIVE
MADISON, WI 53718-6751

(608) 224-2830

ARCHITECT:
DORSCHNER ASSOCIATES, INC.
849 E. WASHINGTON AVE., SUITE 112
MADISON, WI 53703

PIERCE ENGINEERS, INC.

10 WEST MIFFLIN ST., SUITE 205

MADISON, WI 53703

STRUCTURAL ENGINEER:

MADISON, WI 53711

MECHANICAL, ELECTRICAL, PLUMBING DESIGN

JDR ENGINEERING, INC.
5525 NOBEL DRIVE, SUITE 110

REVISION DATE BY TITLE

PROJECT NO. 25214236.00

DRAWN: 04/28/15


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BID DOCUMENTS
ISSUED 04/28/15

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> SITE PLAN -ELECTRICAL

> > SHEET NUMBER



2830 DAIRY DRIVE MADISON, WI 53718-6751 PHONE: (608) 224-2830

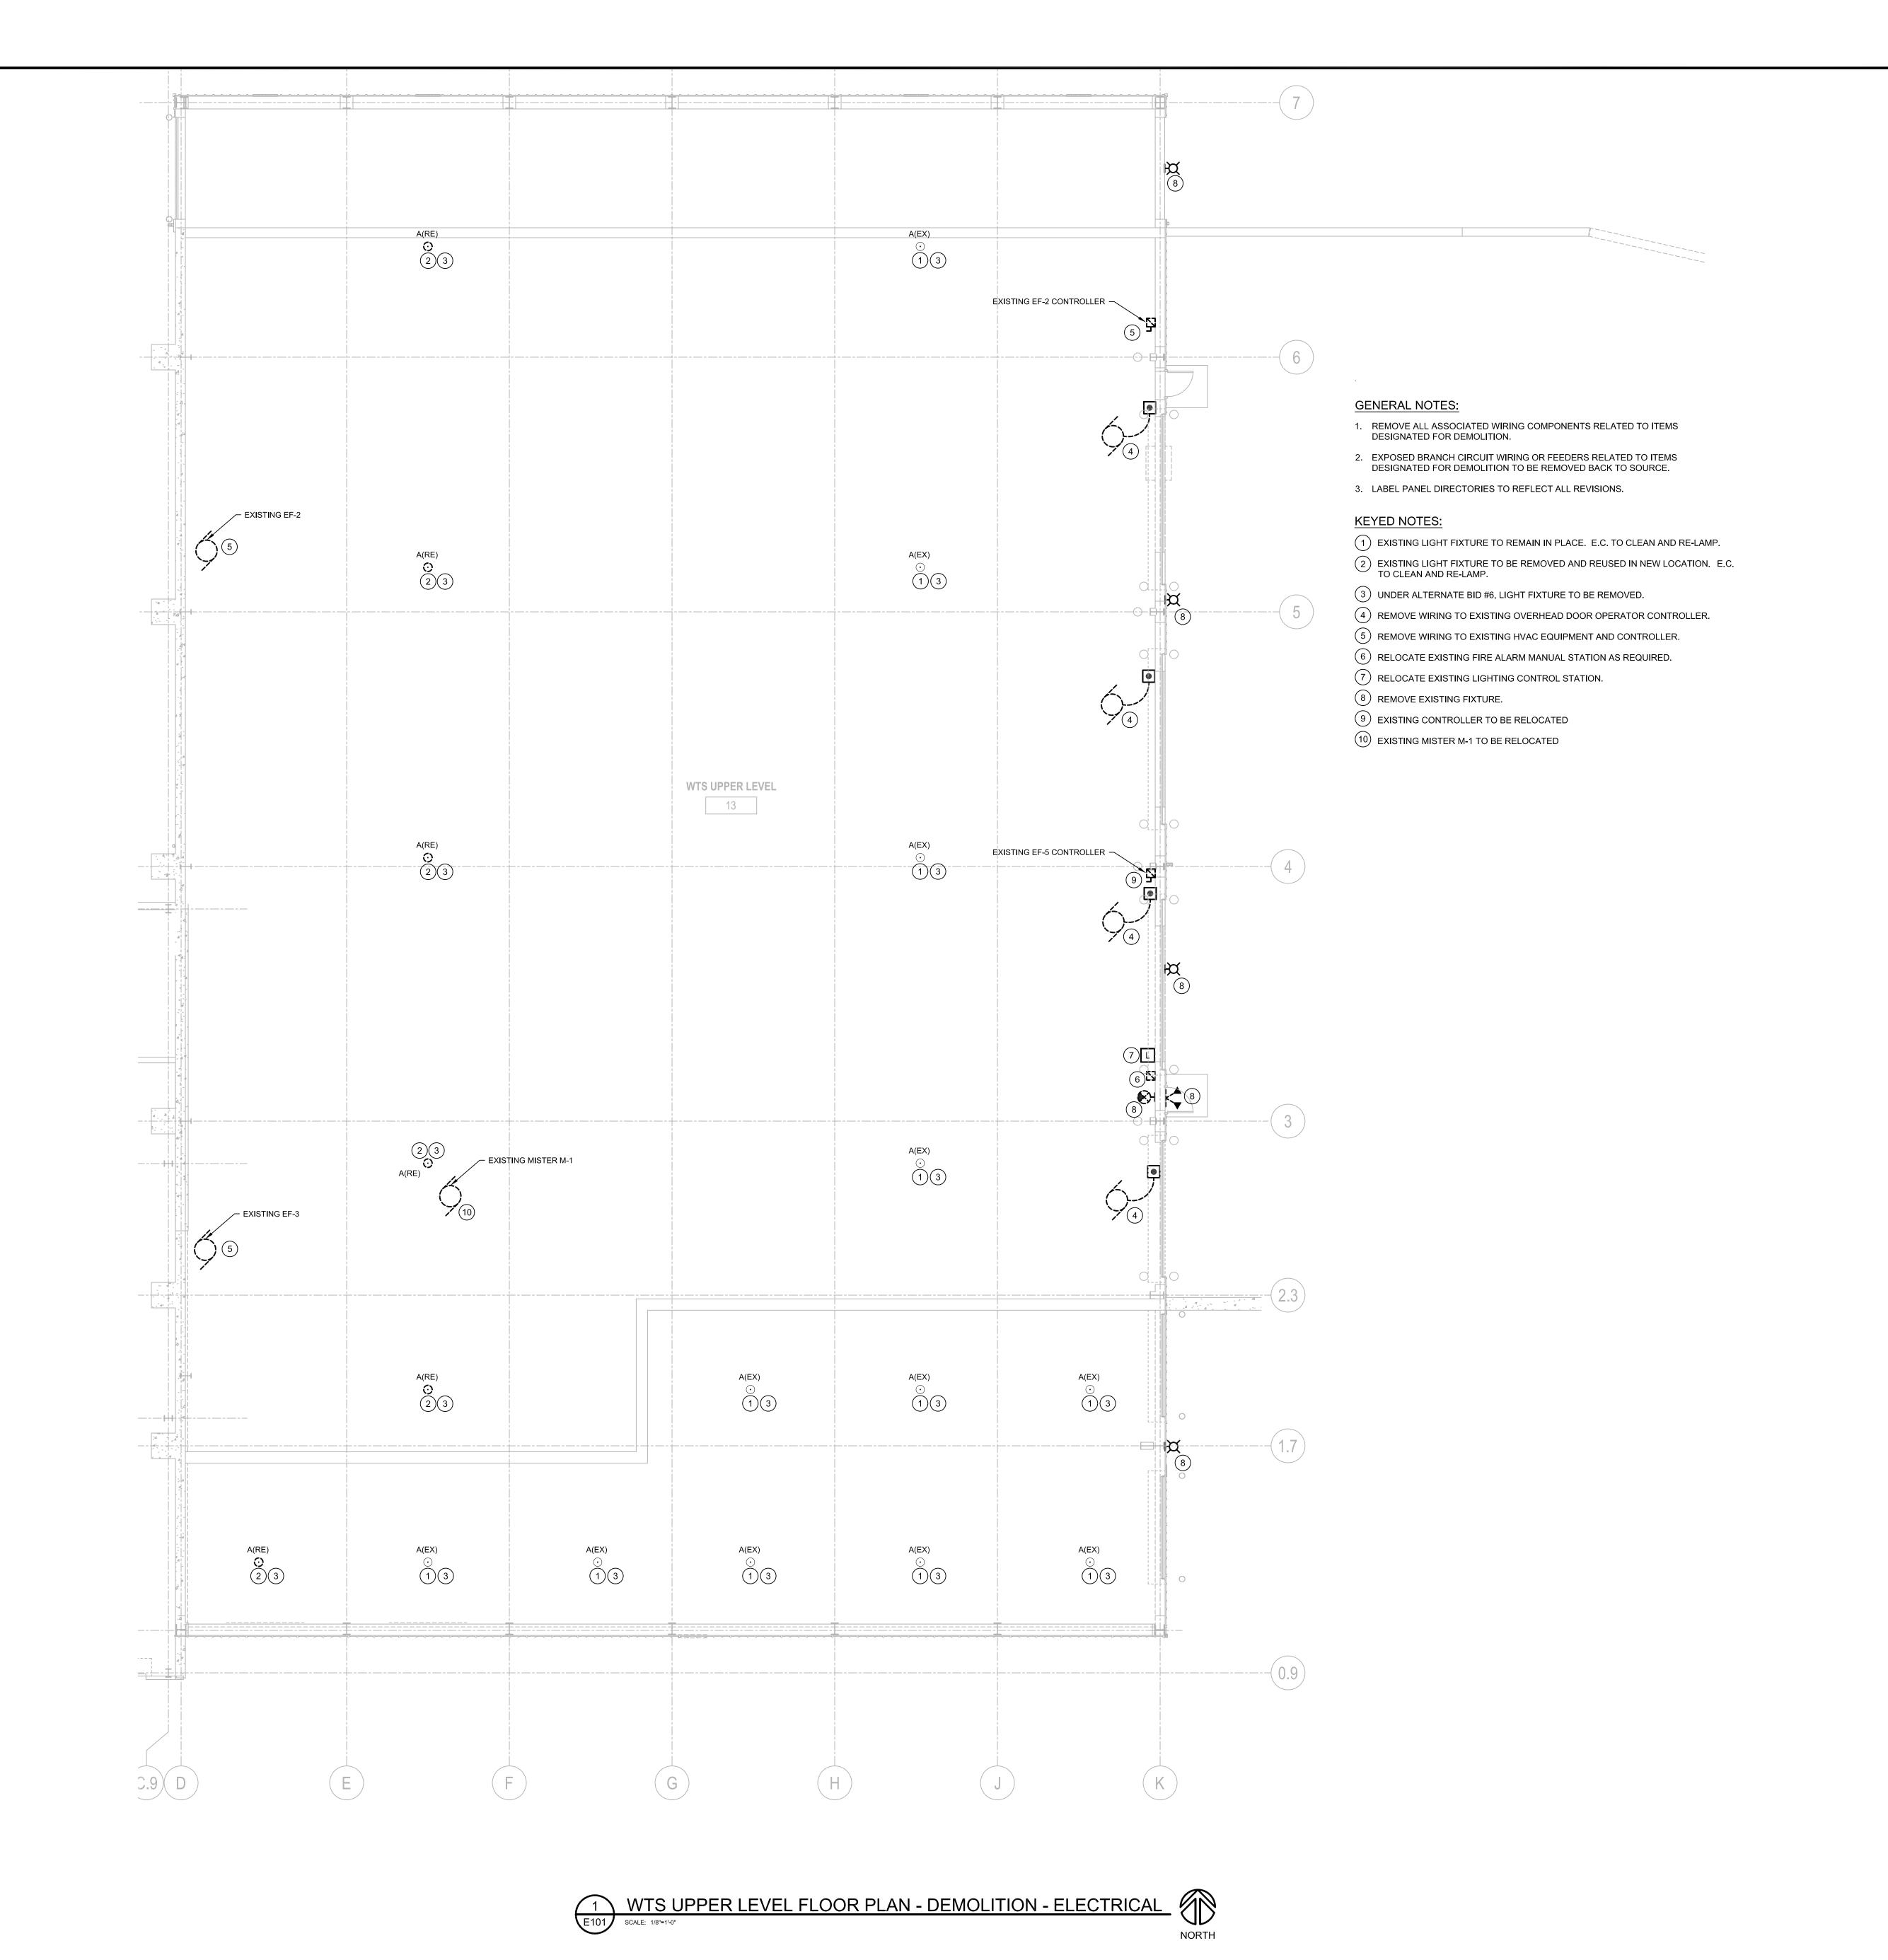ENGINEERING, INC.
5525 NOBEL DRIVE
SUITE 110
MADISON, WI 53711

CONSTRUCTION AND DEMOLITION WASTE RECYCLING FACILITY 7102 US HIGHWAY 12/18 MADISON, WISCONSIN

ph:608.277.1728 fax:608.271.7046 JDR Project No. 150012

DANE COUNTY DEPARTMENT OF
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1919 ALLIANT ENERGY CENTER WAY
MADISON, WI 53713

PROCCESS AND CIVIL ENGINEER:

SCS ENGINEERS 2830 DAIRY DRIVE MADISON, WI 53718-6751 (608) 224-2830

ARCHITECT:

DORSCHNER ASSOCIATES, INC.

849 E. WASHINGTON AVE., SUITE 112

MADISON, WI 53703

STRUCTURAL ENGINEER:
PIERCE ENGINEERS, INC.
10 WEST MIFFLIN ST., SUITE 205
MADISON, WI 53703

MECHANICAL, ELECTRICAL, PLUMBING DESIGN

JDR ENGINEERING, INC.

5525 NOBEL DRIVE, SUITE 110

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DRAWN: 04/28/15

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DRAWN BY: JDR


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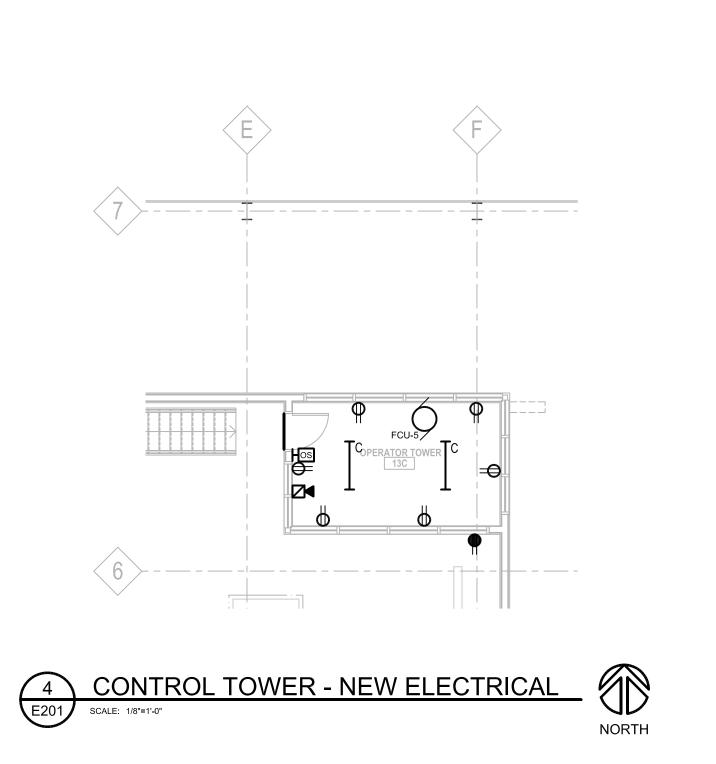
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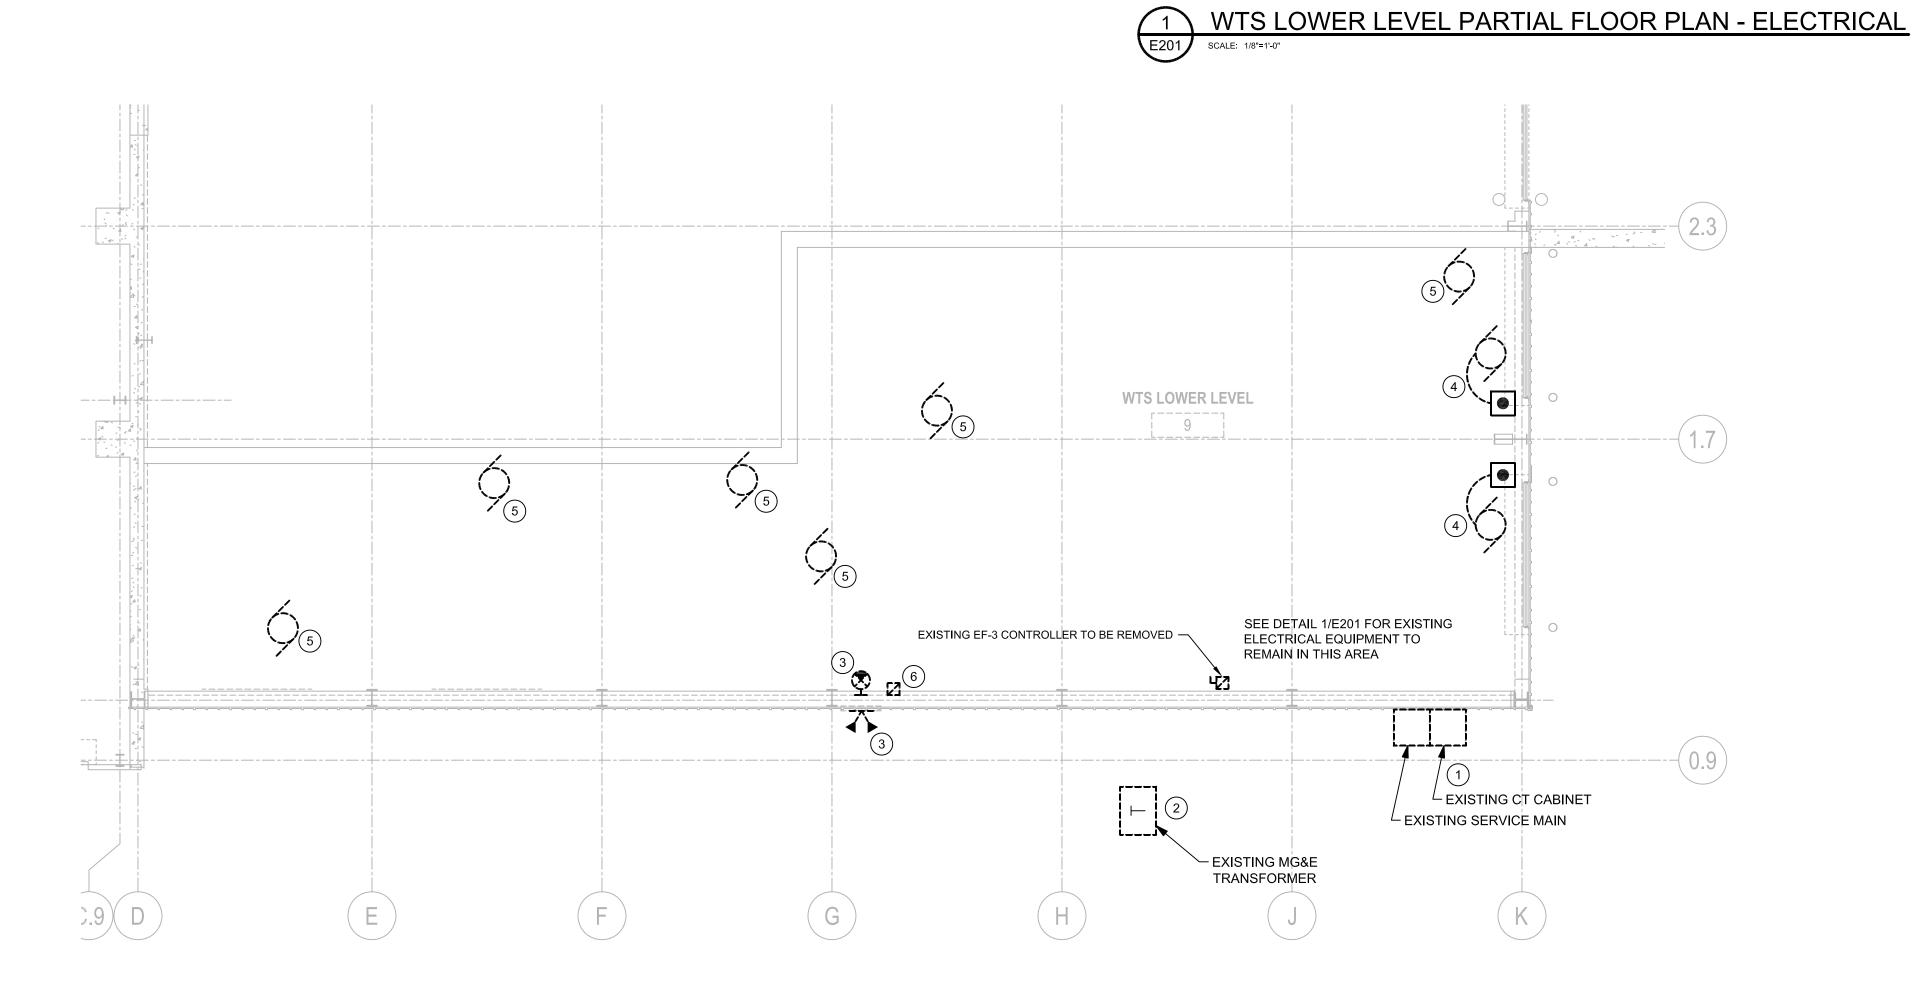
BID DOCUMENTS ISSUED 04/28/15

WTS UPPER LEVEL FLOOR PLAN -DEMOLITION - ELECTRICAL

> SHEET NUMBER **E101**





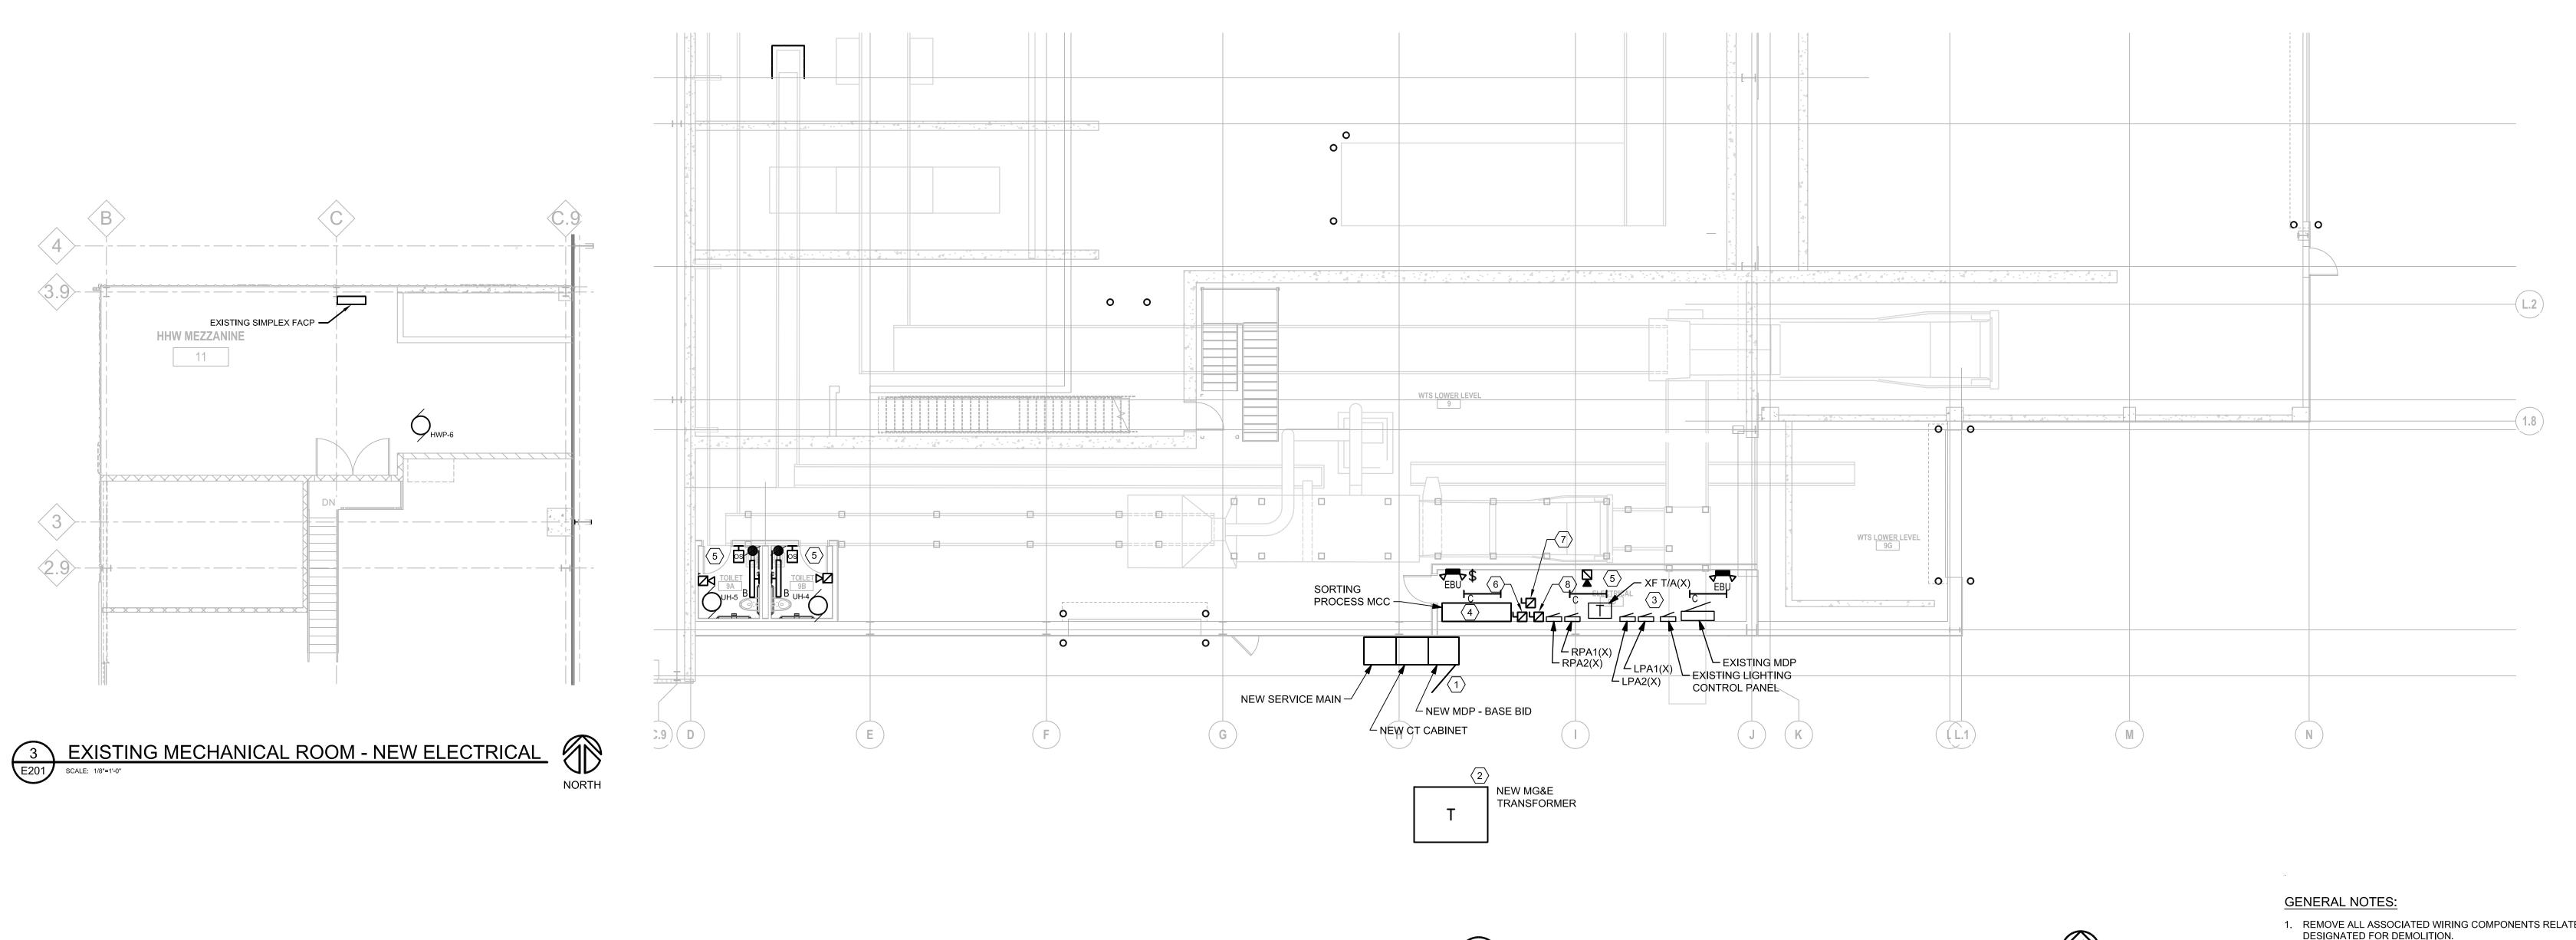

- 1. REMOVE ALL ASSOCIATED WIRING COMPONENTS RELATED TO ITEMS DESIGNATED FOR DEMOLITION.
- 2. EXPOSED BRANCH CIRCUIT WIRING OR FEEDERS RELATED TO ITEMS DESIGNATED FOR DEMOLITION TO BE REMOVED BACK TO SOURCE.
- 3. LABEL PANEL DIRECTORIES TO REFLECT ALL REVISIONS.
- 4. EC TO RELOCATE AND/OR ADD FIRE ALARM SYSTEM ANNUNCIATION DEVICES AS REQUIRED TO MEET AUDIBLE AND VISUAL REQUIREMENTS OF NFPA 72 AND CITY OF MADISON CODES IN ADDITION TO DEVICES INDICATED ON DRAWING. PROVIDE ALL REQUIRED SYSTEM COMPONENTS. COORDINATE DEVICE LOCATIONS WITH NEW PROCESS EQUIPMENT. REVISIONS TO THE EXISTING SIMPLEX FIRE ALARM SYSTEM ARE TO BE SUBMITTED TO THE LOCAL AHJ FOR APPROVAL.

DEMOLITION KEYED NOTES:

- 1 EXISTING SERVICE MAIN DISCONNECT AND CT CABINET TO BE DISCONNECTED AND REMOVED AFTER NEW SERVICE IS ENERGIZED. COORDINATE SERVICE SHUT-DOWN WITH MG&E AND OWNER. SCHEDULE SHUT-DOWN TO MINIMIZE DISRUPTION OF NORMAL OPERATION.
- 2 EC TO REMOVE EXISTING TRANSFORMER PAD AFTER REMOVAL OF TRANSFORMER BY MG&E.
- (3) EXISTING FIXTURE TO BE REMOVED
- REMOVE WIRING TO EXISTING OVERHEAD DOOR OPERATOR AND CONTROLLER.
- 5) REMOVE WIRING TO EXISTING PROCESS EQUIPMENT.
- (6) RELOCATE EXISTING FIRE ALARM MANUAL STATION AS REQUIRED.

NEW WORK KEYED NOTES:

- (1) PROVIDE NEW SERVICE MAIN DISCONNECT, CT CABINET AND MAIN DISTRIBUTION PANEL. EQUIPMENT SHALL BE IN NEMA 4 ENCLOSURES. PROVIDE CONCRETE EQUIPMENT PAD FOR NEW EQUIPMENT. SEE ONE-LINE DIAGRAM FOR ADDITIONAL INFORMATION.
- (2) PROVIDE SERVICE ENTRANCE PER MG&E REQUIREMENTS. COORDINATE EXACT LOCATION OF TRANSFORMER PAD FOR NEW MG&E TRANSFORMER WITH MG&E AND LOCATION OF PROCESS COMPONENTS ON THE SITE.
- (3) RE-FEED EXISTING MDP FROM NEW MDP. EXISTING ELECTRICAL DISTRIBUTION EQUIPMENT IN THIS ROOM TO REMAIN AND BE REUSED.
- (4) NEW SORTING PROCESS MOTOR CONTROL CENTER TO BE FURNISHED BY PROCESS EQUIPMENT CONTRACTOR. EC TO INSTALL MCC AND FEEDER FRO NEW MDP. ALL WIRING FROM MCC TO PROCESS EQUIPMENT TO BE INSTALLE BY PROCESS EQUIPMENT CONTRACTOR.
- (5) CONNECT NEW LIGHT FIXTURES TO EXISTING UNSWITCHED LIGHTING CIRCL SERVING THE AREA. CONNECT RECEPTACLES TO SPARE BREAKER IN PANEL
- $\overline{\left\langle 6\right\rangle }$ EXISTING EF-4 CONTROLLER TO REMAIN.
- $\langle 7 \rangle$ NEW EF-11 CONTROLLER LOCATION.
- (8) RELOCATED EF-5 CONTROLLER LOCATION.

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CUIT	REVISION	DATE	BY	TITLE
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	PROJECT	NO.		25214236.00
	DRAWN:			04/28/15
	REVISED:			04/28/15
	DRAWN B	Y:		JDR
	CHECKED	BY:		JDR
	APPROVED	BY:		

SCS ENGINEERS

2830 DAIRY DRIVE MADISON, WI 53718-6751 PHONE: (608) 224-2830

ENGINEERING, INC. 5525 NOBEL DRIVE SUITE 110 MADISON, WI 53711 ph:608.277.1728 fax:608.271.7046 JDR Project No. 150012

CONSTRUCTION AND **DEMOLITION WASTE** RECYCLING FACILITY 7102 US HIGHWAY 12/18 MADISON, WISCONSIN

DANE COUNTY DEPARTMENT OF PUBLIC WORKS SOLID WASTE DIVISION 1919 ALLIANT ENERGY CENTER WAY

MADISON, WI 53713

PROCCESS AND CIVIL ENGINEER:

MADISON, WI 53718-6751

DORSCHNER ASSOCIATES, INC.

O WEST MIFFLIN ST., SUITE 205

MECHANICAL, ELECTRICAL, PLUMBING

5525 NOBEL DRIVE, SUITE 110

849 E. WASHINGTON AVE., SUITE 112

SCS ENGINEERS 2830 DAIRY DRIVE

(608) 224-2830

MADISON, WI 53703

STRUCTURAL ENGINEER: PIERCE ENGINEERS, INC.

MADISON, WI 53703

JDR ENGINEERING, INC.

MADISON, WI 53711

ARCHITECT:


DESIGN

BID DOCUMENTS ISSUED 04/28/15

PARTIAL FLOOR PLANS -**ELECTRICAL**

SHEET NUMBER E201

2 WTS LOWER LEVEL PARTIAL FLOOR PLAN - DEMOLITION E201 SCALE: 1/8"=1"-0"

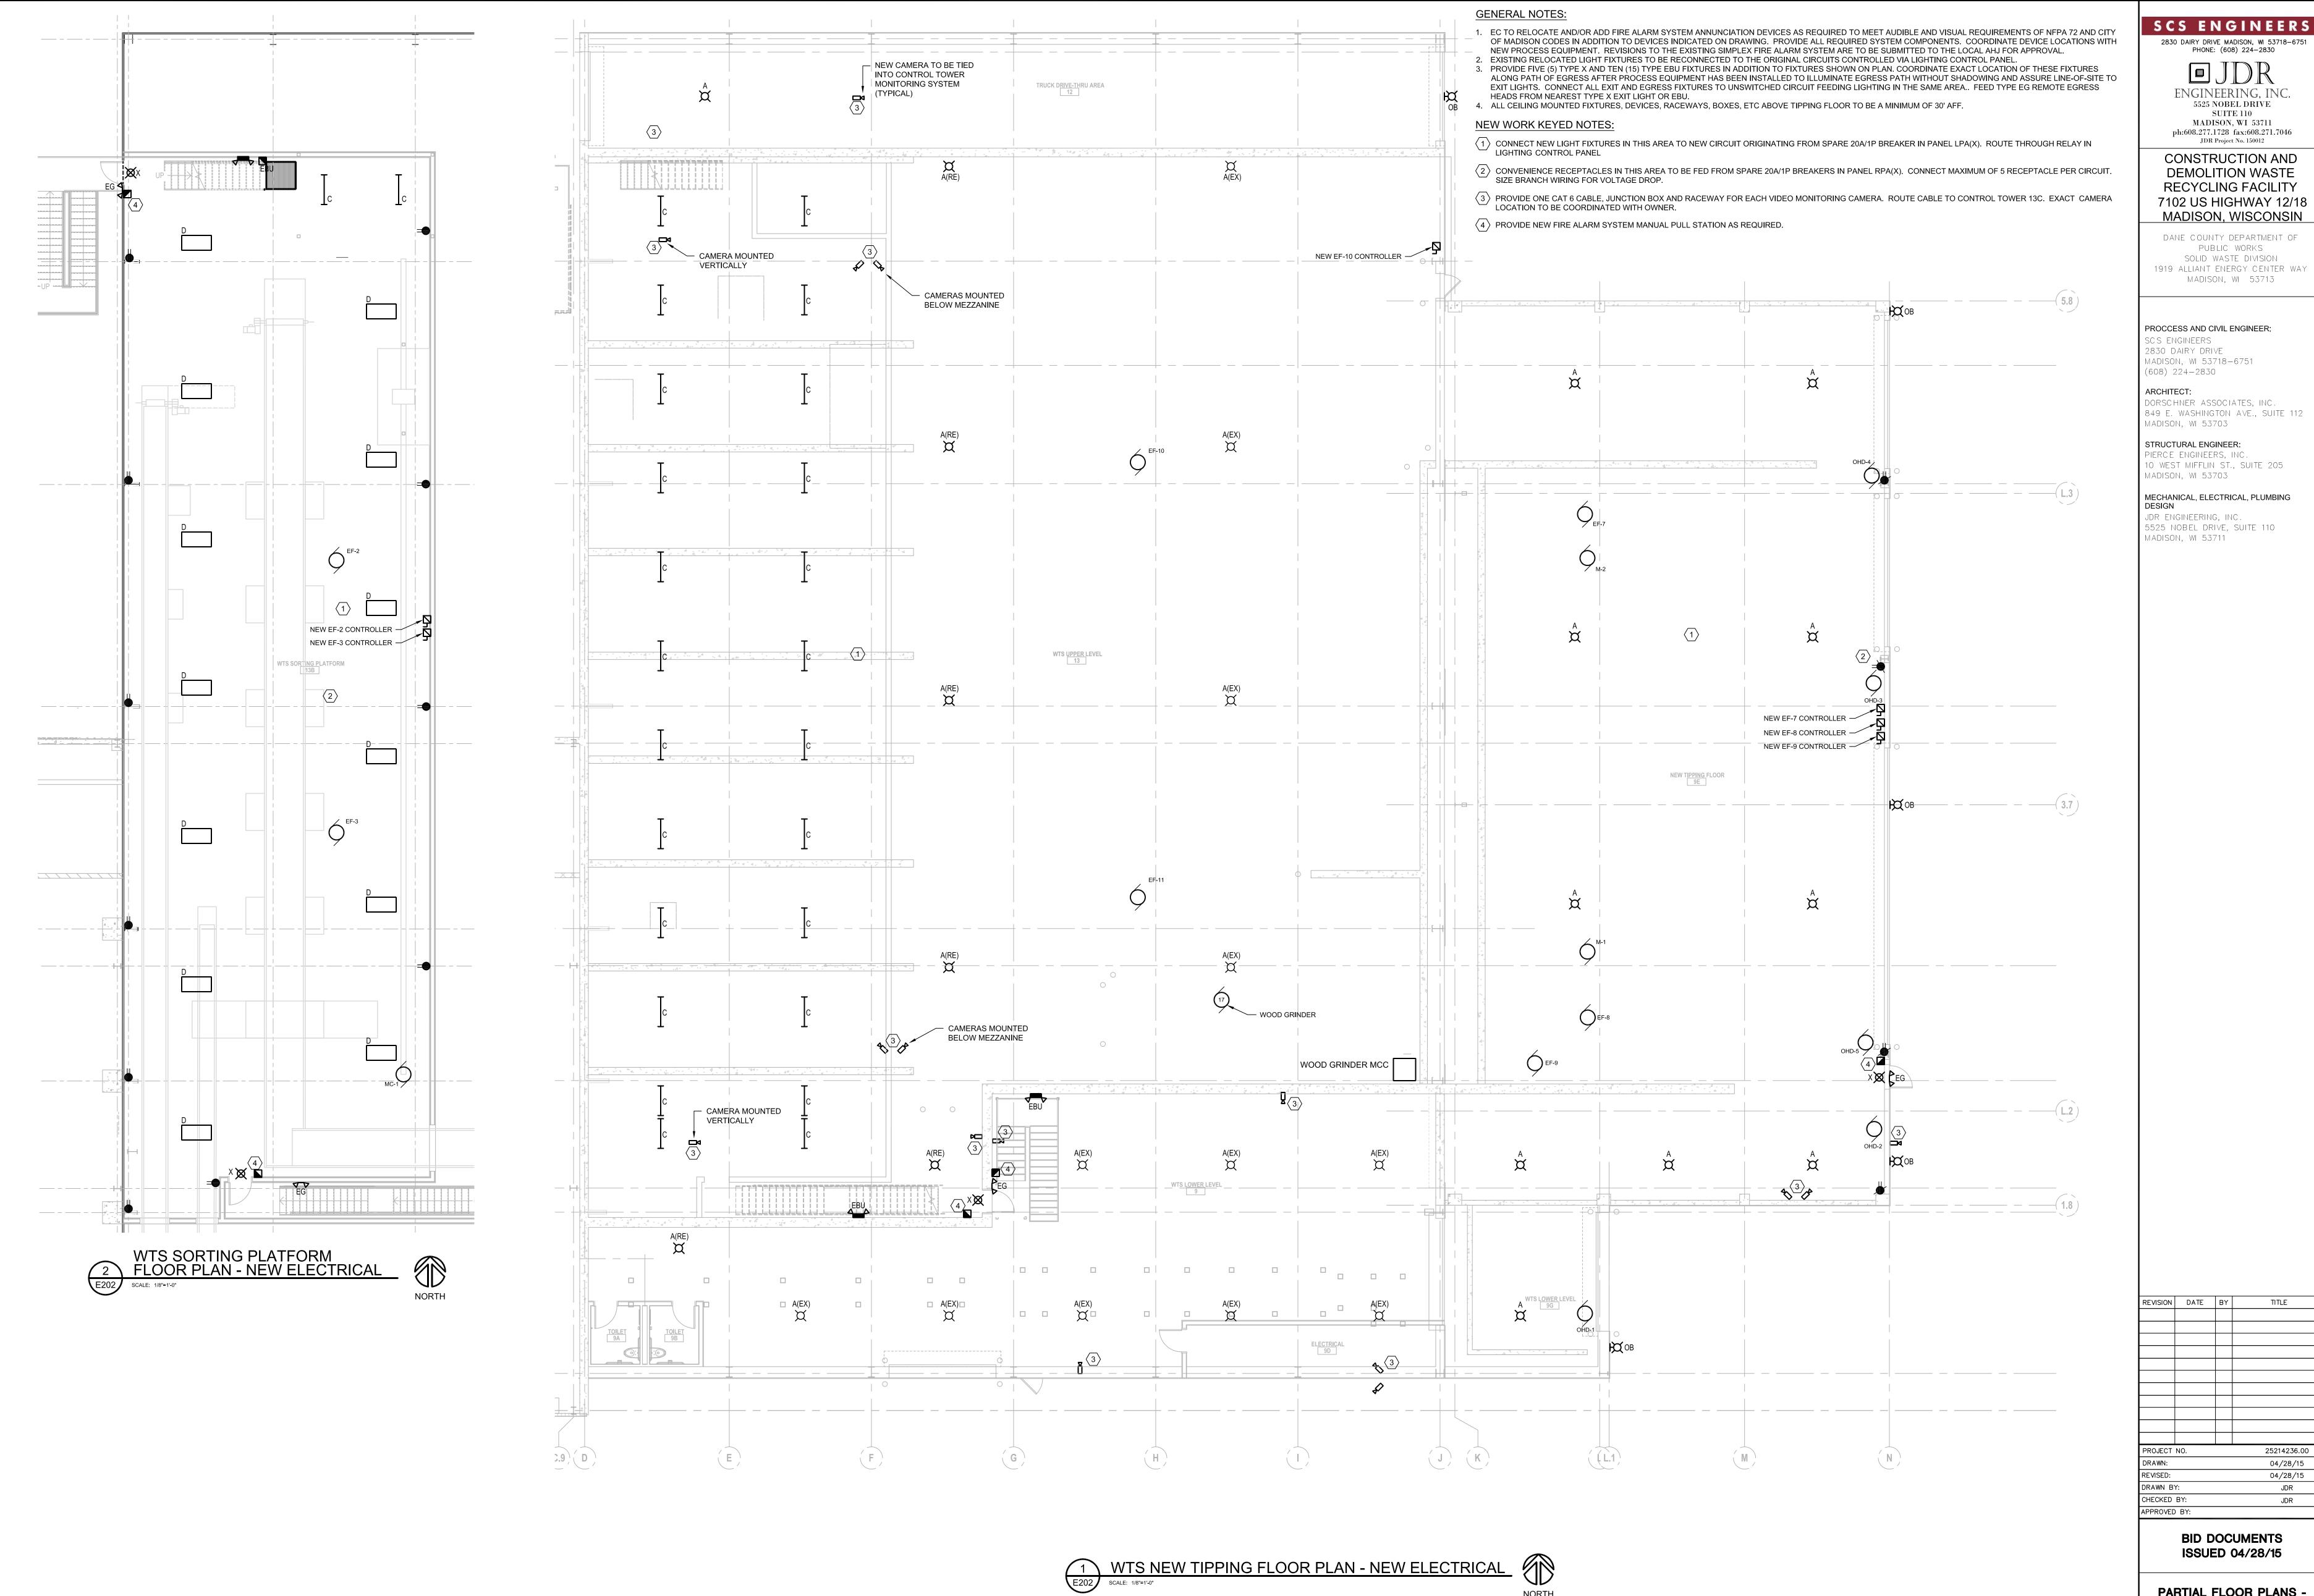

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SUITE 110

7102 US HIGHWAY 12/18 MADISON, WISCONSIN DANE COUNTY DEPARTMENT OF PUBLIC WORKS

MADISON, WI 53713

SOLID WASTE DIVISION

PROCCESS AND CIVIL ENGINEER:

SCS ENGINEERS 2830 DAIRY DRIVE MADISON, WI 53718-6751

(608) 224-2830 ARCHITECT: DORSCHNER ASSOCIATES, INC. 849 E. WASHINGTON AVE., SUITE 112

MADISON, WI 53703 STRUCTURAL ENGINEER: PIERCE ENGINEERS, INC.

O WEST MIFFLIN ST., SUITE 205 MADISON, WI 53703 MECHANICAL, ELECTRICAL, PLUMBING

JDR ENGINEERING, INC. 5525 NOBEL DRIVE, SUITE 110 MADISON, WI 53711


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> **BID DOCUMENTS** ISSUED 04/28/15

PARTIAL FLOOR PLANS -**ELECTRICAL**

SHEET NUMBER E202



EQUIPMENT #19

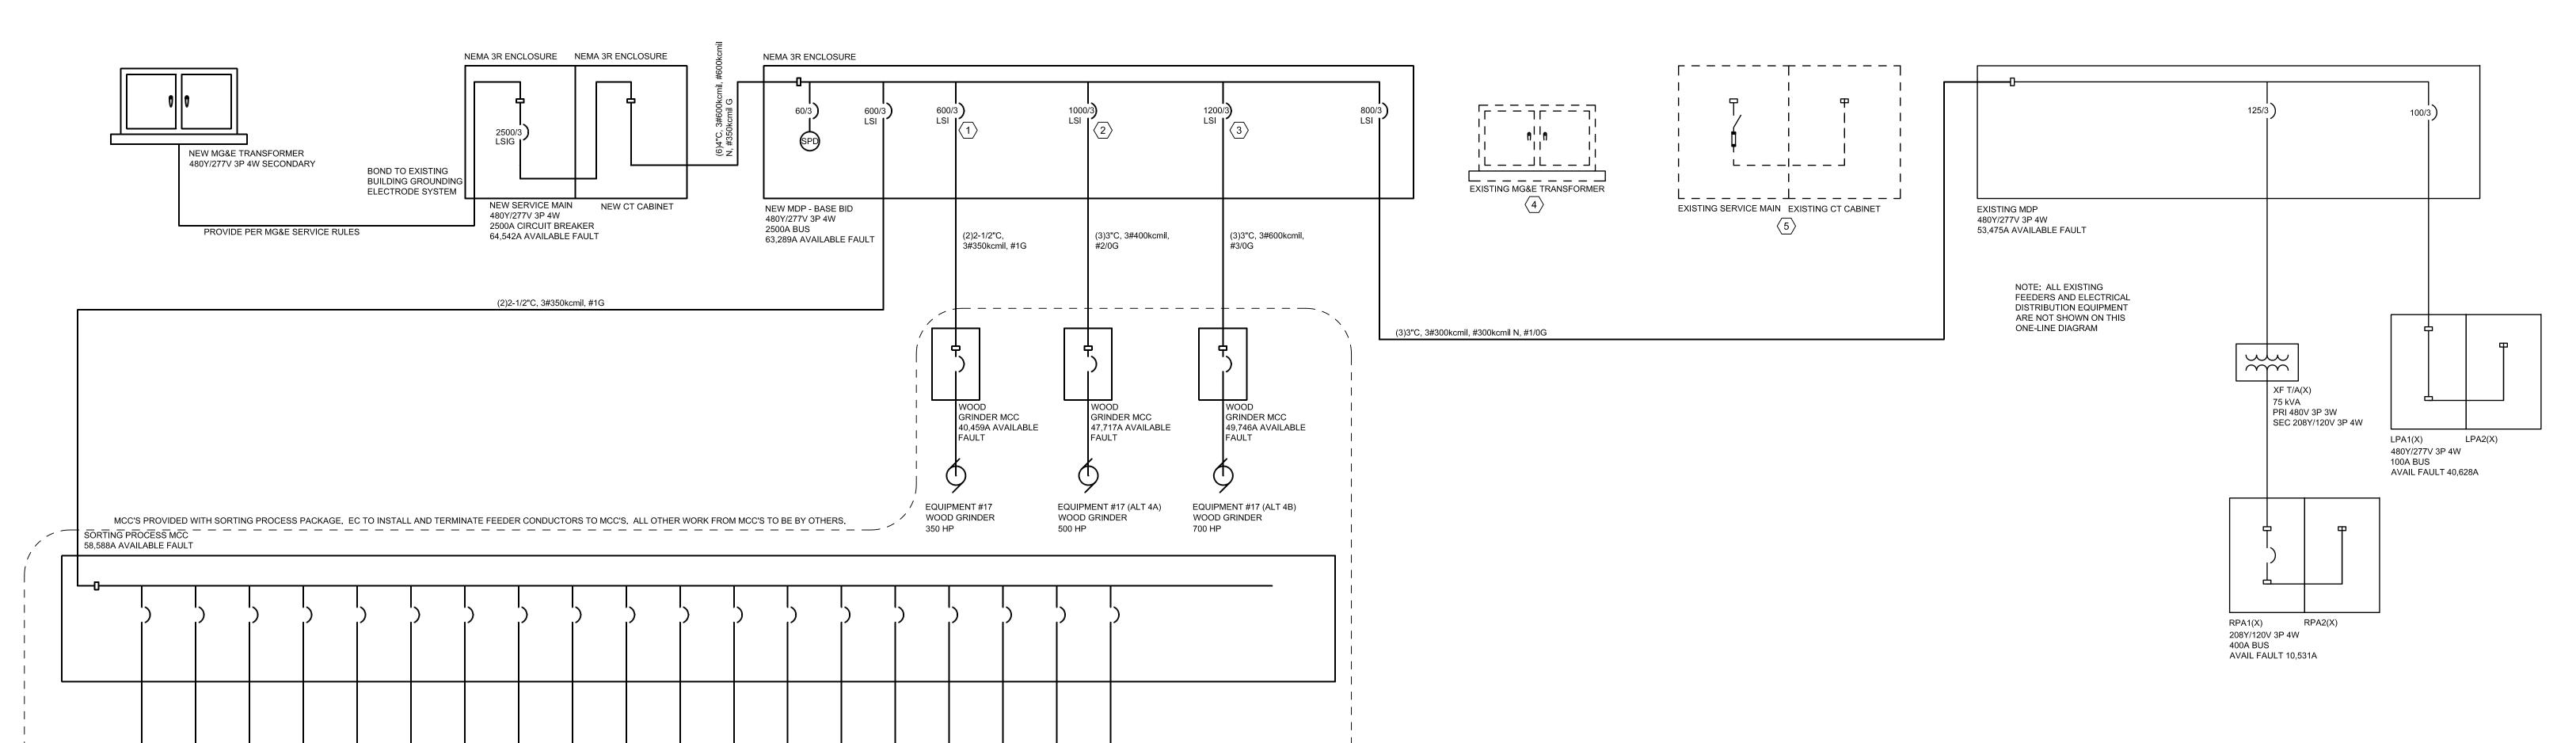WOOD GRINDER

DUST CONTROL

EQUIPMENT #20

60 HP

CARDBOARD BALER

1 ONE-LINE DIAGRAM SCALE: NONE

EQUIPMENT #7

DE-STONER/AIR

EQUIPMENT #9

CONVEYOR

10 HP

EQUIPMENT #8

(DE-STONER/AIR

KNIFE OUTFEED)

SLIDER BED

CONVEYOR

(PICKING B-LINE)

EQUIPMENT #10

CONVEYOR (SM

INFORMATION SHOWN WITHIN THIS AREA IS BASED ON PRELIMINARY INFORMATION AND IS SHOWN FOR CALCULATION PURPOSES ONLY.

5 HP

TROUGHING IDLER

RESIDUAL BUNKER)

TROUGHING IDLER

(PRIMARY FINGER

EQUIPMENT #12

CONVEYOR (FINES

BUNKER INFEED

SCREEN UNDERS)

COLLECTOR/FILTER

CONVEYOR

PLATFORM)

7.5 HP

EQUIPMENT #14

AGGREGATE

(SLIDING BELT)

CONVEYOR

(AGGREGATE ON

EQUIPMENT #18

WOOD CONVEYOR

CONVEYOR

EQUIPMENT #5

CONVEYOR

EQUIPMENT #4B

MAGNET RECTIFIER

(SECONDARY

FINGER SCREEN

EQUIPMENT #6

FINGER SCREEN

SECONDARY

50 HP

SLIDING BED

EQUIPMENT #3

10 HP

PICKING A-LINE

APRON CONVEYOR

CONVEYOR

(OVERS)


15 HP

EQUIPMENT #1

SCREEN

50 HP

PRIMARY FINGER

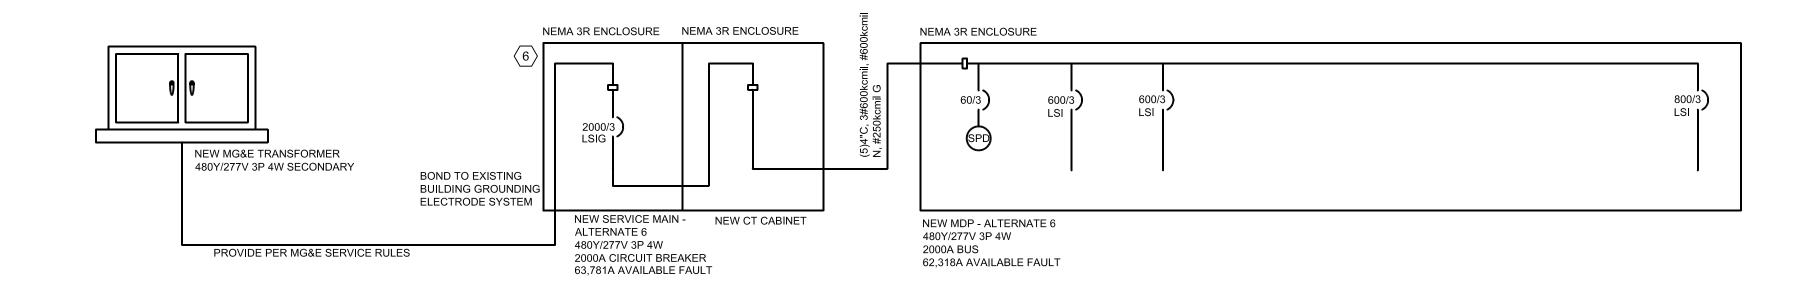

PARTIAL ONE-LINE DIAGRAM - ALTERNATE 6

SCALE: NONE

GENERAL NOTES:

- DASHED LINES INDICATE EQUIPMENT TO BE REMOVED.
 LIGHTER LINES INDICATE EXISTING EQUIPMENT TO REMAIN.
- HEAVIER LINES INDICATE NEW EQUIPMENT.
 SEE SHEET E800 FOR LOAD SCHEDULES AND PRELIMINARY FAULT CURRENT CALCULATIONS.

KEYED NOTES:

- $\fbox{1}$ BASE BID TO INCLUDE CIRCUIT BREAKER AND ASSOCIATED WIRING FOR A 350 HP WOOD GRINDER.
- 2 ALTERNATE BID 4A TO INCLUDE CIRCUIT BREAKER AND ASSOCIATED WIRING FOR A 500 HP WOOD GRINDER IN LIEU OF THE 350 HP WOOD GRINDER.
- 3 ALTERNATE BID 4B TO INCLUDE CIRCUIT BREAKER AND ASSOCIATED WIRING FOR A 700 HP WOOD GRINDER IN LIEU OF THE 350 HP WOOD GRINDER.
- 4 EXISTING UTILITY TRANSFORMER TO BE REMOVED BY MG&E. EC TO REMOVE TRANSFORMER PAD.
- (5) EXISTING EXTERIOR SWITCHGEAR AND ASSOCIATED EQUIPMENT PAD TO BE REMOVED BY EC.
- 6 ALTERNATE BID 6 TO INCLUDE 2000 AMP SERVICE EQUIPMENT AND FEEDERS AS INDICATED IN DETAIL 2/E600 IN LIEU OF 2500 AMP SERVICE EQUIPMENT.

SCS ENGINEERS

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CONSTRUCTION AND DEMOLITION WASTE RECYCLING FACILITY 7102 US HIGHWAY 12/18 MADISON, WISCONSIN

JDR Project No. 150012

DANE COUNTY DEPARTMENT OF
PUBLIC WORKS
SOLID WASTE DIVISION
1919 ALLIANT ENERGY CENTER WAY
MADISON, WI 53713

PROCCESS AND CIVIL ENGINEER:

SCS ENGINEERS 2830 DAIRY DRIVE MADISON, WI 53718-6751 (608) 224-2830


MADISON, WI 53703

ARCHITECT:
DORSCHNER ASSOCIATES, INC.
849 E. WASHINGTON AVE., SUITE 112
MADISON, WI 53703

STRUCTURAL ENGINEER:
PIERCE ENGINEERS, INC.
10 WEST MIFFLIN ST., SUITE 205

MECHANICAL, ELECTRICAL, PLUMBING DESIGN

JDR ENGINEERING, INC. 5525 NOBEL DRIVE, SUITE 110 MADISON, WI 53711

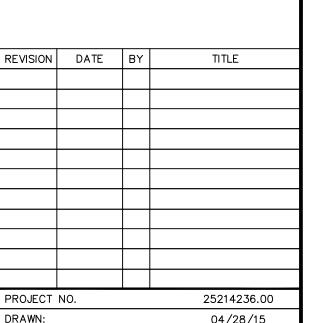

 PROJECT NO.
 25214236.00

 DRAWN:
 04/28/15

 REVISED:
 04/28/15

 DRAWN BY:
 JDR

 CHECKED BY:
 JDR

 APPROVED BY:

BID DOCUMENTS ISSUED 04/28/15

ONE-LINE DIAGRAM ELECTRICAL

SHEET NUMBER **E600**

NEW MDP - ALTERNATE 4B ROOM OUTDOORS **VOLTS** 480Y/277V 3P 4W **AIC** 65,000 MOUNTING FLOOR MAIN BKR MLO **BUS AMPS** 2500 FED FROM NEW CT CABINET NEUTRAL 100% LUGS STANDARD NOTE CKT BREAKER TRIP/POLES CIRCUIT DESCRIPTION LOAD KVA FEEDER RACEWAY AND CONDUCTORS 52.5 | 52.6 | 52.5 | (3)3"C,3#300kcmil,#300kcmil N,#1/0G 800/3 SWITCHBOARD EXISTING MDP 130 | 130 | 130 | (2)2-1/2"C,3#350kcmil,#1G 600/3 MCC SORTING PROCESS MCC 1200/3 MCC WOOD GRINDER MCC 230 230 230 (3)3"C,3#600kcmil,#3/0G 400/3 SPACE 400/3 SPACE 0 0 0 60/3 SPD 0 0 0 TOTAL CONNECTED KVA BY PHASE | 413 | 413 | 413 CONN KVA CALC KVA CONN KVA CALC KVA LIGHTING CONTINUOUS LARGEST MOTOR 690 863 (125%) **HEATING** (N/A)OTHER MOTORS 417 417 (100%) COOLING (N/A) RECEPTACLES (50%>10) NONCONTINUOUS 0 (N/A) (N/A) KITCHEN EQUIP 0 DIVERSE **METERED DEMAND** 270 (125%) 338 TOTAL KVA 1,480 1,720 BALANCED 3-PHASE AMPS 2,070

DEVICE	FAULT	AIC RATING	L-N VOLTS	UTILITY	FED FROM		FEEDER
				FAULT	DEVICE	FAULT	SIZE
NEW MG&E TRANSFORMER	70,227	100,000	277V	65,000			
NEW SERVICE MAIN	66,167	100,000	277V	60,911	NEW MG&E TRANSFORMER	65,000	(6)#600kcmil
NEW CT CABINET	65,834	100,000	277V	60,576	NEW SERVICE MAIN	60,911	(6)#600kcmil
NEW MDP - ALTERNATE 4B	64,919	65,000	277V	59,654	NEW CT CABINET	60,576	(6)#600kcmil
EXISTING MDP	54,624	65,000	277V	50,829	NEW MDP - ALTERNATE 4B	59,654	(3)#300kcmi
LPA1(X)	41,237	42,000	277V	39,114	EXISTING MDP	50,829	#3
LPA2(X)	37,692	42,000	277V	35,931	LPA1(X)	39,114	#3
XF T/A(X)	10,601	22,000	120V	10,529	EXISTING MDP	50,829	#1
RPA1(X)	10,550	22,000	120V	10,478	XF T/A(X)	10,529	#600kcmil
RPA2(X)	10,470	22,000	120V	10,399	RPA1(X)	10,478	#600kcmil
SORTING PROCESS MCC	62,510	65,000	277V	57,496	NEW MDP - ALTERNATE 4B	59,654	(2)#350kcmi
WOOD GRINDER MCC	49,746	65,000	277V	45,286	NEW MDP - ALTERNATE 4B	59,654	(3)#600kcmi

	$\overline{=} \bigvee M$	DP	— <i>/</i>	\ LTE	RN	A		4					
MOUN	OUTDOORS TING FLOOR FROM NEW C	T CABINE	Т	VOLTS BUS AN NEUTRA	IPS 2		5P 4W			55,000 BKR MLO STANDARD			
CKT	BREAKER TRIP/POLES	CIRCUIT	DESCRIPTION				OAD KV		FEEDER RACEWAY	AND CONDUC	TARS		
#	IKIP/PULES	CIRCUIT	DESCRIP HON			Α	В	С	FEEDER RACEWAT	AND CONDOC	IUKS		
1	800/3	SWITCHE	BOARD EXISTIN	NG MDP		52.5	52.6	52.5	(3)3"C,3#300kcr	mil,#300kcm	ii N,#1/0G		
2	600/3		RTING PROCE			130	130	130	(2)2-1/2"C,3#3				
3	1000/3		OOD GRINDER			164	164	164	(3)3"C,3#400kcr	•••			
4	400/3	SPACE				0	0	0	(0)0 0,0 100.000	,,,,,,,,,,,,,,,,,,,,,,,,,,,,,,,,,,,,			
5	400/3	SPACE				0	0	0					
6	600/3	SPD				0	0	0					
		TOT	AL CONNECTE	D KVA BY P	HASE	346	346	346					
			CONN KVA	CALC KVA						CONN KVA	CALC KVA		
	LIGHTING		0	0	(125%	3		C	ONTINUOUS	10	12.5	(125%)	
	LARGEST	MOTOR	491	613	(125%	•			EATING	0	0	(N/A)	
	OTHER M		417	417	(100%	•			DOLING	0	0	(N/A)	
	RECEPTAG		0	0	(50%)	•			ONCONTINUOUS	0	0	(100%)	
	KITCHEN		0	0	(N/A)	•			VERSE	0	0	(N/A)	
	MIOHEN	LWUII	J	J	(11/ 7)	,			ETERED DEMAND	270	338	(125%)	
								T	OTAL KVA	1,280	1,470	- *	
									ALANCED 3-PHAS	•	1,770		

DEVICE	FAULT	AIC RATING	L-N VOLTS	UTILITY	FED FROM		FEEDER
				FAULT	DEVICE	FAULT	SIZE
NEW MG&E TRANSFORMER	69,306	100,000	277V	65,000			
NEW SERVICE MAIN	65,236	100,000	277V	60,911	NEW MG&E TRANSFORMER	65,000	(6)#600kcmil
NEW CT CABINET	64,903	100,000	277V	60,576	NEW SERVICE MAIN	60,911	(6)#600kcmi l
NEW MDP - ALTERNATE 4A	63,986	65,000	277V	59,654	NEW CT CABINET	60,576	(6)#600kcmil
EXISTING MDP	53,967	65,000	277V	50,829	NEW MDP - ALTERNATE 4A	59,654	(3)#300kcmil
LPA1(X)	40,890	42,000	277V	39,114	EXISTING MDP	50,829	#3
LPA2(X)	37,411	42,000	277V	35,931	LPA1(X)	39,114	#3
XF T/A(X)	10,590	22,000	120V	10,529	EXISTING MDP	50,829	#1
RPA1(X)	10,539	22,000	120V	10,478	XF T/A(X)	10,529	#600kcmil
RPA2(X)	10,459	22,000	120V	10,399	RPA1(X)	10,478	#600kcmil
SORTING PROCESS MCC	61,646	65,000	277V	57,496	NEW MDP - ALTERNATE 4A	59,654	(2)#350kcmi
WOOD GRINDER MCC	47,717	65,000	277V	44,275	NEW MDP - ALTERNATE 4A	59,654	(3)#400kcmi

MOUN		Γ CABINE	Т	VOLTS BUS AN NEUTRA	MPS 2	500	3P 4W		MAIN	65,000 BKR MLO STANDARD		
CKT #	BREAKER TRIP/POLES	CIRCUIT	DESCRIPTION	l		A	OAD KV B	A C	FEEDER RACEWAY	AND CONDUC	TORS	
1 2 3 4 5 6	800/3 600/3 600/3 400/3 400/3 60/3	MCC SC	BOARD EXISTI PRTING PROCE DOD GRINDER	SS MCC		52.5 130 115 0 0	52.6 130 115 0 0	52.5 130 115 0 0	(3)3"C,3#300kd (2)2-1/2"C,3#3 (2)2-1/2"C,3#3 - - -	350kcmil,#1G	il N,#1/0G	
		TOT	AL CONNECTE	D KVA BY P	PHASE	297	298	297				
	LIGHTING LARGEST OTHER MO RECEPTAC KITCHEN	OTORS CLES	CONN KVA 0 344 417 0 0	CALC KVA 0 430 417 0 0	(125% (125% (100% (50%) (N/A)	() () -10)		H C N D	CONTINUOUS JEATING COOLING JONCONTINUOUS DIVERSE JETERED DEMAND	CONN KVA 10 0 0 0 0 270 1,140	CALC KVA 12.5 0 0 0 0 338 1,290	(125%) (N/A) (N/A) (100%) (N/A) (125%)

DEVICE	FAULT	AIC RATING	L-N VOLTS	UTILITY	FED FROM	FEEDER	
				FAULT	DEVICE	FAULT	SIZE
NEW MG&E TRANSFORMER	68,617	100,000	277V	65,000			
NEW SERVICE MAIN	64,542	100,000	277V	60,911	NEW MG&E TRANSFORMER	65,000	(6)#600kcm
NEW CT CABINET	64,208	100,000	277V	60,576	NEW SERVICE MAIN	60,911	(6)#600kcm
NEW MDP - BASE BID	63,289	65,000	277V	59,654	NEW CT CABINET	60,576	(6)#600kcm
EXISTING MDP	53,475	65,000	277V	50,829	NEW MDP - BASE BID	59,654	(3)#300kcm
LPA1(X)	40,628	42,000	277V	39,114	EXISTING MDP	50,829	#3
LPA2(X)	37,198	42,000	277V	35,931	LPA1(X)	39,114	#3
XF T/A(X)	10,582	22,000	120V	10,529	EXISTING MDP	50,829	#1
RPA1(X)	10,531	22,000	120V	10,478	XF T/A(X)	10,529	#600kcmil
RPA2(X)	10,451	22,000	120V	10,399	RPA1(X)	10,478	#600kcmil
SORTING PROCESS MCC	61,001	65,000	277V	57,496	NEW MDP - BASE BID	59,654	(2)#350kcn
WOOD GRINDER MCC	40,998	65,000	277V	38,536	NEW MDP - BASE BID	59,654	(2)#350kcn

MOU		T CABINE	Т	BUS A	480Y MPS 2 AL 100		3P 4W		MAIN	BKR MLO STANDARD		
CKT	BREAKER					LOAD KVA						
#	TRIP/POLES	CIRCUIT	DESCRIPTION			Α	В	С	FEEDER RACEWAY	AND CONDUC	TORS	
1 2 3 4 5 6	2 600/3 MCC SORTING PROCESS MCC 600/3 MCC WOOD GRINDER MCC 400/3 SPACE 5 400/3 SPACE				52.5 130 115 0 0	52.6 130 115 0 0	52.5 130 115 0 0	(3)3"C,3#300kc (2)2-1/2"C,3#3 (2)2-1/2"C,3#3	The state of the s			
		TOT	AL CONNECTE	D KVA BY	PHASE	297	298	297				
			CONN KVA	CALC KVA						CONN KVA	CALC KVA	
	LIGHTING LARGEST OTHER M RECEPTA KITCHEN	OTORS CLES	0 344 417 0 0	0 430 417 0	(125% (125% (100% (50%) (N/A)	s) s) >10)		H () N	CONTINUOUS HEATING COOLING HONCONTINUOUS DIVERSE HETERED DEMAND	10 0 0 0 0 0 270	12.5 0 0 0 0 0 338	(125%) (N/A) (N/A) (100%) (N/A) (125%)

DEVICE	FAULT	AIC RATING	L-N VOLTS	UTILITY	FED FROM	FEEDER	
				FAULT	DEVICE	FAULT	SIZE
NEW MG&E TRANSFORMER	68,613	100,000	277V	65,000			
NEW SERVICE MAIN - ALTERNATE 6	63,781	100,000	277V	60,151	NEW MG&E TRANSFORMER	65,000	(5)#600kcmi
NEW CT CABINET	63,390	100,000	277V	59,759	NEW SERVICE MAIN - ALTERNATE 6	60,151	(5)#600kcmi
NEW MDP - ALTERNATE 6	62,318	65,000	277V	58,683	NEW CT CABINET	59,759	(5)#600kcmi
EXISTING MDP	52,763	65,000	277V	50,104	NEW MDP - ALTERNATE 6	58,683	(3)#300kcmi
LPA1(X)	40,208	42,000	277V	38,675	EXISTING MDP	50,104	#3
LPA2(X)	36,849	42,000	277V	35,562	LPA1(X)	38,675	#3
XF T/A(X)	10,570	22,000	120V	10,515	EXISTING MDP	50,104	#1
RPA1(X)	10,519	22,000	120V	10,465	XF T/A(X)	10,515	#600kcmil
RPA2(X)	10,440	22,000	120V	10,386	RPA1(X)	10,465	#600kcmil
SORTING PROCESS MCC	60,095	65,000	277V	56,588	NEW MDP - ALTERNATE 6	58,683	(2)#350kcmi
WOOD GRINDER MCC	40,583	65,000	277V	38,111	NEW MDP - ALTERNATE 6	58,683	(2)#350kcmi

SCS ENGINEERS

2830 DAIRY DRIVE MADISON, WI 53718-6751
PHONE: (608) 224-2830

ENGINEERING, INC.
5525 NOBEL DRIVE
SUITE 110
MADISON, WI 53711
ph:608.277.1728 fax:608.271.7046
JDR Project No. 150012

CONSTRUCTION AND DEMOLITION WASTE RECYCLING FACILITY 7102 US HIGHWAY 12/18 MADISON, WISCONSIN

DANE COUNTY DEPARTMENT OF
PUBLIC WORKS
SOLID WASTE DIVISION
1919 ALLIANT ENERGY CENTER WAY
MADISON, WI 53713

PROCCESS AND CIVIL ENGINEER:

SCS ENGINEERS 2830 DAIRY DRIVE MADISON, WI 53718-6751 (608) 224-2830

ARCHITECT:
DORSCHNER ASSOCIATES, INC.
849 E. WASHINGTON AVE., SUITE 112
MADISON, WI 53703

STRUCTURAL ENGINEER:
PIERCE ENGINEERS, INC.
10 WEST MIFFLIN ST., SUITE 205
MADISON, WI 53703

MECHANICAL, ELECTRICAL, PLUMBING DESIGN

JDR ENGINEERING, INC.
5525 NOBEL DRIVE, SUITE 110

MADISON, WI 53711

EVISION	DATE	BY	TITLE
ROJECT	NO.		25214236.00
RAWN:			04/28/15
EVISED:		·	04/28/15

APPROVED BY:

BID DOCUMENTS

ISSUED 04/28/15

CHECKED BY:

ELECTRICAL SCHEDULES

SHEET NUMBER **E800**