

DANE COUNTY SHERIFF'S OFFICE CCB JAIL MITIGATION UPGRADES

210 MARTIN LUTHER KING JR. BLVD MADISON, WISCONSIN 53703

BID DOCUMENTS

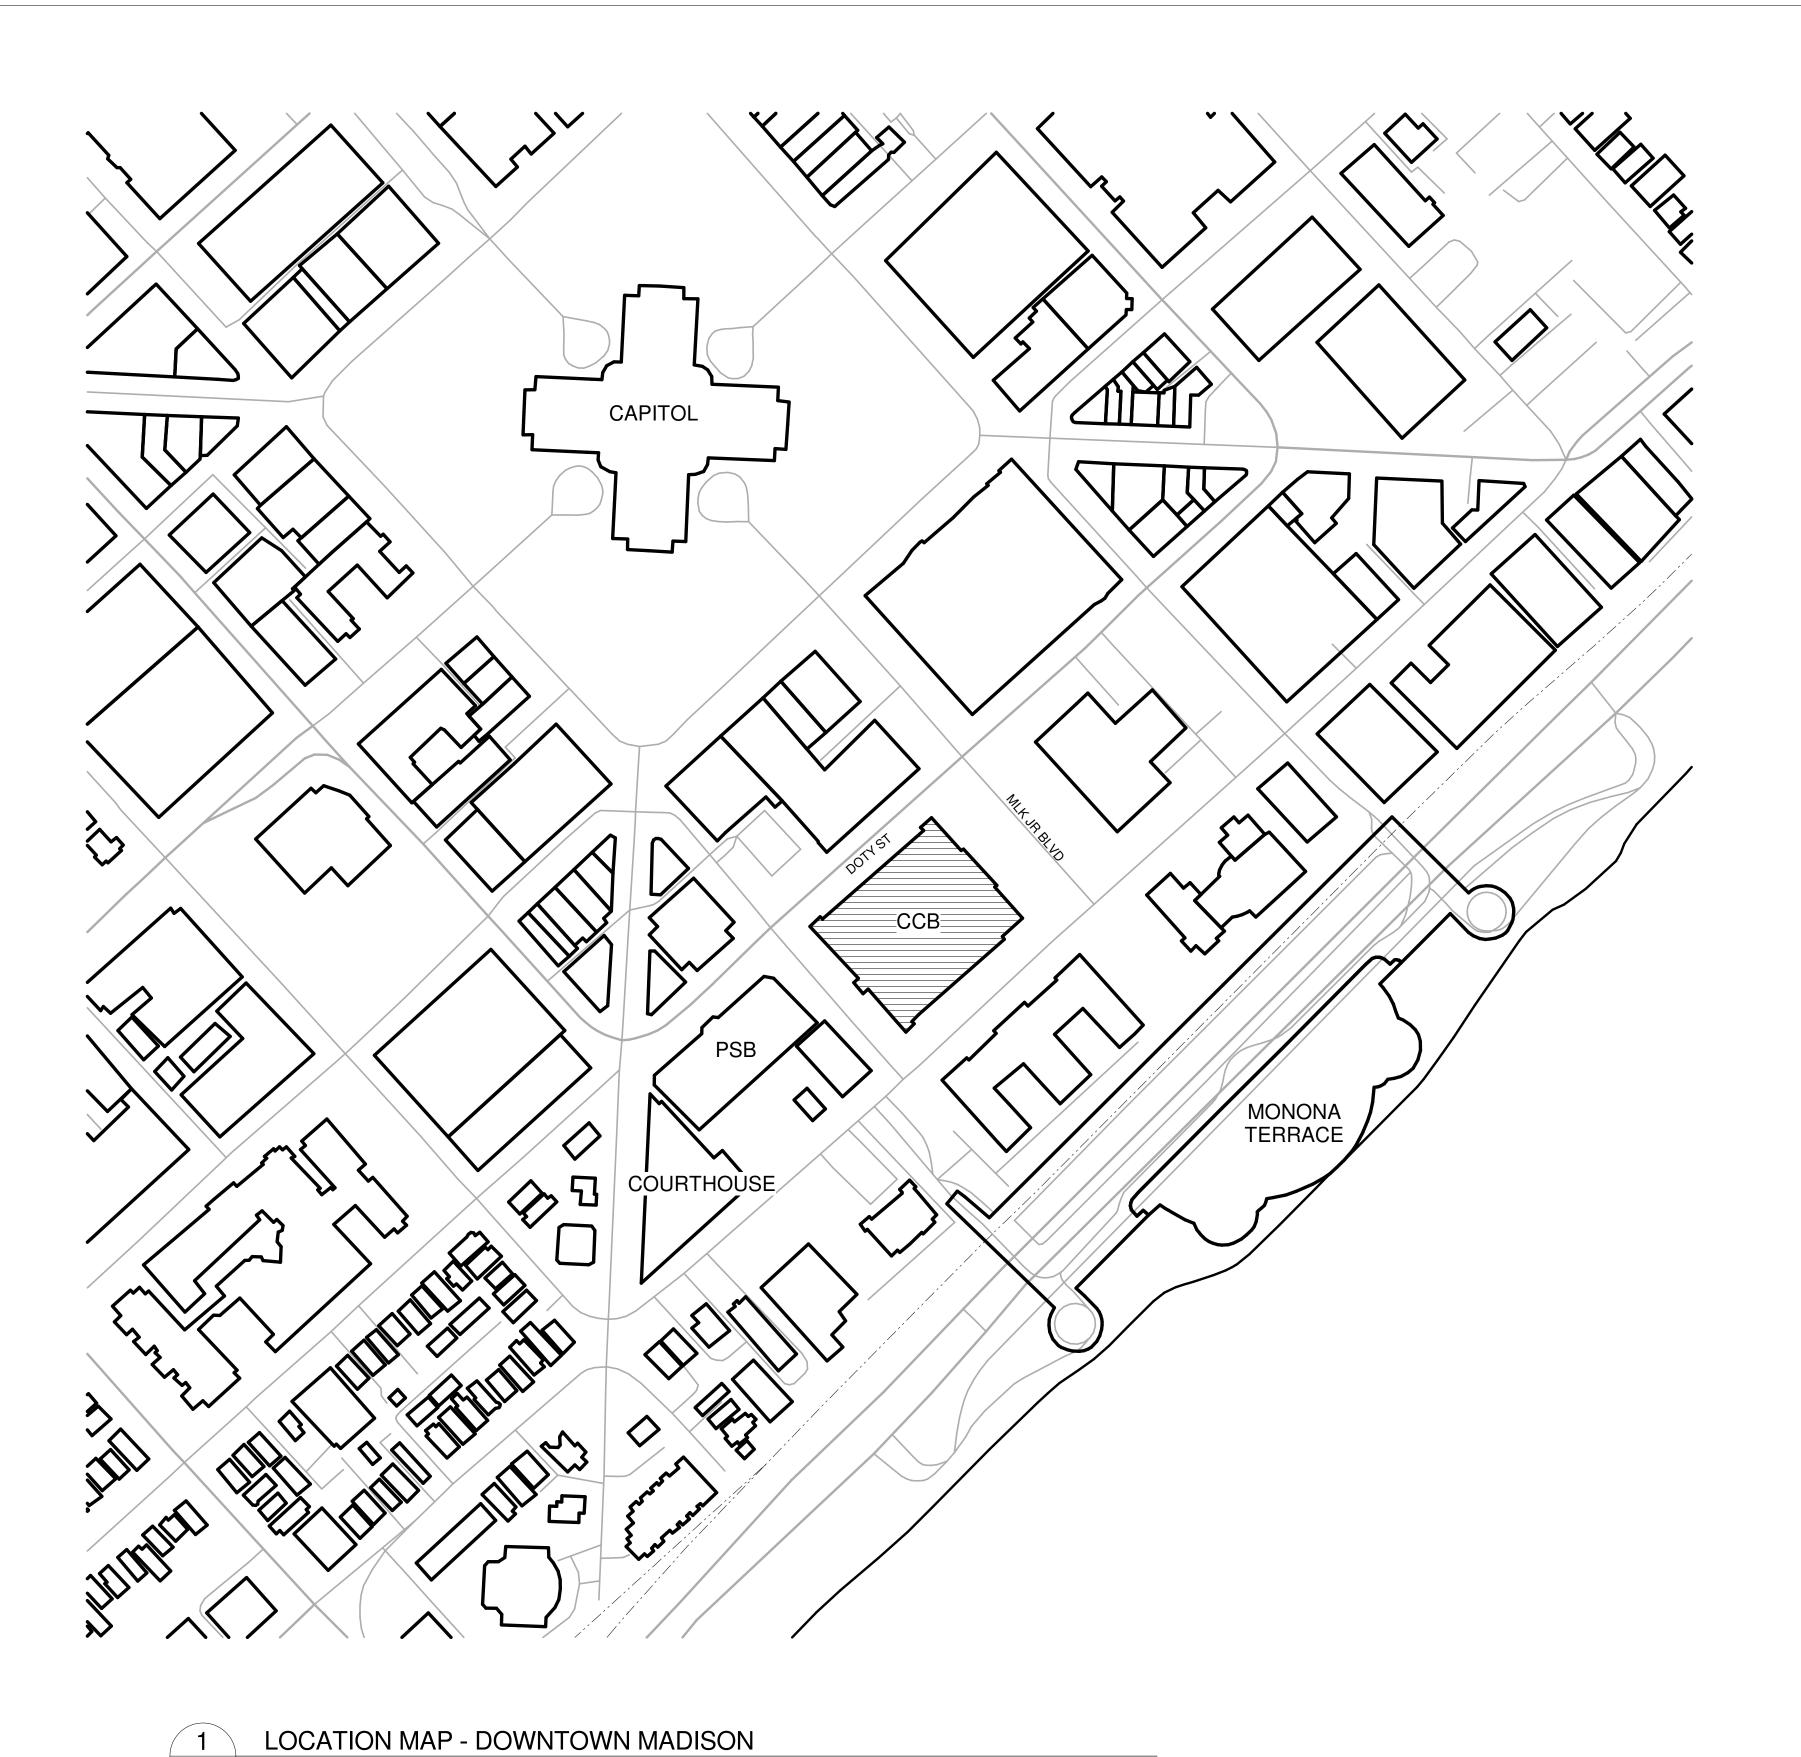

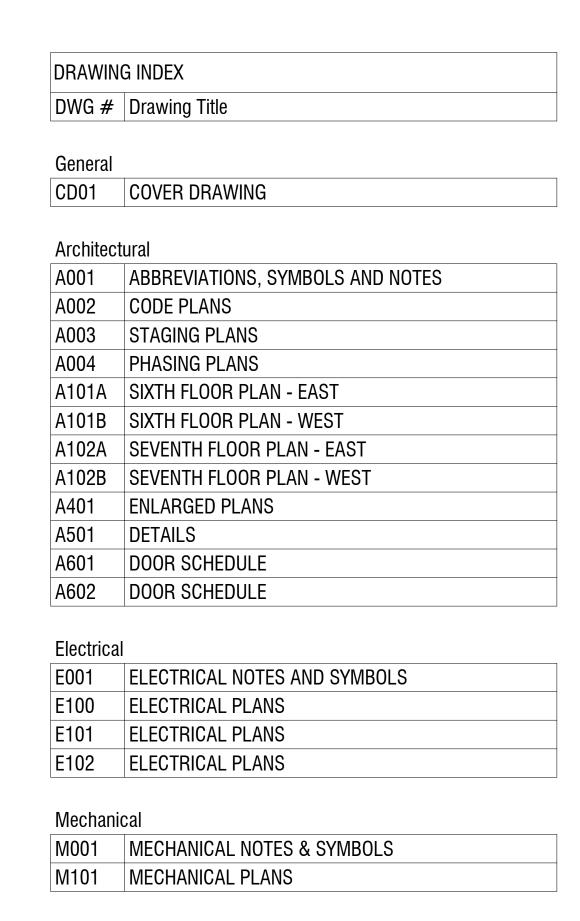



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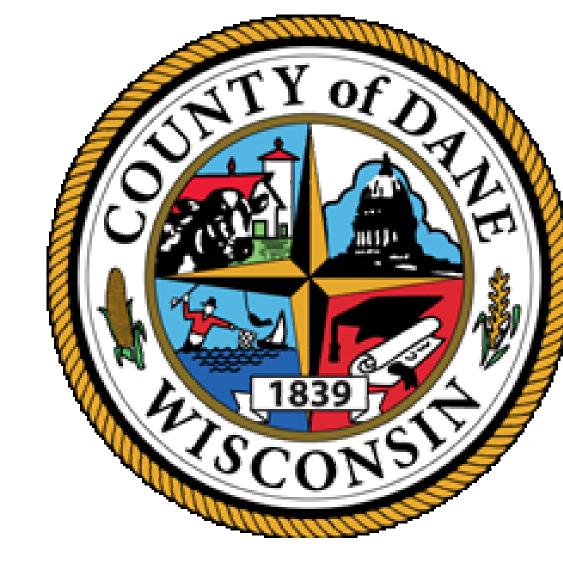
DANE COUNTY DEPT. OF PUBLIC WORKS, HIGHWAY & TRANSPORTATION 1919 ALLIANT ENERGY CENTER WAY MADISON, WI 53713

ARCHITECT:

POTTER LAWSON 749 UNIVERSITY ROW, SUITE 300 MADISON, WI 53705 608-274-2741

SECURITY / MECHANICAL / ELECTRICAL:

MEAD & HUNT 2440 DEMING WAY MIDDLETON, WI 53562 608-273-6380



PUBLIC WORKS PROJECT NO. 317006

DRAWING INDEX (EXISTING - FOR REFERENCE ONLY) DWG # Drawing Title

12/22/1954 - Court House and City Hall (Original Building)

No Date - Air Conditioning CCB PENTHOUSE

02/01/1983 - City-County Building Vertical Expansion

SIXTH FLOOR PLAN - EAST HVAC SIXTH FLOOR PLAN - WEST HVAC SEVENTH FLOOR PLAN - EAST HVAC SEVENTH FLOOR PLAN - WEST HVAC

PENTHOUSE FLOOR - WEST HVAC

05/08/2000 - HVAC Modifications 6th & 7th Floors CCB-0 PARTIAL 6TH FLOOR PLAN PARTIAL 7TH FLOOR PLAN PENTHOUSE SECTIONS M1-2 PARTIAL PENTHOUSE FLOOR PLAN

EQUIPMENT SCHEDULES M2-1 EQUIPMENT SCHEDULES

M3-0 DETAILS





1919 ALLIANT ENERG

PROJECT NO. 317006

04/04/17 BID DOCUMENTS

BID DOCUMENTS

DESIGNED BY: JDH DRAWN BY: CHECKED BY: JDH

SHEET CONTENTS **COVER DRAWING**

CD01

		ABBRE	/IATIO	NS			MATERIAL LEGEN
REFERENCE STANDARDS	• • • • • • • • • • • • • • • • • • • •	CONFERENCE CONNECT/CONNECTION	ID IF	INSIDE DIAMETER INSIDE FACE	R R	RISER RADIUS	SECTION
AOI	CONSTR CONT CONTR	CONSTRUCTION CONTINUOUS CONTRACTOR	IN INCAND INSUL	INCHES INCANDESCENT INSULATION	RA RB RC	RETURN AIR RESILIENT BASE REINFORCED CONCRETE	EARTH
ACI AMERICAN CONCRETE INSTITUTE ADA AMERICANS WITH DISABILITIES ACT AGA AMERICAN GAS ASSOCIATION	COORD CORR CP	COORDINATE CORRIDOR CONCRETE PIPE	INSUL PNL INT INV	INSULATED METAL PANEL INTERIOR INVERT	RCVR RECPT RD	RECEIVER RECEPTACLE ROOF DRAIN	
AIA AMERICAN GAS ASSOCIATION AIA AMERICAN INSTITUTE OF ARCHITECTS AWS AMERICAN WELDING SOCIETY AWI ARCHITECTURAL WOODWORKING INSTITUTE	CP CRCMF CSB CSK	CONCRETE PIPE CIRCUMFERENCE CONCRETE SPLASH BLOCK COUNTERSUNK	INV INV EL IP IPS	INVERT INVERT ELEVATION IRON PIPE INSIDE PIPE SIZE	RD RD REBAR REC	ROOF DRAIN ROAD REINFORCING STEEL BARS RECESSED	GRANULAR FILL
ANSI AMERICAN NATIONAL STANDARDS INSTITUTE ASHRAE AMERICAN SOCIETY OF HEATING REFRIGERATING	CSFHMS G, CSFHWS	COUNTERSUNK FLAT HEAD MACHINE SCREW COUNTERSUNK FLAT HEAD WOOD SCREW	IP5	INSIDE PIPE SIZE	RECT REF	RECTANGULAR REFERENCE	GROUT, MORTAR
AND AIR CONDITIONING ENGINEERS AMERICAN SOCIETY OF PLUMBING ENGINEERS ASPE AMERICAN SOCIETY OF SANITARY ENGINEERS	CSMT CSMU CSWK	CASEMENT CALCIUM SILICATE MASONRY UNIT CASEWORK	JAN CLO JST JT	JANITOR CLOSET JOIST JOINT	REFR REINF REM	REFRIGERATOR REINFORCING/REINFORCEMENT REMOVABLE	AND PLASTER
ASSE AMERICAN WATER WORKS ASSOCIATION AWWA AMERICAN SOCIETY OF MECHANICAL ENGINEERS ASME AMERICAN SOCIETY OF TESTING AND MATERIALS	CT CTD&R CTR	CERAMIC TILE COMBINATION TOWEL DISPENSER & RECEPTACE CENTER		KIP	REQD RESIL RET	REQUIRED RESILIENT RETURN	CONCRETE MASONRY UNITS
ASTM AMERICAN ASSOCIATION OF STATE HIGHWAY & TRANSPORTATION OFFICIALS COMMERCIAL STANDARD	CUH	CUBIC CABINET UNIT HEATER	KD KIP FT KIT	KNOCKED DOWN ONE THOUSAND FOOT POUNDS KITCHEN	REV RFG	REVISE/REVISION ROOFING	BRICK
CS CONSTRUCTION SPECIFICATION INSTITUTE CSI CAST IRON SOIL PIPE INSTITUTE			KLF KO KOP	KIPS PER LINEAR FOOT KNOCKOUT KNOCKOUT PANEL	RF RH RHR	RESILIENT FLOORING RIGHT HAND RIGHT HAND REVERSE	
CISPI STATE OF WISCONSIN, DEPARTMENT OF NATURAL DNR RESOURCES STATE OF WISCONSIN, DEPARTMENT OF	D	PENNY (NAIL)	KPL KSF	KICK PLATE KIPS PER SQUARE FOOT	RLG RM RND	RAILING ROOM ROUND	STONE
DOT TRANSPORTATION STATE OF WISCONSIN, DEPARTMENT OF DOC COMMERCE	DBL DLB ACT DEG	DOUBLE DOUBLE ACTING DEGREE	KSI	KIPS PER SQUARE INCH	RO ROW RR	ROUGH OPENING RIGHT OF WAY RAILROAD	
FEDERAL SPECIFICATIONS FS INSULATING GLASS CERTIFICATION COUNCIL IGCC MANUFACTURERS STANDARDIZATION SOCIETY	DEPT DET	DEPARTMENT DETAIL	LAB LAM LAU	LABORATORY LAMINATE/LAMINATED LAUNDRY	RV	ROOF VENT	METAL
MSS NATIONAL BUREAU OF STANDARDS NBS NATIONAL ELECTRICAL CODE	DF DH DIA	DRINKING FOUNTAIN DOUBLE HUNG DIAMETER	LAV LBR	LAVATORY LUMBER	S	SOUTH	CARPET
NEC NATIONAL ELECTRICAL MANUFACTURERS NEMA ASSOCIATION NATIONAL FIRE PROTECTION ASSOCIATION	DIAG DIM DL	DIAGONAL DIMENSION DEAD LOAD	LBS LD BRG LF	POUNDS LOAD BEARING LINEAR FEET (FOOT)	SA SAFB SAN	SUPPLY AIR SOUND ATTENUATION FIRE BLANKET SANITARY	
NFPA NATIONAL FOREST PRODUCTS ASSOCIATION NFPA NATIONAL PARTICLEBOARD ASSOCIATION NPA NATIONAL SANITATION FOUNDATION	DMPF DN DPTN	DAMPPROOFING DOWN DEMOUNTABLE PARTITION	LG LH LHR	LENGTH, LONG LEFT HAND LEFT HAND REVERSE	SB SC SCHED	SPLASH BLOCK SOLID CORE SCHEDULE/SCHEDULED	WOOD (ROUGH)
NSF NATIONAL SWIMMING POOL INSTITUTE NSPI OCCUPATIONAL SAFETY AND HEALTH	DR DR CL	DOOR DOOR CLOSURE	LIB LIN LKR	LIBRARY LINEAR LOCKER	SCJ SCMU	SLAB CONTROL JOINT SOLID CONCRETE MASONRY UNIT	wood (FINISHED)
OSHA ADMINISTRATION PRECAST/PRESTRESSED CONCRETE INSTITUTE PCI PLUMBING AND DRAINAGE INSTITUTE	DR FR DRLV DS	DOOR FRAME DOOR LOUVER DOWNSPOUT	LKR RM LL	LOCKER ROOM LIVE LOAD	SCT SD SECT	STRUCTURAL CLAY TILE SOAP DISPENSER SECTION	
PDI SHEET METAL AND AIR CONDITIONING SMACNA CONTRACTORS NATIONAL ASSOCIATION SEALED INSULATING GLASS MANUFACTURERS	DT DVTL DW	DRAIN TILE DOVETAIL DISHWASHER	LLH LLV LNTL	LONG LEG HORIZONTAL LONG LEG VERTICAL LINTEL	SFTWD SHR SHT	SOFTWOOD SHOWER SHEET	PLYWOOD
SIGMA ASSOCIATION STANDARD SPECIFICATION FOR HIGHWAY AND SSHSC STRUCTURE CONSTRUCTION, WISCONSIN DOT,	DWG DWR	DRAWING DRAWER	LPT LR LT	LOW POINT LIVING ROOM LIGHT	SHTHG SIM SJ	SHEATHING SIMILAR SCORED JOINT	INSULATION (LOOSE OF
DIVISION OF HIGHWAYS UNDERWRITERS LABORATORIES	DWRT E	DUMBWAITER EAST	LTG LT WT	LIGHTING LIGHTWEIGHT	SM SND	SHEET METAL SANITARY NAPKIN DISPENSER	BATT)
UL WATER CONDITIONING FOUNDATION WCF	EA EF EFS	EACH EACH FACE EXTERIOR FINISH SYSTEM	LVR LWC	LOUVER LIGHTWEIGHT CONCRETE	SNR SPEC SPKLR	SANITARY NAPKIN RECEPTOR SPECIFICATION SPRINKLER	INSULATION (RIGID)
	EIFS EL ELEC	EXTERIOR INSULATION & FINISH SYSTEM ELEVATION ELECTRIC/ELECTRICAL	MAINT	MAINTENANCE	SPKR SQ SQ FT	SPEAKER SQUARE SQUARE FOOT (FEET)	
	ELEV EMER	ELEVATOR EMERGENCY	MAS MATL MAX	MASONRY MATERIAL MAXIMUM	SQ IN SQ YD	SQUARE INCH `SQUARE YARD	ELEVATION
TRADE STANDARDS	EMER SHR ENCL ENGR	ENCLOSURE ENGINEER	MBR MBW MCM	MASTER BEDROOM MASONRY BEARING WALL METAL COMPOSITE MATERIAL	SS SST ST	SERVICE SINK STAINLESS STEEL STREET	BRICK
A/E ARCHITECT AND/OR ENGINEER	ENTR EPDM EQ	ENTRANCE ETHYLENE PROPYLENE DIENE MONOMER EQUAL	MDO MECH MEMB	METAL COMPOSITE MATERIAL MEDIUM DENSITY OVERLAY MECHANICAL MEMBRANE	STAG STC STD	STAGGERED SOUND TRANSMISSION CLASSIFICATION STANDARD	CONCRETE DI ASTERI
EC ELECTRICAL CONTRACTOR ELC ELEVATOR CONTRACTOR FPC FIRE PROTECTION CONTRACTOR	EQL SP EQUIP	EQUALLY SPACED EQUIPMENT EQUIVALENT	MEZZ MFR	MEZZANINE MANUFACTURER	STIF STIR STL	STIFFENER STIRRUP STEEL	CONCRETE, PLASTER A ACOUSTICAL CEILING T
FSC FOOD SERVICE CONTRACTOR GC PRIME CONTRACTOR OR DESIGNATED	EQUIV ESCAL ESMT	ESCALATOR EASEMENT	MH MHGT MIN	MANHOLE MOUNTING HEIGHT MINIMUM	STL JST STL LNTL	STEEL JOIST STEEL LINTEL	SYMBOLS LEGEN
CONTRACTOR OF HIS CHOICE HC HEATING CONTRACTOR	ESTB EW EWC	ESTABLISH EACH WAY ELECTRIC WATER COOLER	MIRR MISC MJ	MIRROR MISCELLANEOUS MOVEMENT JOINT	STL PL STOR STRUCT	STEEL PLATE STORAGE STRUCTURAL/STRUCTURE	
PC PLUMBING CONTRACTOR TCC TEMPERATURE CONTROL CONTRACTOR	EXC EXH EXST	EXCAVATION/EXCAVATE EXHAUST EXISTING	MKBD ML	MARKER BOARD METAL LATH	SUSP SUSP CLG SW	SUSPEND/SUSPENDED SUSPENDED CEILING SIDEWALK	SPECIFIC NOTES NEW NOTE
OENIEDAL OTANIDADDO	EXP EXP BT	EXPANSION EXPANSION BOLT	MLDG MLWK MO	MOLDING (MOULDING) MILLWORK MASONRY OPENING	SW SYMM	SWITCH SYMMETRICAL	DEMOLITION NOTE
GENERAL STANDARDS	EXP JT EXT EXST GR	EXPANSION JOINT EXTERIOR EXISTING GRADE	MS MTD MTG	MACHINE SCREW MOUNTED MOUNTING			WINDOW/IGU TYPE
ANOUGR POLT			MTL MTP MULL	METAL METAL TOILET PARTITION MULLION		TREAD	FINISH NOTE
AB ANCHOR BOLT ABAN ABANDON ABC AGGREGATE BASE COURSE	F FA	FAHRENHEIT FIRE ALARM	MWP	MEMBRANE WATERPROOFING	T&B TB	TOP AND BOTTOM TOWEL BAR	(XXX'-XX") CEILING HEIGHT NOTE ROOM ROOM NAME
AC AIR CONDITIONING ACM ALUMINUM COMPOSITE ACID RES MATERIAL	FAB FBC	FABRICATE FIRE BLANKET CABINET	N NA	NORTH NOT APPLICABLE	TD TD TDR	TOWEL DISPENSER TRENCH DRAIN TOWEL DISPENSER/RECEPTACLE	ROOM ROOM NAME NAME AND RM. # NUMBER
ACOUS ACID RESISTANT ACOUS INSUL ACOUSTICAL	FD FDTN FE	FLOOR DRAIN FOUNDATION FIRE EXTINGUISHER	NIC NO NOM	NOT IN CONTRACT NUMBER NOMINAL	TEL TEMP TER	TELEPHONE TEMPERATURE TERRAZZO	'OPENING' REFERENCE NUMBER
ACOUS PNL ACOUSTICAL INSULATION ACOUS TILE ACOUSTICAL PANEL ACP ACOUSTICAL TILE	FEC FF FGL	FIRE EXTINGUISHER CABINET FINISH FACE FIBERGLASS	NRC NTS	NOISE REDUCTION COEFFICIENT NOT TO SCALE	TFF T&G	TOP OF FINISH FLOOR TONGUE AND GROOVE	DE. DO
ACS FLR ASPHALTIC CONCRETE PAVING ACS PNL ACCESS FLOOR AD ACCESS PANEL	FH FHC FHMS	FIRE HYDRANT FIRE HOSE CABINET FLAT HEAD MACHINE SCREW	OFCI OFOI	OWNER FURNISHED-CONTRACTOR INSTALLED	THRES TKBD TMPD GL	THRESHOLD TACKBOARD TEMPERED GLASS	100A
ADC AREA DRAIN ADDL AUTOMATIC DOOR CLOSER ADH ADDITIONAL	FHWS FHP	FLAT HEAD WOOD SCREW FULL HEIGHT PARTITION	O/O OF	OWNER FURNISHED-OWNER INSTALLED OUT TO OUT	TOB TOC TOC	TOP OF BEAM TOP OF CONCRETE TOP OF CURB	PARTITION TYPE REFERENCE NOTE: PARTITION TYPES
ADJ ADHESIVE ADJC ADJUSTABLE	FIN FIN FLR FIN GR	FINISH FINISH FLOOR FINISH GRADE	OA OC OD	OUTSIDE FACE OUTSIDE AIR ON CENTER	TOF TOJ TOPO	TOP OF FOOTING TOP OF JOIST	DESIGNATED 'S' ARE TO EXTINUTE ABOVE.
ADS ADJACENT AFF AUTOMATIC DOOR SEAL AFG ABOVE FINISHED FLOOR	FIXT FLG FLL	FIXTURE FLASHING FLOW LINE	OFF OPH OPNG	OUTSIDE DIAMETER OFFICE OPPOSITE HAND	TOS TOS	TOPOGRAPHY TOP OF SLAB TOP OF STEEL	≥ EXAMPLE: _XX/S
AFS ABOVE FINISHED GRADE AGGR ABOVE FINISHED SLAB AHU AGGREGATE	FLR FLR FIN	FLOOR FLOOR FINISH	OPP OVHD	OPENING OPPOSITE	TOW TP TPH	TOP OF WALL TELEPHONE POLE TOILET PAPER HOLDER	BUILDING SECTION REFERENCE DETAIL NUMBER
ALT AIR HANDLING UNIT ALT NO ALTERNATE, ALTERNATIVE ALUM ALTERNATE NUMBER	FLT GL FLEX FLUOR	FLOAT GLASS FLEXIBLE FLUORESCENT	OZ	OVERHEAD OUNCE	TRTD TV TYP	TREATED TELEVISION TYPICAL	XX XXXXX XXXXX
ANOD ALUMINUM APPROX ANODIZE	FOC FOF FOM	FACE OF CONCRETE FACE OF FINISH FACE OF MASONRY	PAR PB PBD	PARALLEL PUSHBUTTON PARTICLEBOARD	'''	TTTIONE	DRAWING NUMBER WALL SECTION REFERENCE
ARCH APPROXIMATE ASC ARCHITECTURAL ASSY ABOVE SUSPENDED CEILING	FOS FPL FPRF	FACE OF STUD/FACE OF SLAB FIREPLACE FIREPROOFING	PCF PCP	POUNDS PER CUBIC FOOT PORTLAND CEMENT PLASTER	UC UF	UNDERCUT UNDER FLOOR	DETAIL NUMBER
AUTO ASSEMBLY AUX AUTOMATIC AVE AUXILIARY	FR FR MIR	FRAME FRAMED MIRROR	PERIM PERP PERF	PERIMETER PERPENDICULAR PERFORATED	UGND UH UNEX	UNDERGROUND UNIT HEATER UNEXCAVATED	XX DRAWING NUMBER
AVE AUXILIARY AWT AVENUE ACOUSTICAL WALL TREATMENT	FS FSTNR	F FRAMED MIRROR AND SHELF FULL SIZE FASTENER	PG PI PIV	PIPE GUARD POINT OF INTERSECTION POST INDICATOR VALVE	UNFIN UON UR	UNFINISHED UNLESS OTHERWISE NOTED URINAL	EXTERIOR ELEVATION REFERENCE
B&B BALLED AND BURLAPPED B/B BACK TO BACK	FT FTG FURN	FOOT/FEET FOOTING FURNITURE	PKWY PL	PARKWAY PLATE PROPERTY LINE	UTIL UV	UTILITY UNIT VENTILATOR	DETAIL NUMBER
BC BACK OF CURB BD BOARD BEV BEVEL	FURG FWC	FURRING FABRIC WALL COVERING	PL PL GL PLAM	PLATE GLASS PLASTIC LAMINATE	V	VOLT	DRAWING NUMBER
BF BARRIER FREE BFE BOTTOM OF FOOTING ELEVATION BITUM BITUMINOUS			PLAS PLBG PLF	PLASTER PLUMBING POUNDS PER LINEAR FOOT	VB VCT VIF	VINYL BASE VINYL COMPOSITION TILE VERIFY IN FIELD	INTERIOR ELEVATION REFERENCE XX — DETAIL NUMBER
BLDG BUILDING BLK BLOCK	GA GALV	GAUGE GALVANIZED	PLYWD PMFS PNL	PLYWOOD PRE-MOLDED FILLER STRIP PANEL	VII VR VNR VENT	VAPOR RETARDER VENEER VENTILATING	XXXX) DRAWING NUMBER
BLKG BLOCKING BLKHD BULKHEAD BLT BORROWED LIGHT	GALV STL GB	GALVANIZED STEEL GRAB BAR	POL PP	POLISHED POWER POLE	VERT VEST	VERTICAL VESTIBULE	
BM BENCH MARK BOT BOTTOM BOW BOTTOM OF WALL	GDR GI GL	GUARD RAIL GALVANIZED IRON GLASS	PR PREFAB PREFIN	PAIR PREFABRICATED PREFINISHED	VOL VWC	VOLUME VINYL WALL COVERING	INTERIOR ELEVATION REFERENCE XX (MULTIPLE VIEW) DETAIL NUMBER
B PL BASE PLATE BRCG BRACING	GL BLK GLU LAM GLZ	GLASS BLOCK GLUE LAMINATED WOOD GLAZING	PRKG PROJ PROP	PARKING PROJECT PROPERTY	W W/O WBL	WEST WITHOUT WOOD BLOCKING	xx (xxxx) xx
BRG BEARING BRK BRICK BRKT BRACKET	GLZ CMU GR	GLAZED CONCRETE MASONRY UNIT GRADE/GRADING	PS CONC PSF	PRESTRESSED CONCRETE POUNDS PER SQUARE FOOT	WC WD	WATER CLOSET WOOD	DRAWING NUMBER XX DETAIL SECTION REFERENCE
BS BOTH SIDES BSMT BASEMENT BTWN BETWEEN	GRL GRTG GSB	GRILLE GRATING GYPSUM SHEATHING BOARD	PSI PT	POUNDS PER SQUARE INCH PAINT/POINT/POST TENSIONED/ PRESSURE TREATED	WDW WGL WH	WINDOW WIRED GLASS WALL HYDRANT	DETAIL NUMBER
BUR BUILT-UP ROOFING BW BOTH WAYS	GWB GYP GYP BD	GYPSUM WALLBOARD GYPSUM GYPSUM BOARD	PTD PTDR PTN	PAPER TOWEL DISPENSER PAPER TOWEL DISPENSER & RECEPTACLE PARTITION	WP WP WP	WEATHERPROOF WORKING POINT WATERPROOFING	XXXXX DRAWING NUMBER
C CENTIGRADE, CELSIUS	GYP PLAS	GYPSUM PLASTER	PTR PTWD PVC	PAPER TOWEL RECEPTACLE PRESERVATIVE TREATED WOOD POLYVINYL CHLORIDE	WPM WR WRECPT	WATERINGOTING WATERPROOF MEMBRANE WATER RESISTANT WASTE RECEPTACLE	DETAIL REFERENCE
C/C CENTER TO CENTER C&G CURB AND GUTTER CAB CABINET	HB HC	HOSE BIB HOLLOW CORE	PVMT	PAVEMENT	WS WSCT	WEATHERSTRIPPING WAINSCOT	DETAIL NUMBER
CB CATCH BASIN CCTV CLOSED CIRCUIT TELEVISION	HD HDBD	HEAD HARDBOARD	QT QTB	QUARRY TILE QUARRY TILE BASE	WT WWF	WEIGHT WELDED WIRE FABRIC	XXXX
CG CORNER GUARD CEM CEMENT CEM PLAS CEMENT PLASTER	HDR HDWD HDW	HEADER HARDWOOD HARDWARE	QTF QTY	QUARRY TILE FLOOR QUANTITY			EXIT ARROW SYMBOL DRAWING NUMBER
CFLG COUNTER FLASHING CFM CUBIC FEET PER MINUTE CHBD CHALKBOARD	HEX HM HMD	HEXAGONAL/HEXAGON HOLLOW METAL HOLLOW METAL DOOR			YCO YD YD	YARD CLEAN OUT YARD YARD DRAIN	XX" — EXIT WIDTH
CI CAST IRON CJ CONTROL JOINT	HMF HNDRL HORIZ	HOLLOW METAL BOOK HOLLOW METAL FRAME HAND RAIL HORIZONTAL				וייים איייים איייים איייים איייים איייים איייים איייים איייים	XXX — NUMBER OF OCCUPA
CL CENTER LINE CLG CEILING CLL COLUMN LINE	HP HPT	HORSEPOWER HIGH POINT					DIMENSIONS 3/4" SLASH INDICATES
CLR CLEAR CLRM CLASSROOM CLO CLOSET	HR HT HTG	HOUR HEIGHT HEATING					DIMENSION TO FACE CENTERLINE OF OBJ
CMU CONCRETE MASONRY UNIT CMP CORRUGATED METAL PIPE CNTR COUNTER	HVAC HWY HYD	HEATING, VENTILATING, & AIR CONDITIONING HIGHWAY HYDRANT					SPOT ELEVATIONS ON PLANS
CO CLEAN OUT CONST JT CONSTRUCTION JOINT	טווו						000'-00"
COL COLUMN CONC CONCRETE							FLOOR ELEVATION REFERENCE
			1				LOCATION 000'-0"

GENERAL NOTES

1. REFER TO A002 FOR DEPARTMENT OF CORRECTIONS CODE

4. ALL CMU PARTITIONS ARE RUNNING BOND UNLESS

5. REFER TO ALL DRAWINGS, INCLUDING THOSE OF OTHER TRADES, FOR ADDITIONAL NOTES, SYMBOLS AND

7. IN MASONRY CONSTRUCTION, LOCATE DOOR FRAMES ON THE SIDE OF THE WALL TOWARD THE ROOM INTO WHICH THE DOOR SWINGS UNLESS OTHERWISE INDICATED.

8. PROVIDE BULLNOSE CMU AT OUTSIDE VERTICAL CORNERS

AND FIRE-SAFED, HAVE FIRE DAMPERS EQUIVALENT TO THE HOURLY FIRE RATING OF THE PENETRATED CONSTRUCTION.

10.ALL PITCHED FLOOR AREAS SHOWN WITH PITCH LINES SHALL SLOPE AT 1/4"/FT. UNLESS OTHERWISE INDICATED. PROVIDE A SLADE DEPRESSION AT ALL FLOOR DRAINS WHERE PITCH

9. SEE DRAWINGS A002 FOR REFERENCE FLOOR PLAN INDICATING FIRE RATED PARTITIONS AND SPACES. ALL MECHANICAL, ELECTRICAL AND PLUMBING PENETRATIONS THROUGH FIRE RATED CONSTRUCTION SHALL BE SLEEVED

12.REFER TO SPECIFICATION SECTION 07 92 00 - JOINT

13. FINISH FLOOR ELEVATIONS ARE TO THE TOP OF CONCRETE

14. WHERE DOORS OCCUR IN PARTITIONS WITHOUT DIMENSION SEE THE DOOR FRAME DETAILS TO DETERMINE THE EXACT LOCATION OF THE DOOR.

15.REFER TO 1/4" SCALE ENLARGED FLOOR PLANS FOR DIMENSIONS OF TOILET ROOMS, STAIRS, ELEVATOR SHAFTS AND OTHER PLAN ELEMENTS

RELATED ISSUES.

ABBREVIATIONS.

OTHERWISE INDICATED.

UNLESS OTHERWISE INDICATED.

LINES ARE NOT SHOWN ON PLANS.

SEALANTS FOR SECURITY SEALANT.

UNLESS OTHERWISE INDICATED.

2. NOT USED

3. NOT USED

6. NOT USED

11.NOT USED

16.NOT USED

17.NOT USED

18.NOT USED

19.NOT USED

ABV ABOVE

ACC ACCESSIBLE DE DETENTION

JB JUNCTION BOX LG LAY-IN GRID

MTL MATERIAL

SURF SURFACE TR TOOL RESISTANT

LK LOCK

DETENTION HOLLOW METAL

FURNISHED BY OTHERS

DIV DIVISION
EMT ELECTRIC METALLIC TUBING

GRC GALVANIZED RIGID CONDUIT

RAI REMAIN AS IS RGS REMOVABLE GLASS STOP SE SECURITY ELECTRONICS

ES EXPOSED STRUCTURE FBO FURNISHED BY OTHE

MFG MANUFACTURER

Mead & Hunt, Inc. 2440 Deming Way Middleton, WI 53562 phone: 608-273-6380



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DANE COUNTY DEPT. OF PUBLIC WORKS, HIGHWAY & TRANSPORTATION 1919 ALLIANT ENERGY MADISON, WI 53713

CENTER WAY PROJECT NO. 317006

20.GENERAL CONTRACTOR SHALL COORDINATE ALL PLUMBING, MECHANICAL AND ELECTRICAL FLOOR, ROOF AND WALL SLEEVES AND SHAFTS WITH THE DRAWINGS OF ALL OTHER TRADES. 21.REFER TO PLUMBING, MECHANICAL AND ELECTRICAL CONTRACTORS DRAWINGS AND MANUFACTURERS TEMPLATE DRAWINGS FOR ALL EQUIPMENT SUPPORTS, BOLT SETTING TEMPLATES, ISOLATIONS, SPRING ISOLATORS, ETC. 22.DEC RESPONSIBLE FOR FILLING ALL FIELD WELDS AT METAL TO METAL JOINTS WITH METAL BODY PUTTY FILLER OR APPROVED SECURITY SEALANT. SAND SMOOTH AND PRIME FOR FINISH PAINT. SEE SPECIFICATION SECTION 11 19 00 FOR WELDING PROCEDURES AND FINISHING OF FIELD WELDS.
TYPICAL ALL DETENTION FURNISHINGS.


04/04/17 BID DOCUMENTS

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DE ABBREVIATIONS M&H NO.: 4215400-161950.01 DATE: April 4, 2017 DESIGNED BY: JDH DRAWN BY: MKH CHECKED BY: JDH DETENTION EQUIPMENT CONTRACTOR DO NOT SCALE DRAWINGS


SHEET CONTENTS ABBREVIATIONS, SYMBOLS AND NOTES

SHEET NO .:

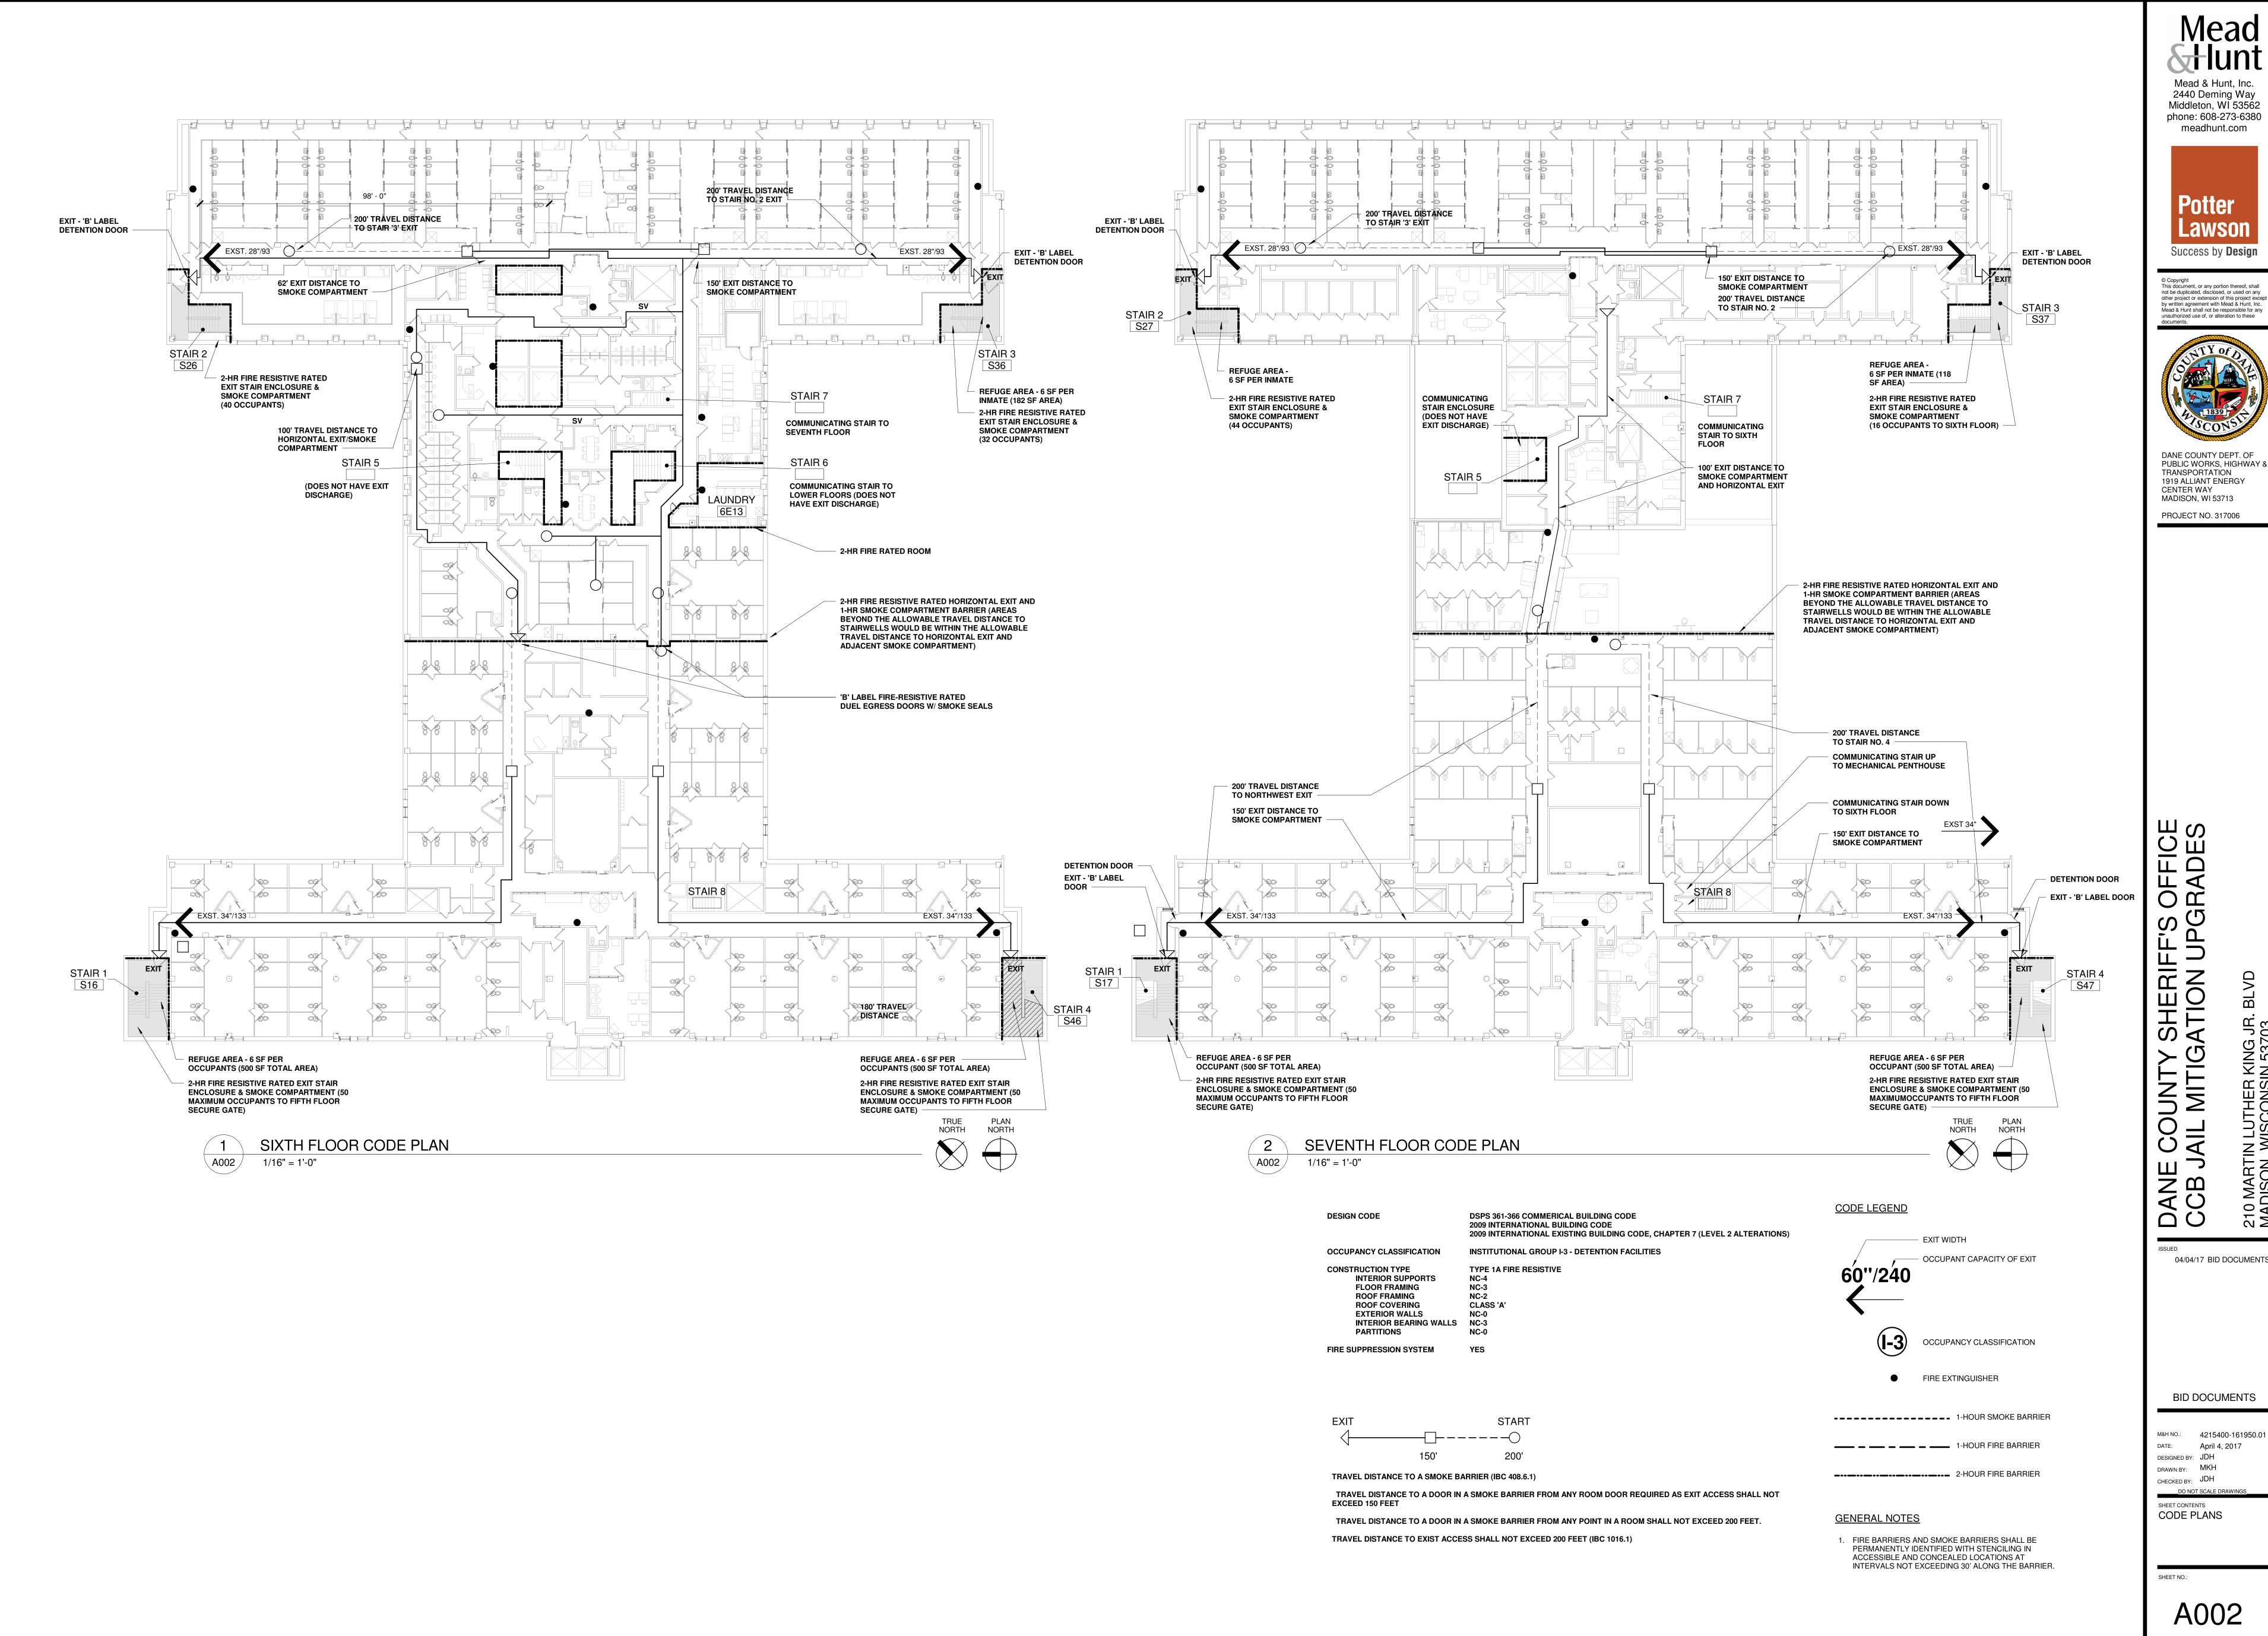


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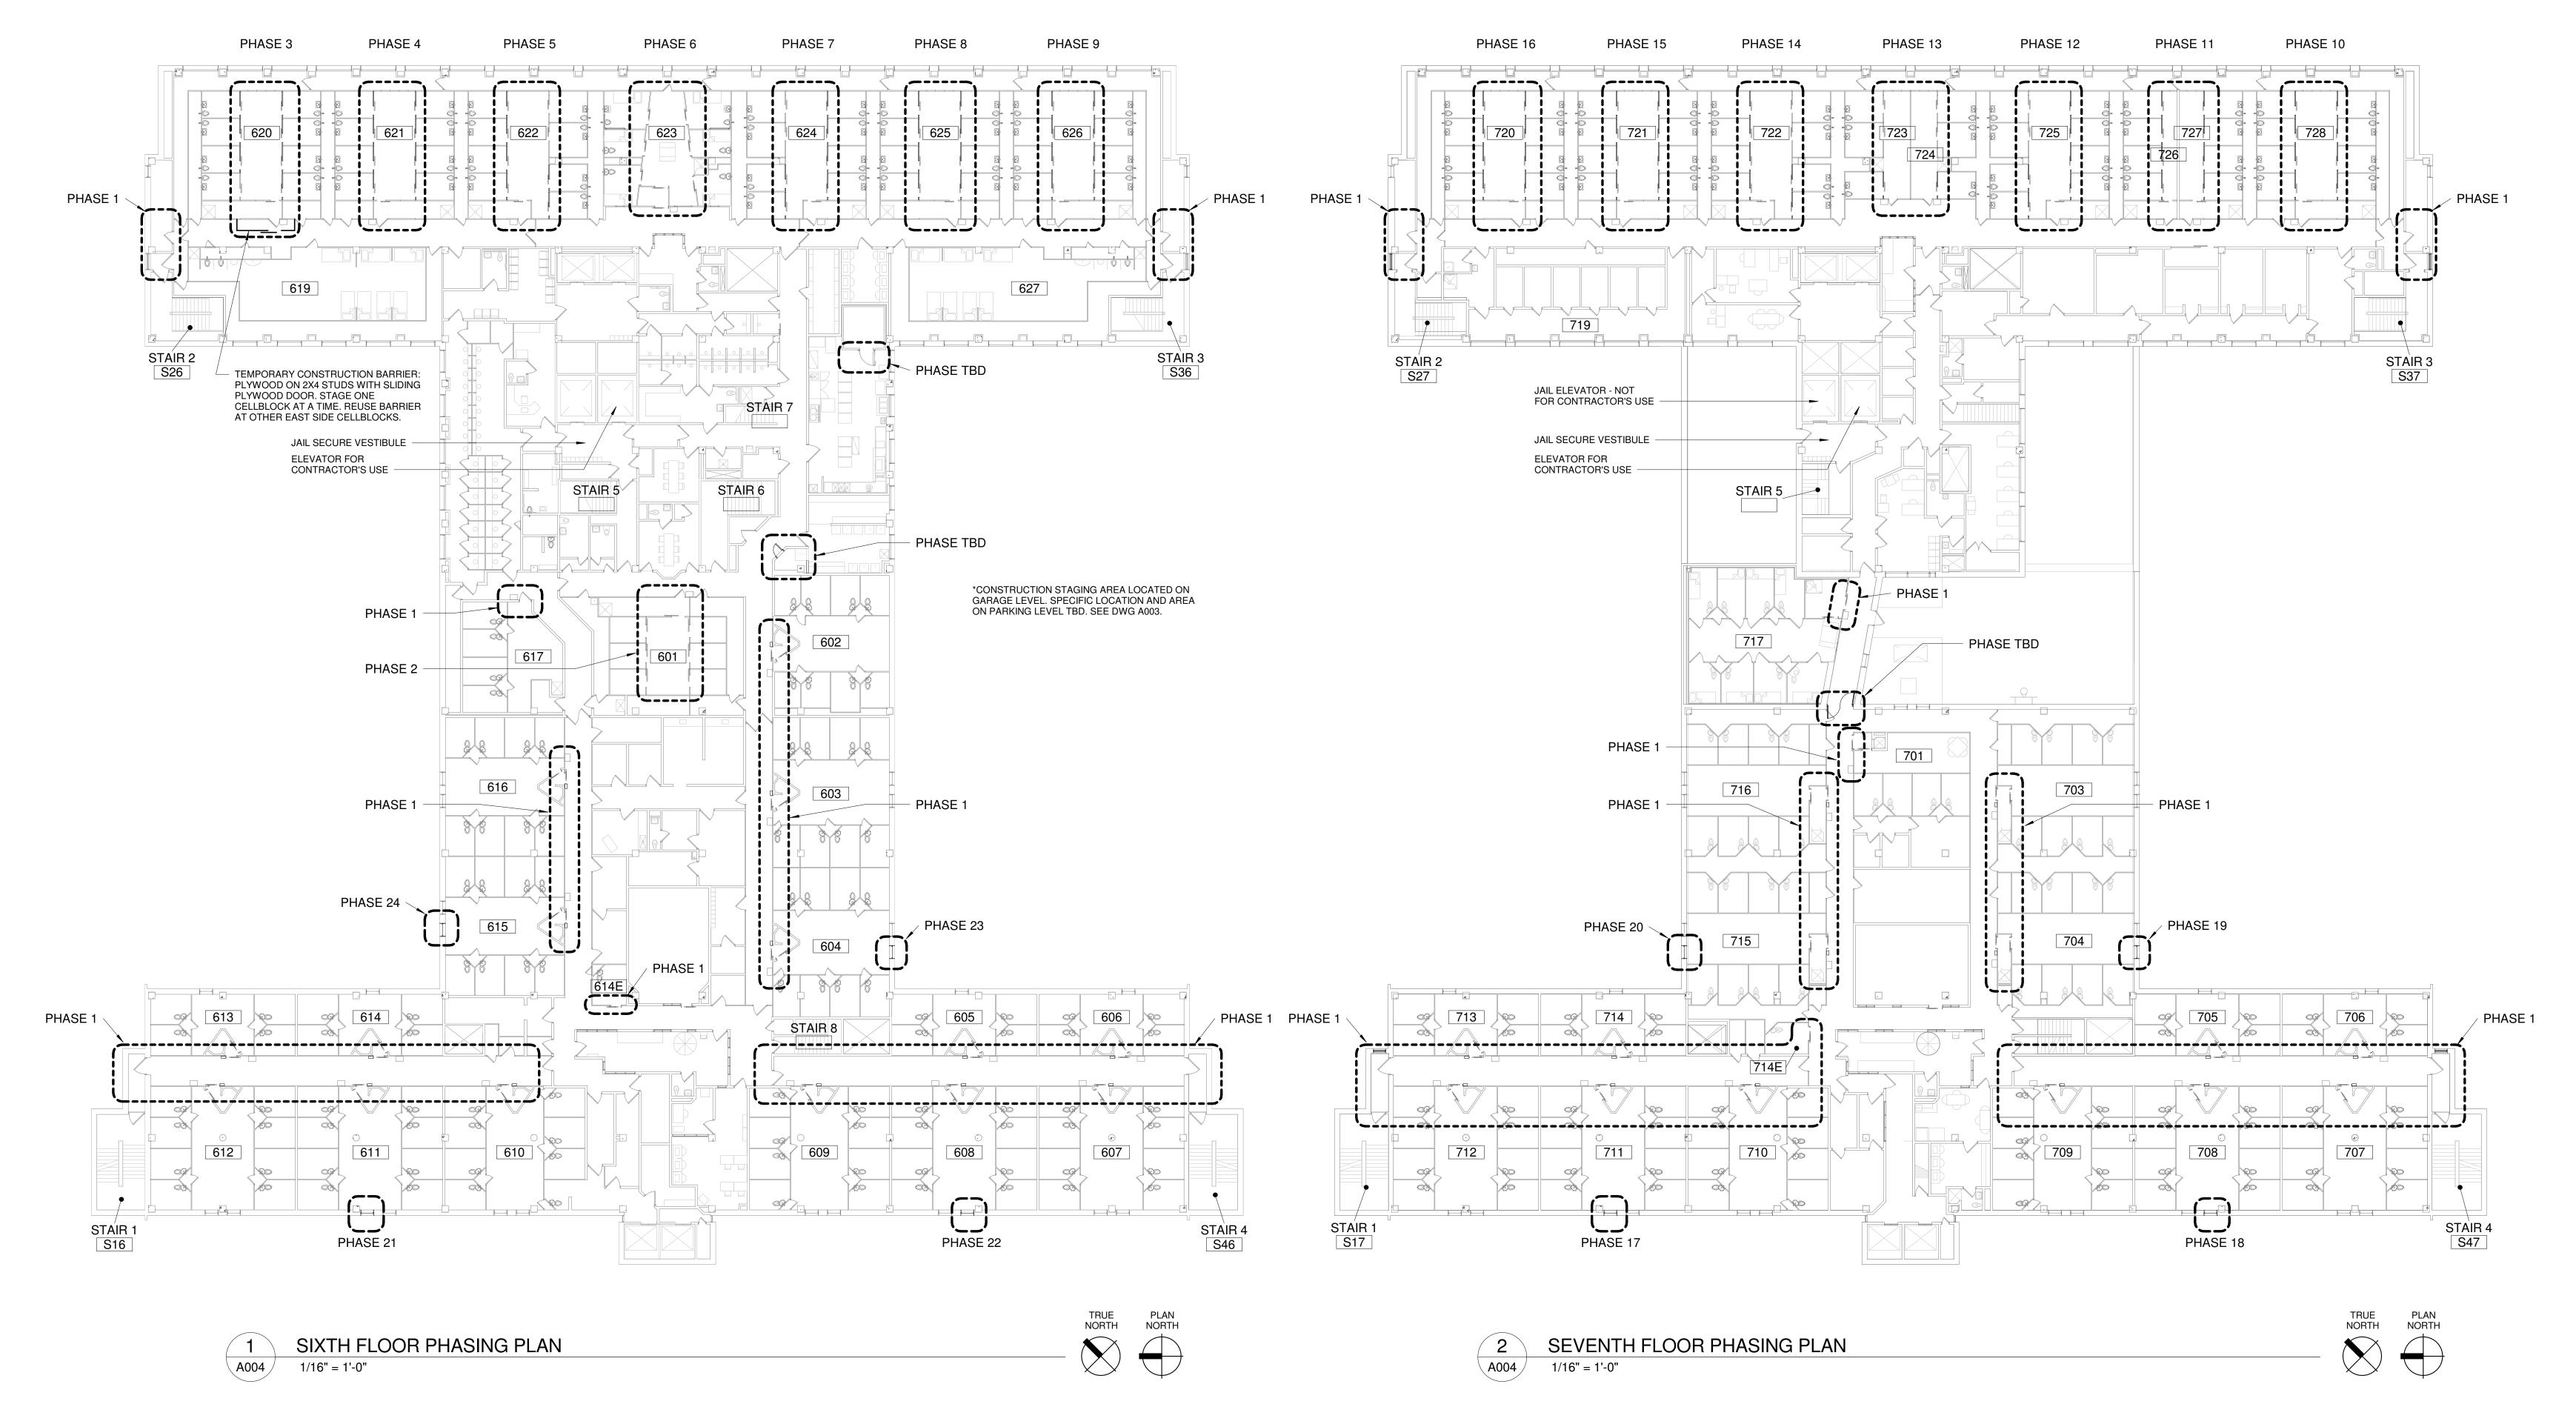
DANE COUNTY SHERIFF'S OFFICE CCB JAIL MITIGATION UPGRADES

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SHEET CONTENTS STAGING PLANS

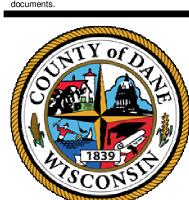

PROPOSED WORK SCHEDULE. FINAL WORK SCHEDULE TO BE DETERMINED DURING PRE-CONSTRUCTION CONFERENCE.

	PHASE	DURATION	DESCRIPTION OF WORK
•	1	6 WEEKS	LOCK REPLACEMENT AND CYLINDER/KEYING UPGRADES.
·	2	1 WEEK	SLIDING DOOR DEVICE UPGRADE INCLUDING CABINET LOCK REPLACEMENT AND OUTERDOOR (J-DOOR) LOCK REPLACEMENT.
·	3 ↓	1 WEEK	SLIDING DOOR DEVICE UPGRADE INCLUDING CABINET LOCK REPLACEMENT AND OUTERDOOR (J-DOOR) LOCK REPLACEMENT.
	16	1 WEEK	
·	17	1 WEEK	DETENTION WINDOW REPLACEMENT
	\downarrow	"	
	24	1 WEEK	

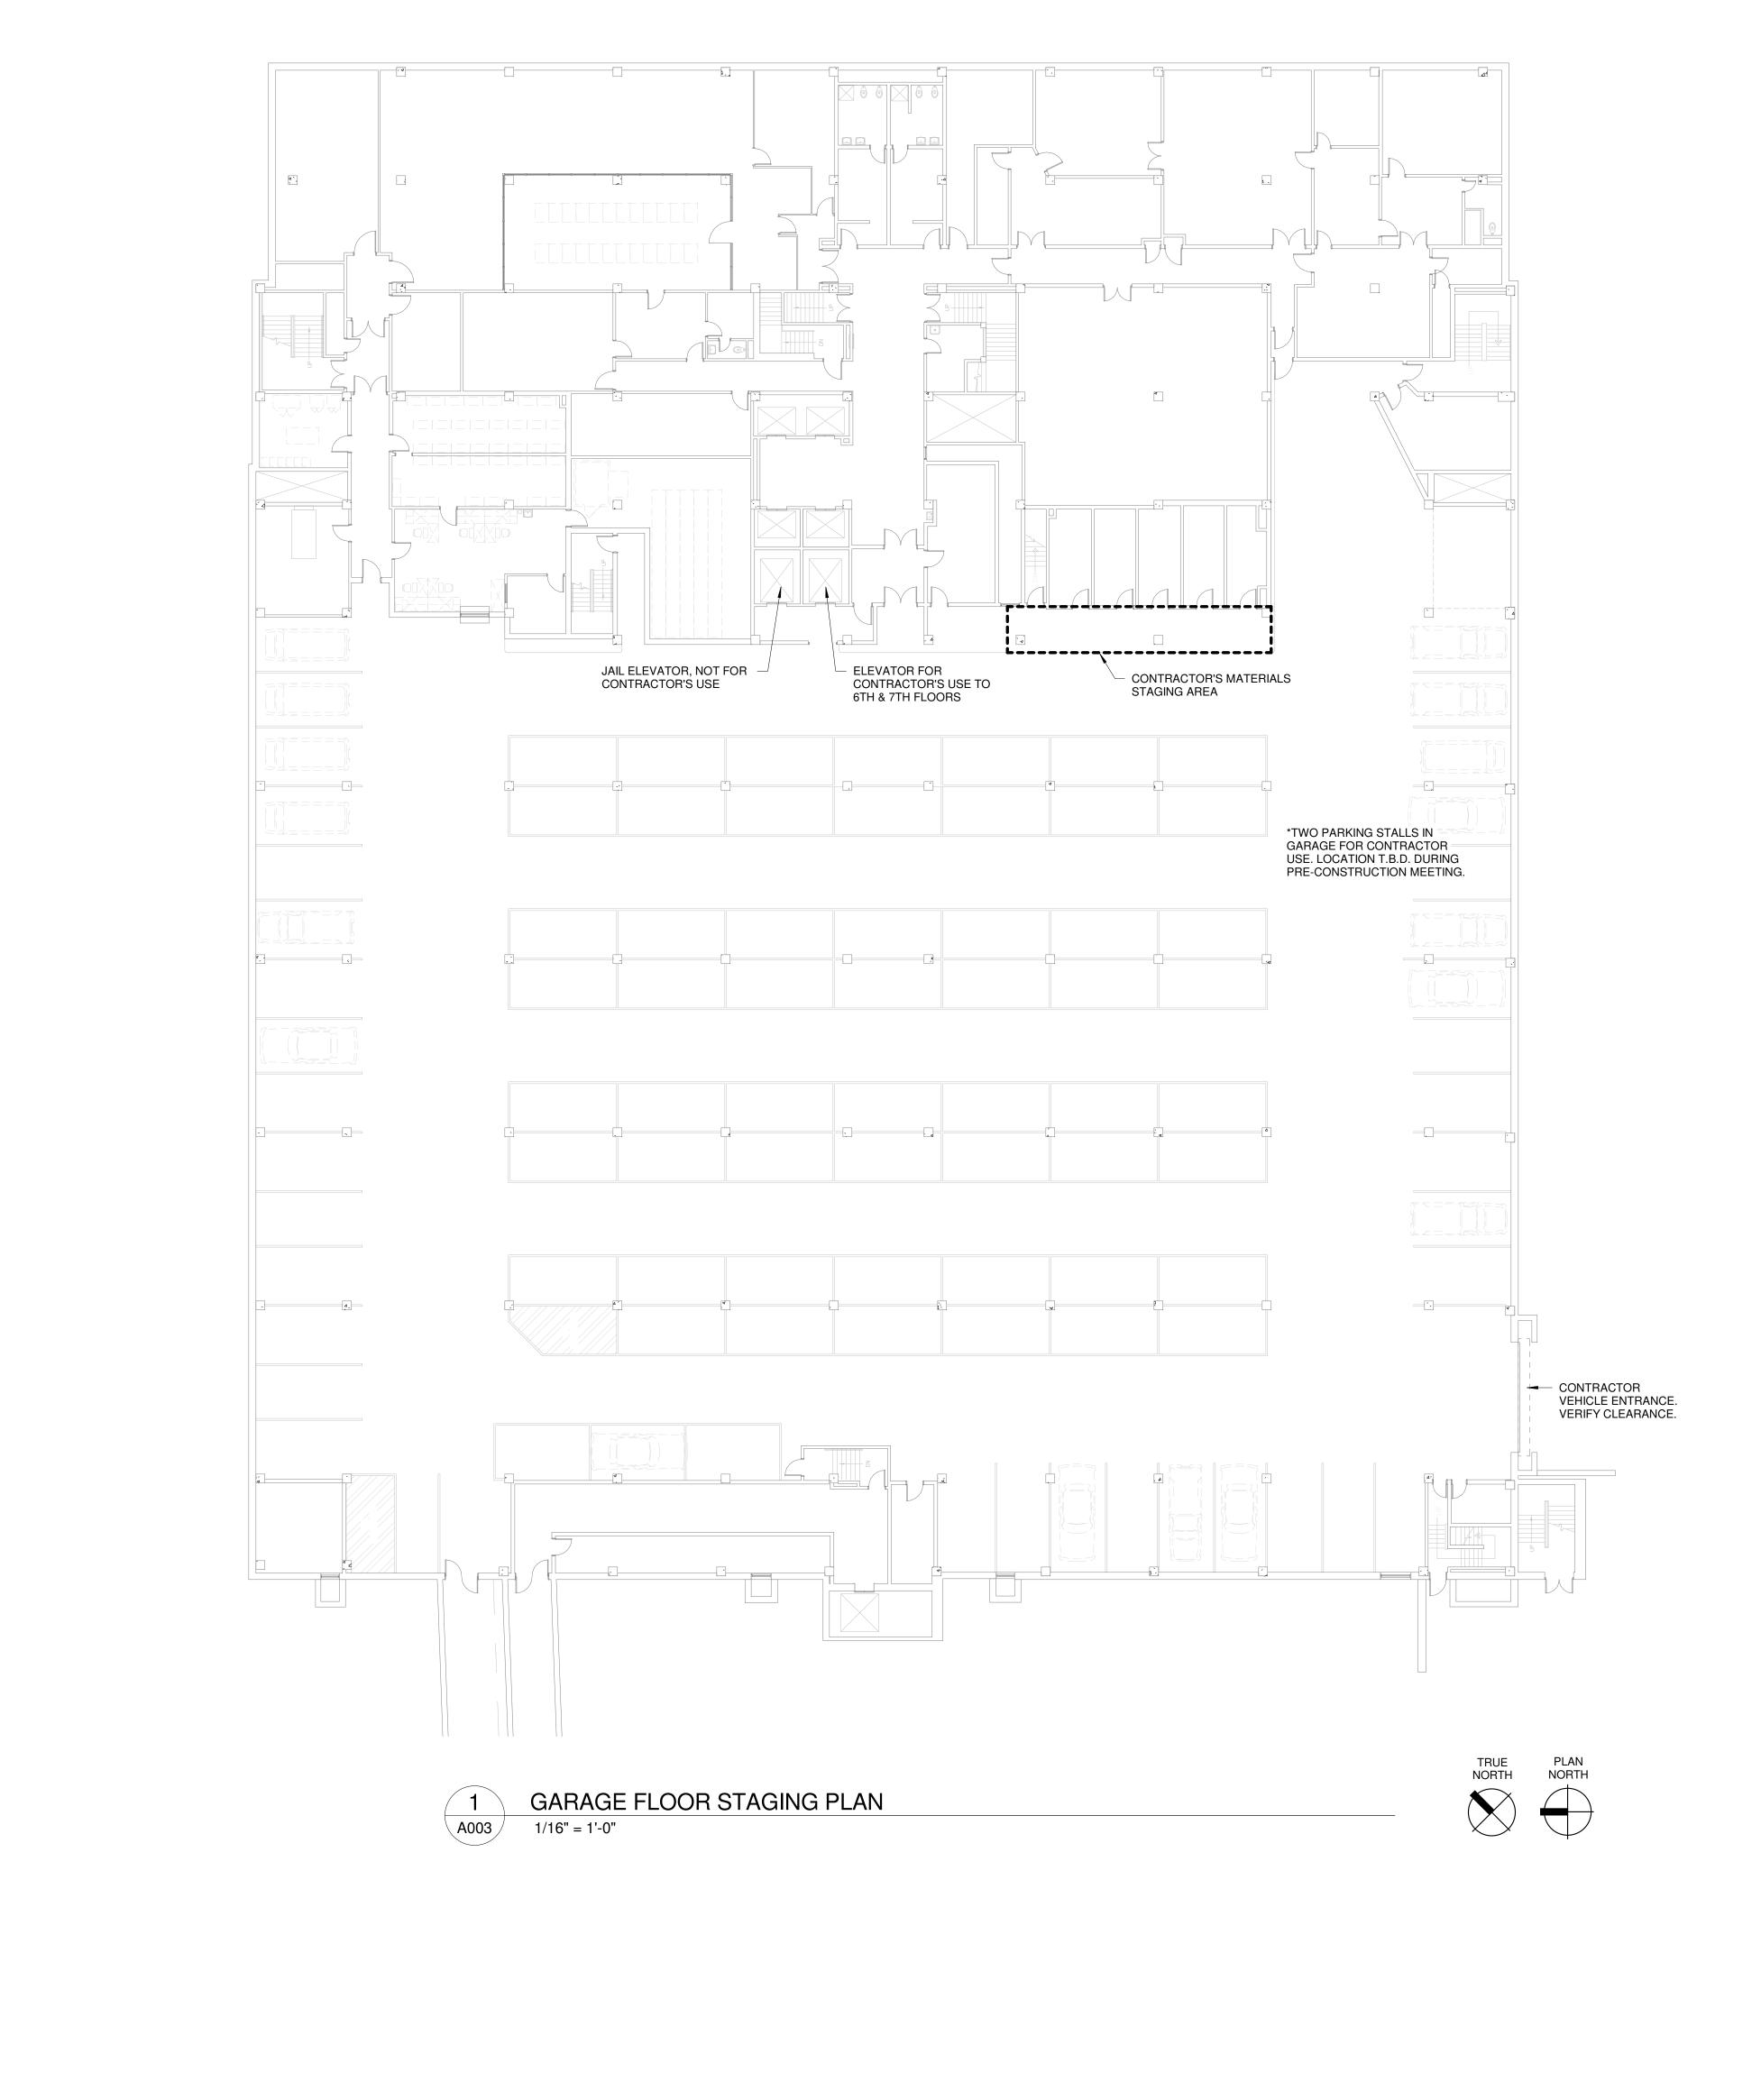ADDITIONAL DOORS NOT DELINEATED ON ABOVE FLOOR PLANS ARE PART OF PHASE I. REFER TO DOOR SCHEDULE FOR DESCRIPTION OF WORK.

AFTER EACH PHASE, CLEANING AND PUNCHLIST TO BE COMPLETED BEFORE TURN-OVER TO OWNER. OWNER TO BE PROVIDED TWO DAYS BETWEEN PHASES FOR SHAKE-DOWN OF AREA, FINAL CLEANING AND INMATE MOVEMENT.


TDB - TO BE DETERMINED BASED ON GENERAL CONTRACTOR'S FINAL PROJECT SCHEDULE.

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phone: 608-273-6380 meadhunt.com



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MADISON, WI 53713

PROJECT NO. 317006

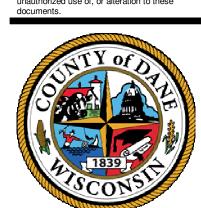04/04/17 BID DOCUMENTS

BID DOCUMENTS

M&H NO.: 4215400-161950.01 DATE: April 4, 2017 DESIGNED BY: JDH DRAWN BY: MKH

__DO NOT SCALE DRAWINGS_ SHEET CONTENTS PHASING PLANS

CHECKED BY: JDH

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SHEET CONTENTS SIXTH FLOOR PLAN -**EAST**


8 LOUVER BY G.C. IN EXISTING WALL OPENING. SEE MECH

9 FIRE/SMOKE DAMPER (SEE HVAC) IN NEW WALL OPENING

(10) REMOVE EXISTING NON-RATED DOOR AND HARDWARE

DWGS FOR SIZE AND LOCATION.

ABOVE DOOR

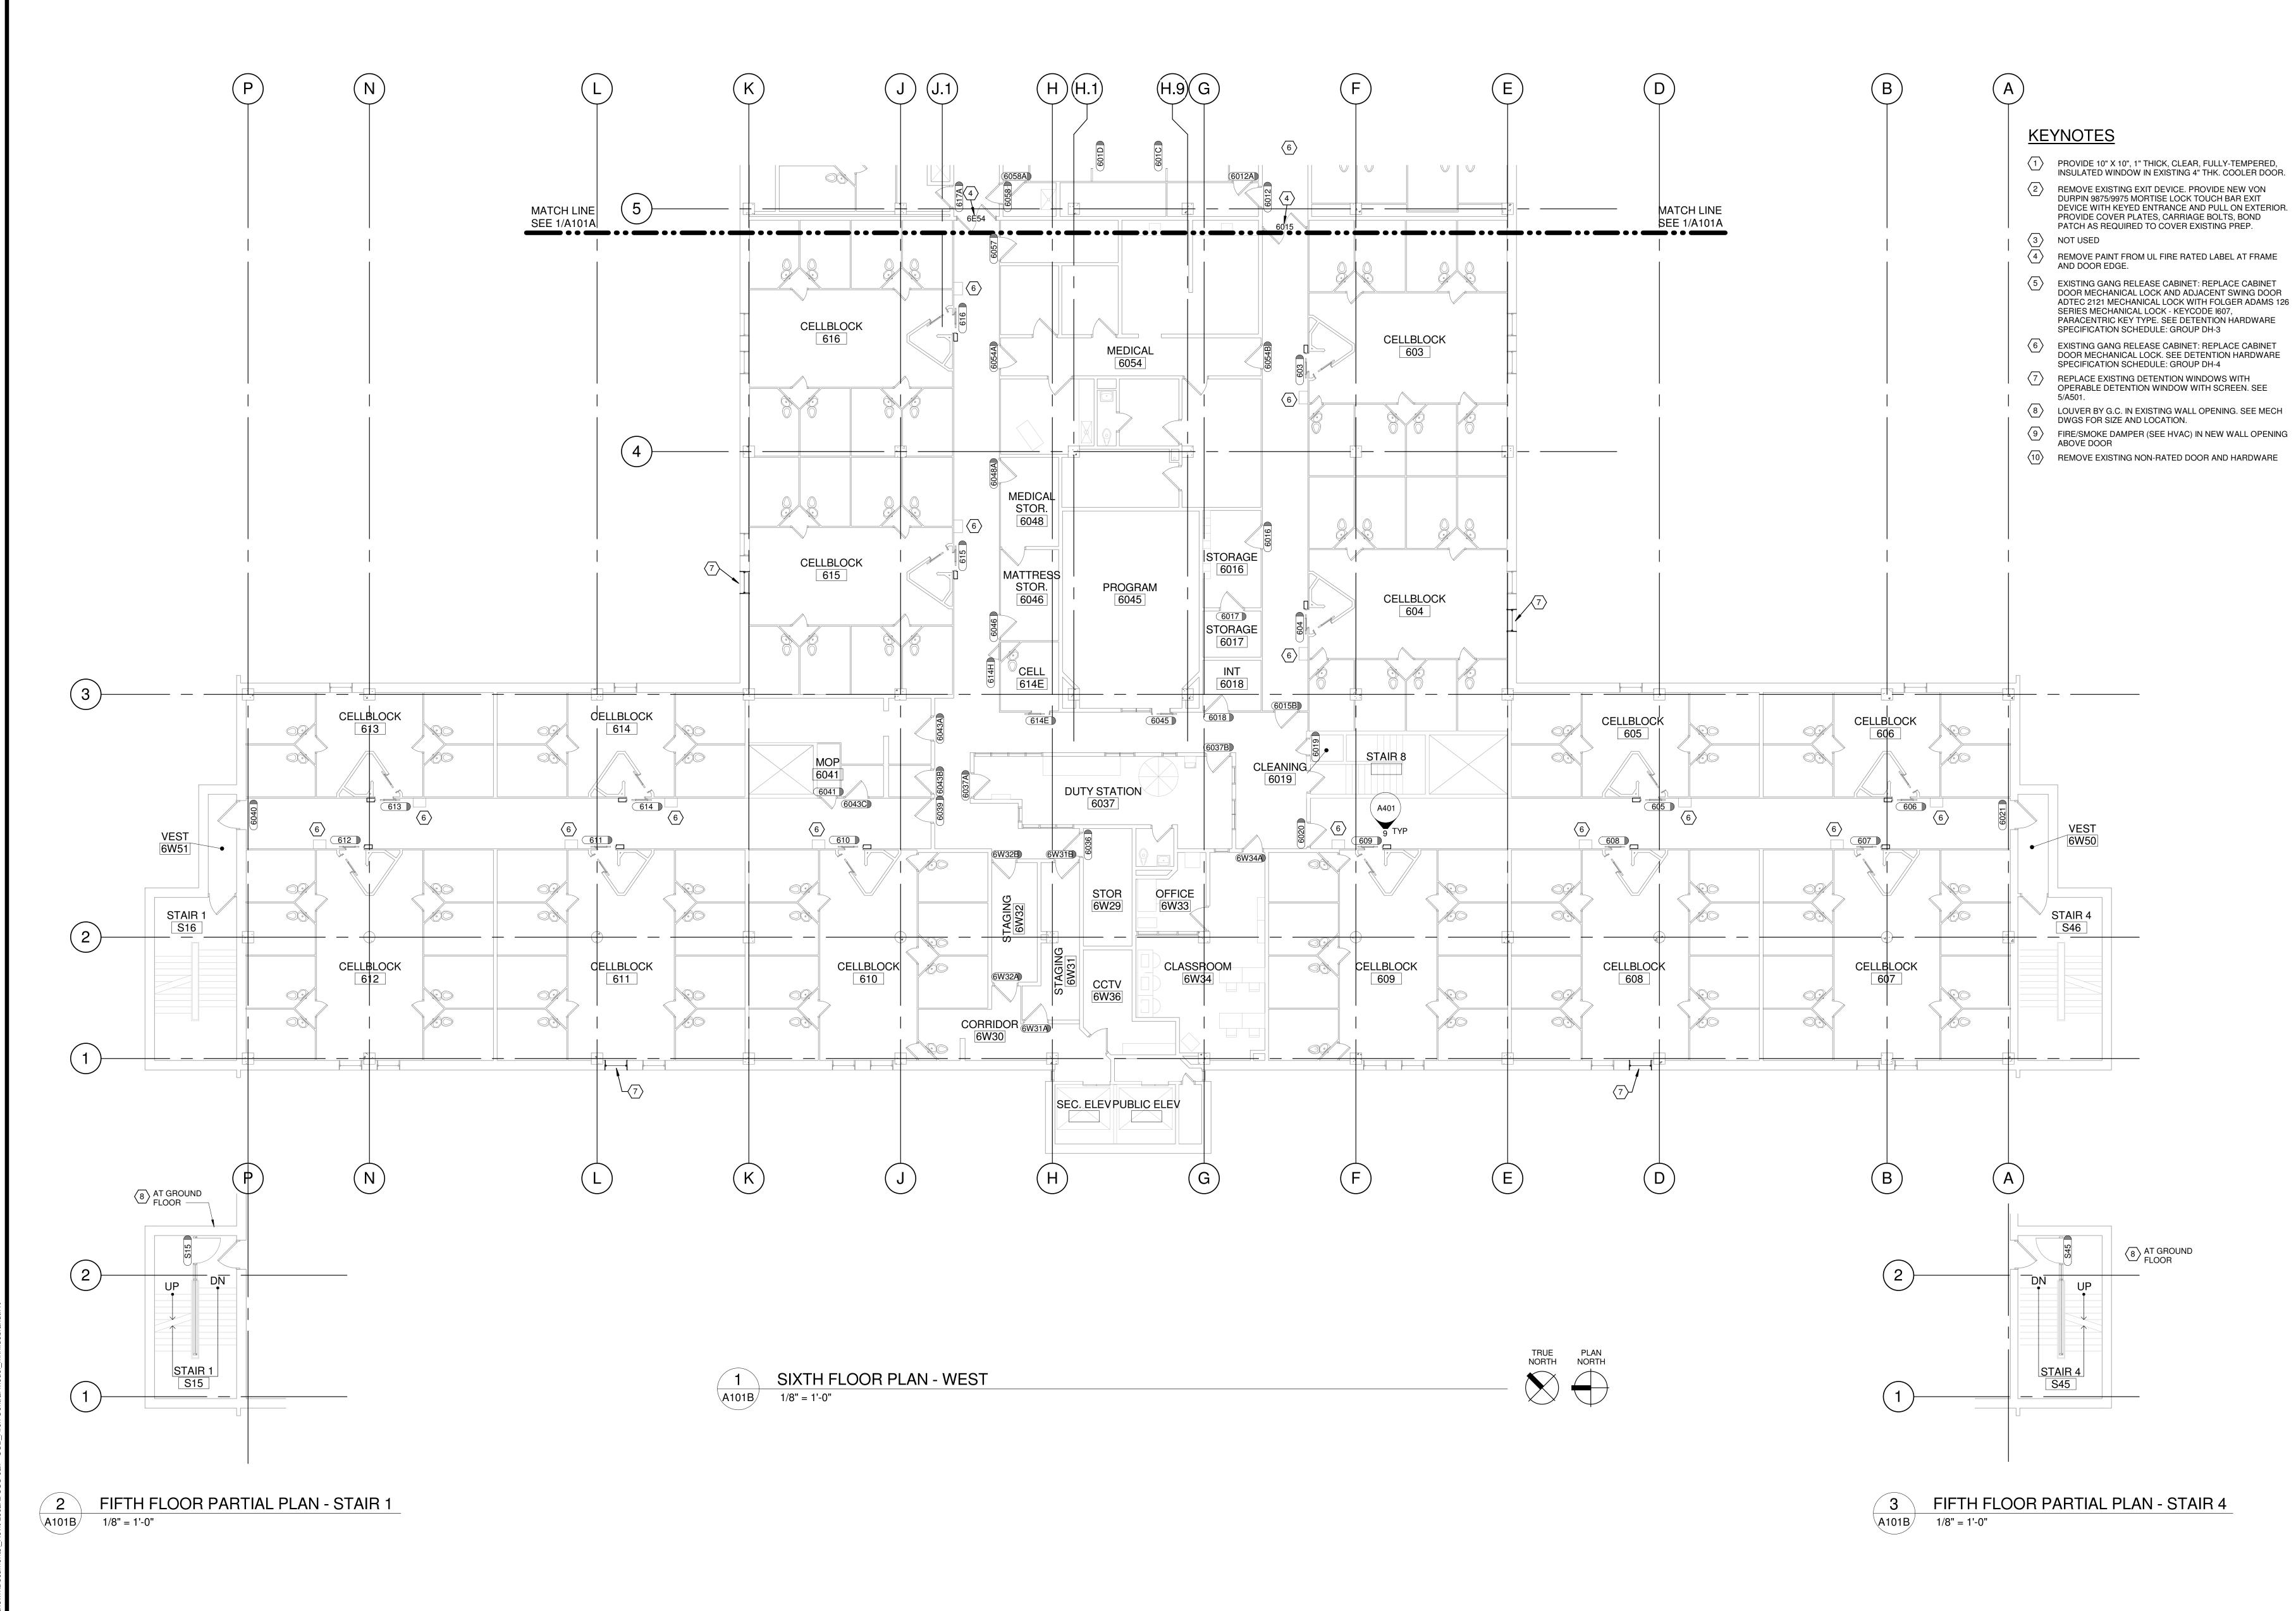

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PROJECT NO. 317006

DANE COUNTY SHERIFF'S OFFICE CCB JAIL MITIGATION UPGRADES


04/04/17 BID DOCUMENTS

BID DOCUMENTS

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SHEET CONTENTS SIXTH FLOOR PLAN

A101B

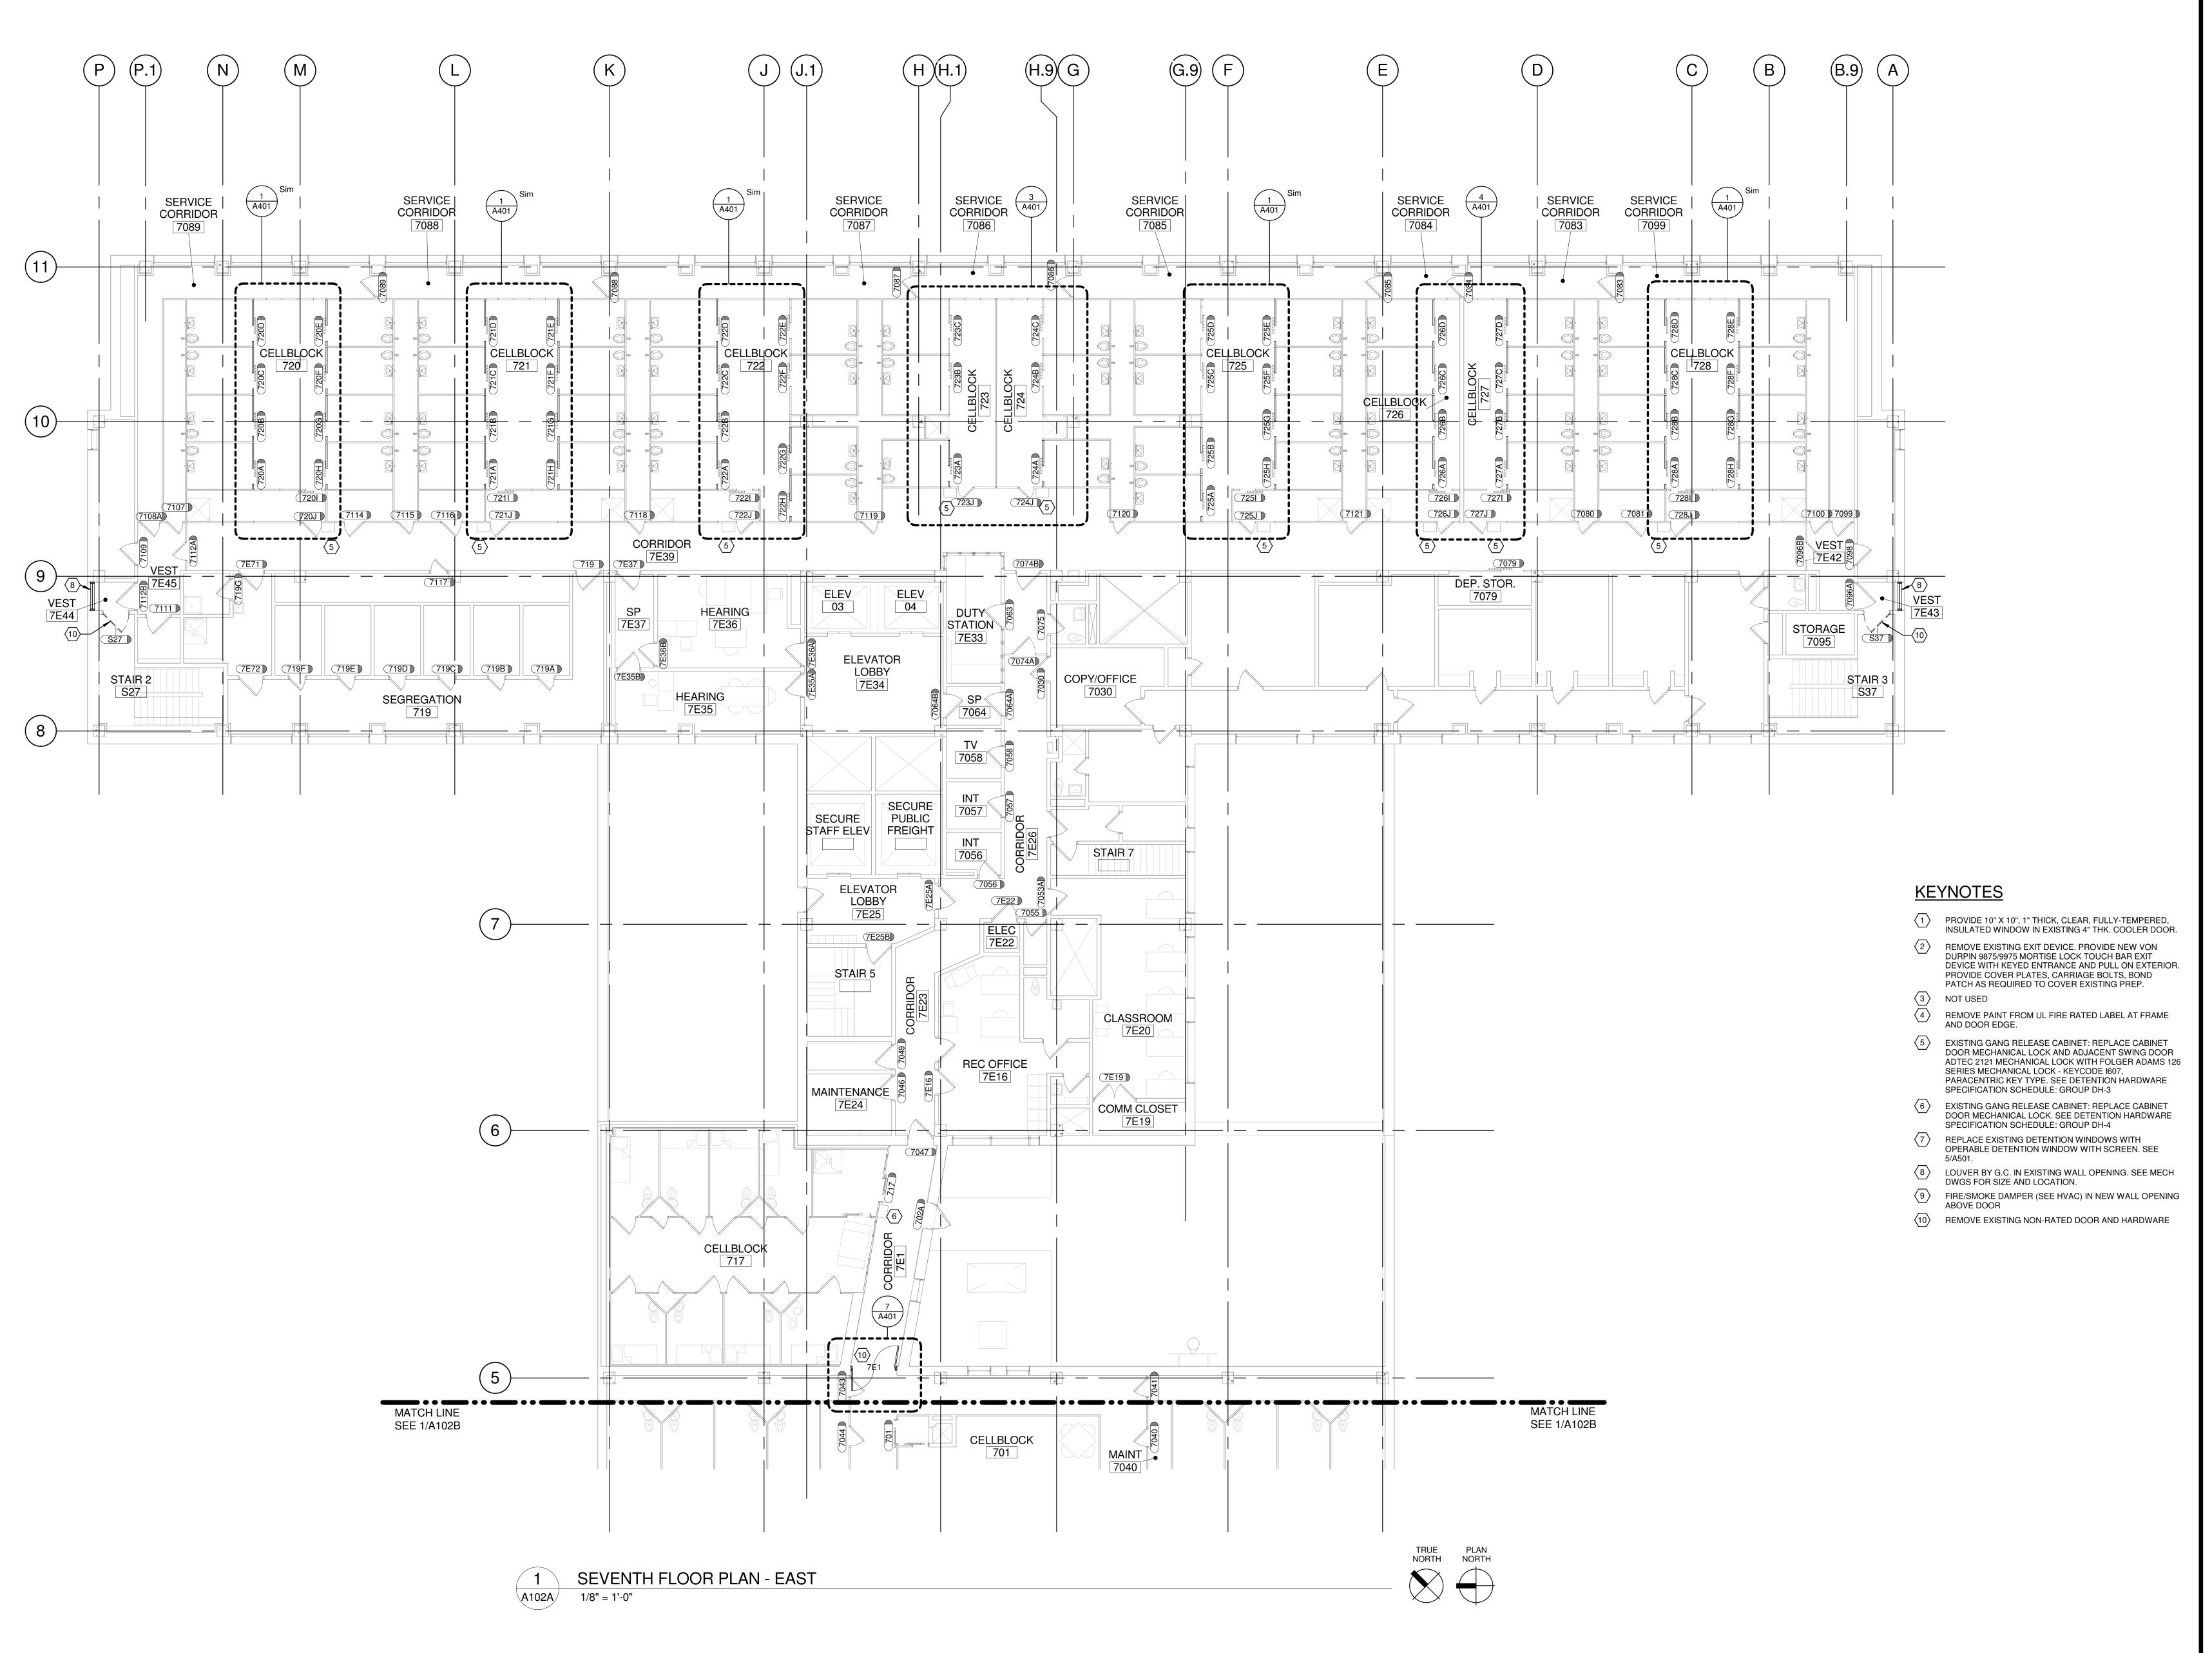

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PROJECT NO. 317006


04/04/17 BID DOCUMENTS

BID DOCUMENTS

M&H NO.: 4215400-161950.01 April 4, 2017 DESIGNED BY: JDH DRAWN BY: MKH CHECKED BY: JDH

SHEET CONTENTS SEVENTH FLOOR PLAN - EAST

A102A

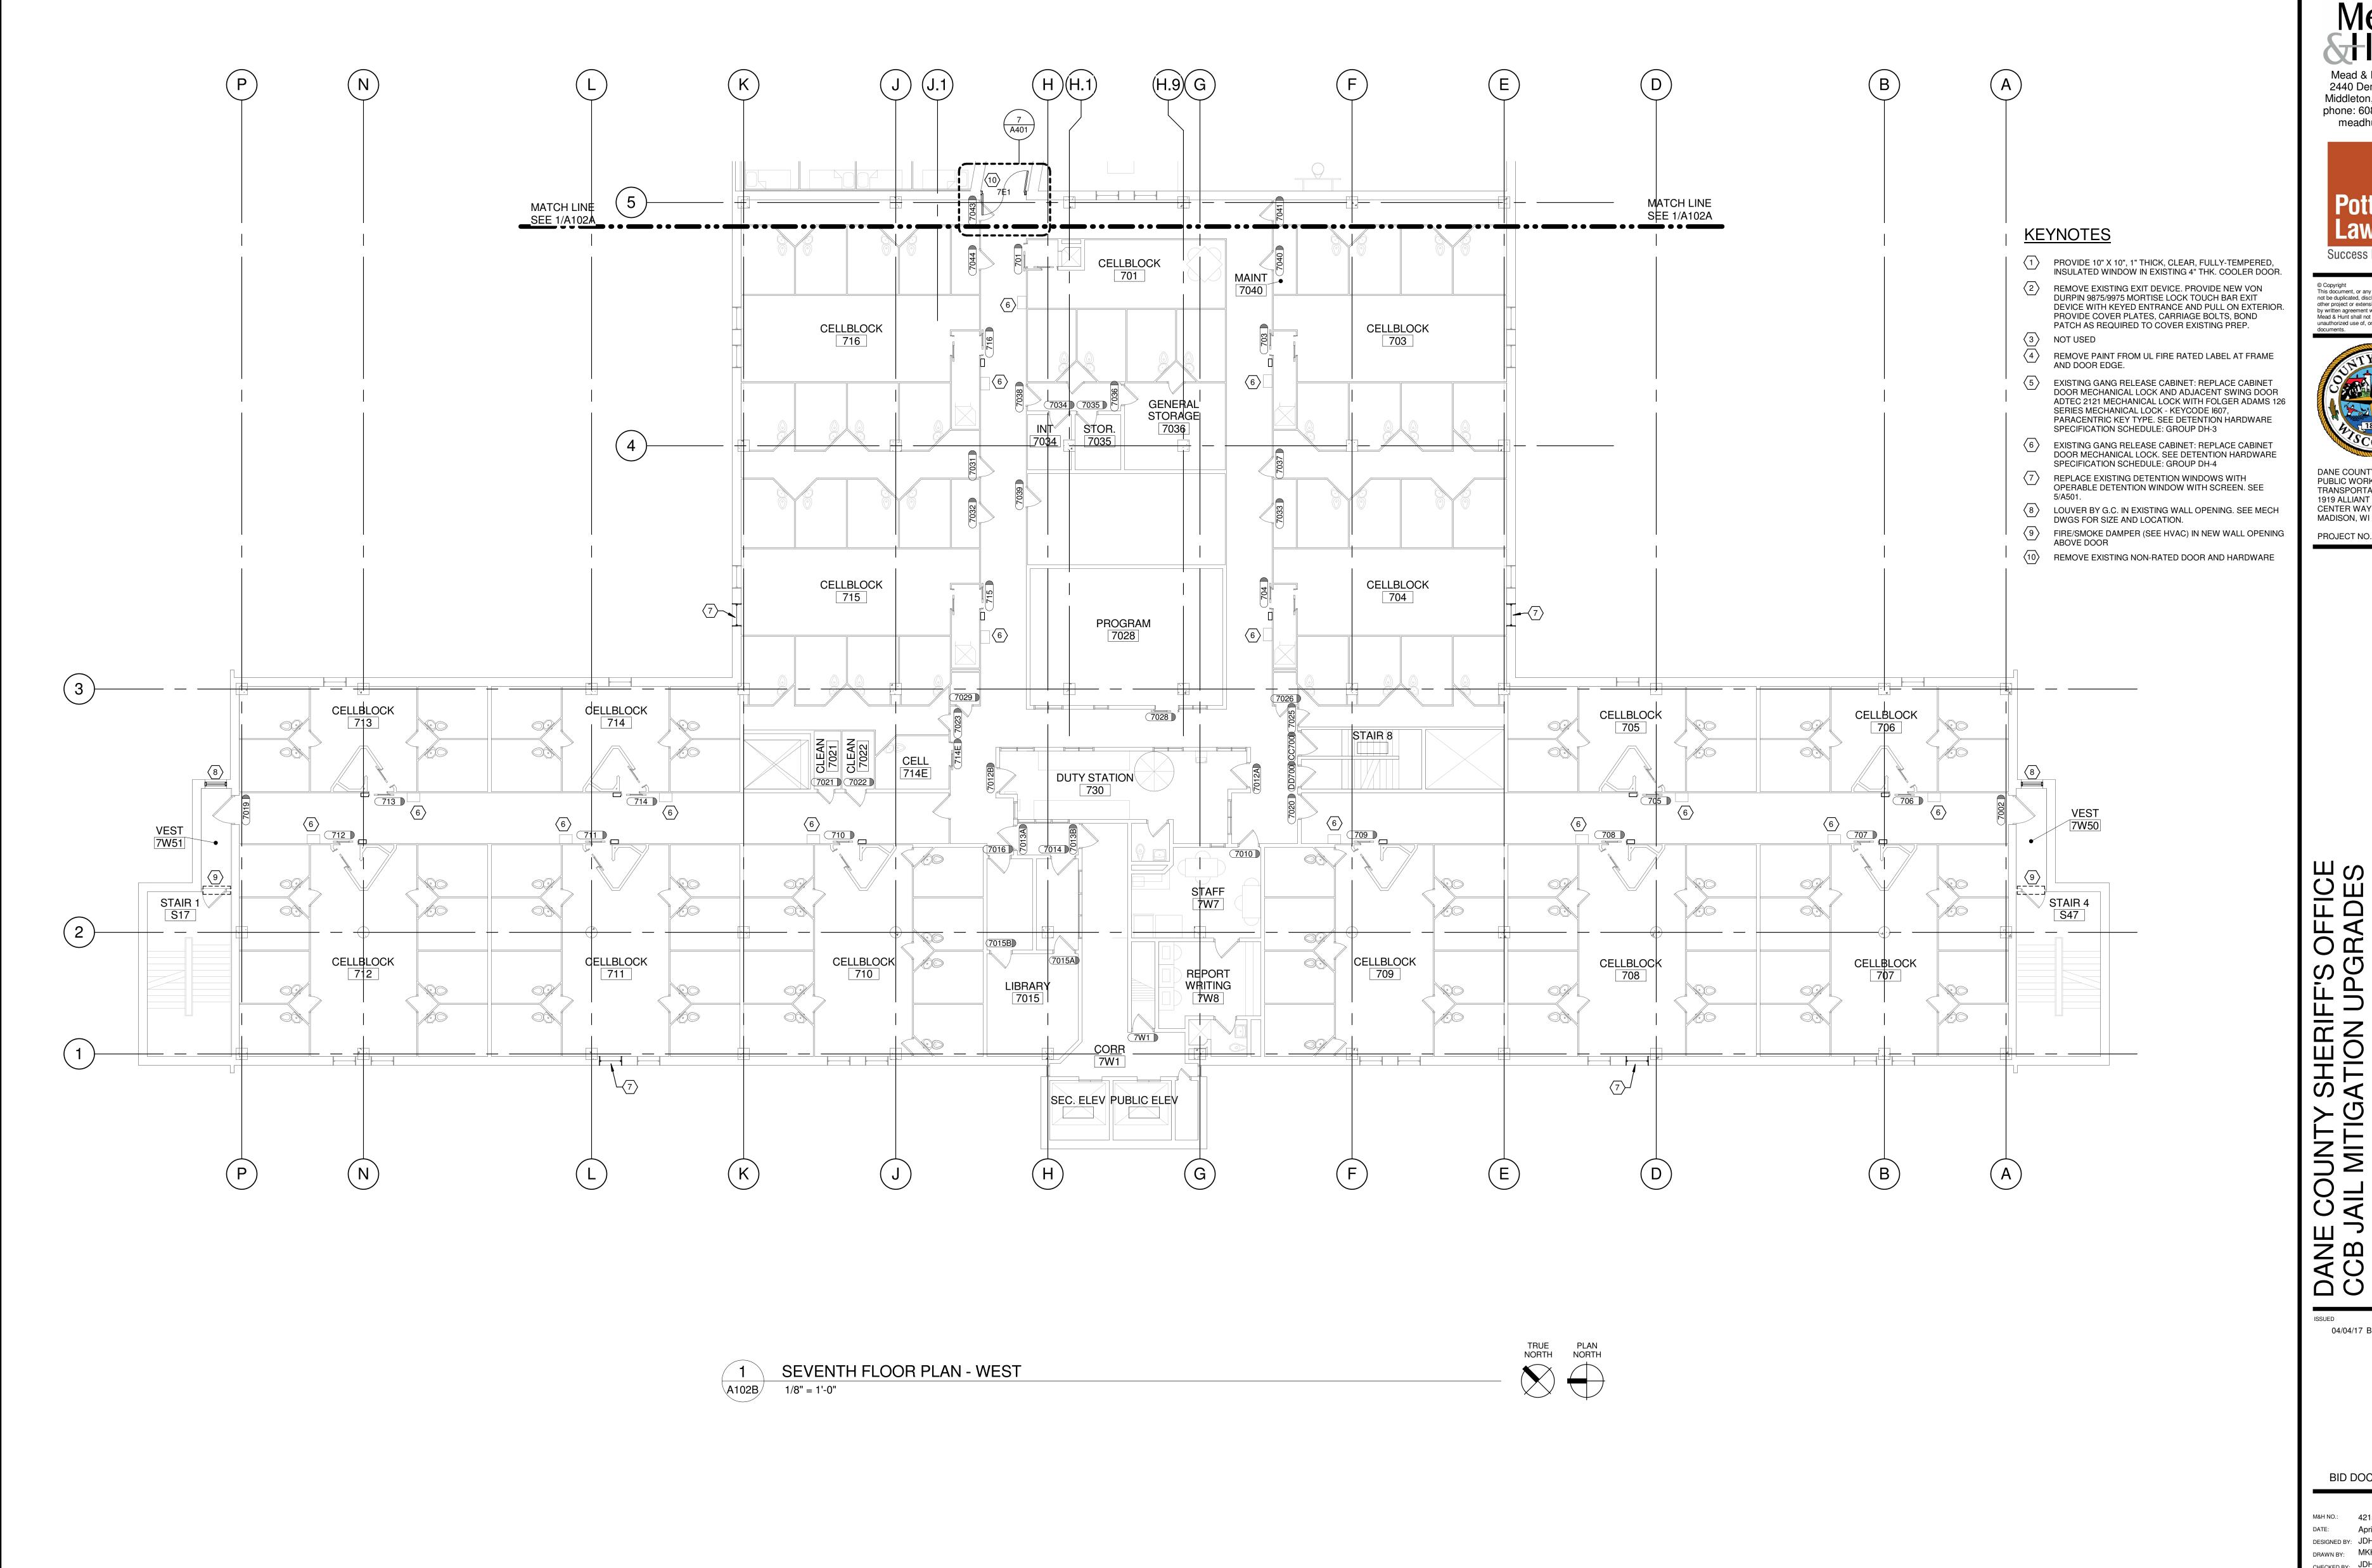

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PROJECT NO. 317006

04/04/17 BID DOCUMENTS


BID DOCUMENTS

M&H NO.: 4215400-161950.01 DATE: April 4, 2017 DESIGNED BY: JDH DRAWN BY: MKH CHECKED BY: JDH

SHEET CONTENTS SEVENTH FLOOR PLAN - WEST

DO NOT SCALE DRAWINGS

A102B

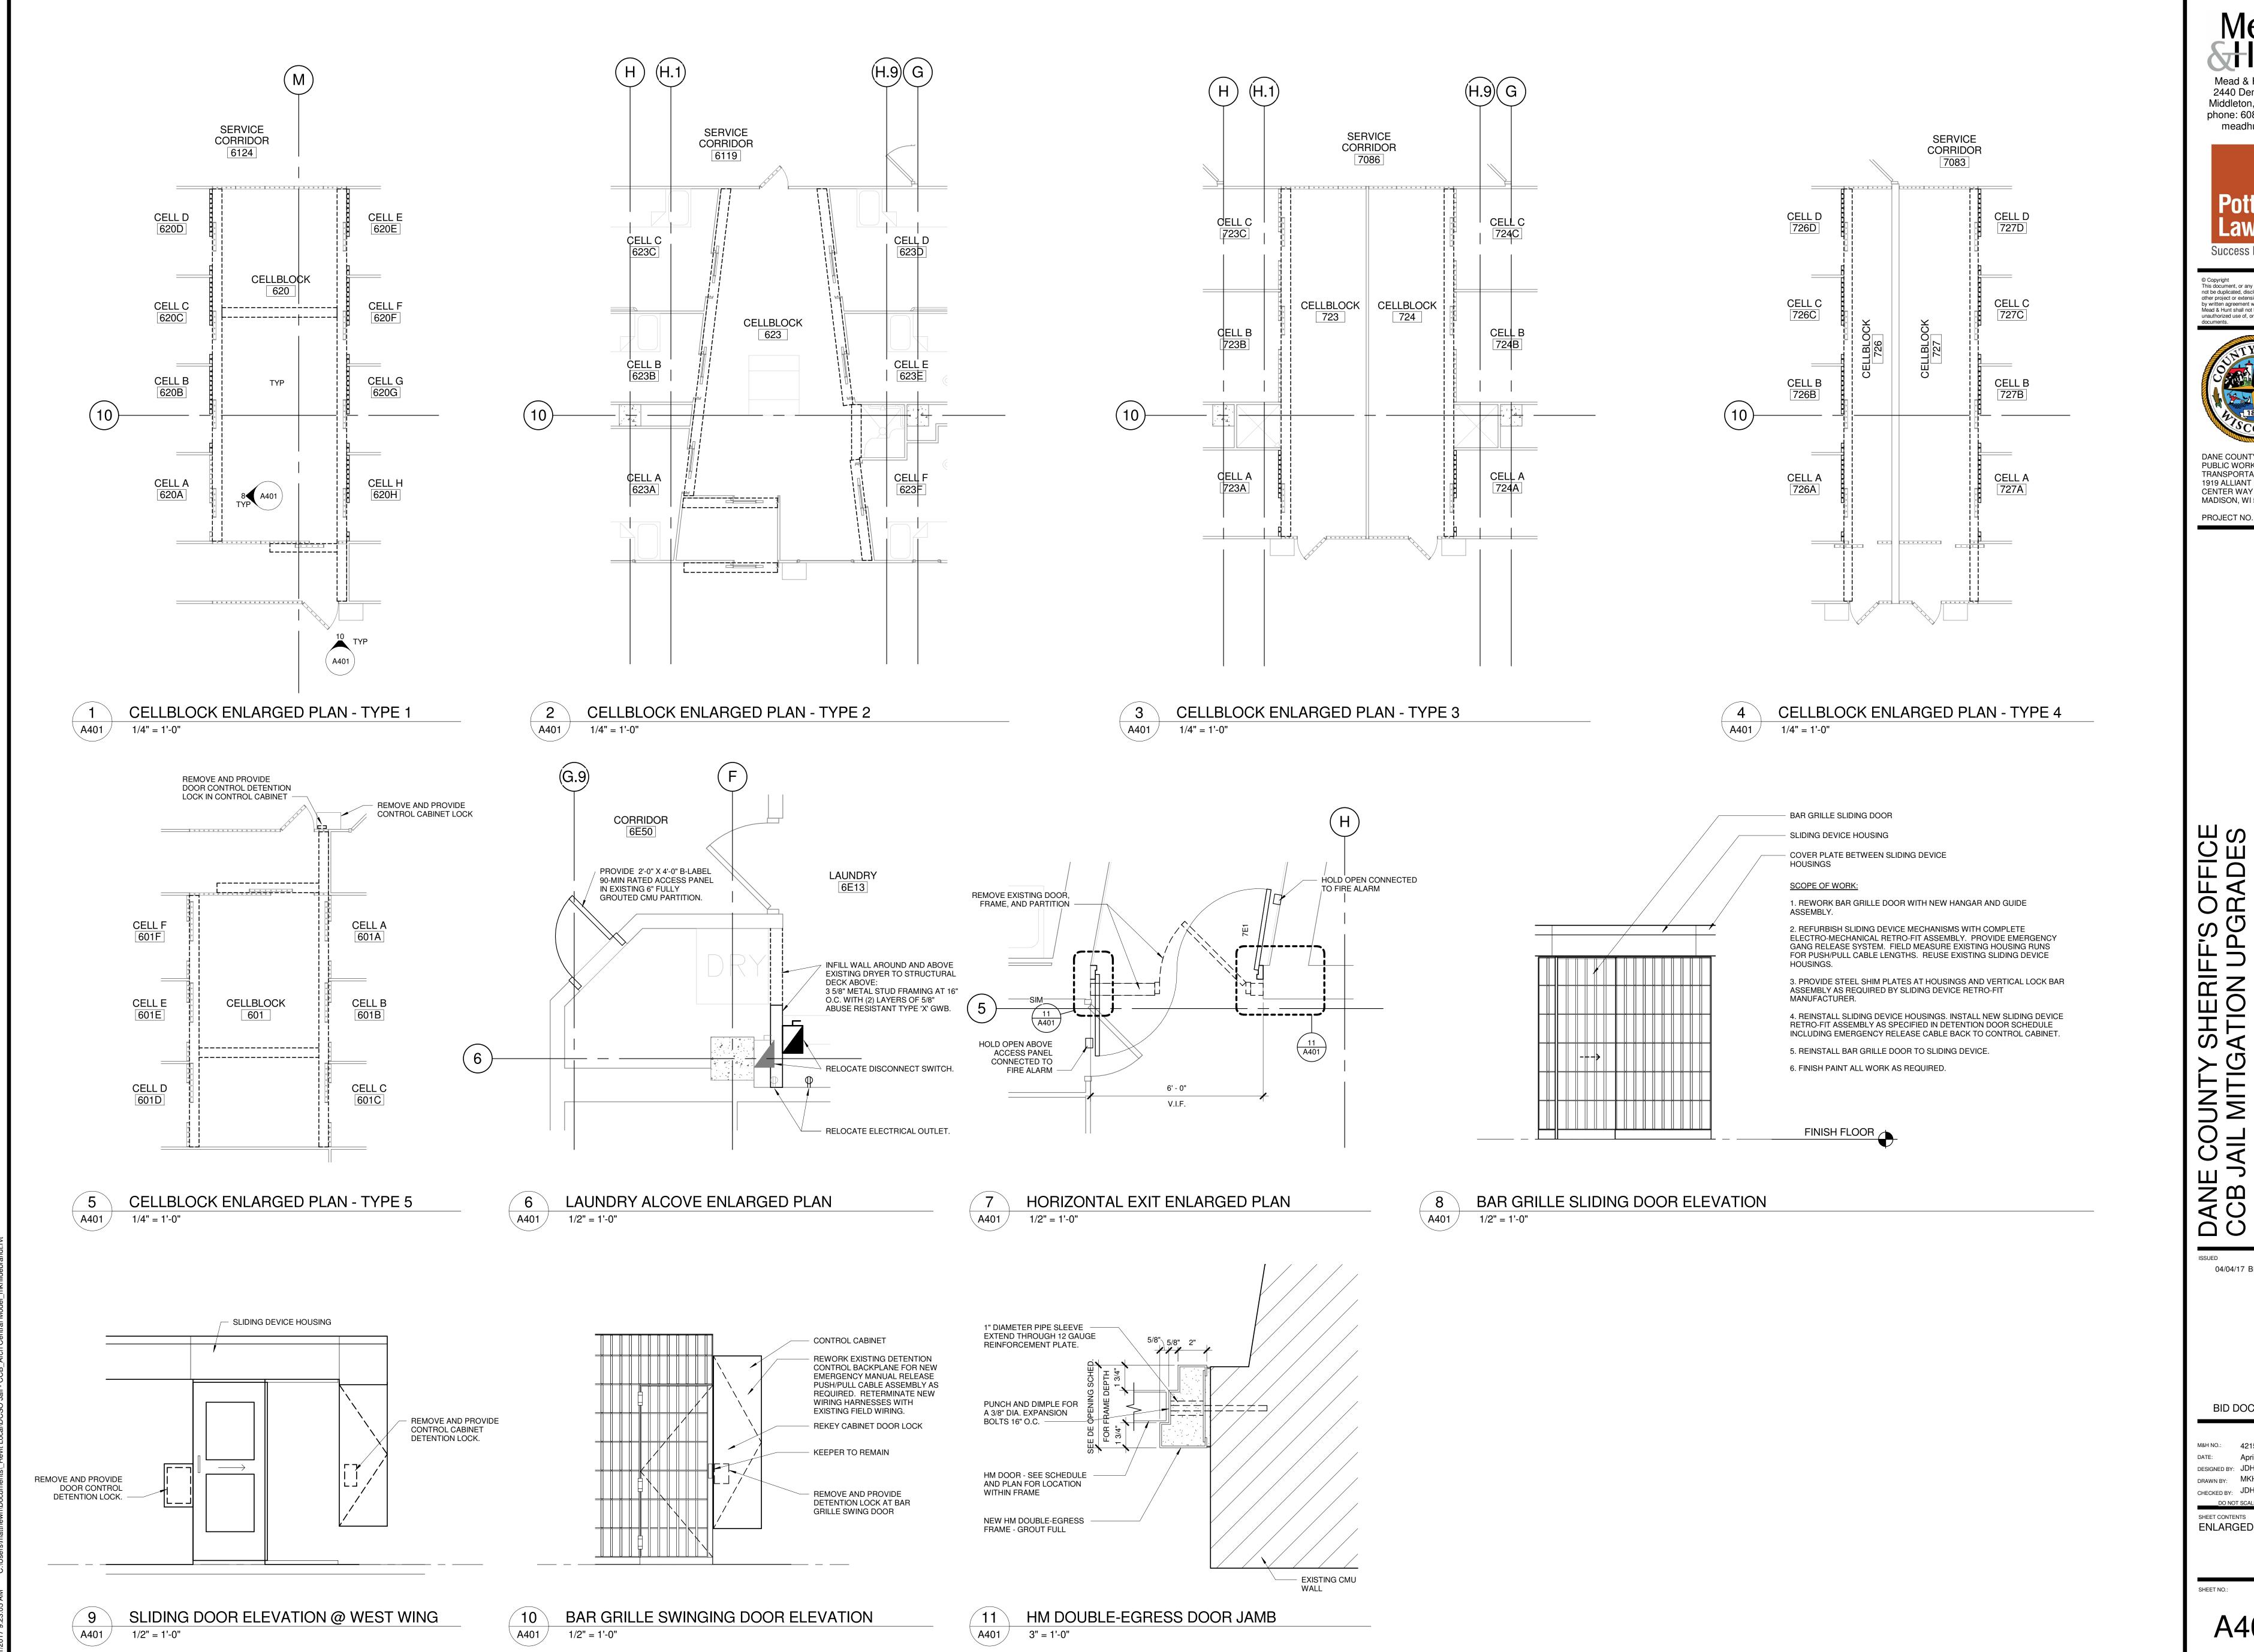

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PROJECT NO. 317006

H H

04/04/17 BID DOCUMENTS

BID DOCUMENTS

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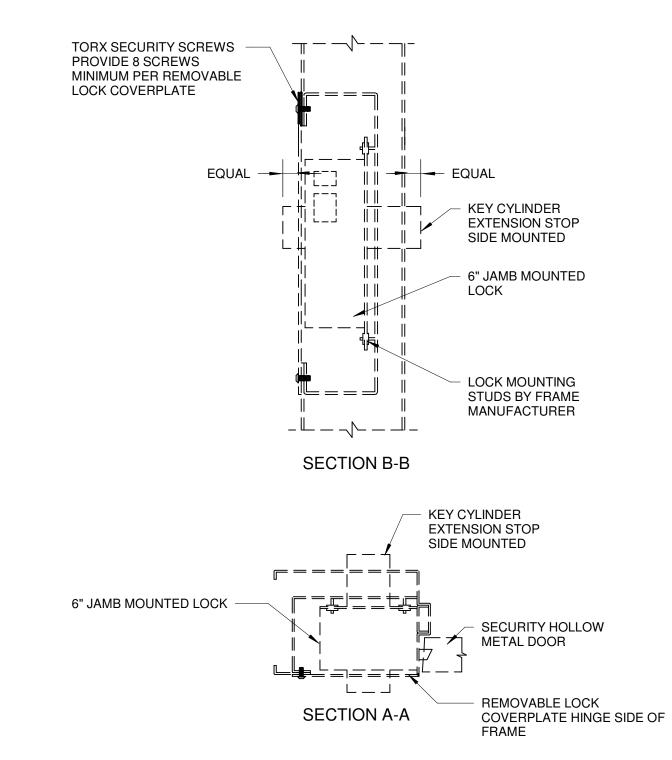
ENLARGED PLANS

__DO NOT SCALE DRAWINGS


SHEET NO.:

A401

WINDOW ELEVATION A501 1/2" = 1'-0"




ELECTRIC LOCK POCKET DETAIL - HINGE SIDE A501 1/4" = 1'-0"

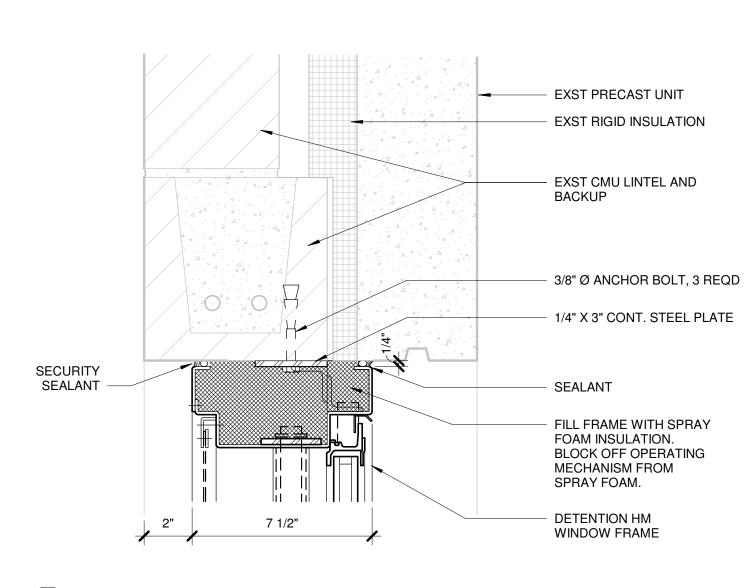


DETENTION WINDOW HEAD


A501 3" = 1'-0"

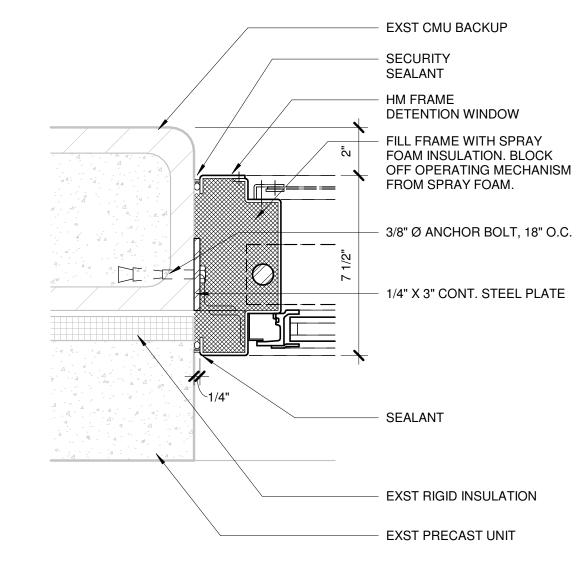

DETENTION WINDOW JAMB \A501 3" = 1'-0"

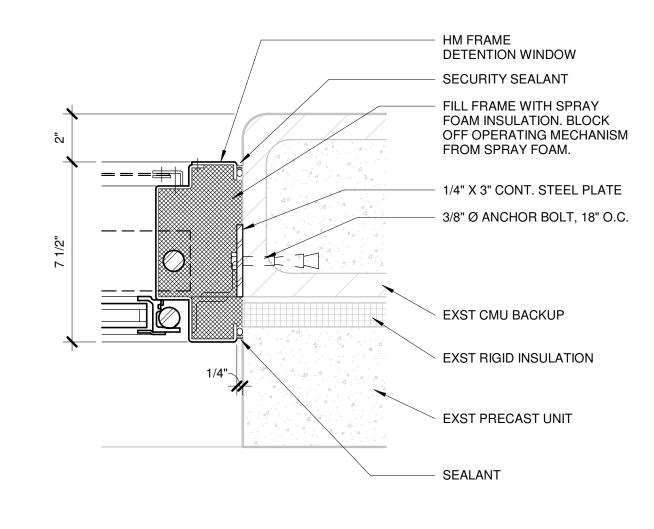

DETENTION WINDOW HINGE JAMB A501 3" = 1'-0"

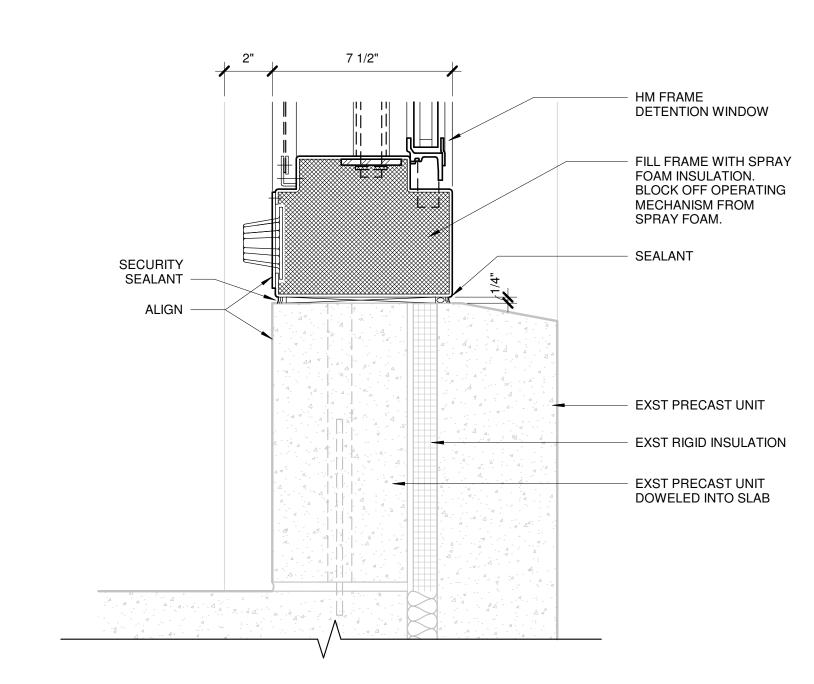

DETENTION WINDOW SILL

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SHERIFF'S

04/04/17 BID DOCUMENTS

BID DOCUMENTS

M&H NO.: 4215400-161950.01 DATE: **April 4, 2017** DESIGNED BY: JDH DRAWN BY: MKH CHECKED BY: JDH DO NOT SCALE DRAWINGS SHEET CONTENTS **DETAILS**

A501

GENERAL NOTES:

- 1. INTEGRATE ALL NEW HARDWARE WITH EXISTING SECURITY SYSTEM ELECTRONICS.
- 2. AT NEW ELECTRO-MECHANICAL LOCK LOCATIONS CONTRACTOR SHALL BE RESPONSIBILE FOR EQUIPING NEW DETENTION LOCKS WITH MOLEX CONNECTORS TO MATCH EXISTING CONDITIONS
- 3. CONTRACTOR TO MASTER AND GRAND MASTER ALL BEST INTERCHANGABLE CORE KEY CYLINDER TO EXISTING MASTER AND GRAND MASTER CODES. COORDINATE WITH OWNER.
- 4. FIELD VERIFY EXISTING DOOR SIZES IF NECESSARY.
- 5. ALL DOORS ARE EXISTING TO BE MODIFIED, EXCEPT WHERE OTHERWISE NOTED.

NOTES:

- 1. RE-KEY EXISTING PARACENTRIC LOCK TO NEW KEY CODE.
- 2. RE-KEY EXISTING MOGUL LOCK TO NEW KEY CODE.
- 3. REPLACE ADTEC MOGUL LOCK WITH NEW FOLGER ADAM EQUIVALENT.
- 4. REPLACE HYBRID FA LOCK & BEST CYLINDER WITH NEW FA MOGUL CYLINDER.
- 5. REPLACE PARACENTRIC KEY CYLINDER AND LEVER TUMBLERS IN EXISTING ADTEC LOCK WITH NEW FOLGER ADAM PARACENTRIC KEY CYLINDER AND LEVEL TUMBLERS.
- 6. RE-KEY EXISTING BUILDER'S HARDWARE TO NEW KEY CODE. CONTRACTOR TO PROVIDE INTERCHANGABLE CORE.
- 7. PROVIDE MOGUL CYLINDER.
- 8. REPLACE EXISTING ELECTRO-MECHANICAL DETENTION LOCK WITH NEW.
- 9. NEW HM DOUBLE-EGRESS DOOR AND FRAME, SEE 11/A401 FOR JAMB DETAIL.
- 10. NEW SWING GATE SIMILAR TO EXISTING DOORS S15 AND S45.
- 11. PROVIDE NEW DETENTION HOLLOW METAL LOCK POCKET.
- 12. EXISTING SWING GATE AND ENCLOSURE.
- 13. PROVIDE DOOR AND FRAME PREP FOR NEW LOCK.
- 14. CONTRACTOR TO VERIFY DOOR GAUGE AND THICKNESS. REWORK DOOR FOR NEW DETENTION LOCK.
- 15. DELETE CLOSER AND FLOOR STOP (STEEL ANGLE). PROVIDE LCN 4210 CLOSER AND PORTLAND SECURITY HARDWARE PSH-760 DOOR STOP (OR EQUAL).
- 16. REPLACE MEDECO MORTISE KEY CYLINDER WITH BEST INTERCHANGEABLE CORE CYLINDER.
- 17. SEE DETAIL 6/A501 FOR LOCK MOUNTING IN NEW LOCK POCKET IN EXISTING FRAME.
- 18. EXISTING BEST CYLINDER/MORTISE LOCKSET.
- 19. REPLACE HYRID BEST/MOGUL CYLINDER WITH NEW MOGUL CYLINDER.
- 20. REPLACE EXISTING BEST CYLINDRICAL PASSAGE SET WITH NEW BEST CYLINDRICAL LOCK. PROVIDE STOREROOM FUNCTION.
- 21. PROVIDE NEW HYBRID MOGUL/BEST KEY CYLINDER WITH INTERCHANGEABLE CORE.
- 22. EXISTING HYBRID MOGUL/BEST KEY CYLINDER TO REMAIN. PROVIDE NEW INTERCHANGEABLE CORE.
- 23. ADTEC PARACENTRIC LOCK ON RHR DOOR TO REMAIN. PROVIDE BLANK COVER PLATE OVER PARACENTRIC KEY CYLINDER ON HINGE SIDE. REMOVE LEVER HANDLE AND PATCH HOLE ON HINGE SIDE.
- 24. REWORK LHR DOOR FOR NEW DETENTION MORTISE LOCK. MOUNT LOCK ABOVE EXISTING CREMONE LOCK PREP.25. UPGRADE SCHLAGE CYLINDRICAL LOCK WITH NEW BEST CYLINDRICAL LOCK WITH INTERCHANGEABLE CORE.
- 26. REKEY TO EXISTING MASTER AND GRAND MASTER CODES. PROVIDE INTERCHANGEABLE CORE.
- 27. REMOVE DOOR PANEL.

Opening	Door info	ormation		ldwr	Lock	ROUND, 1ST, 5T		Key	
Opening Number	Width	Height		roup	Lock Mounting	Existing Lock	Key Code	Type	Notes
GROUND	FLOOR								
S30 GROUND	2' - 8" FLOOR: 1	7' - 0" Door Total			1		E633	Р	10
FIRST FLC S21	3' - 4"	7' - 0"			1		E633	Р	10
FIRST FLC	OOR: 1 Do	or Total	-						
FIFTH FLC	OR								
S15 S45	3' - 4" 3' - 4"	6' - 6" 6' - 6"			1	86 86	E633 E633	P	1, 12 1, 12
FIFTH FLC									.,
SIXTH FLO	OOR								
6E8 6E9	3' - 0" 2' - 4"	7' - 0" 7' - 0"			7 7	2121 2121	I 607	M M	3
6E11A	3' - 8"	7' - 0"		H-12	21	-	I 607	М	14, 18
6E13A 6E14	3' - 0" 3' - 0"	7' - 0" 7' - 0"	D	H-12	20	-	I 607 S10	M C	14, 18 6, 18
6E17	3' - 0"	7' - 0"	_		19	110-02	I 607	М	2
6E18A 6E18B	3' - 0" 2' - 10"	7' - 0" 7' - 0"		DH-8 DH-9	7	2121 56E	E612 E633	M M	11 8, 11
6E22A	3' - 0"	7' - 0"		H-10	7	126	E612	М	11, 17
6E29 6E30	3' - 0" 3' - 0"	7' - 0" 7' - 0"			9	2121 2121	I 607	M M	<u>3</u> 3
6E31A	3' - 0"	7' - 0"			9	2121	I 607	М	3
6E31B 6E34	3' - 0" 2' - 6"	7' - 0" 8' - 0"			19 15	2110-1 36	I 607	M P	3 1
6E35A 6E35B	2' - 6" 3' - 0"	7' - 0" 7' - 0"	D	H-10	7 7	126 2121	E612 S49BC4	M M	11, 17 3
6E50	3' - 6"	7' - 0"			7	56E	E612	Р	1
6E53 6E54	2' - 0" 5' - 0"	7' - 0" 7' - 0"	90		4	4012	S49BC4	Р	1
6E54A	2' - 8"	7' - 0"			2	4076	S49BC4	Р	5
6E60 6E80	3' - 0" 3' - 0"	7' - 0" 7' - 0"			7	4076 2121	S49BC4 I 607	P M	<u>5</u> 3
6E81	3' - 0"	7' - 0"			20	110-01	S49BC4	М	2
6W31A 6W31B	3' - 0" 3' - 0"	7' - 0" 7' - 0"		DH-9	12 12	2121 126	I 607	M M	3 11
6W32A 6W32B	3' - 0" 3' - 0"	7' - 0" 7' - 0"			7	126 126	I 607	М	2
6W34A	2' - 6"	7' - 0"		DH-9	12 7	126 126	I 607	M M	11 2
601A 601B	2' - 9" 2' - 9"	6' - 4" 6' - 4"		DH-1 DH-1					
601C	2' - 9"	6' - 4")H-1					
601D 601E	2' - 9" 2' - 9"	6' - 4" 6' - 4"		DH-1 DH-1					
601F	2' - 9"	6' - 4"		DH-1					
601G 601GA	2' - 0" 2' - 0"	7' - 0" 7' - 0"			4	66 62	I 607	P P	<u>1</u> 1
601H	2' - 0"	7' - 0"			1	66	I 607	Р	1
601HA 601I	2' - 0" 3' - 0"	7' - 0" 6' - 4"		DH-2	4	62	I 607	Р	1
601J	2' - 4"	6' - 4"		DH-5			I 607	М	
602 603	4' - 0" 4' - 0"	6' - 4" 6' - 4"		DH-7 DH-7	9		I 607	P P	
604	4' - 0"	6' - 4"		DH-7	18		I 607	Р	
605 606	4' - 0" 4' - 0"	6' - 4" 6' - 4"		DH-7 DH-7	18 19		E612 I 607	P P	
607	4' - 0"	6' - 4"		DH-7	18		1 607	Р	
608 609	4' - 0" 4' - 0"	6' - 4" 6' - 4"		DH-7 DH-7	18 18		I 607	P P	
610 611	4' - 0" 4' - 0"	6' - 4" 6' - 4"		DH-7 DH-7	18 18		I 607	P P	
612	4' - 0"	6' - 4"		DH-7	18		I 607	Р	
613 614	4' - 0" 4' - 0"	6' - 4" 6' - 4"		DH-7 DH-7	18 18		I 607	P P	
614E	4' - 0"	7' - 0"		7117	16	32	I 607	Р	1
614H 615	2' - 0" 4' - 0"	7' - 0" 6' - 4"	Г	DH-7	4 18	12	S49BC4 I 607	P P	1
616	4' - 0"	6' - 4"		DH-7	18		I 607	Р	_
617A 617J	2' - 8" 2' - 6"	7' - 0" 7' - 0"	ח	H-11	19 9	110-02	S49BC4 I 607	M P	2 13
619J	2' - 6"	7' - 0"			4	62	I 607	P	1
620A 620B	2' - 0" 2' - 0"	6' - 4" 6' - 4"		DH-1 DH-1					
620C 620D	2' - 0" 2' - 0"	6' - 4" 6' - 4"		DH-1 DH-1					
620E	2' - 0"	6' - 4")H-1					
620F 620G	2' - 0" 2' - 0"	6' - 4" 6' - 4"		DH-1 DH-1					
620H	2' - 0"	6' - 4"		DH-1					
620I 620J	2' - 0" 2' - 6"	6' - 4" 6' - 3"		DH-2	9	122	I 607	M	2
621A	2' - 0"	6' - 4"		DH-1					-
621B 621C	2' - 0" 2' - 0"	6' - 4" 6' - 4"		DH-1 DH-1					
621D	2' - 0"	6' - 4"		DH-1					
621E 621F	2' - 0" 2' - 0"	6' - 4" 6' - 4"		DH-1 DH-1					
621G 621H	2' - 0" 2' - 0"	6' - 4" 6' - 4"		DH-1 DH-1					
621I	2' - 0"	6' - 4")H-1)H-2					
621J 622A	2' - 6" 2' - 0"	6' - 3" 6' - 4"		DH-1	9	122	I 607	М	2
622B	2' - 0"	6' - 4")H-1					
622C 622D	2' - 0" 2' - 0"	6' - 4" 6' - 4"		DH-1 DH-1					
622E	2' - 0"	6' - 4"		DH-1					
622F 622G	2' - 0" 2' - 0"	6' - 4" 6' - 4"		DH-1 DH-1					
622H	2' - 0"	6' - 4"		DH-1					
622I 622J	2' - 0" 2' - 0"	6' - 4" 6' - 4"		DH-2	9	122	I 607	M	2
623A	3' - 4"	7' - 0"		DH-1	3	166	1 007	141	_
623B 623C	3' - 4" 3' - 4"	7' - 0" 7' - 0"		DH-1 DH-1					
623D	3' - 4"	7' - 0"	[DH-1					
623E 623F	3' - 4"	7' - 0" 7' - 0")H-1)H-1					
623F	3' - 4"	7' - 0"		DH-1					

Opening Number	Door info	Height	Label	Hdwr Group	Lock Mounting	Existing Lock	Key Code	Key Type	Notes
624A	2' - 0"	6' - 4"		DH-1					
624B	2' - 0"	6' - 4"		DH-1					
624C	2' - 0"	6' - 4"		DH-1					
624D 624E	2' - 0" 2' - 0"	6' - 4" 6' - 4"		DH-1 DH-1					
624E 624F	2' - 0"	6' - 4"		DH-1 DH-1					
624G	2' - 0"	6' - 4"		DH-1					
624H	2' - 0"	6' - 4"		DH-1					
6241	2' - 0"	6' - 4"		DH-2		100	1.007	N #	^
624J 625A	2' - 0" 2' - 0"	6' - 4" 6' - 4"		DH-1	9	122	I 607	M	2
625B	2' - 0"	6' - 4"		DH-1					
625C	2' - 0"	6' - 4"		DH-1					
625D	2' - 0"	6' - 4"		DH-1					
625E 625F	2' - 0" 2' - 0"	6' - 4" 6' - 4"		DH-1 DH-1					
625G	2' - 0"	6' - 4"		DH-1					
625H	2' - 0"	6' - 4"		DH-1					
625I	2' - 0"	6' - 4"		DH-2					
625J	2' - 6"	6' - 3"		DUI	9	122	I 607	М	2
626A 626B	2' - 0" 2' - 0"	6' - 4" 6' - 4"		DH-1 DH-1					
626C	2' - 0"	6' - 4"		DH-1					
626D	2' - 0"	6' - 4"		DH-1					
626E	2' - 0"	6' - 4"		DH-1					
626F	2' - 0"	6' - 4"		DH-1					
626G 626H	2' - 0" 2' - 0"	6' - 4" 6' - 4"		DH-1 DH-1					
626I	2' - 0"	6' - 4"		DH-2					
626J	2' - 6"	6' - 3"			9	122	I 607	М	2
627J	2' - 6"	7' - 0"			4	62	1607	Р	1
6001 6002	2' - 4" 2' - 8"	7' - 0" 7' - 0"			2	66 76	S49BC4 E612	P P	1 1
6002 6003A	2' - 8"	7' - 0"			I	70	<u></u> ⊏01∠	F	No work.
6003B	2' - 6"	7' - 0"							No work.
6010	2' - 6"	7' - 0"			2	66	S49BC4	Р	1
6012	2' - 6"	7' - 0"			21	110-01	I 607	M	2
6012A 6015	2' - 4" 5' - 8"	7' - 0" 7' - 0"	90		4	12	S49BC4	Р	1
6015B	3' - 0"	7' - 0"	50		1	76	E612	Р	1
6016	3' - 0"	7' - 0"			21	110-01	I 607	М	2
6017	3' - 0"	7' - 0"			20	110-01	S49BC4	М	2
6018	3' - 0" 2' - 0"	7' - 0" 7' - 0"		DH 44	21	110-01	I 607	M	2
6019 6020	2' - 0" 3' - 0"	7' - 0" 7' - 0"		DH-14 DH-15	20 20	110-01	S10 E612	C	2, 21
6020	3' - 6"	7' - 0"		211 10	7	56	E612	P	1
6036	3' - 0"	7' - 0"			7	126	S49BC4	М	2
6037A	3' - 0"	7' - 0"			21	110-01	S49BC4	M	2
6037B	3' - 0" 3' - 0"	7' - 0" 7' - 0"		DU 10	21	110-01	S49BC4	M	2
6039 6040	3' - 0" 3' - 6"	7' - 0"		DH-13	19 7	56	E612 E612	M P	14 1
6041	2' - 0"	7' - 0"		DH-14	20	110-01	S10	C	2, 21
6043A	3' - 0"	7' - 0"			21	110-01	S10	С	22
6043B	3' - 0"	7' - 0"			21		S10	С	6, 18
6043C 6045	3' - 0" 4' - 0"	7' - 0" 7' - 0"			21 16	32	S10 I 607	C P	6, 18 1
6045	3' - 0"	7' - 0"			16 21	32 110-01	I 607	M	1 4
6048A	3' - 0"	7' - 0"					. 507		•
6054A	3' - 0"	7' - 0"			19	110-02	I 607	М	2
6054B	3' - 0"	7' - 0"			19	110-02	1607	M	2
6057 6058	3' - 0" 2' - 6"	7' - 0" 7' - 0"			21 20	110-01 110-01	I 607	M M	2 2
6058A	2' - 6"	7' - 0"			20	110-01	1 007	IVI	۷
6078	2' - 6"	7' - 0"			21	110-01	I 607	М	7
6079	3' - 0"	7' - 0"			20	110-01	I 607	М	19
6098B	3' - 0"	7' - 0"			1	66	S49BC4	Р	1
6099A 6099B	2' - 6" 2' - 6"	7' - 0" 7' - 0"			1	66	S49BC4	Р	No work.
6102A	3' - 0"	8' - 0"			7	56E	E612	P	1
6102B	3' - 0"	8' - 0"			7	56E	E612	Р	1
6103A	2' - 4"	6' - 4"		DH-8	1	56E	S49BC4	Р	8, 11
6104	1' - 6"	7' - 0"			4	12	S49BC4	P	1
6104A 6105	2' - 0" 2' - 6"	7' - 0" 7' - 0"			2	4017 66	S49BC4 S49BC4	P P	1
6106	2' - 6"	7' - 0"			2	66	S49BC4 S49BC4	P	<u> </u>
6107	3' - 4"	6' - 8"	90		1	66	E612	P	1
6108	2' - 6"	7' - 0"			21	110-01	S49BC4	М	2
6109	2' - 6"	7' - 0"			2	66	S49BC4	P	1
6110 6111	2' - 0" 2' - 4"	7' - 0" 7' - 0"			4	12 62	S49BC4 I 607	P P	<u>1</u> 1
6112	2' - 4"	7 - 0"			4	62	I 607	P	<u> </u>
6114	2' - 0"	7' - 0"			4	12	S49BC4	Р	1
6115	2' - 6"	7' - 0"			2	66	S49BC4	Р	1
6116	2' - 0"	7' - 0"			4	12	S49BC4	P	1
6117 6118	2' - 6" 2' - 0"	7' - 0" 7' - 0"			2	66 12	S49BC4 S49BC4	P P	<u>1</u> 1
6119	2' - 6"	7' - 0"			2	66	S49BC4 S49BC4	P	<u></u> 1
6120	2' - 0"	7' - 0"	_		4	12	S49BC4	Р	1
6121	2' - 0"	7' - 0"			4	12	S49BC4	Р	1
6122	2' - 6"	7' - 0"			2	66	S49BC4	P	1
6123 6124	2' - 0" 2' - 6"	7' - 0" 7' - 0"			2	12 66	S49BC4 S49BC4	P P	1 1
6125	2' - 0"	7 - 0"			4	12	S49BC4 S49BC4	P	1
6127	2' - 6"	7' - 0"			21	110-01	S49BC4	М	2
6128	2' - 6"	7' - 0"			2	66	S49BC4	Р	1
6128A	3' - 4"	6' - 8"	90		1	66	E612	Р	1
6129 6129A	2' - 6" 2' - 4"	7' - 0" 6' - 4"		DH 0	2	66 56E	S49BC4	P P	1 8 11
6129A 6130	2' - 4" 1' - 6"	6' - 4" 7' - 0"		DH-8	7	56E 12	S49BC4 S49BC4	P	8, 11 1
6130A	2' - 0"	7' - 0"			4	12	S49BC4 S49BC4	P	<u></u> 1
6131	2' - 4"	7' - 0"			4	62	I 607	P	1
6132	2' - 6"	7' - 0"			2	66	S49BC4	Р	1
6133 Deco	2' - 4"	7' - 0"			4	62	S49BC4	P	1
D600 S26	3' - 0" 3' - 4"	7' - 0" 6' - 8"		-	2	86	E612	Р	No work.
	, J +	, J U	I	1					No work.

DE DOOR SCHEDULE - GROUND, 1ST, 5TH & 6TH FLOORS



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DANE COUNTY DEPT. OF PUBLIC WORKS, HIGHWAY & TRANSPORTATION 1919 ALLIANT ENERGY CENTER WAY MADISON, WI 53713 PROJECT NO. 317006

ROJECT NO. 317000

COUNTY SHERIFF'S OFFICAIL MITIGATION UPGRADE

UED 04/04/17 BID DOCUMENTS

DANE CCB J

BID DOCUMENTS

M&H NO.: 4215400-161950.01

DATE: April 4, 2017

DESIGNED BY: JDH

DRAWN BY: MKH

CHECKED BY: JDH

SHEET CONTENTS
DOOR SCHEDULE

SHEET NO.:

A601

GENERAL NOTES:

- 1. INTEGRATE ALL NEW HARDWARE WITH EXISTING SECURITY SYSTEM ELECTRONICS.
- 2. AT NEW ELECTRO-MECHANICAL LOCK LOCATIONS CONTRACTOR SHALL BE RESPONSIBILE FOR EQUIPING NEW DETENTION LOCKS WITH MOLEX CONNECTORS TO MATCH EXISTING CONDITIONS
- 3. CONTRACTOR TO MASTER AND GRAND MASTER ALL BEST INTERCHANGABLE CORE KEY CYLINDER TO EXISTING MASTER AND GRAND MASTER CODES. COORDINATE WITH OWNER.
- 4. FIELD VERIFY EXISTING DOOR SIZES IF NECESSARY.
- 5. ALL DOORS ARE EXISTING TO BE MODIFIED, EXCEPT WHERE OTHERWISE NOTED.

NOTES:

- 1. RE-KEY EXISTING PARACENTRIC LOCK TO NEW KEY CODE.
- 2. RE-KEY EXISTING MOGUL LOCK TO NEW KEY CODE.
- 3. REPLACE ADTEC MOGUL LOCK WITH NEW FOLGER ADAM EQUIVALENT.
- 4. REPLACE HYBRID FA LOCK & BEST CYLINDER WITH NEW FA MOGUL CYLINDER.
- 5. REPLACE PARACENTRIC KEY CYLINDER AND LEVER TUMBLERS IN EXISTING ADTEC LOCK WITH NEW FOLGER ADAM PARACENTRIC KEY
- CYLINDER AND LEVEL TUMBLERS.

 6. RE-KEY EXISTING BUILDER'S HARDWARE TO NEW KEY CODE. CONTRACTOR TO PROVIDE INTERCHANGABLE CORE.
- 7. PROVIDE MOGUL CYLINDER.
- 8. REPLACE EXISTING ELECTRO-MECHANICAL DETENTION LOCK WITH NEW.
- 9. NEW HM DOUBLE-EGRESS DOOR AND FRAME, SEE 11/A401 FOR JAMB DETAIL.
- 10. NEW SWING GATE SIMILAR TO EXISTING DOORS S15 AND S45.
- 11. PROVIDE NEW DETENTION HOLLOW METAL LOCK POCKET.
- 12. EXISTING SWING GATE AND ENCLOSURE.
- 13. PROVIDE DOOR AND FRAME PREP FOR NEW LOCK.
- 14. CONTRACTOR TO VERIFY DOOR GAUGE AND THICKNESS. REWORK DOOR FOR NEW DETENTION LOCK.
- DELETE CLOSER AND FLOOR STOP (STEEL ANGLE). PROVIDE LCN 4210 CLOSER AND PORTLAND SECURITY HARDWARE PSH-760 DOOR STOP (OR EQUAL).
- 16. REPLACE MEDECO MORTISE KEY CYLINDER WITH BEST INTERCHANGEABLE CORE CYLINDER.
- 17. SEE DETAIL 6/A501 FOR LOCK MOUNTING IN NEW LOCK POCKET IN EXISTING FRAME.
- 18. EXISTING BEST CYLINDER/MORTISE LOCKSET.
- 19. REPLACE HYRID BEST/MOGUL CYLINDER WITH NEW MOGUL CYLINDER.
- 20. REPLACE EXISTING BEST CYLINDRICAL PASSAGE SET WITH NEW BEST CYLINDRICAL LOCK. PROVIDE STOREROOM FUNCTION.
- 21. PROVIDE NEW HYBRID MOGUL/BEST KEY CYLINDER WITH INTERCHANGEABLE CORE.
- 22. EXISTING HYBRID MOGUL/BEST KEY CYLINDER TO REMAIN. PROVIDE NEW INTERCHANGEABLE CORE.
- 23. ADTEC PARACENTRIC LOCK ON RHR DOOR TO REMAIN. PROVIDE BLANK COVER PLATE OVER PARACENTRIC KEY CYLINDER ON HINGE SIDE. REMOVE LEVER HANDLE AND PATCH HOLE ON HINGE SIDE.
- 24. REWORK LHR DOOR FOR NEW DETENTION MORTISE LOCK. MOUNT LOCK ABOVE EXISTING CREMONE LOCK PREP.
- 25. UPGRADE SCHLAGE CYLINDRICAL LOCK WITH NEW BEST CYLINDRICAL LOCK WITH INTERCHANGEABLE CORE.26. REKEY TO EXISTING MASTER AND GRAND MASTER CODES. PROVIDE INTERCHANGEABLE CORE.
- 27. REMOVE DOOR PANEL.

	_					SCHEDULE - 7T	H FLOOR		
Opening Number	Door info	ormation Height	Label	Hdwr Group	Lock Mounting	Existing Lock	Key Code	Key Type	Notes
SEVENTH	I FLOOR								
7E1	5' - 8"	7' - 4"	90	HG-1	-	-	-	0	9
7E16 7E19	3' - 0" 5' - 4"	7' - 0" 7' - 0"		DH-13	19 20/5	-	S49BC4 S49BC4/S49BC4	C P/M	6, 18 5, 23, 24
7E22	3' - 0"	7' - 0"			20	110-01	S49BC4	М	2
7E25A	3' - 0"	7' - 0"	45	DH-9	7	126M	E612	M	11
7E25B 7E35A	3' - 0" 2' - 10"	7' - 0" 7' - 0"	45		7 9	2121 122	E612 E612	M M	<u>3</u> 3
7E35B	2' - 10"	7' - 0"		DH-9	7	-	1607	M	11
7E36A	2' - 10"	7' - 0"			9	122	E612	М	3
7E36B 7E37	2' - 10" 2' - 10"	7' - 0" 7' - 0"		DH-9	7	2121	I 607	M M	<u>11</u> 3
7E71	3' - 0"	7' - 0"			21	110-01	1607	M	2
7E72	3' - 0"	7' - 0"			7	2121	I 607	М	3
7W1	2' - 8"	7' - 0"		DI 7			1.007		
701 702A	3' - 4" 3' - 0"	7' - 0" 7' - 0"		DH-7	9	110-02	I 607	P M	2
703	4' - 0"	7' - 0"		DH-7	9	-	1 607	Р	_
704	4' - 0"	7' - 0"		DH-7	9	-	I 607	Р	
705 706	4' - 0" 4' - 0"	6' - 4" 6' - 4"		DH-7 DH-7	9	-	I 607	P P	
707	4' - 0"	6' - 4"		DH-7	9	-	1607	P	
708	4' - 0"	6' - 4"		DH-7	9	-	I 607	Р	
709	4' - 0"	6' - 4"		DH-7	9	-	1607	P	
710 711	4' - 0" 4' - 0"	6' - 4" 6' - 4"		DH-7 DH-7	9	-	I 607	P P	
712	4' - 0"	6' - 4"		DH-7	9	-	1607	Р	
713	4' - 0"	6' - 4"		DH-7	9	-	1607	Р	
714 714E	4' - 0" 3' - 4"	6' - 4" 7' - 0"		DH-7	9	32	I 607	P P	1
714	4' - 0"	7'-0"		DH-7	9	-	I 607	P	I
716	4' - 0"	7' - 0"		DH-7	9	-	I 607	Р	
717	3' - 4" 3' - 0"	7' - 0"		DH-7	9	-	1607	Р	
719 719A	2' - 0"	7' - 0" 7' - 0"			21 19	110-01	I 607	M C	2 6, 18
719B	2' - 0"	7' - 0"			24	NS402E	I 607	C	16
719C	2' - 0"	7' - 0"			24	NS402E	I 607	С	16
719D 719E	2' - 0" 2' - 0"	7' - 0" 7' - 0"			24 24	NS402E NS402E	I 607	C	16 16
719F	2' - 0"	7' - 0"			24	NS402E	1607	C	16
719G	2' - 6"	7' - 0"			21	-	S49BC4	М	2
720A 720B	2' - 0" 2' - 0"	6' - 4" 6' - 4"		DH-1 DH-1				-	
720B 720C	2' - 0"	6' - 4"		DH-1				-	
720D	2' - 0"	6' - 4"		DH-1				-	
720E	2' - 0"	6' - 4"		DH-1				-	
720F 720G	2' - 0" 2' - 0"	6' - 4" 6' - 4"		DH-1 DH-1				-	
720H	2' - 0"	6' - 4"		DH-1				-	
7201	2' - 0"	6' - 4"		DH-2				-	
720J 721A	2' - 6" 2' - 0"	6' - 3" 6' - 4"		DH-1	9	122	I 607	М	2
721A 721B	2' - 0"	6' - 4"		DH-1				-	
721C	2' - 0"	6' - 4"		DH-1				-	
721D	2' - 0"	6' - 4"		DH-1				-	
721E 721F	2' - 0" 2' - 0"	6' - 4" 6' - 4"		DH-1 DH-1				-	
721G	2' - 0"	6' - 4"		DH-1				-	
721H	2' - 0"	6' - 4"		DH-1				-	
721I 721J	2' - 0" 2' - 6"	6' - 4" 6' - 3"		DH-2	9	122	I 607	- M	2
7213 722A	2' - 0"	6' - 4"		DH-1	3	144	1 007	-	۷
722B	2' - 0"	6' - 4"		DH-1				-	
722C	2' - 0" 2' - 0"	6' - 4" 6' - 4"		DH-1				-	
722D 722E	2' - 0"	6' - 4"		DH-1 DH-1				-	
722F	2' - 0"	6' - 4"		DH-1				-	
722G	2' - 0"	6' - 4"		DH-1				-	
722H 722I	2' - 0" 2' - 0"	6' - 4" 6' - 4"		DH-1 DH-2				-	
722J	2' - 0"	6' - 4"		ש'ווים	9	122	I 607	M	2
723A	2' - 0"	6' - 4"		DH-1				-	
723B 723C	2' - 0" 2' - 0"	6' - 4" 6' - 4"		DH-1				-	
723U 723J	2' - 0"	6' - 4" 6' - 4"		DH-1	9	122	I 607	- М	2
724A	2' - 0"	6' - 4"		DH-1				-	
724B	2' - 0"	6' - 4"		DH-1				-	
724C 724J	2' - 0" 2' - 0"	6' - 4" 6' - 4"		DH-1	9	122	I 607	- M	2
725A	2' - 0"	6' - 4"		DH-1		166	1 507	-	Ĺ
725B	2' - 0"	6' - 4"		DH-1				-	
725C	2' - 0"	6' - 4"		DH-1				-	
725D 725E	2' - 0" 2' - 0"	6' - 4" 6' - 4"		DH-1 DH-1				-	
725F	2' - 0"	6' - 4"		DH-1				-	
725G	2' - 0"	6' - 4"	_	DH-1				-	
725H 725I	2' - 0" 2' - 0"	6' - 4" 6' - 4"		DH-1 DH-2				-	
725J	2' - 0"	6' - 4"		טוז-ע	9	122	I 607	- М	2
726A	2' - 0"	6' - 4"		DH-1				-	
726B	2' - 0"	6' - 4"		DH-1				-	
726C	2' - 0"	6' - 4"		DH-1	1	I	I	1	

Number	Width	Height	Label	Hdwr Group	Lock Mounting	Existing Lock	Key Code	Key Type	Notes
727A	2' - 0"	6' - 4"		DH-1				-	
727B	2' - 0"	6' - 4"		DH-1				-	
727C	2' - 0"	6' - 4"		DH-1				-	
727D	2' - 0"	6' - 4"		DH-1				-	
727I 727J	2' - 0" 2' - 0"	6' - 4" 6' - 4"		DH-2	9	122	I 607	- M	2
7273 728A	2' - 0"	6' - 4"		DH-1	9	122	1607	-	2
728B	2' - 0"	6' - 4"		DH-1				-	
728C	2' - 0"	6' - 4"		DH-1				-	
728D	2' - 0"	6' - 4"		DH-1				-	
728E	2' - 0"	6' - 4"		DH-1				-	
728F	2' - 0"	6' - 4"		DH-1				-	
728G	2' - 0"	6' - 4"		DH-1				-	
728H	2' - 0"	6' - 4"		DH-1				-	
728I 728J	2' - 0" 2' - 6"	6' - 4" 6' - 3"		DH-2	9	122	I 607	- M	2
7002	3' - 6"	7' - 0"			7	56	E612	P	1
7010	2' - 6"	7' - 0"			7	126	S49BC4	M	2
7012A	3' - 0"	7' - 0"			21	110-01	S49BC4	M	2
7012B	3' - 0"	7' - 0"			21	110-01	S49BC4	М	2
7013A	3' - 0"	7' - 0"			7	126	S49BC4	М	2
7013B	3' - 0"	7' - 0"			7	126	S49BC4	M	2
7014	3' - 0"	7' - 0"			7	126	S49BC4	M	2
7015A	2' - 8"	7' - 0"			7	126	S49BC4	M	2
7015B	2' - 8"	7' - 0"			7	126	S49BC4	M	2
7016 7019	2' - 8" 3' - 6"	7' - 0" 7' - 0"			7 7	126 56	S49BC4 E612	M P	2
7019	3' - 6"	7' - 0"		DH-15	20	00	E612	C	20
7020	2' - 0"	7 - 0"		DH-15	20	-	S10	C	13, 21
7021	2' - 6"	7' - 0"			20	-	I 607	C	6, 18
7023	2' - 0"	7' - 0"			6	82	S49BC4	P	1
7025	2' - 0"	7' - 0"			6	82	S49BC4	Р	1
7026	2' - 0"	7' - 0"		DH-14	20	-	S10	С	13, 21
7028	3' - 4"	7' - 0"			18	32	I 607	P	1
7029	2' - 0"	7' - 0"		DH-14	20	110-01	S10	C	21
7030	3' - 0" 2' - 6"	7' - 0" 7' - 0"			20	- 00	S10 S49BC4	C P	25
7031 7032	2' - 6" 2' - 6"	7' - 0"		DH-14	20	82	S49BC4 S49BC4	M	1 13
7032	2' - 6"	7' - 0"		14-ווט	20	-	1 607	C	6, 18
7034	2' - 6"	7' - 0"			20		1 007		0, 10
7035	2' - 6"	7' - 0"							
7036	2' - 6"	7' - 0"		DH-14	21	-	S10	С	13
7037	2' - 6"	7' - 0"			3	82	S49BC4	Р	1
7038	2' - 6"	7' - 0"		DH-14	21	-	I 607	M	13
7039	2' - 6"	7' - 0"		DH-14	21	-	S49BC4	M	13
7040	2' - 4"	7' - 0"			20	-	S10	C	6, 18
7041 7043	2' - 4"	7' - 0" 7' - 0"			3	82 82	S49BC4 S49BC4	P P	1 1
7043	2' - 6"	7 - 0"			20	- 82	MS	C	6, 18, 26
7044	3' - 0"	7 - 0"			21	-	MS	C	6, 18, 26
7047	3' - 0"	7' - 0"			19	110-02	E612	M	4
7049	3' - 0"	7' - 0"			21	-	I 607	С	6, 18
7053A	3' - 0"	7' - 0"			1	66	I 607	Р	1
7055	2' - 6"	7' - 0"			21	110-01	S49BC4	M	2
7056	2' - 6"	7' - 0"			21	110-01	I 607	M	2
7057	2' - 6"	7' - 0"			21	110-01	1 607	M	2
7058 7063	2' - 6" 3' - 0"	7' - 0" 7' - 0"			21	110-01 66	I 607 S49BC4	M	2
7063 7064A	3' - 0"	7 - 0"		DH-9	7	00	E612	M	11
7064B	3' - 0"	7 - 0"		DH-9	7		E633	M	11
7004B 7074A	3' - 0"	7' - 0"		פיוום	1	66	E612	P	1
7074B	3' - 0"	7' - 0"			1	66	E612	P	1
7075	2' - 6"	7' - 0"			19	110-02	S49BC4	М	2
7079	3' - 0"	7' - 0"			15	36	S49BC4	Р	1
7080	2' - 0"	7' - 0"			4	12	S49BC4	Р	1
7081	2' - 6"	7' - 0"			4	62	S49BC4	P	1
7083	2' - 6"	7' - 0"			2	66	S49BC4	P	1
7084	2' - 6" 2' - 6"	7' - 0" 7' - 0"			2	66 66	S49BC4 S49BC4	P	1 1
7085 7086	2' - 6"	7' - 0"			2 2	66	S49BC4 S49BC4	P	1
7086	2' - 6"	7 - 0"			2	66	S49BC4 S49BC4	P	<u></u>
7087	2' - 6"	7' - 0"			2	66	S49BC4	P	<u>'</u> 1
7089	2' - 6"	7' - 0"			2		S49BC4	P	1
7096A	3' - 4"	6' - 8"	90		1	66	E612	Р	1
7096B	2' - 4"	6' - 4"			7	56	S49BC4	М	2
7098	2' - 6"	7' - 0"			21	110-01	S49BC4	М	2
7099	2' - 6"	7' - 0"			2	86	S49BC4	P	1
7100	2' - 0"	7' - 0"			4	12	S49BC4	P	1
7107 7108A	2' - 0" 2' - 6"	7' - 0" 7' - 0"			2	12 66	S49BC4 S49BC4	P P	<u>1</u> 1
7108A 7109	2' - 6"	7' - 0"			21	110-01	S49BC4 S49BC4	M	2
7109	3' - 0"	7 - 0"			21	110-01	S49BC4 S49BC4	M	2
7112A	2' - 4"	6' - 4"			7	56	S49BC4 S49BC4	P	1
7112R	3' - 4"	6' - 8"	90		1	66	E612	P	1
7114	2' - 6"	7' - 0"			4	62	I 607	P	1
7115	2' - 0"	7' - 0"			4	12	S49BC4	P	1
7116	2' - 6"	7' - 0"			4	62	S49BC4	Р	1
7117	2' - 0"	7' - 0"			4	12	S49BC4	Р	1
7118	2' - 0"	7' - 0"			4	12	S49BC4	P	1
	2' - 0"	7' - 0"			4	12	S49BC4	P	11
7119	~ .	7' - 0"	I	I	4	12	S49BC4	P	1
7119 7120	2' - 0"						0.40500.4		
7119 7120 7121	2' - 0"	7' - 0"			4	12	S49BC4	Р	1 No west
7119 7120							S49BC4 E612	P	1 No work. 2

SEVENTH FLOOR: 190 Doors Total

DE DOOR SCHEDULE - 7TH FLOOR

Mead & Hunt, Inc.

2440 Deming Way Middleton, WI 53562

phone: 608-273-6380

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DANE COUNTY DEPT. OF PUBLIC WORKS, HIGHWAY & TRANSPORTATION 1919 ALLIANT ENERGY CENTER WAY MADISON, WI 53713

PROJECT NO. 317006

DANE COUNTY SHERIFF'S OFFICE CCB JAIL MITIGATION UPGRADES

CCB JAIL

CCB JAIL

STO MARTIN LU

MADISON, WIS

BID DOCUMENTS

M&H NO.: 4215400-161950.01

DATE: April 4, 2017

DESIGNED BY: JDH

DRAWN BY: MKH

CHECKED BY: JDH

SHEET CONTENTS
DOOR SCHEDULE

SHEET NO.:

4602

SERVICE & DISTRIBUTION SYMBOLS

EXISTING PANELBOARD

FIRE ALARM SYMBOLS

FACP FAAP

FIRE ALARM CONTROL PANEL FIRE ALARM ANNUNCIATOR PANEL

INTELLIGENT PHOTOELECTRIC SMOKE DETECTOR

MOTOR & EQUIPMENT CONNECTION SYMBOLS

3 PHASE MOTOR CONNECTION

1 PHASE MOTOR CONNECTION **EQUIPMENT CONNECTION**

COMBINATION MAGNETIC MOTOR CONTROLLER

L M MANUAL MOTOR CONTROLLER (3 PHASE) **L** SS

SOLID STATE MOTOR CONTROLLER REDUCED VOLTAGE SOLID STATE CONTROLLER

VARIABLE FREQUENCY MOTOR CONTROLLER

MAGNETIC MOTOR CONTROLLER NON-FUSED DISCONNECT SWITCH

FUSED DISCONNECT SWITCH DOUBLE THROW SWITCH

> FUSED SINGLE POLE SWITCH MOTOR RATED SWITCH WITH OVERLOADS

MOTOR RATED SWITCH WITHOUT OVERLOADS

REDUCED VOLTAGE MAGNETIC CONTROLLER COMBINATION REDUCED VOLTAGE MAGNETIC CONTROLLER **AUTOMATIC TRANSFER SWITCH**

MANUAL TRANSFER SWITCH ENCLOSED CIRCUIT BREAKER

GENERAL SYMBOLS

#/E-### DETAIL NUMBER / SHEET NUMBER

KEYED NOTE, USED TO DESCRIBE ADDITIONAL INFORMATION OF WORK REQUIRED, SPECIFIC TO THE SHEET AND/OR DETAIL IT IS SHOWN WITH.

KITCHEN EQUIPMENT TAG. # REFERS TO CORRESPONDING NUMBER IN KITCHEN EQUIPMENT SCHEDULE.

LINE TYPE KEY

NEW WORK BY THIS CONTRACTOR (DARK SOLID LINE) ____ EXISTING TO BE REMOVED BY THIS CONTRACTOR (DARK DASHED LINE) EXISTING TO REMAIN WORK

(THIN SOLID LINE) NEW WORK UNDER FLOOR BY THIS CONTRACTOR

ONE-LINE EQUIPMENT ENCLOSURE PANEL DIVISION LINES

—— CON —— SITE UNDERGROUND CONDUIT ——//CON//—— SITE REMOVED UNDERGROUND E SITE UNDERGROUND ELECTRIC

ELECTRIC

—— OHE —— SITE OVERHEAD ELECTRIC —— //OHE//—— SITE REMOVED OVERHEAD **ELECTRIC**

ELECTRICAL ABBREVIATIONS

3R NEMA 3R RATING **NEMA 4X RATING**

AMPERES A/E ARCHITECT / ENGINEER ABOVE ACCESSIBLE CEILING

ACCU AIR COOLED CONDENSING UNIT ABOVE FINISHED FLOOR

AFG ABOVE FINISHED GRADE AHU AIR HANDLING UNIT ALT ALTERNATE

APE AIRCRAFT PROCESS EQUIPMENT ATS AUTOMATIC TRANSFER SWITCH

BLDG BUILDING BRKR BREAKER

CONDUIT CB CIRCUIT BREAKER CF CIRCULATION FAN

CHILLER CH CHWP CHILLED WATER PUMP CKT CIRCUIT

CP CIRCULATION PUMP CRAC COMPUTER ROOM AIR CONDITIONER CRP CONDENSATION RETURN

COOLING TOWER CUH CABINET UNIT HEATER DC DROP CORD

CT

DDC DIGITAL CONTROL PANEL **DUCT HEATER** DH DISC DISCONNECT

DOOR OPERATOR DWG DRAWING

E/O ELECTRICAL-TO-OPTICAL CONVERTER ELECTRICAL CONTRACTOR ECB ENCLOSED CIRCUIT BREAKER

EXHAUST FAN **EMERGENCY**

EMT ELECTRICAL METALLIC TUBING EQUIPMENT SUPPLIER ETR EXISTING TO REMAIN

EWC ELECTRICAL WATER COOLER EWH ELECTRICAL WATER HEATER FUSED FA FIRE ALARM

FAF FORCED AIR FURNACE FCU FAN COIL UNIT GENERAL CONTRACTOR GARBAGE DISPOSAL

GFI GROUND FAULT INTERRUPTER GND GROUND GWH GAS WATER HEATER

HD HAND DRYER HORSEPOWER HVAC HEATING, VENTILATION, AIR CONDITIONING HWB HOT WATER BOILER

HWP HOT WATER PUMP IEWH INSTANTANEOUS ELECTRIC WATER HEATER

INFRARED HEATER IMC INTERMEDIATE METALLIC CONDUIT

IWH INSTANTANEOUS WATER HEATER

J-BOX JUNCTION BOX LBS POUNDS

LFS LIGHTING FIXTURE SCHEDULE MAU MAKE-UP AIR UNIT

MAX MAXIMUM MC MECHANICAL CONTRACTOR

MCC MOTOR CONTROL CENTER MDF MAIN DISTRIBUTION FRAME

MDP MAIN DISTRIBUTION PANEL

MIN. MINIMUM MNS MASS NOTIFICATION SYSTEM

MTD MOUNTED MTG MOUNTING MTS MANUAL TRANSFER SWITCH

NIC NOT IN CONTRACT NIGHT LIGHT

NL/EL NIGHT LIGHT AND EMERGENCY LIGHT NTS NOT TO SCALE

OC ON CENTER OFCI OWNER FURNISHED, CONTRACTOR INSTALLED

OFOI OWNER FURNISHED, OWNER INSTALLED PH PHASE

PNL PANEL

PVC POLYVINYL CHLORIDE RCP RADIANT CEILING PANEL

RECPT RECEPTACLE REF REFRIGERATOR

REQ'D REQUIRED RF RETURN FAN RGS RIGID GALVANIZED STEEL CONDUIT

MAY ALSO BE REFERENCED AS RMC OR GRC

RMC RIGID METAL CONDUIT RTU ROOF TOP UNIT S/N SOLID NEUTRAL

SERVICE ENTRANCE SEC-P SECURITY PANEL SUPPLY FAN

SUMP PUMP STAINLESS STEEL

SW SWITCH SWBK SWITCH BANK TBR TO BE REMOVED

TCP TEMPERATURE CONTROL PANEL TFA TO FLOOR ABOVE TFB TO FLOOR BELOW

TYP TYPICAL UC UNIT COOLER UG UNDERGROUND

UH UNIT HEATER UNO UNLESS NOTED OTHERWISE UNIT VENTILATER UV

VOLTS VER VEHICLE EXHAUST REEL VFD VARIABLE FREQUENCY DRIVE

VS VERSUS W WATTS

WCC WATER COOLED CONDENSER WFE WELDING FUME EXTRACTOR WH WATER HEATER

WL WET LOCATION LISTED WP WEATHERPROOF XFMR TRANSFORMER XP EXPLOSION PROOF

DEMOLITION GENERAL NOTES:

1. THE INFORMATION SHOWN IS BASED ON EXISTING DRAWINGS AND SITE OBSERVATIONS TO ASSIST CONTRACTOR IN BIDDING. THE ELECTRICAL DRAWINGS INDICATE EXISTING ELECTRICAL ITEMS TO BE REMOVED. THE DRAWINGS ARE INTENDED TO INDICATE THE SCOPE OF WORK REQUIRED AND DO NOT INDICATE EVERY BOX. CONDUIT, OR WIRE THAT MUST BE REMOVED. THE CONTRACTOR SHALL VISIT THE SITE PRIOR TO SUBMITTING A BID AND VERIFY EXISTING CONDITIONS. REFER TO SPECIFICATION SECTION 26 05 02 FOR

ADDITIONAL REQUIREMENTS.

2. ELECTRICAL ITEMS (i.e., DISCONNECTS, MOTOR CONTROLLERS, ETC.) REMOVED AND NOT RELOCATED REMAIN THE PROPERTY OF THE OWNER AND SHALL BE TURNED OVER TO THE OWNER, IN A STORAGE AREA TO BE DESIGNATED BY THE OWNER. EQUIPMENT BEING REMOVED SHALL BE HANDLED SO AS NOT TO FURTHER REDUCE ITS VALUE TO THE OWNER. THE CONTRACTOR SHALL DISPOSE OF MATERIAL THE OWNER DOES NOT WANT TO REUSE OR RETAIN FOR MAINTENANCE PURPOSES.

3. ALL BOXES THAT REMAIN IN PLACE IN EXISTING MASONRY WALLS SHALL BE PROVIDED WITH A BLANK COVERPLATE. REFER TO SPECIFICATIONS FOR ADDITIONAL REQUIREMENTS.

4. THIS CONTRACTOR SHALL COORDINATE ALL HIS WORK, INCLUDING PHASING WITH OTHER CONTRACTORS AT THE JOB SITE BEFORE REMOVING EXISTING ELECTRICAL AND INSTALLING NEW ITEMS.

5. EXISTING CONDUIT IN GOOD CONDITION, MAY BE REUSED IN PLACE. RELOCATED CONDUIT SHALL NOT BE ALLOWED. BONDING CONDUCTORS SHALL BE INSTALLED IN ALL REUSED CONDUIT TO ASSURE PROPER GROUND

6. MAINTAIN CIRCUIT CONTINUITY OF EQUIPMENT LOCATED OUTSIDE OF CONSTRUCTION AREA. DEVICE AND EQUIPMENT REMOVAL IN CERTAIN LOCATIONS MAY REQUIRE THE INSTALLATION OF A JUNCTION BOX TO RECONNECT CIRCUITS THAT REMAIN IN OPERATION. EXTEND CONDUIT AND WIRING AS REQUIRED TO MAINTAIN POWER TO REMAINING EQUIPMENT.

7. CONTRACTOR SHALL REMOVE AND INSTALL ALL CEILING TILES AS REQUIRED FOR THE EXECUTION OF ELECTRICAL WORK THAT IS OUTSIDE THE CONTRACT LIMITS OF CONSTRUCTION. CONTRACTOR SHALL REPLACE CEILING TILES WITH IDENTICAL MATERIAL WHERE DAMAGED BY THIS CONTRACTOR.

8. PROVIDE REVISED TYPED CIRCUIT DIRECTORY IN PANELBOARDS THAT HAVE CIRCUITS REMOVED OR ADDED CIRCUITS.


CONDUIT ABOVE ACCESSIBLE CEILING FINISHES. CUT RACEWAY FLUSH WITH WALLS AND FLOORS, PATCH SURFACES TO MATCH EXISTING. REMOVE ALL ASSOCIATED CLAMPS, HANGERS, SUPPORTS, ETC. ASSOCIATED WITH RACEWAY REMOVAL.

9. REMOVE ABANDONED CONDUIT, INCLUDING ABANDONED

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PUBLIC WORKS, HIGHWAY & TRANSPORTATION 1919 ALLIANT ENERGY CENTER WAY MADISON, WI 53713 PROJECT NO. 317006

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04/04/17 BID DOCUMENTS

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M&H NO.: 4215400-161950.01 DATE: April 4, 2017 DESIGNED BY: SDL DRAWN BY: KAF CHECKED BY: SDL

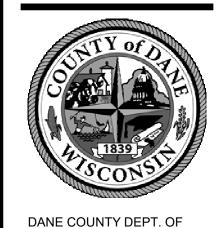SHEET CONTENTS SYMBOLS, ABBREVIATIONS AND NOTES

E001

KEYED NOTES

- 9.103 PROVIDE 208V, 20A, 3PH BRANCH CIRCUIT FROM PANEL B TO SF-3. FAN INCLUDES CONTROLLER WITH LV AUX INPUTS TO FACILITATE CONTROL OF FANS BY FA AND REMOTE FAN CONTROL STATION. PROVIDE FA CONTROL MODULE FOR FAN CONTROL.
- 9.104 PROVIDE 208V, 20A, 3PH BRANCH CIRCUIT FROM PANEL A TO SF-4. FAN INCLUDES CONTROLLER WITH LV AUX INPUTS TO FACILITATE CONTROL OF FANS BY FA AND REMOTE FAN CONTROL STATION. PROVIDE FA CONTROL MODULE FOR FAN CONTROL.
- 9.105 PROVIDE FAN CONTROL STATION WITHIN SECURED KNOX BOX FOR REMOTE ACTIVATION OF STAIRWELL PRESSURIZATION FANS ADJACENT TO EXISTING FAAP.
- 9.106 EXISTING FACP.

ELECTRICAL PLAN

GARAGE LEVEL - OVERALL

1/16" = 1'-0"

GENERAL PLAN NOTES:

1. CONDUIT ROUTING FROM FANS TO ELECTRICAL AND FIRE ALARM PANELS SHALL MINIMIZE WORK IN PRIVATE OFFICES AND AREAS OCCUPIED 24/7 SUCH AS THE 911 CENTER. IN ADDITION, PORTIONS OF THE BUILDING HAVE ASBESTOS-CONTAINING METAL CEILING TILE WHICH, IF DISTURBED MUST BE HANDLED IN ACCORDANCE WITH THE GENERAL CONDITIONS SPECIFICATIONS. THESE AREAS ARE TO BE AVOIDED IF AT ALL POSSIBLE. PROVIDE OWNER WITH INTENDED ROUTING PLAN A MINIMUM OF SEVEN DAYS PRIOR TO COMMENCEMENT OF WORK AND ADJUST ROUTING OR SCHEDULE AS DIRECTED BY OWNER TO MINIMIZE DISRUPTION. AFTER-HOURS WORK MAY BE



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DANE COUNTY DEPT. OF PUBLIC WORKS, HIGHWAY & TRANSPORTATION 1919 ALLIANT ENERGY **CENTER WAY** MADISON, WI 53713 PROJECT NO. 317006

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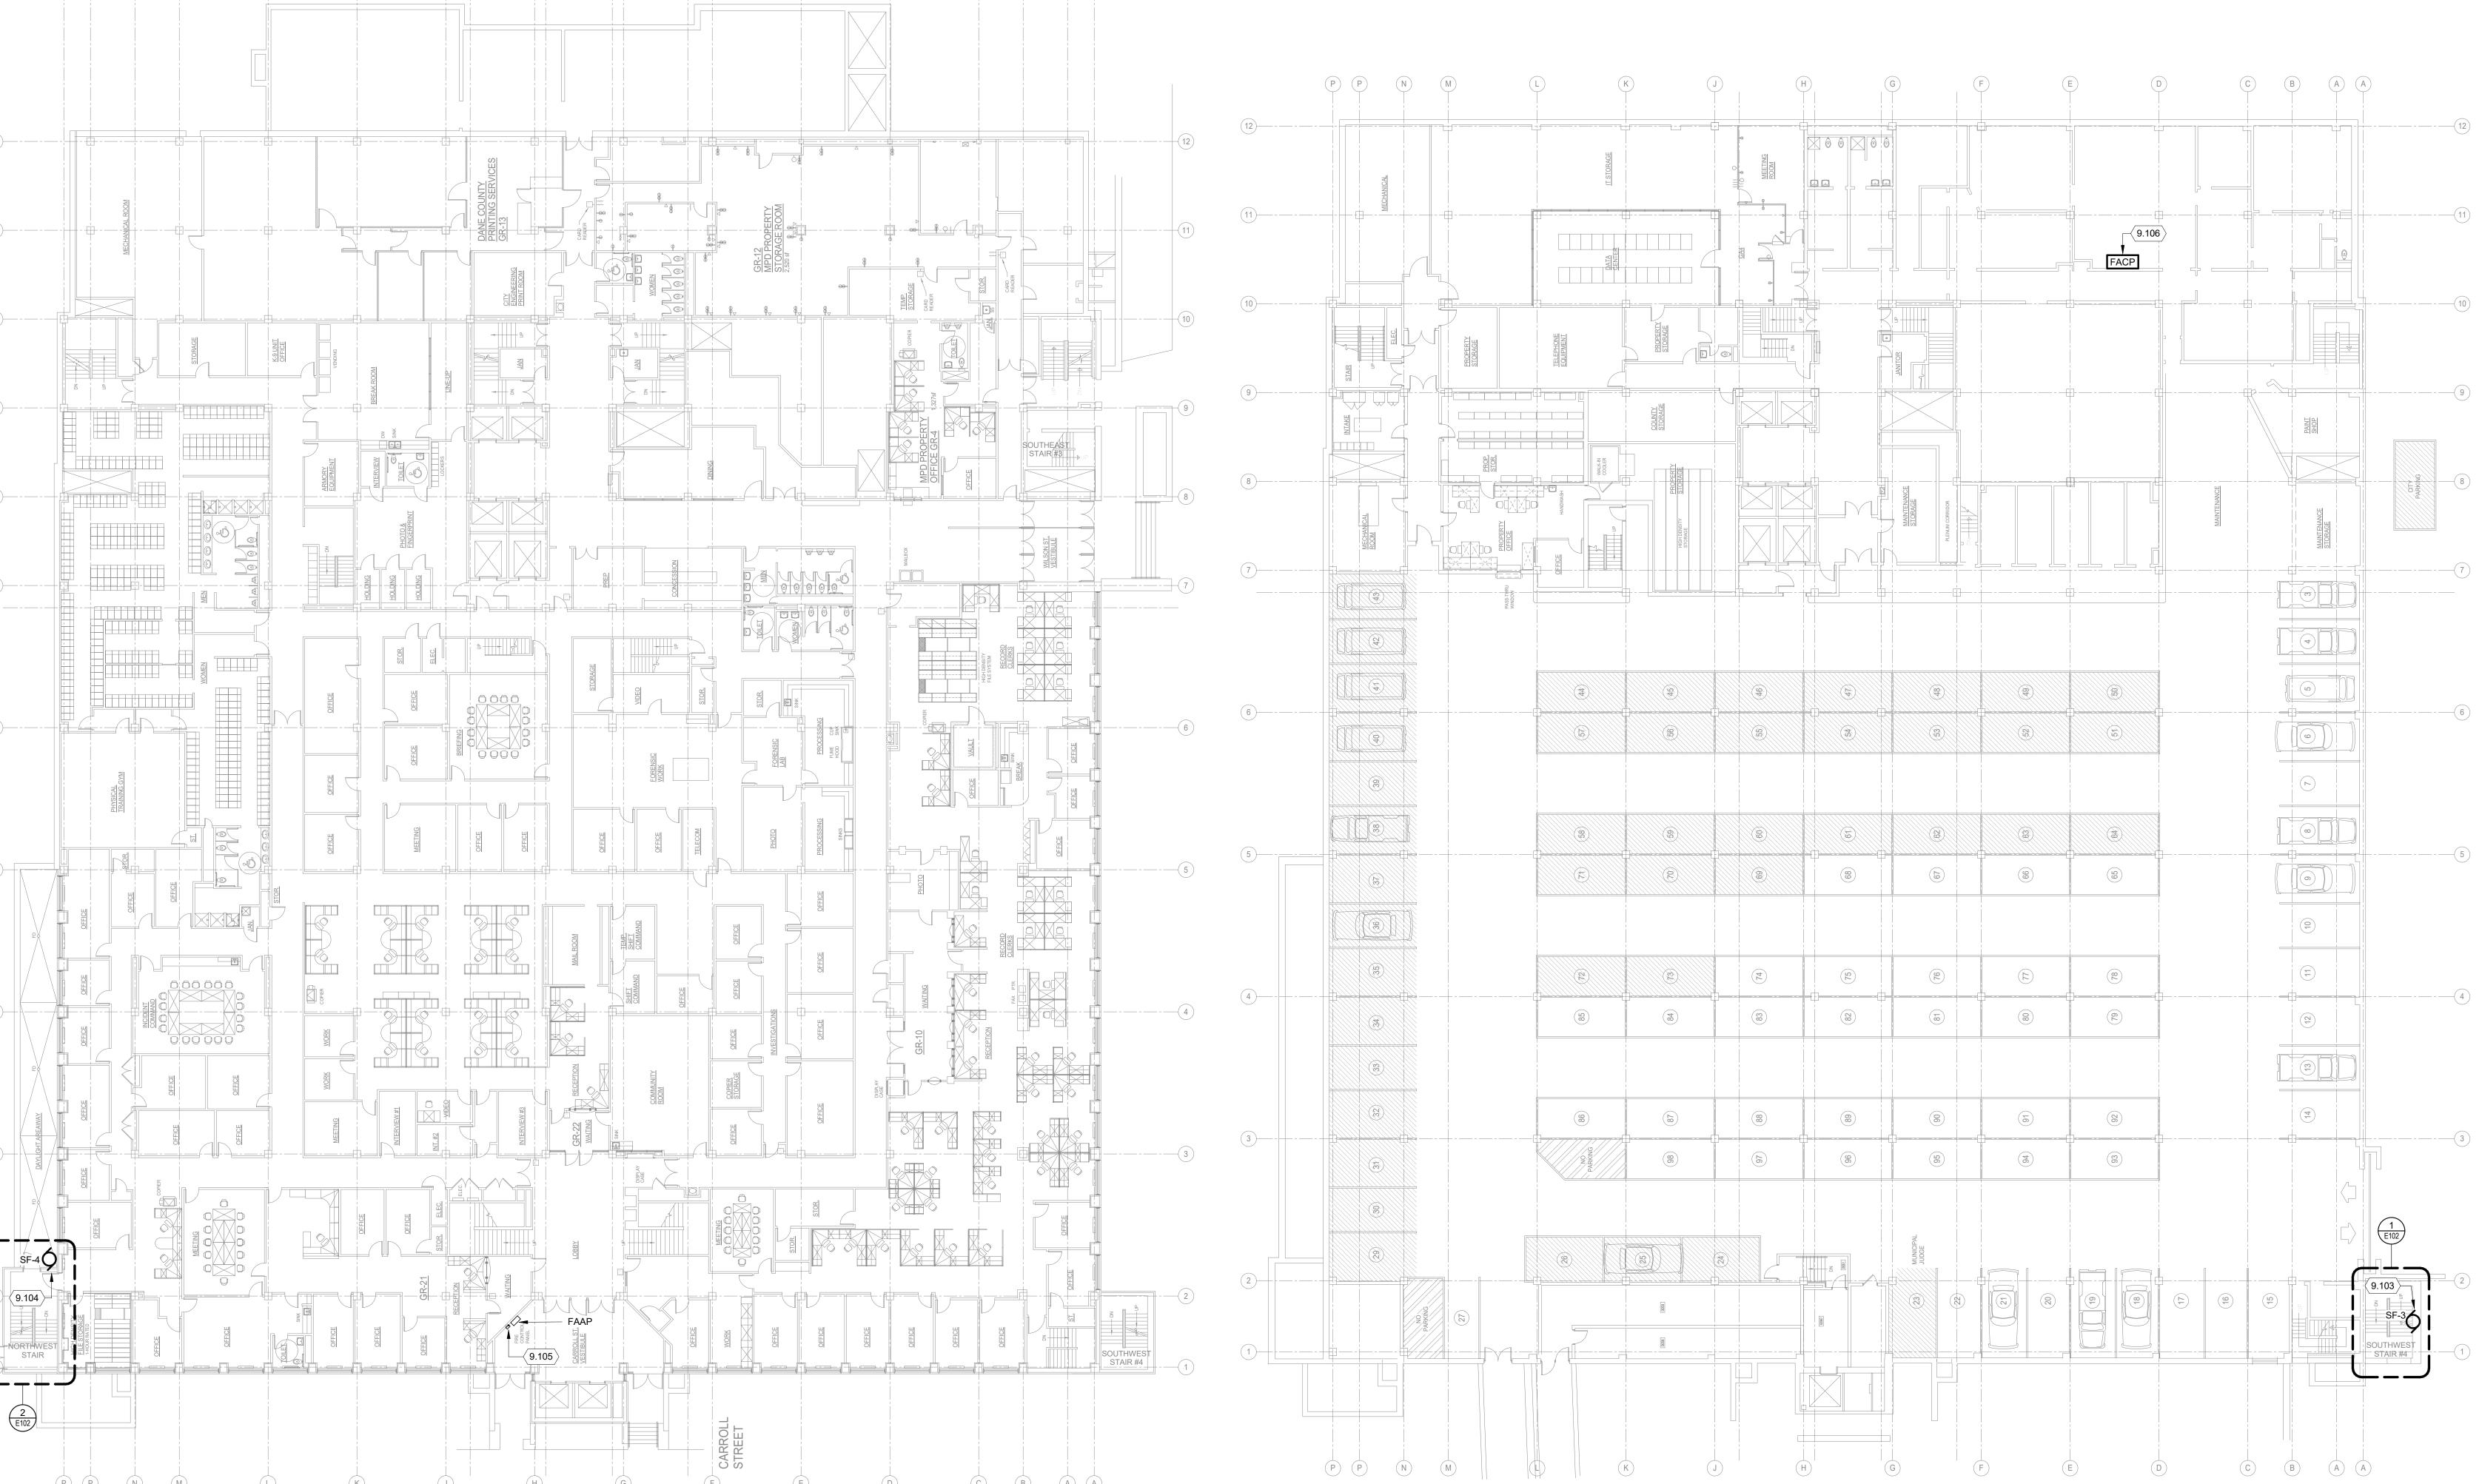
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__DO NOT SCALE DRAWINGS

BID DOCUMENTS

SHEET CONTENTS ELECTRICAL **OVERALL PLANS**

E100



ELECTRICAL PLAN

GROUND FLOOR - OVERALL

1/16" = 1'-0"

FIRST FLOOR - OVERALL

1/16" = 1'-0"


KEYED NOTES

9.101 PROVIDE 120V, 20A, 3PH BRANCH CIRCUIT FROM PANEL EM2-3A TO SF-1. FAN INCLUDES CONTROLLER WITH LV AUX INPUTS TO FACILITATE CONTROL OF FANS BY FA AND REMOTE FAN CONTROL STATION. PROVIDE FA CONTROL MODULE FOR FAN CONTROL.

9.107 REFER TO 6/E-102 FOR APPROXIMATE LOCATION OF SF-2 ON SECOND FLOOR.

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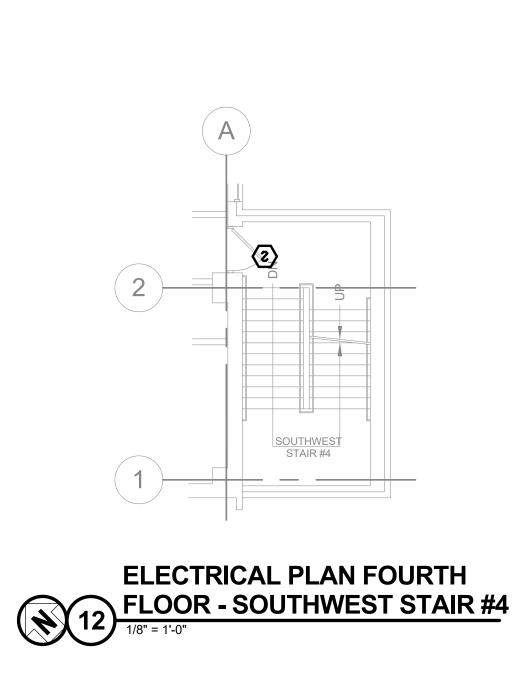
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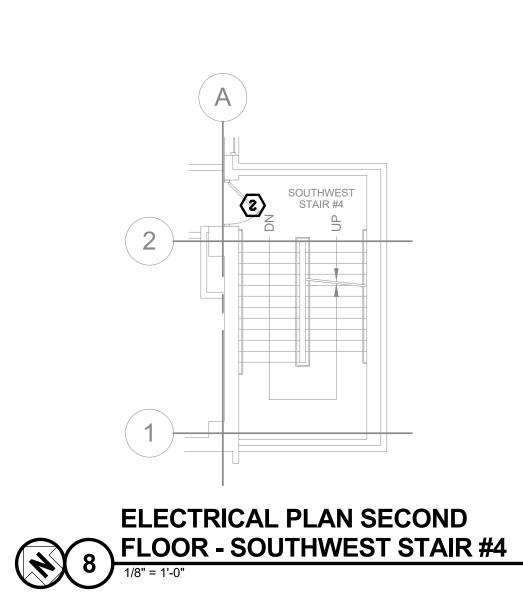
SHEET CONTENTS ELECTRICAL OVERALL PLANS


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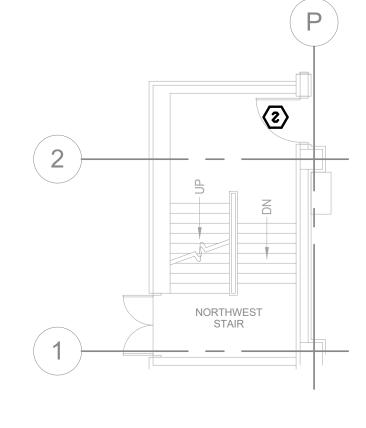


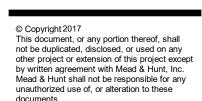NORTHWEST

ELECTRICAL PLAN FIFTH





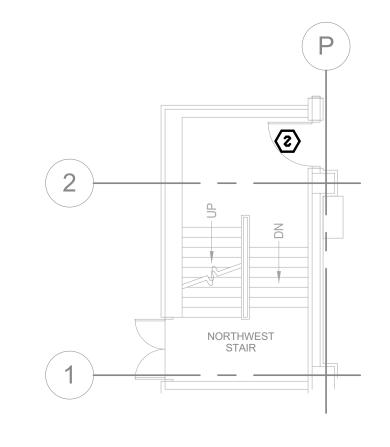


ELECTRICAL PLAN FIRST


ELECTRICAL PLAN FIRST

FLOOR - SOUTHWEST STAIR #4

FLOOR - NORTHWEST STAIR


1/8" = 1'-0"

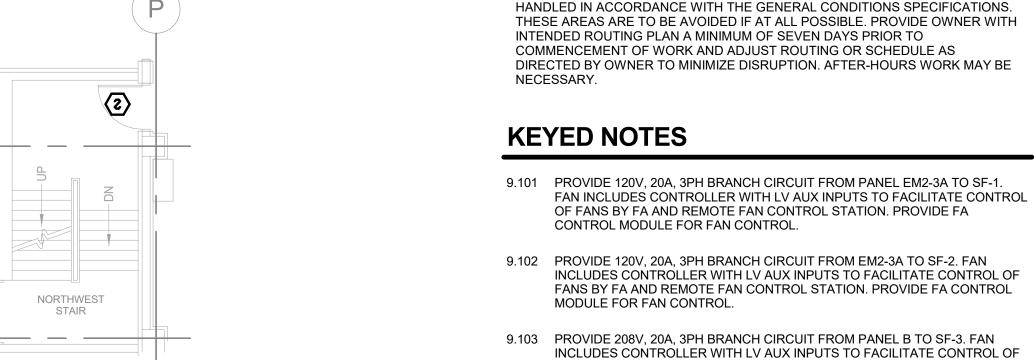

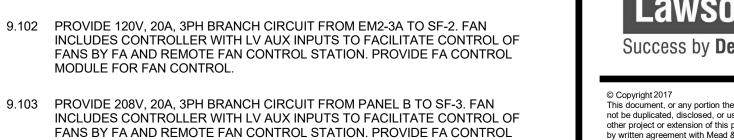




9.104 PROVIDE 208V, 20A, 3PH BRANCH CIRCUIT FROM PANEL A TO SF-4. FAN INCLUDES CONTROLLER WITH LV AUX INPUTS TO FACILITATE CONTROL OF FANS BY FA AND REMOTE FAN CONTROL STATION. PROVIDE FA CONTROL MODULE FOR FAN CONTROL.

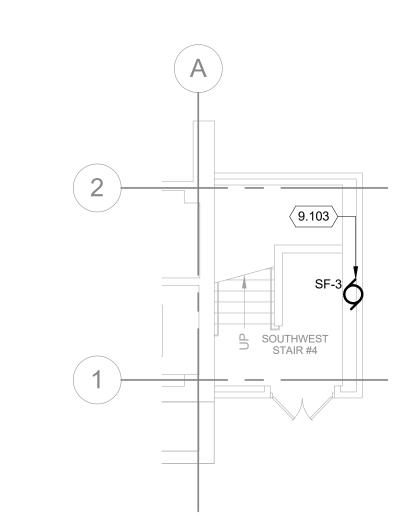





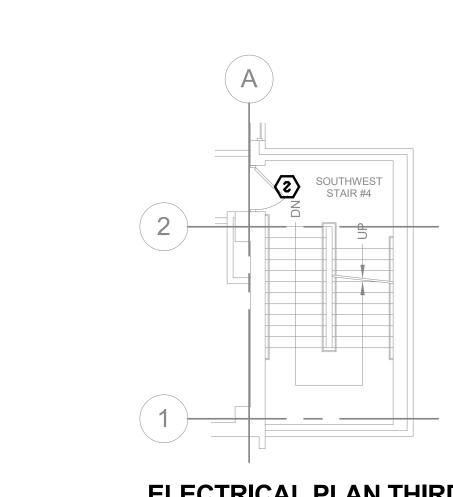



ELECTRICAL PLAN THIRD


9 FLOOR - NORTHWEST STAIR

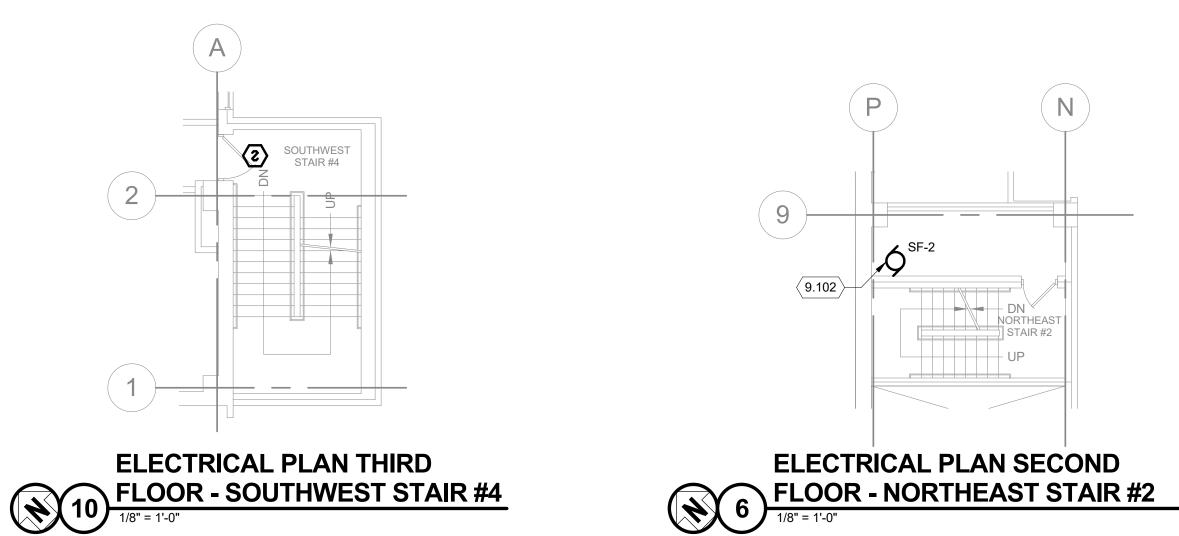


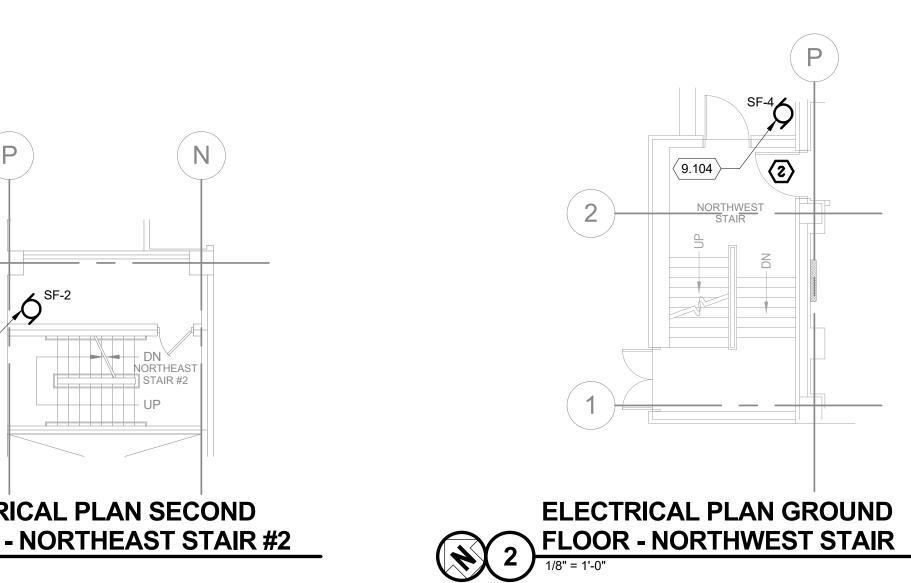

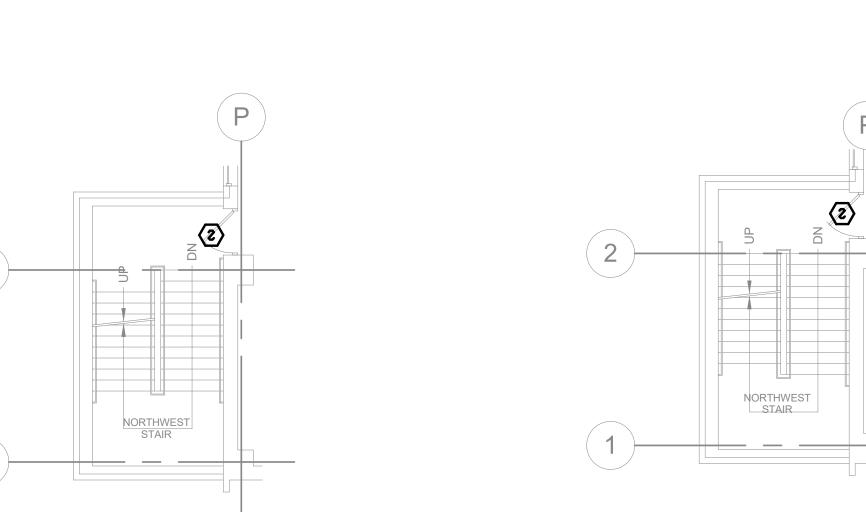

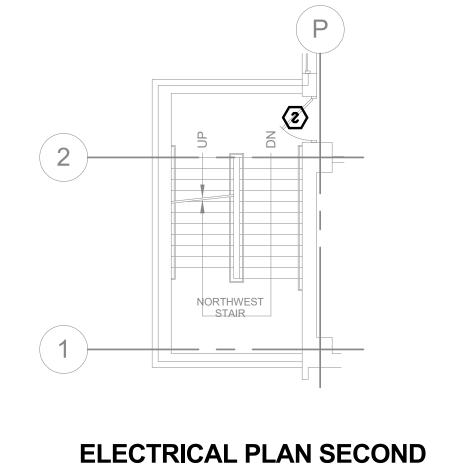

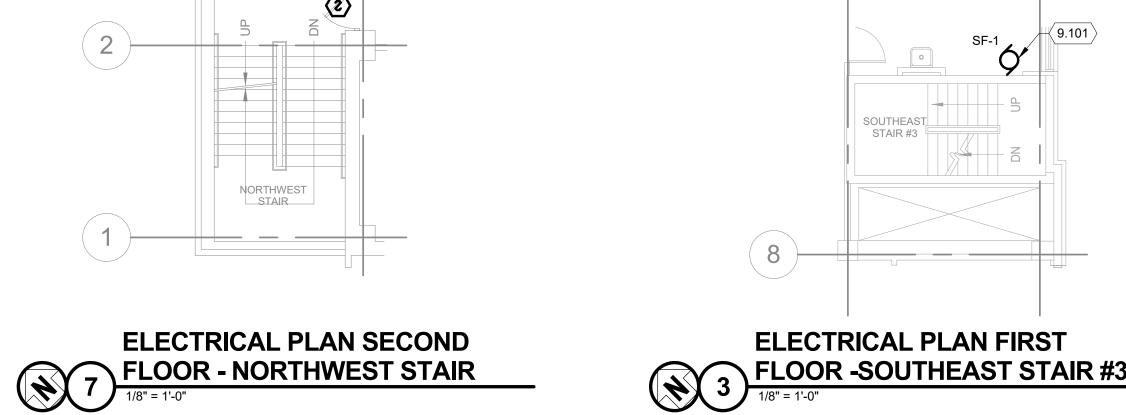

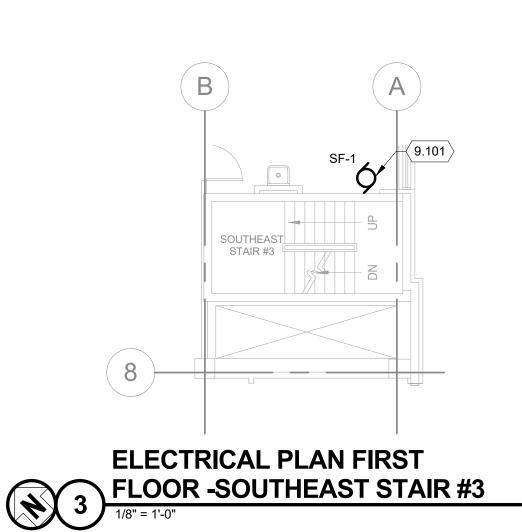



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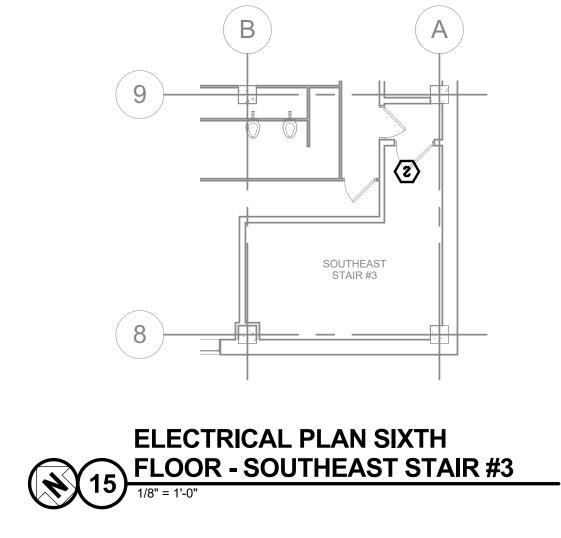
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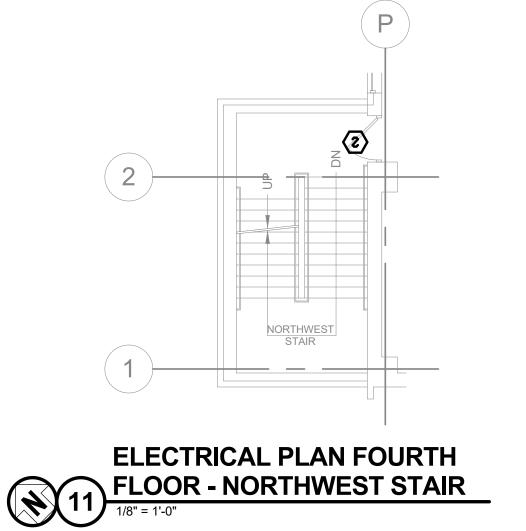
SHEET CONTENTS **ELECTRICAL PLANS**

SHEET NO.:

E102



ELECTRICAL PLAN FIFTH



SIDEWALL PROPELLER FAN W/DAMPER AND LOUVER/GRILLE

	AIR OUTLET AND INLET SCHEDULE														
MARK	MANUFACTURER, MODEL I	NUMBER		OUTLET/ INLET	TYPE	MOUNTING SYSTEM		SIZE (IN)	NECK (IN)	FINISH	MATERIAL	(1) MOUNTING HEIGHT (IN)		LOCATION	REMARKS
SG-1	KEES, SEG-5M		SECURITY	3	3	3	N	(2)	(2)	W	STEEL	SEE PLANS	-	SEE PLANS	(3)
SG-2	KEES, SEG-5M		SECURITY	3	3	3	N	(4)	(4)	W	STEEL	SEE PLANS	-	SEE PLANS	(3)
	OUTLET/INLET			TYPE					MOUNT	ING SYST	EM		DAMPER		FINISH
1	DIFFUSER	1	SINGLE DEFLE	CTION	9	LOUVERED		1	T-BAR CE	EILING		N	NONE	М	MILL
2	REGISTER	2	DOUBLE DEFLE	CTION	10	HOODED		2	PLASTER	R/CONCRE	TE CEILING	BF	BUTTERFLY	W	MFR. STANDARD WHITE
3	GRILLE	3	FIXED BLADE		11	DOOR TRAI	NSFER	3	PLASTER	R/MASONF	RY WALL	G	GRAVITY	S	MFR. SPECIAL COLOR
4	LOUVER	4	PERFORATED		12	BRICK		4	EXPOSE	D DUCTW	ORK	MP	MOTORIZED PNEUMATIC	0	OTHER (SEE
5	PENTHOUSE	5	LINEAR		13	PUNKAH		5	METAL P	ANEL WAI	_L	ME	MOTORIZED ELECTRIC		
6	VENT	6	SLOT		14	LAMINAR		6 ROOF		ОВ	OPPOSED BLADE				
		7	DRUM					7 EXTERIOR STUD WALL		PB	PARALLEL BLADE				
		8	EGGCRATE									LL	LOW LEAKAGE, INSUL.		

- (1) MOUNTING HEIGHT SHALL BE FROM FINISHED FLOOR TO TOP OF OPENING.
- (2) SIZE GRILLE TO MATCH NOMINAL ASSOCIATED FAN DISCHARGE OPENING (APPROXIMATELY 24" SQUARE).
- (3) ONE INCH FLANGE, ZERO DEGREE DEFLECTION. 10 GA FACE AND SLEEVE WITH 1-1/2" x 1/8" STEEL BARS ON 1/2" CENTERS. ANCHOR SLEEVE TO REAR FACE OF WALL OUTSIDE OF STAIRWELL
- (4) SIZE GRILLE TO MATCH NOMINAL ASSOCIATED FAN DISCHARGE OPENING (APPROXIMATELY 40" SQUARE).

	LOUVER (L) SCHEDULE (8) MAX CAPACITY SIZE (IN)																
						MAX.	CAPA	CITY		SIZE	(IN)				(1)		
MARK	MANUFACTURER, MODEL NU	JMBER A	PPLICATION	LOUVER TYPE	MTG. SYSTEM	INLET VEL. (FT/MIN.)	AIR FLOW (CFM)	PD (IN WC)	DAMPER TYPE		WIDTH	FINISH	MATERIAL	ACCESSORIES	MTG. HEIGHT	LOCATION	REMARKS
L-1	GREENHECK, ESD-635		RELIEF	3	1	400	1500	-	(5)	(6)	(6)	С	ALUMINUM	1	ETR	SEE PLANS	-
L-2	GREENHECK, ESD-635		RELIEF	3	1	400	1500	-	(5)	(6)	(6)	С	ALUMINUM	1	ETR	SEE PLANS	-
L-3	NOT USED		-	-	-	-	-	-	-	-	-	-	-	-	-	-	-
L-4	NOT USED		-	-	-	-	-	-	-	-	-	-	-	-	-	-	-
L-5	GREENHECK, ESD-635		INTAKE	3	1	1000	1500	-	(4)	(2)	(2)	С	ALUMINUM	1	ETR	SEE PLANS	-
L-6	EXISTING LOUVER TO REMAIN	1	INTAKE	ETR	ETR	ETR	ETR	-	(7)	ETR	ETR	ETR	ETR	ETR	SEE PLANS	-	
L-7	GREENHECK, ESD-635		INTAKE	3	1	1000	3500	-	(4)	(3)	(3)	С	ALUMINUM	1	(9)	SEE PLANS	-
	APPLICATION	L	OUVER TYPE			MOUNTII	NG SYSTEM			DAMPER TY	PE		FIN	NISH		<i>I</i>	ACCESSORIES
1	INTAKE	1 BF	RICK VENT		1	PLASTER/N	MASONRY WA	ALL	N	NONE		М	MILL			1	BIRD SCREEN
2	EXHAUST	2 TH	HIN LINE EXTR	UDED	2	EXPOSED I	DUCTWORK		BF	BUTTERFL	Y	W	MANUFACTURI	ER STANDARD W	HITE	2	INSECT SCREEN
3	RELIEF	3 DF	RAINABLE BLA	\DE	3	METAL PAN	NEL WALL		G	GRAVITY		s	MANUFACTURI	ER SPECIAL COL	OR	3	FLANGED FRAME
		4 S1	TATIONARY EX	KTRUDED	4	ROOF			MP	MOTORIZEI	D PNEUM.	0	OTHER (SEE SI	PECIFICATIONS)		4	SILL EXTENSIONS
		5 AE	DJUSTABLE EX	KTRUDED	5	EXTERIOR	STUD WALL		ME	MOTORIZEI	D ELECTRIC	. AA	ANODIZED ALL	IMINUM		5	FILTER RACK
		6 W	IND-DRIVEN R	AIN					ОВ	OPPOSED I	BLADE	FP	FACTORY PRIM	MED FOR FIELD P	AINTING		
									РВ	PARALLEL	BLADE	C CUSTOM COLOR SELECTED BY ARCH.					
									LL	LOW LEAKA	AGE, INSUL.						

7 SHUTTER GUARD

10 INLET WIRE GUARD

8 FAN SPEED CONTROLLER

9 NON-FUSED DISCONNECT SWITCH 19 EXTENDED LUBE LINES

- (1) APPROXIMATE, SEE DRAWINGS FOR MOUNTING HEIGHT AND LOCATION.
- (2) SIZE LOUVER TO MATCH EXISTING WALL OPENING SIZE. SUBMITTALS SHALL SHOW EVIDENCE OF OPENING SIZE COORDINATION. FOR ESTIMATING, APPROXIMATE SIZE IS 36x36 (3) SIZE LOUVER TO MATCH ASSOCIATED FAN WALL OPENING SIZE. SUBNMITTALS SHALL SHOW EVIDENCE OF OPENING SIZE COORDINATION. FOR ESTIMATING, APPROXIMATE SIZE IS 36x36
- (4) SPRING LOADED GRAVITY BACKDRAFT DAMPER (PROVIDED BY ASSOCIATED INTAKE SUPPLY FAN SUPPLIER WHEN PART OF FAN ASSEMBLY).
- (5) GALVANIZED INDUSTRIAL PRESSURE RELIEF DAMPER EQUAL TO GREENHECK MODEL HPR-120, SIZED TO MATCH ASSOCIATED RELIEF LOUVER. SET TO RELIEVE AT 0.20" W.C. PRESSURE

27 HANGING SPRING ISOLATORS

28 HANGING NEOPRENE ISOLATORS

30 ECM MOTOR WITH DIFF PRESSURE..

29 FACTORY INSULATED ANGLED FILTER BOX

(6) SIZE LOUVER TO MATCH EXISTING OPENING. APPROXIMATE SIZE IS 36"x36". FIELD VERIFY PRIOR TO SUBMITTAL SHALL SHOW EVIDENCE OF FIELD COORDINATION (7) PROVIDE NEW SPRING LOADED GRAVITY BACKDRAFT DAMPER TO MATCH EXISTING LOUVER SIZE (ESTIMATED TO BE 36"X36" (VERIFY))

	EXHAUST FAN (EF) AND SUPPLY FAN (SF) SCHEDULE																			
AIR FLOW (5) MOTOR FAN (2) MTG. MAXIMUM SOUND (1) OPENING (1)											NG (IN)									
MARK	MANUFACTURER, MODEL NUMBER	FAN TYPE	RATE (CFM)	ESP (IN WC)	(HP)	TYPE	SPEED (RPM)	DRIVE TYPE	ELECTRICAL (VOLTS/PH)	HEIGHT (FT)	(3) (DB)	(4) SONES	INSTALL. TYPE	INTERLOCK WITH	LENGTH	WIDTH	ACCESSORIES	WEIGHT (LB)	LOCATION	REMARKS
SF-1	GREENHECK, SE1-16-436-VG	9	2,000	0.40	3/4	ODP	1350	DIRECT	115/1	(6)	-	-	-	(7)	23 1/4	23 1/4	4,6,8,9,30	150	SEE PLANS	(8),(9)
SF-2	GREENHECK, SE1-16-436-VG	9	2,000	0.40	3/4	ODP	1350	DIRECT	115/1	(6)	-	-	-	(7)	23 1/4	23 1/4	4,6,8,9,30	150	SEE PLANS	(8),(9)
SF-3	GREENHECK, SCS3-24-315-A10-VGD	9	4,000	0.30	1	ODP	1580	DIRECT	208/3	(6)	-	-	-	(7)	33 3/4	33 3/4	1,4,5,8,9,30	250	SEE PLANS	(8),(10)
SF-4	GREENHECK, SCE3-30-612-B10-VGD	9	4,500	0.30	1	ODP	930	DIRECT	208/3	(6)	-	-	-	(7)	39 3/4	39 3/4	1,3,4,5,8,9,30	400	SEE PLANS	(8),(10)

SF-4	GREENHECK, SCE3-30-612-B10-VGD	9	4,500	0.30	1	ODP	930	DIRECT	208/3	(6)	-	-	-	(7)	39 3/4	39 3/4	1,3,4,5,8,9,30	4
	FAN T	FAN TYPE						МОТО	R TYPE			INSTA	LLATION T	YPE				
	CENTRIFUGAL		AXI	AL		ODP	OPEN D	RIP PROOF	=		Α	FREE INL	LET, FREE C	UTLET	1			
1	SIDEWALL	8	ROOFTOP D	OWNBLAST		TEFC TOTALLY ENCLOSED FAN COOLED						FREE INL	LET, DUCTE	D OUTLET				
2	INLINE	9	SIDEWALL P	ROPELLER		XPL EXPLOSION PROOF REMARKS:							-		-			
3	UTILITY	10	TUBE AXIAL			INV	INVERTE	ER DUTY			(1)	SEE SPE	CIFICATION	I SECTION 23099	3 - HVAC 9	SEQUENC	E OF OPERATIO	N.
4	CABINET	11	VANE AXIAL			TEAO	TOTALL'	Y ENCLOSE	ED AIR OVER		(2)	MOUNTI	NG HEIGHT	IS FROM FINISH	ED FLOOR	R LEVEL O	F INDICATED RO	νOΜ,
5	ROOFTOP UPBLAST	12	ROOFTOP U	PBLAST							(3)	SOUND F	POWER LEV	EL RATING PER	AMCA 301			
6	ROOFTOP HOODED	13	ROOFTOP F	RP UPBLAST	-							LOUDNE	SS VALUES	AT 5 FT IN A HE	MISPHERI	CAL FREE	FIELD PER AMO	A 30
7	ROOFTOP FILTERED SUPPLY	14	ROOFTOP H	OODED							(5)	DOES NO	OT INCLUDE	ACCESSORY IT	EM PRESS	SURE DRO)PS	
	ACCESSORIES										(6)	SEE DRA	WINGS FOF	R INSTALLATION	ELEVATIO	NS		

1 GRAVITY BACKDRAFT DAMPER 11 OUTLET WIRE GUARD 21 HOODED WALL CAP 2 MOTORIZED BACKDRAFT DAMPER 12 INLET FILTER GUARD 22 HOODED ROOF CAP 3 WEATHERHOOD 13 MOTOR COVER 23 HINGED ROOF CURB 14 HOUSING INSULATION 24 INLET GRILLE 4 WALL COLLAR MOTOR WIRE GUARD 15 BELT (OSHA) WIRE GUARD 25 BASE MOUNTED VIBRATION ISOLATORS 6 MOTOR (OSHA) WIRE GUARD 16 INLET BELL 26 DUCT ADAPTOR 17 INLET/OUTLET FLANGES

18 INLET VANE DAMPER

20 MFR. ROOF CURB


LOUDNESS VALUES AT 5 FT IN A HEMISPHERICAL FREE FIELD PER AMCA 301. DOES NOT INCLUDE ACCESSORY ITEM PRESSURE DROPS (6) SEE DRAWINGS FOR INSTALLATION ELEVATIONS (7) SEE SEE HVAC CONTROL SEQUENCES SPECIFICATION FOR INTERLOCK REQUIREMENTS

(8) PROVIDE ALLCOMPONENTS NECESSARY FOR DIFFERENTIAL PRESSURE SPEED CONTROL OF FAN, INCLUDING BUT NOT LIMITED TO PRESSURE TRANSDUCER'S, PROBES, TRANSFORMERS, TUBING, ETC.. (9) INSTALL DIFFERENTIAL FAN SPEED CONTROLLER ON OR NEAR FAN OUTSIDE STAIRWELL SERVED. INSTALL ONE

(2) MOUNTING HEIGHT IS FROM FINISHED FLOOR LEVEL OF INDICATED ROOM, TO TOP OF FAN OR WALL OPENING.

PRESSURE SENSING PORT WITHIN STAIRWELL CLOSE TO SECOND FLOOR LEVEL, OUT OF REACH OF STAIRWELL... OCCUPANTS AND OTHER PORT EXPOSED TO THE OUTDOORS. CAULK AND SEAL WALL PENTRATIONS (FIRE RATED PENETRATION FOR STAIRWELL)


(10) SAME AS NOTE (9) ABOVE EXCEPT INSTALL STAIRWELL PRESSURE SENSING PORT CLOSE TO 1ST FLOOR LEVEL

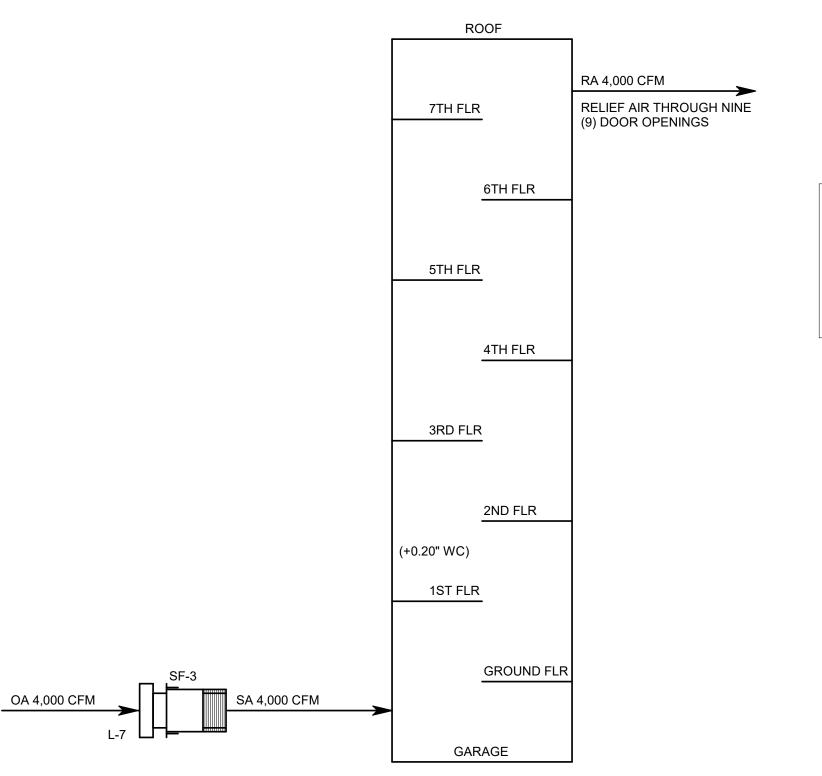


SW STAIRWELL #4 FLOW DIAGRAM

NW STAIRWELL #1 FLOW DIAGRAM

12" = 1'-0"

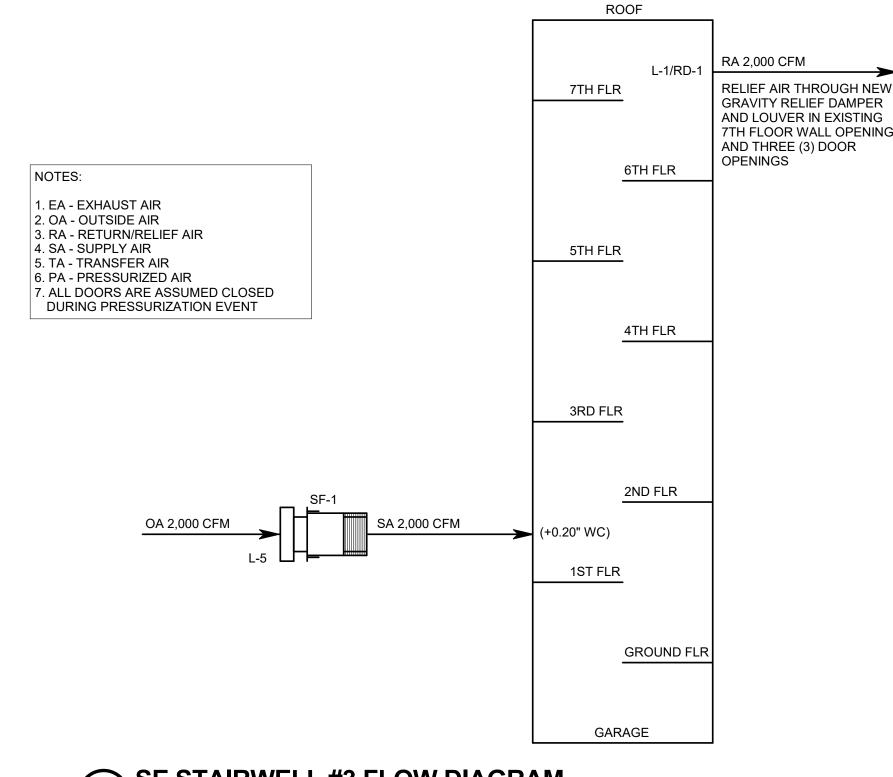

SE STAIRWELL #3 FLOW DIAGRAM

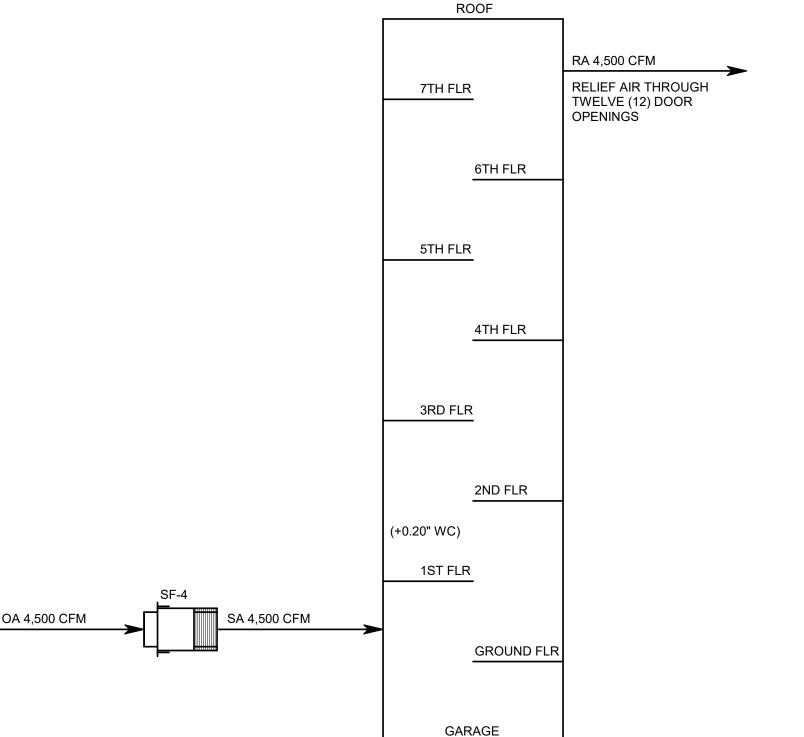

NE STAIRWELL #2 FLOW DIAGRAM

12" = 1'-0"

HVAC SYMBOLS:

AIRFLOW (SUPPLY) AIRFLOW (RETURN) AIRFLOW (DOOR GRILLE 3/4" DOOR CUTOFF SUPPLY OR OUTDOOR AIR EXHAUST SUPPLY DUCT TURNED AWAY SUPPLY DUCT TURNED TOWARD (FIRST FIGURE IS SIDE SHOWN) 12ø ROUND DUCT (RIGID) / 12/12ø / OVAL DUCT FLEXIBLE CONNECTION DUCT (FLEXIBLE ROUND) TURNING VANES TRANSITION (SQUARE-TO-ROUND) BACKDRAFT DAMPER AD FD MOD FIRE DAMPER & ACCESS DOOR MOTOR OPERATED DAMPER OPPOSED BLADE DAMPER PARALLEL BLADE DAMPER ROOM SENSOR STATIC PRESSURE SENSOR TEMPERATURE SENSOR THERMOSTAT SMOKE DETECTOR

AIR OUTLET/INLET TYPE

(CFM)

A

GENERAL NOTES:

INDICATED IN THE CONTRACT DOCUMENTS.

VALIDATE PROPER SYSTEM OPERATION

- ABBREVIATIONS INDICATED HERE AND NOT USED IN THE CONTRACT DOCUMENTS DO NOT APPLY TO THIS PROJECT. ADDITIONAL ABBREVIATIONS MAY BE
- 2. THESE DRAWINGS ARE DESIGN DRAWINGS AND ARE DIAGRAMMATIC, THEY MAY NOT SHOW ALL PHYSICAL ARRANGEMENTS, OFFSETS, BENDS, OR ELBOWS WHICH MAY BE REQUIRED FOR PROPER INSTALLATION OF VARIOUS MATERIALS, EQUIPMENT, PIPING AND DUCTWORK SYSTEMS IN ALLOTTED SPACES. EXAMINE THESE AND OTHER AVAILABLE DRAWINGS TO DETERMINE SPACE LIMITATIONS AND INTERFERENCES. MAKE ANY MINOR CHANGES IN LOCATIONS OF EQUIPMENT, PIPING, AND DUCTWORK FROM THAT SHOWN ON DRAWINGS AND FOR ALL PHYSICAL DETAILS REQUIRED FOR INSTALLATION. COST FOR ADAPTING WORK TO JOB SITE CONDITIONS SHALL NOT BE CONSIDERED AS BASIS OF AN EXTRA COST TO CONTRACT.
- ELEVATION OF PIPING AND DUCTWORK INDICATED ON THESE DRAWINGS ARE TO BE USED AS GUIDELINES TO ASSIST WITH INSTALLATIONS. MINOR CHANGES TO THESE ELEVATIONS MAY BE NECESSARY TO ELIMINATE UNFORESEEN INTERFERENCES. ANY CHANGE IN ELEVATION SHALL BE APPROVED
- 4. ANY AND ALL INFORMATION SHOWN ON THESE DRAWINGS WITH RESPECT TO EXISTING STRUCTURES, UTILITIES, AND MECHANICAL SYSTEMS, IS AS EXACT AS COULD BE SECURED. THE INFORMATION IS NOT WARRANTED NOR GUARANTEED ACCURATE, FIELD VERIFY ALL EXISTING CONDITIONS PRIOR TO
- 5. ACCURATE AND LEGIBLE AS-BUILT DRAWING MARKUPS SHALL BE MAINTAINED AT THE JOB SITE, AND BE SUBMITTED PRIOR TO FINAL PAYMENT FOR THE
- 6. ALL NEW AND EXISTING ROOFING SYSTEMS SHALL BE PROTECTED FROM DAMAGE DURING CONSTRUCTION ACTIVITIES.
- 7. VERIFY ALL EQUIPMENT LOCATIONS AND PIPE ROUTING WITH OWNER PRIOR TO INSTALLATION.
- 8. SEQUENCE OF WORK AND/OR PLACE OF COMMENCEMENT OF WORK SHALL BE APPROVED PRIOR TO WORK BEING STARTED. SCHEDULED SHUTDOWNS SHALL BE CLOSELY COORDINATED WITH EXISTING OPERATIONS.
- A. ALL HVAC SYSTEMS ON 6TH AND 7TH FLOORS OF FACILITY SHALL BE CLEANED PER SPECIFICATION SECTION 230600 HVAC AIR DUCT CLEANING. THIS INCLUDES AIR SYSTEMS IN THE ROOFTOP PENTHOUSES SERVING THE 6TH AND 7TH FLOORS
- B. SEE NON-MEAD & HUNT DRAWINGS CCB-0, CCB-1, M1-1, M1-2, M2-0, M2-1, M3-0, 9.15 THROUGH 9.19, SHEET 19 OF 45, M14, AND M15 FOR ADDITIONAL INFORMATION REGARDING EXISTING 6TH AND 7TH FLOOR HVAC SYSTEMS
- C. PROPER STAGING/SCHEDULING OF DUCT CLEANING ACTIVITIES IS CRITICAL TO MAINTAIN ONGOING OPERATIONS OF THE FACILITY. SEE ARCHITECTURAL DRAWING A003 FOR STAGING PLANS OF THE 6TH AND 7TH FLOORS. CONTRACTORS BID MUST ACCOMMODATE STAGING PLAN
- 10. COMMISSIONING: ALL HVAC SYSTEMS IN THIS PROJECT SHALL BE COMMISSIONED TO VERIFY COMPLIANCE WITH DESIGN INTENT. COMMISSIONING SHALL INCLUDE BUT NOT BE LIMITED TO SIMULATING A FIRE EVENT VIA THE MAIN FIRE ALARM CONTROL PANEL AND VERIFYING THE OPERATION OF ALL FOUR FANS DURING THE FIRE EVENT. WHEN THE FANS ARE ENERGIZED, MEASURE AND RECORD THE NET DEVELOPED POSITIVE PRESSURE IN EACH STAIRWELL RELATIVE TO OUTDOOR ATMOSPHERE (TARGET IS 0.10" TO 0.20" W.C. PRESSURE) WHILE CHECKING THE OPERATION OF THE ASSOCIATED RELIEF DAMPER AND FAN SPEED CONTROLLER. DO THIS FOR EACH FAN IN EACH STAIRWELL WITH THE JUST THE SEVENTH FLOOR DOOR OPEN AND THEN AGAIN WITH THE SIXTH AND SEVENTH FLOOR DOORS OPEN. CHECK FOR DOORS THAT MAY BE DIFFICULT TO OPEN DUE TO THE POSITIVE PRESSURE IN THE STAIRWELL. CONTRACTOR SHALL ALSO BUDGET ONE FULL DAY OF ADDITIONAL COMMISSIONING TIME TO ASSIST THE OWNER AND FIRE MARSHALL INSPECT AND
- 11. ANY STAIRWELL PIPE PENETRATION (NOT FLOOR TO FLOOR WITHIN THE STAIRWELL) WITH AN ANNULAR GAP GREATER THAN 1/16" SHALL BE SEALED WITH FIRE RATED CAULKING. FOR BIDDING PURPOSES ASSUME THERE IS ONE PENETRATION IN EACH OF THE FOUR STAIRWELLS THAT NEEDS TO BE SEALED
- 12. FOR ANY FASTENERS EXPOSED TO OCCUPANTS OF THE STAIRWELLS, PROVIDE SECURITY FASTENERS AS SPECIFIED IN SECTION 050533 SECURITY

Mead & Hunt, Inc. 2440 Deming Way Middleton, WI 53562 phone: 608-273-6380 meadhunt.com



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DANE COUNTY DEPT. OF PUBLIC WORKS, HIGHWAY & TRANSPORTATION 1919 ALLIANT ENERGY CENTER WAY MADISON, WI 53713

PROJECT NO. 317006

RA 2,000 CFM

OPENINGS

7TH FLR

5TH FLR

(+0.20" WC)

1ST FLR

6TH FLR

4TH FLR

2ND FLR

GROUND FLF

GARAGE

RELIEF AIR THROUGH NEW

GRAVITY RELIEF DAMPER

AND LOUVER IN EXISTING 7TH FLOOR WALL OPENING AND THREE (3) DOOR

04/04/17 BID DOCUMENTS

BID DOCUMENTS

M&H NO.: 4215400-161950.01 DATE: April 4, 2017 DESIGNED BY: RFP DRAWN BY: RJH

SHEET CONTENTS MECHANICAL NOTES & SYMBOLS

DO NOT SCALE DRAWINGS

SHEET NO .:

CHECKED BY: KML

M001

KEYED NOTES

7.001 DOOR TO BE REMOVED

7.002 REMOVE EXISTING LOUVER. INFILL RESULTANT OPENING AROUND NEW DAMPER/LOUVER ASSEMBLY WITH 3" THICK POLYSTYRENE INSULATION WRAPPED IN SHEET ALUMINUM.

7.003 REMOVE EXISTING BLANK-OFF DAMPER AND ELECTRIC FINNED TUBE HEATER. EXISTING LOUVER TO REMAIN. BLANK-OFF RESULTANT OPENING AROUND NEW DAMPER WITH 3" THICK POLYSTYRENE INSULATION WRAPPED IN SHEET ALUMINUM. TOP OF NEW LOUVER/DAMPER ASSEMBLY SHALL BE TIGHT TO TOP OF EXISTING OPENING.

7.004 REMOVE EXISTING DAMPER ASSEMBLY AND ELECTRIC FINNED TUBE HEATER. EXISTING LOUVER TO REMAIN. BLANK-OFF BACK SIDE OF LOUVER WITH 2" OF RIGID SHEET POLYSTYRENE WRAPPED IN SHEET ALUMINUM.

7.005 REMOVE WINDOW AND REPLACE WITH LOUVER AS INDICATED.

7.006 PROVIDE 1 1/2 HOUR FIRE RATED BLANKET INSULATION OVER GALVANIZED DUCT PLENUM FROM CONNECTION TO OA INTAKE LOUVER TO STAIRWELL

7.007 OPEN ENDED SUPPLY FAN WITHIN DUCT PLENUM.

7.008 CUT NEW WALL OPENING FOR SUPPLY GRILLE.

7.009 RELOCATE/RE-ROUTE EXISTING 3" LOW PRESSURE STEAM LINE AROUND NEW DUCT PLENUM. RE-INSULATE WITH LIKE INSULATION.

7.010 PROVIDE NEW WALL OPENING IN CONCRETE WALL WITH BOTTOM OF OPENING MINIMUM 4'-0" AFF.

7.011 PROVIDE SUPPORT STAND FOR EXTERIOR PORTION OF FAN. SUPPORT FROM AREA WELL FLOOR.

7.012 PROVIDE NEW WALL OPENING IN EXISTING CONCRETE WALL.

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PUBLIC WORKS, HIGHWAY & TRANSPORTATION 1919 ALLIANT ENERGY CENTER WAY MADISON, WI 53713

PROJECT NO. 317006

BID DOCUMENTS

04/04/17 BID DOCUMENTS


DESIGNED BY: RFP DRAWN BY: RJH CHECKED BY: KML


SHEET CONTENTS MECHANICAL PLANS


M101


MECHANICAL PLAN SEVENTH FLOOR - NORTHWEST


1/8" = 1'-0"

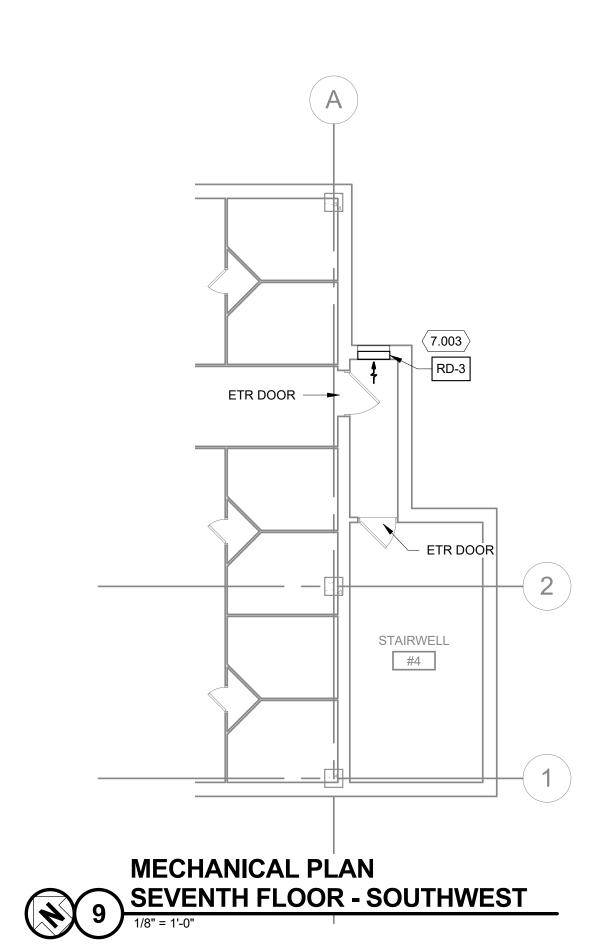

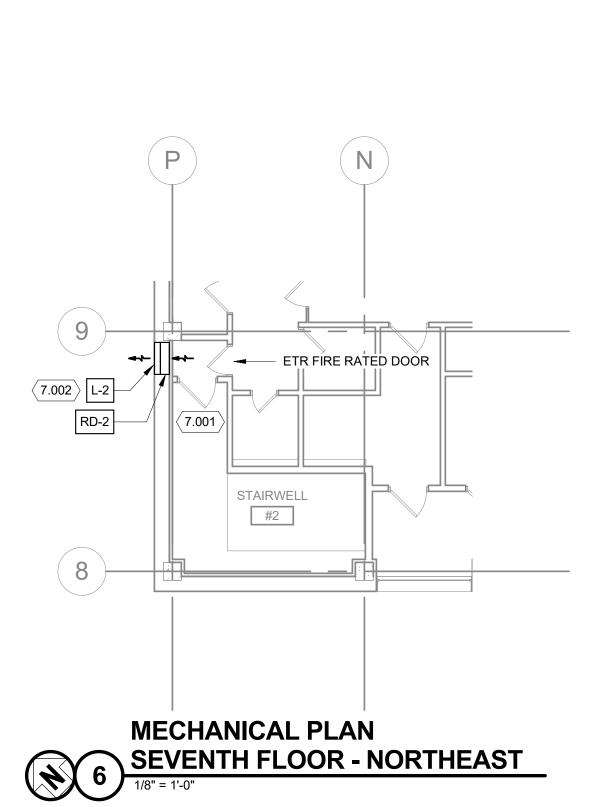

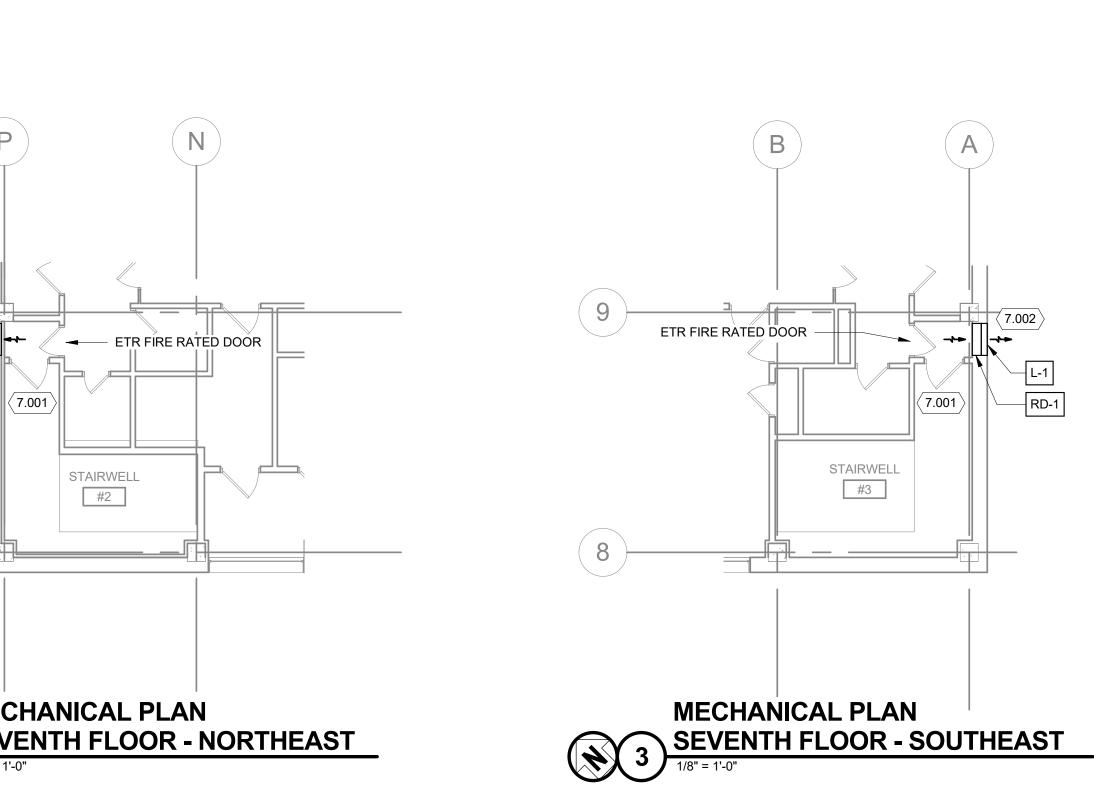

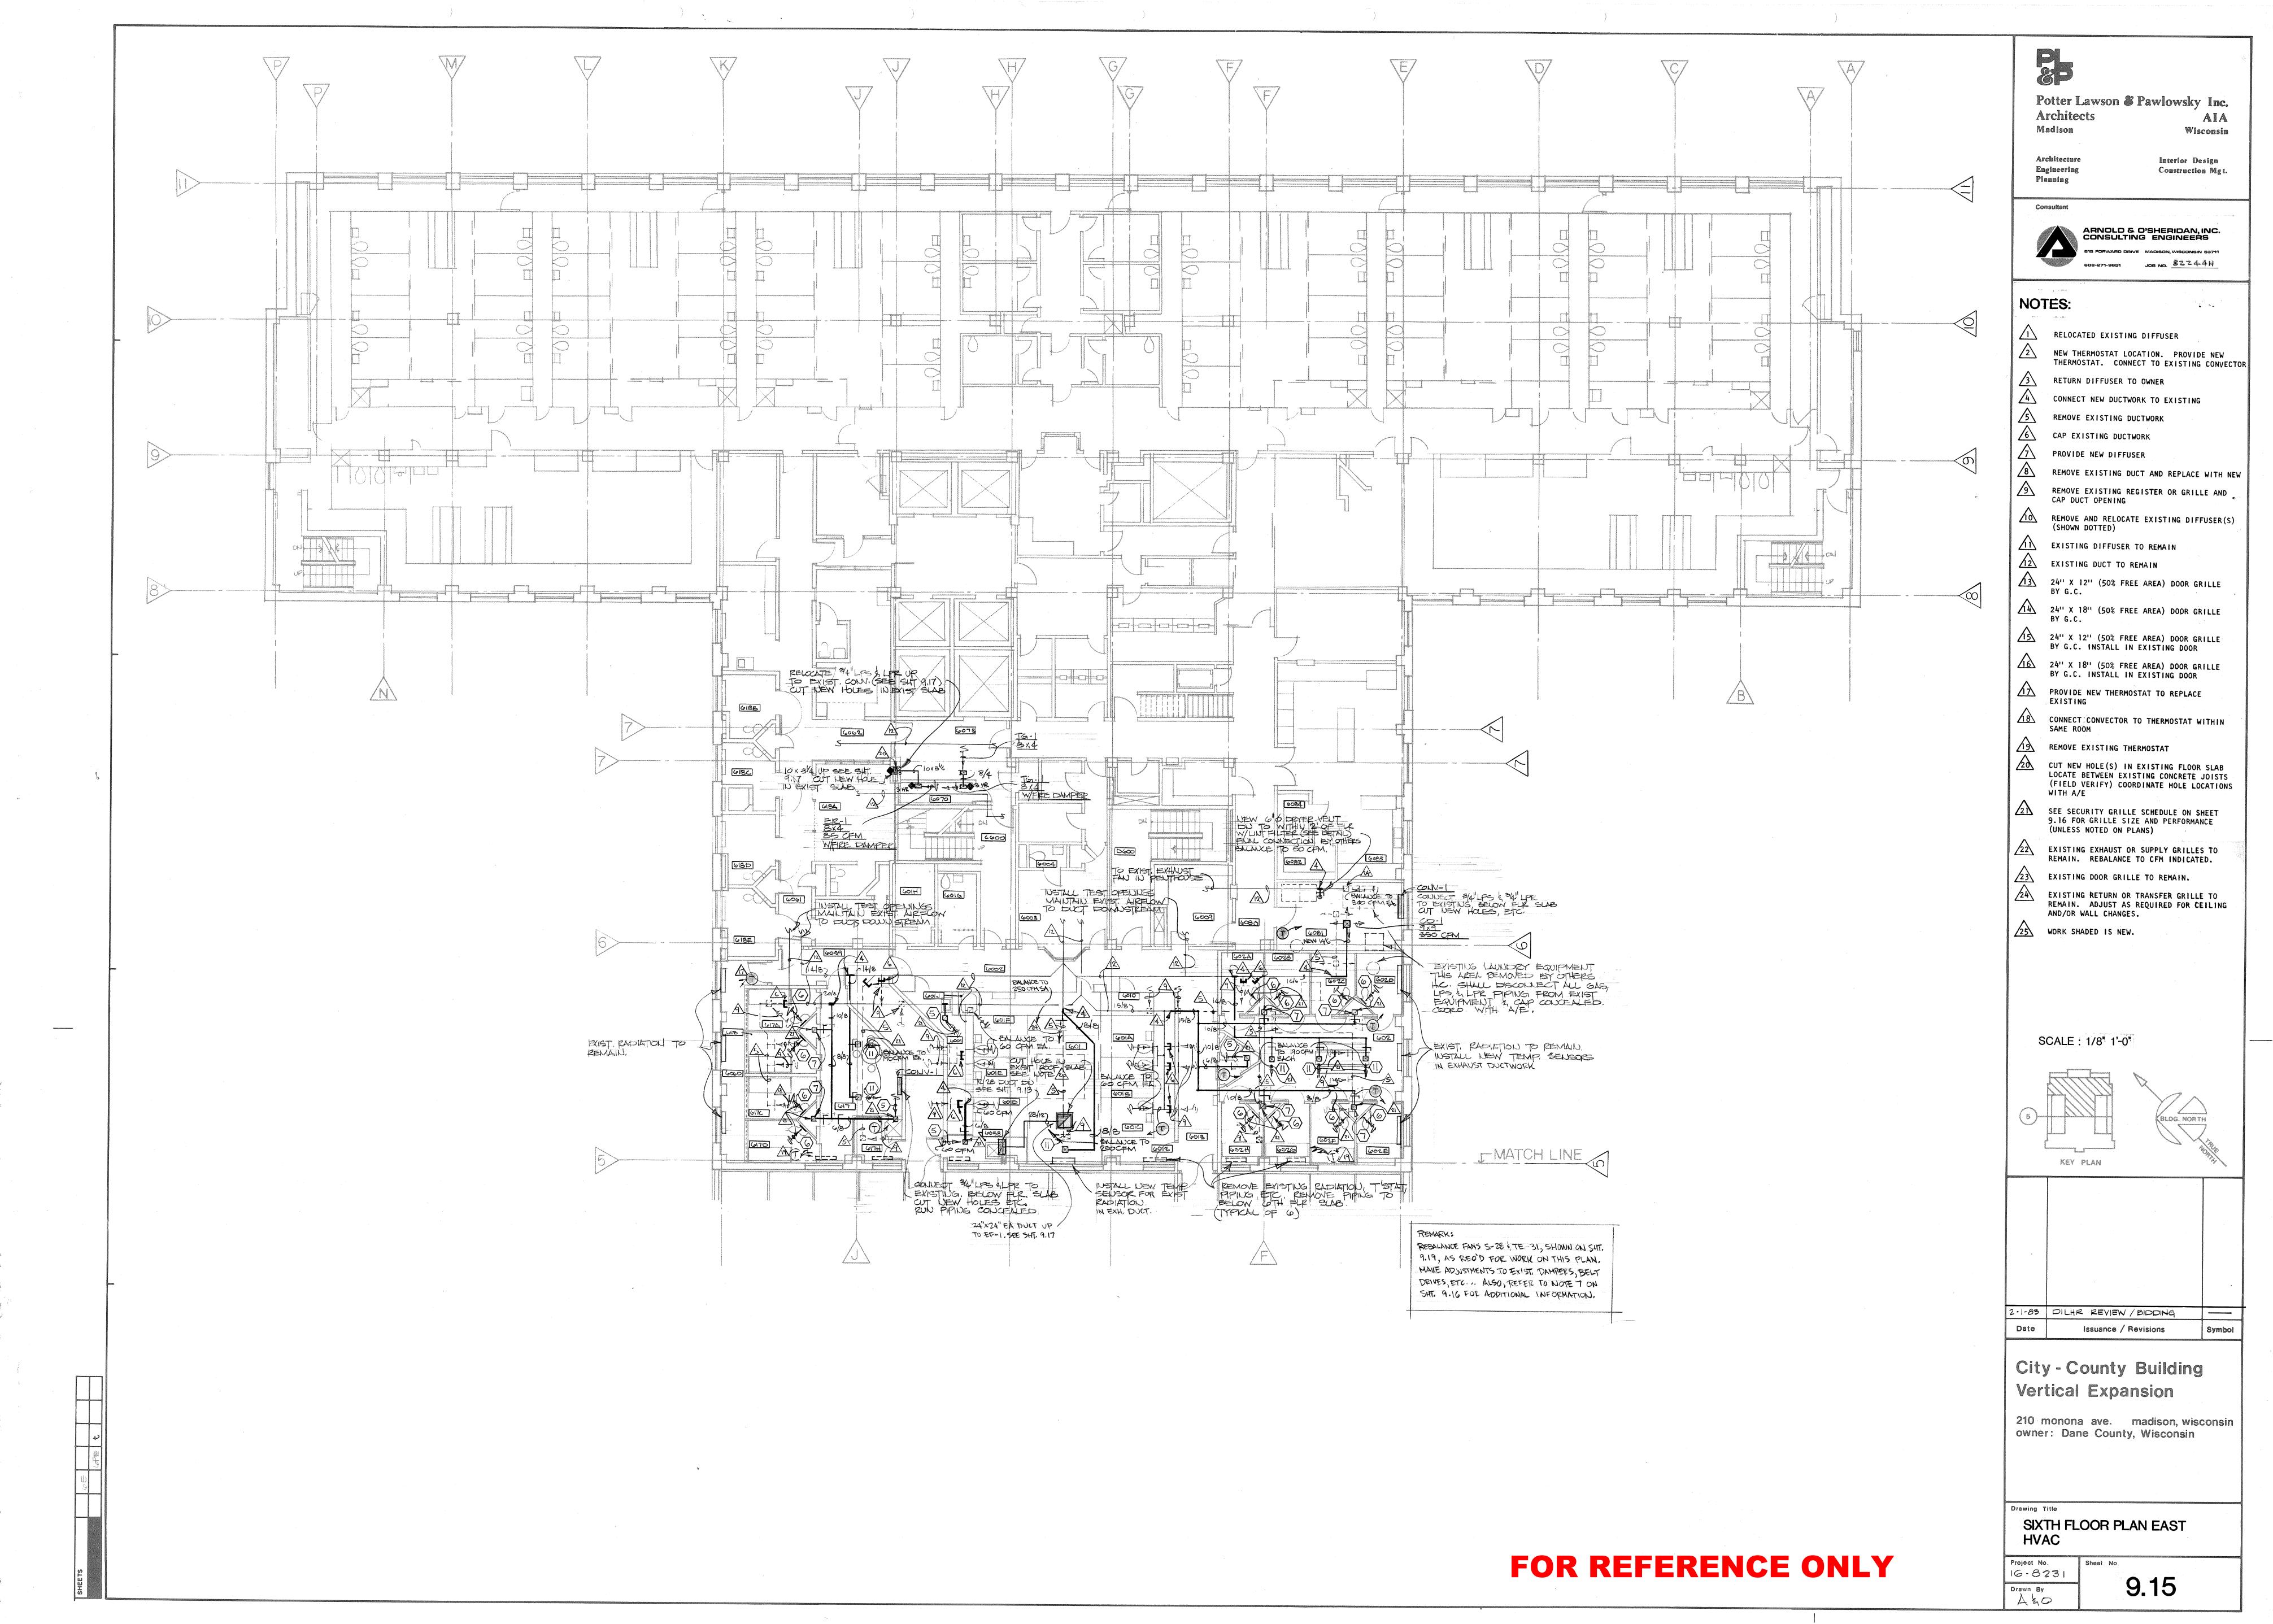

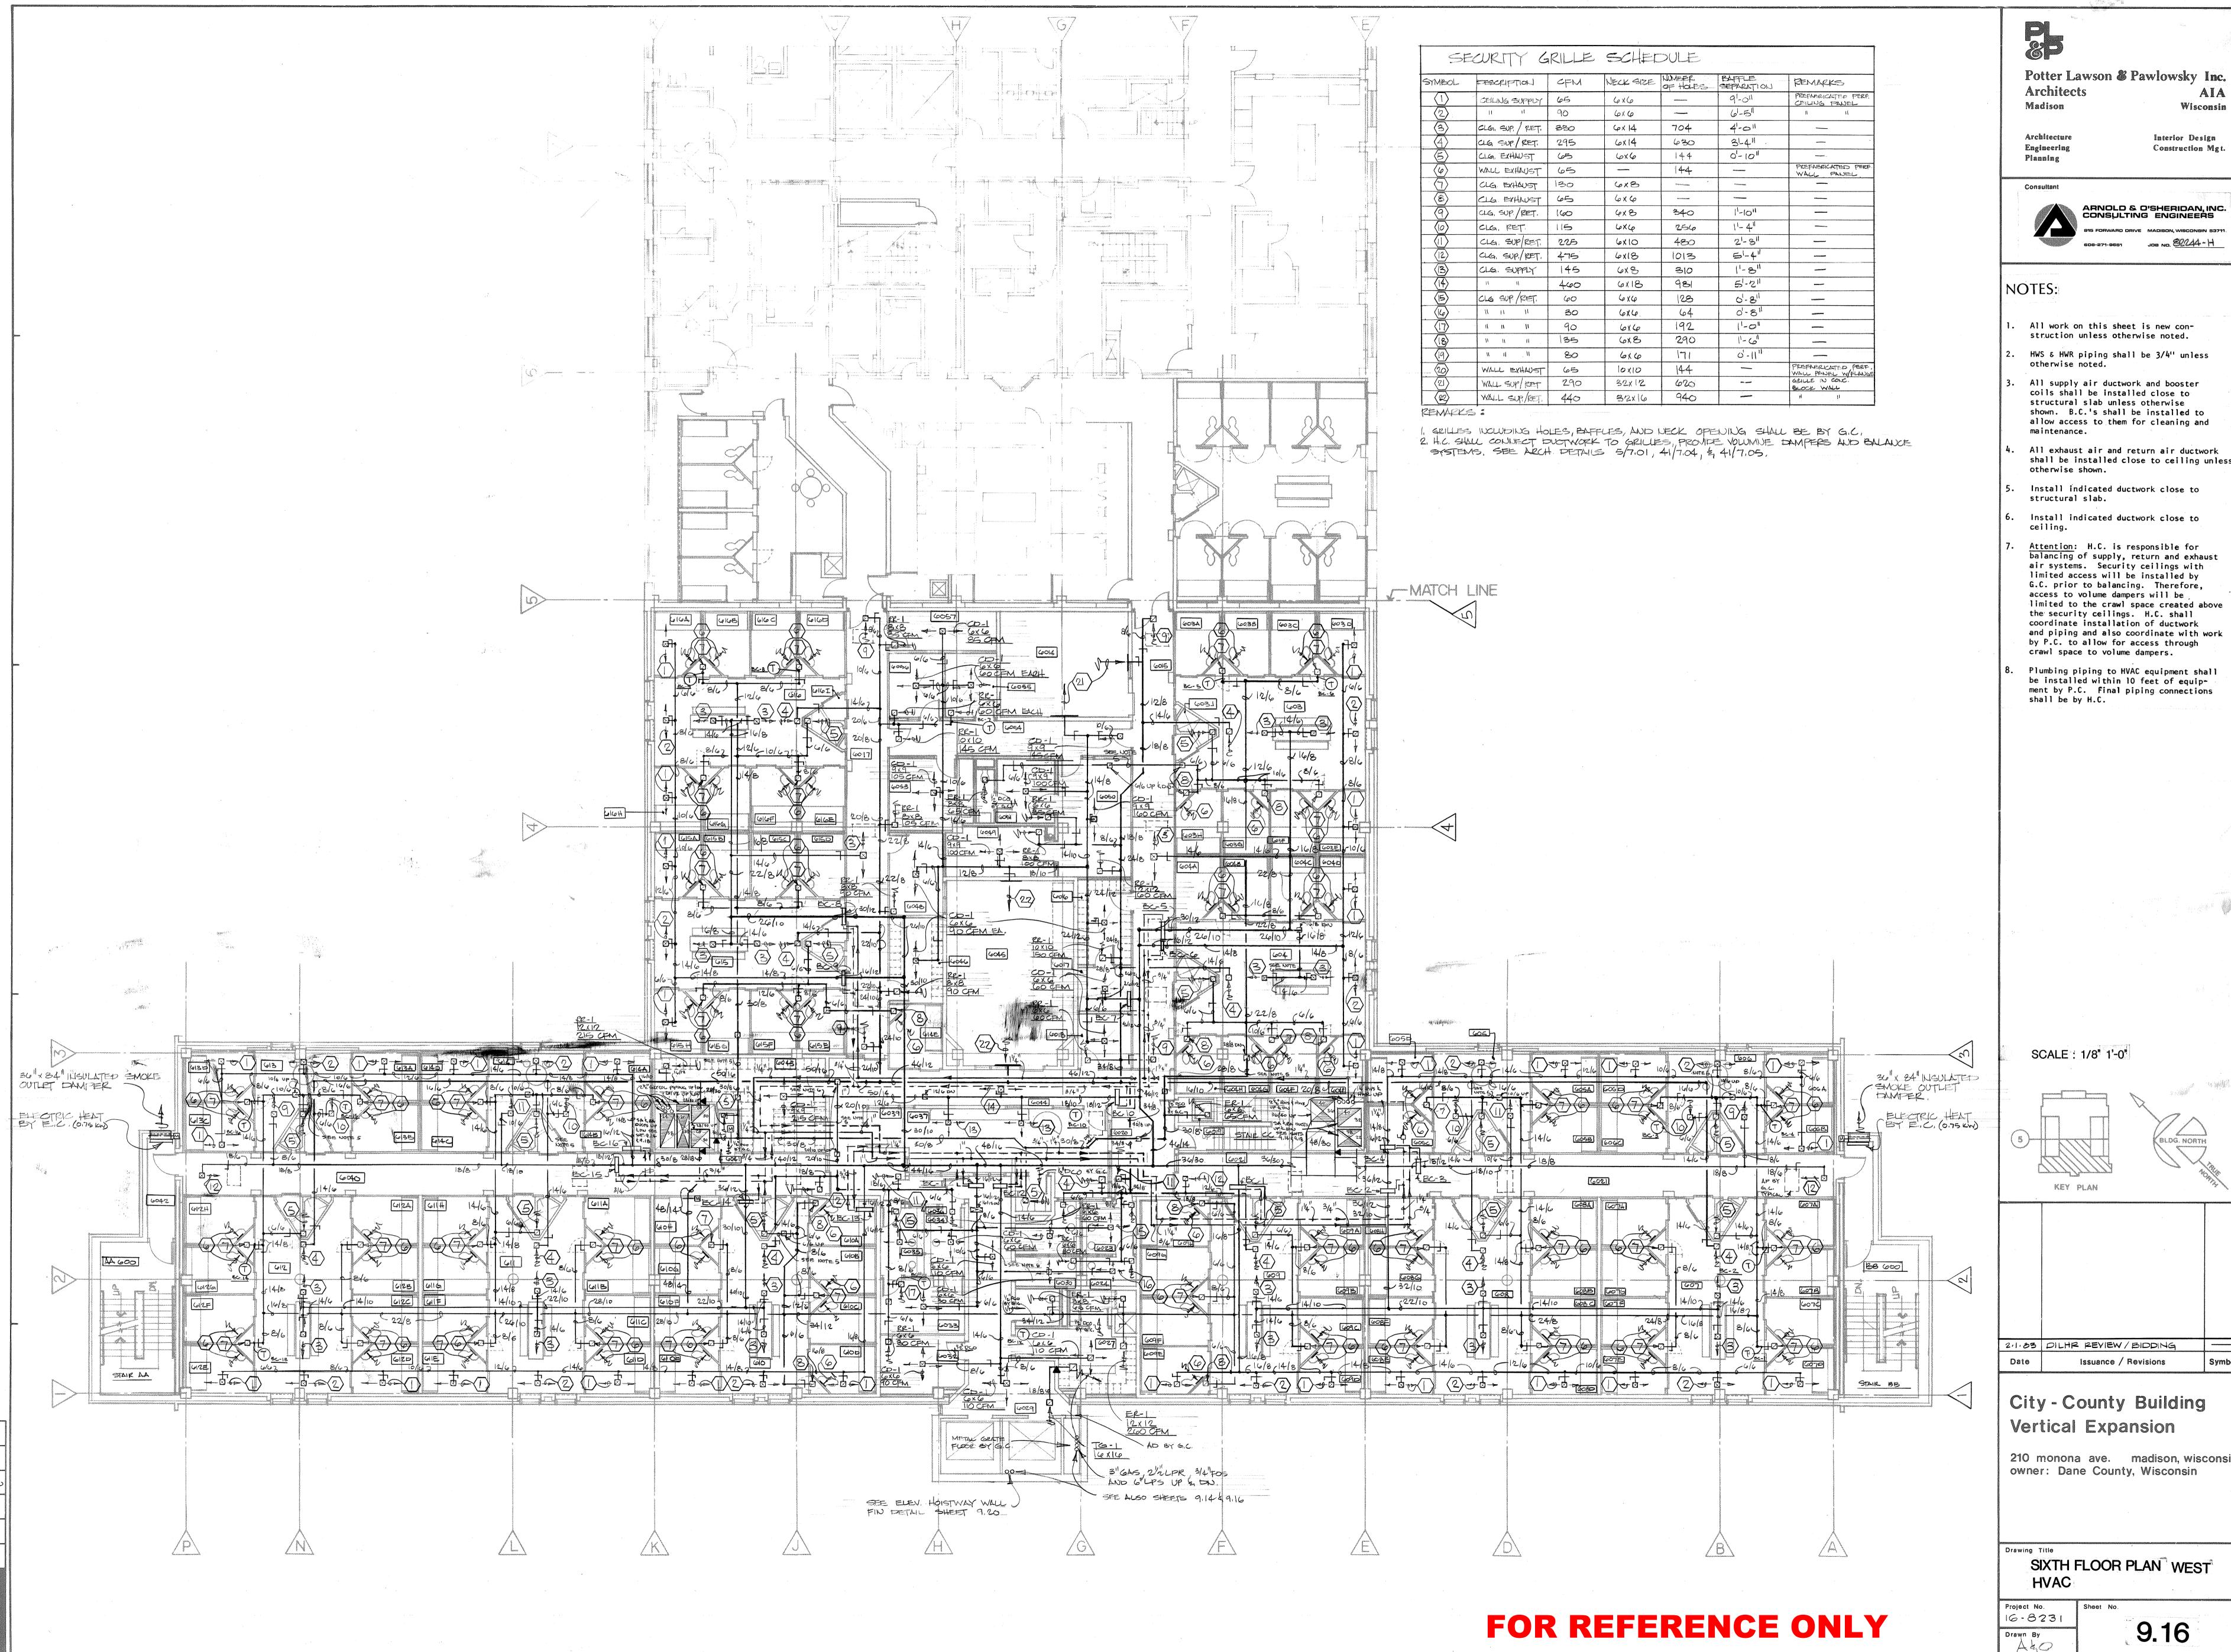



Potter Lawson & Pawlowsky Inc. Wisconsin

> Interior Design Construction Mgt.

608-271-9651 JOB NO. 82244-H

- All work on this sheet is new con-
- HWS & HWR piping shall be 3/4" unless
- All supply air ductwork and booster coils shall be installed close to structural slab unless otherwise shown. B.C.'s shall be installed to
- All exhaust air and return air ductwork shall be installed close to ceiling unless
- Install indicated ductwork close to
- Install indicated ductwork close to
- Attention: H.C. is responsible for balancing of supply, return and exhaust air systems. Security ceilings with limited access will be installed by G.C. prior to balancing. Therefore, access to volume dampers will be limited to the crawl space created above the security ceilings. H.C. shall coordinate installation of ductwork and piping and also coordinate with work by P.C. to allow for access through
- Plumbing piping to HVAC equipment shall be installed within 10 feet of equipment by P.C. final piping connections

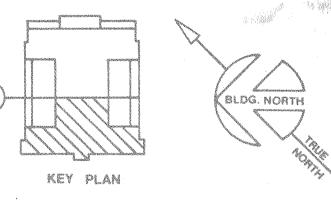

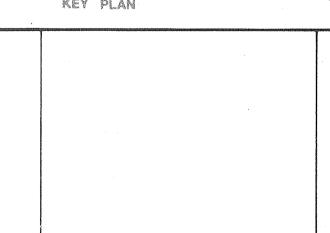


City - County Building

210 monona ave. madison, wisconsin owner: Dane County, Wisconsin


SIXTH FLOOR PLAN WEST

9.16

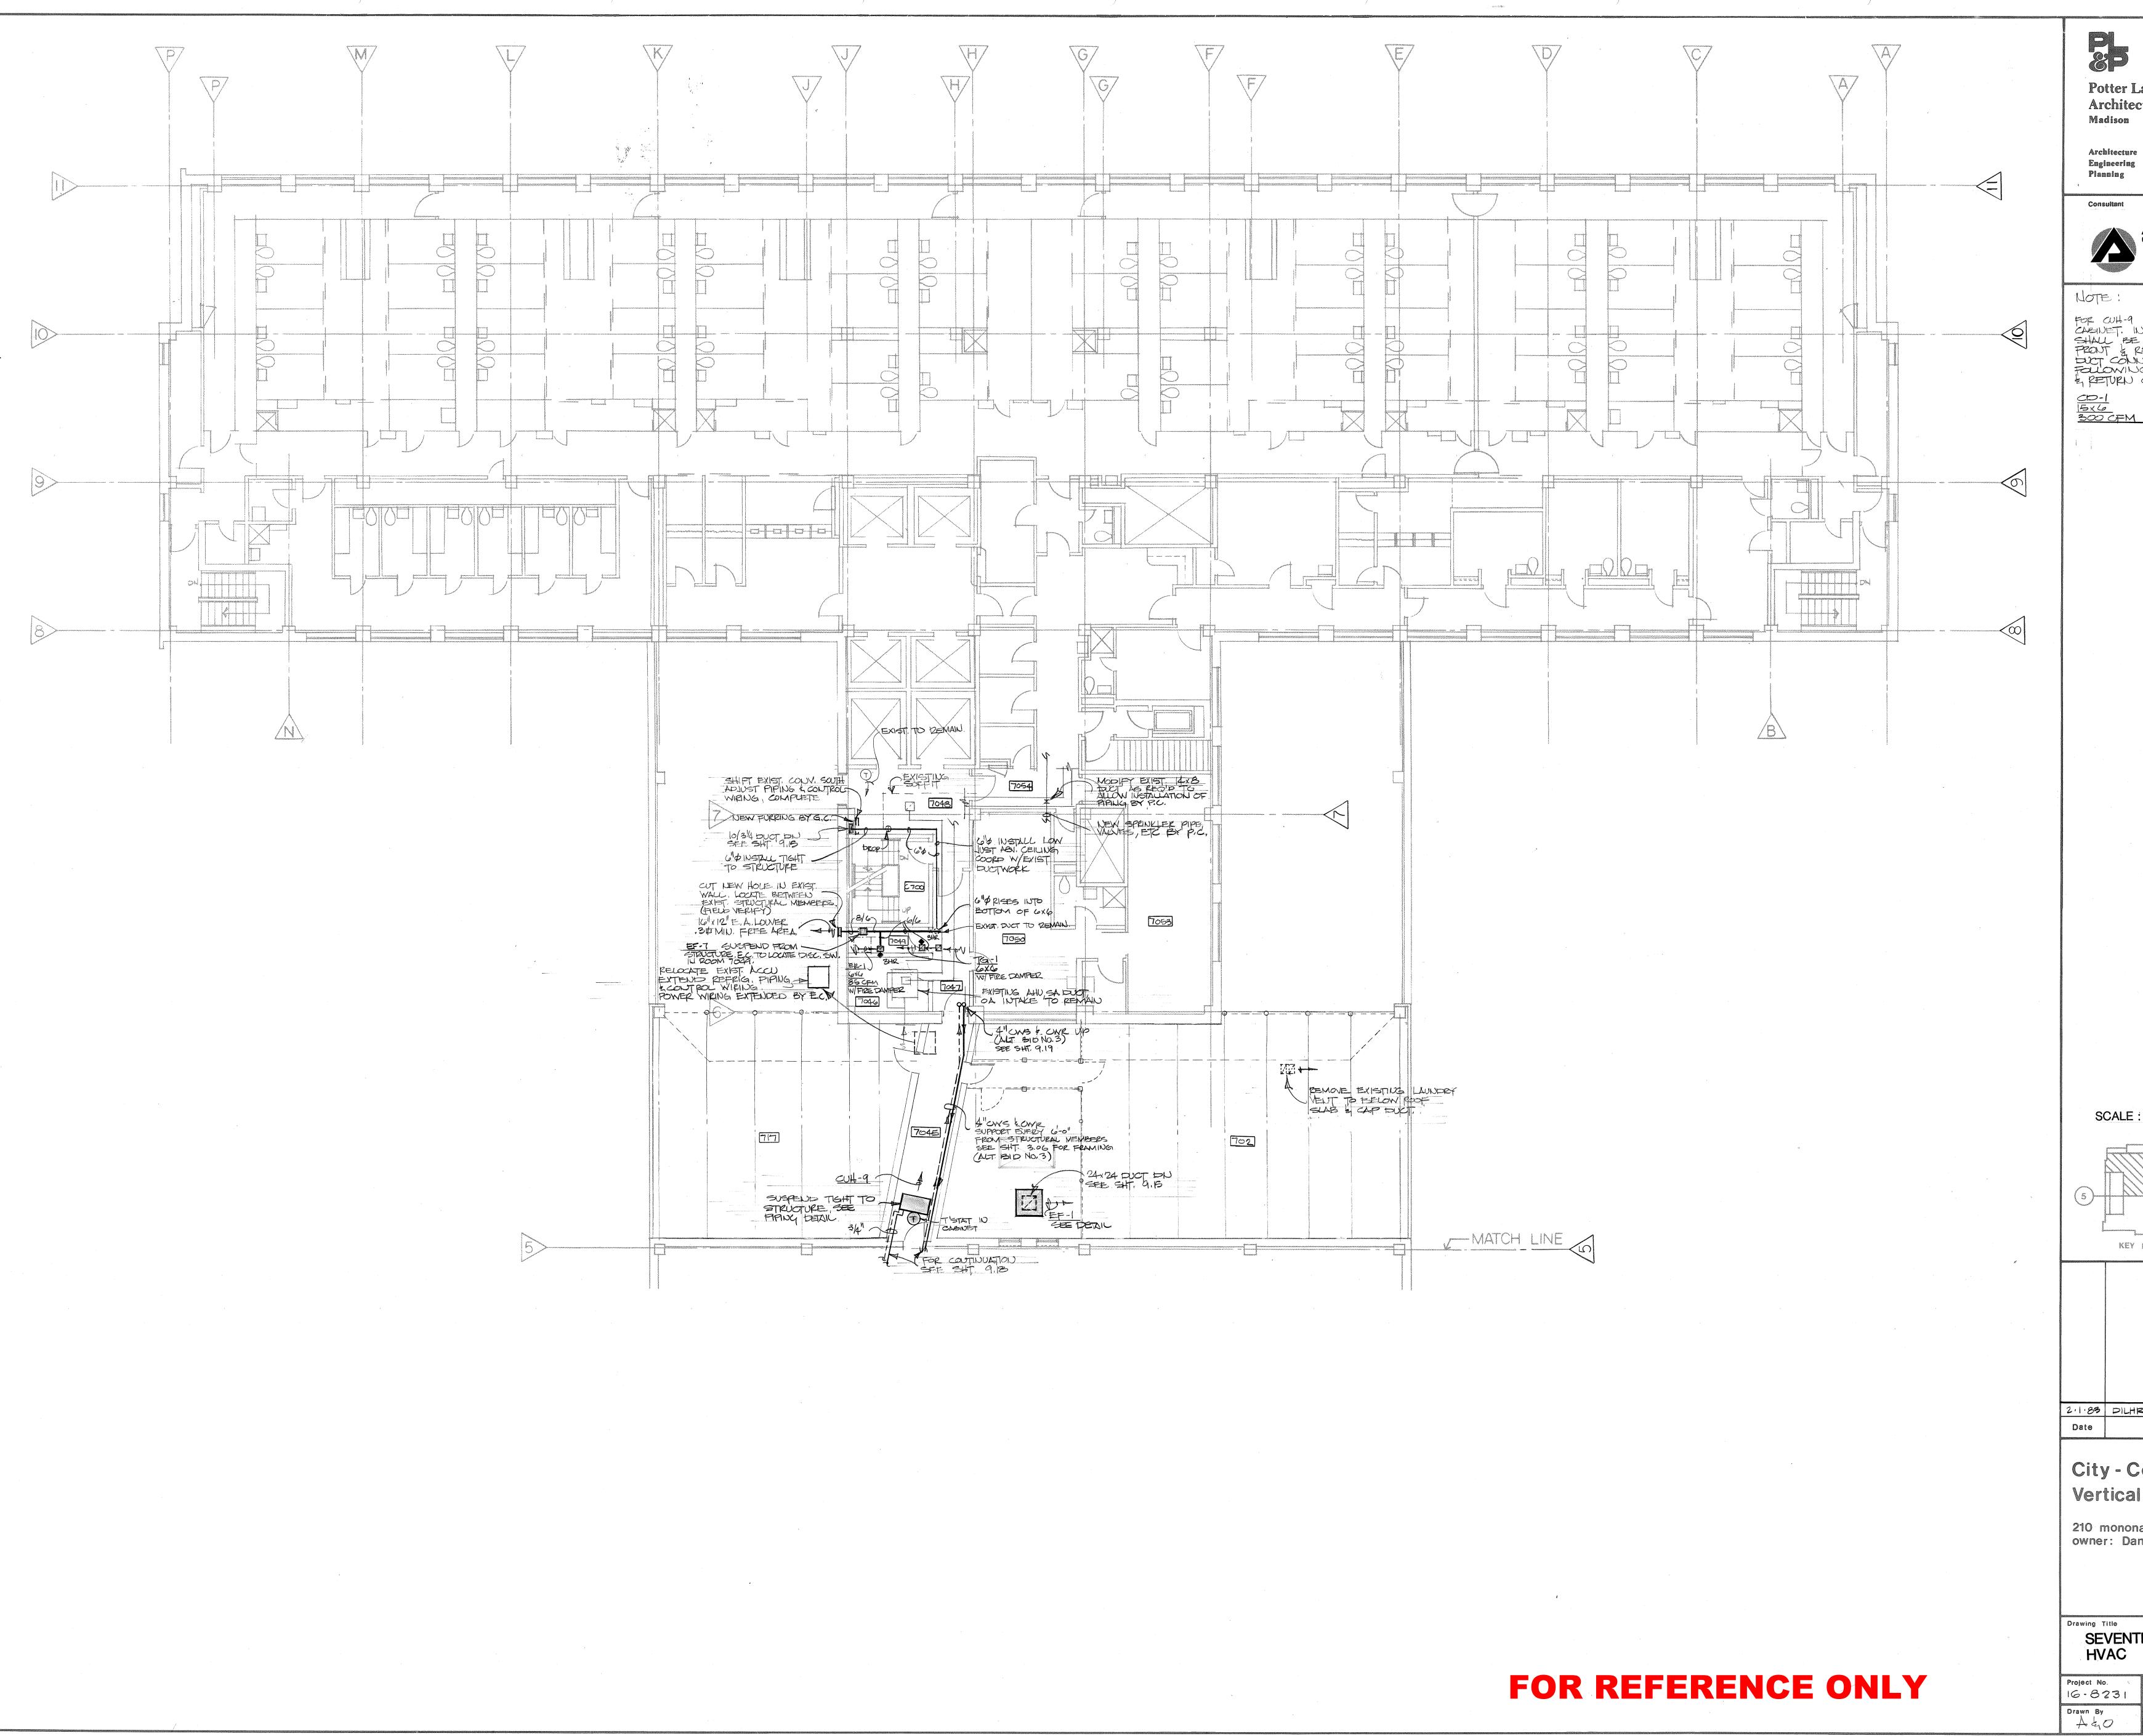


Potter Lawson & Pawlowsky Inc. Architects Wisconsin

> Interior Design Construction Mgt.

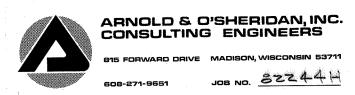

FOR OUT-9 INSTALL ALL VALVES WITHIN CAPINET. IN ALT. BID NO. 3 UNIT SHALL BE FULLY RECESSED WITH FRONT & REAR DUCT OUTLETS, DUCT CONNECTORS, AND THE FOLLOWING CELLING DIFFUSER & PETURN GRILLE:

SCALE: 1/8" 1'-0"

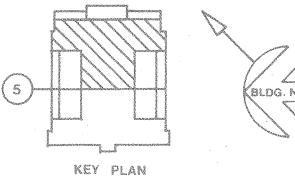

2.1.83 DILHR REVIEW / BIDDING

Issuance / Revisions


City - County Building Vertical Expansion


owner: Dane County, Wisconsin


SEVENTH FLOOR PLAN EAST

16-8231

9.17

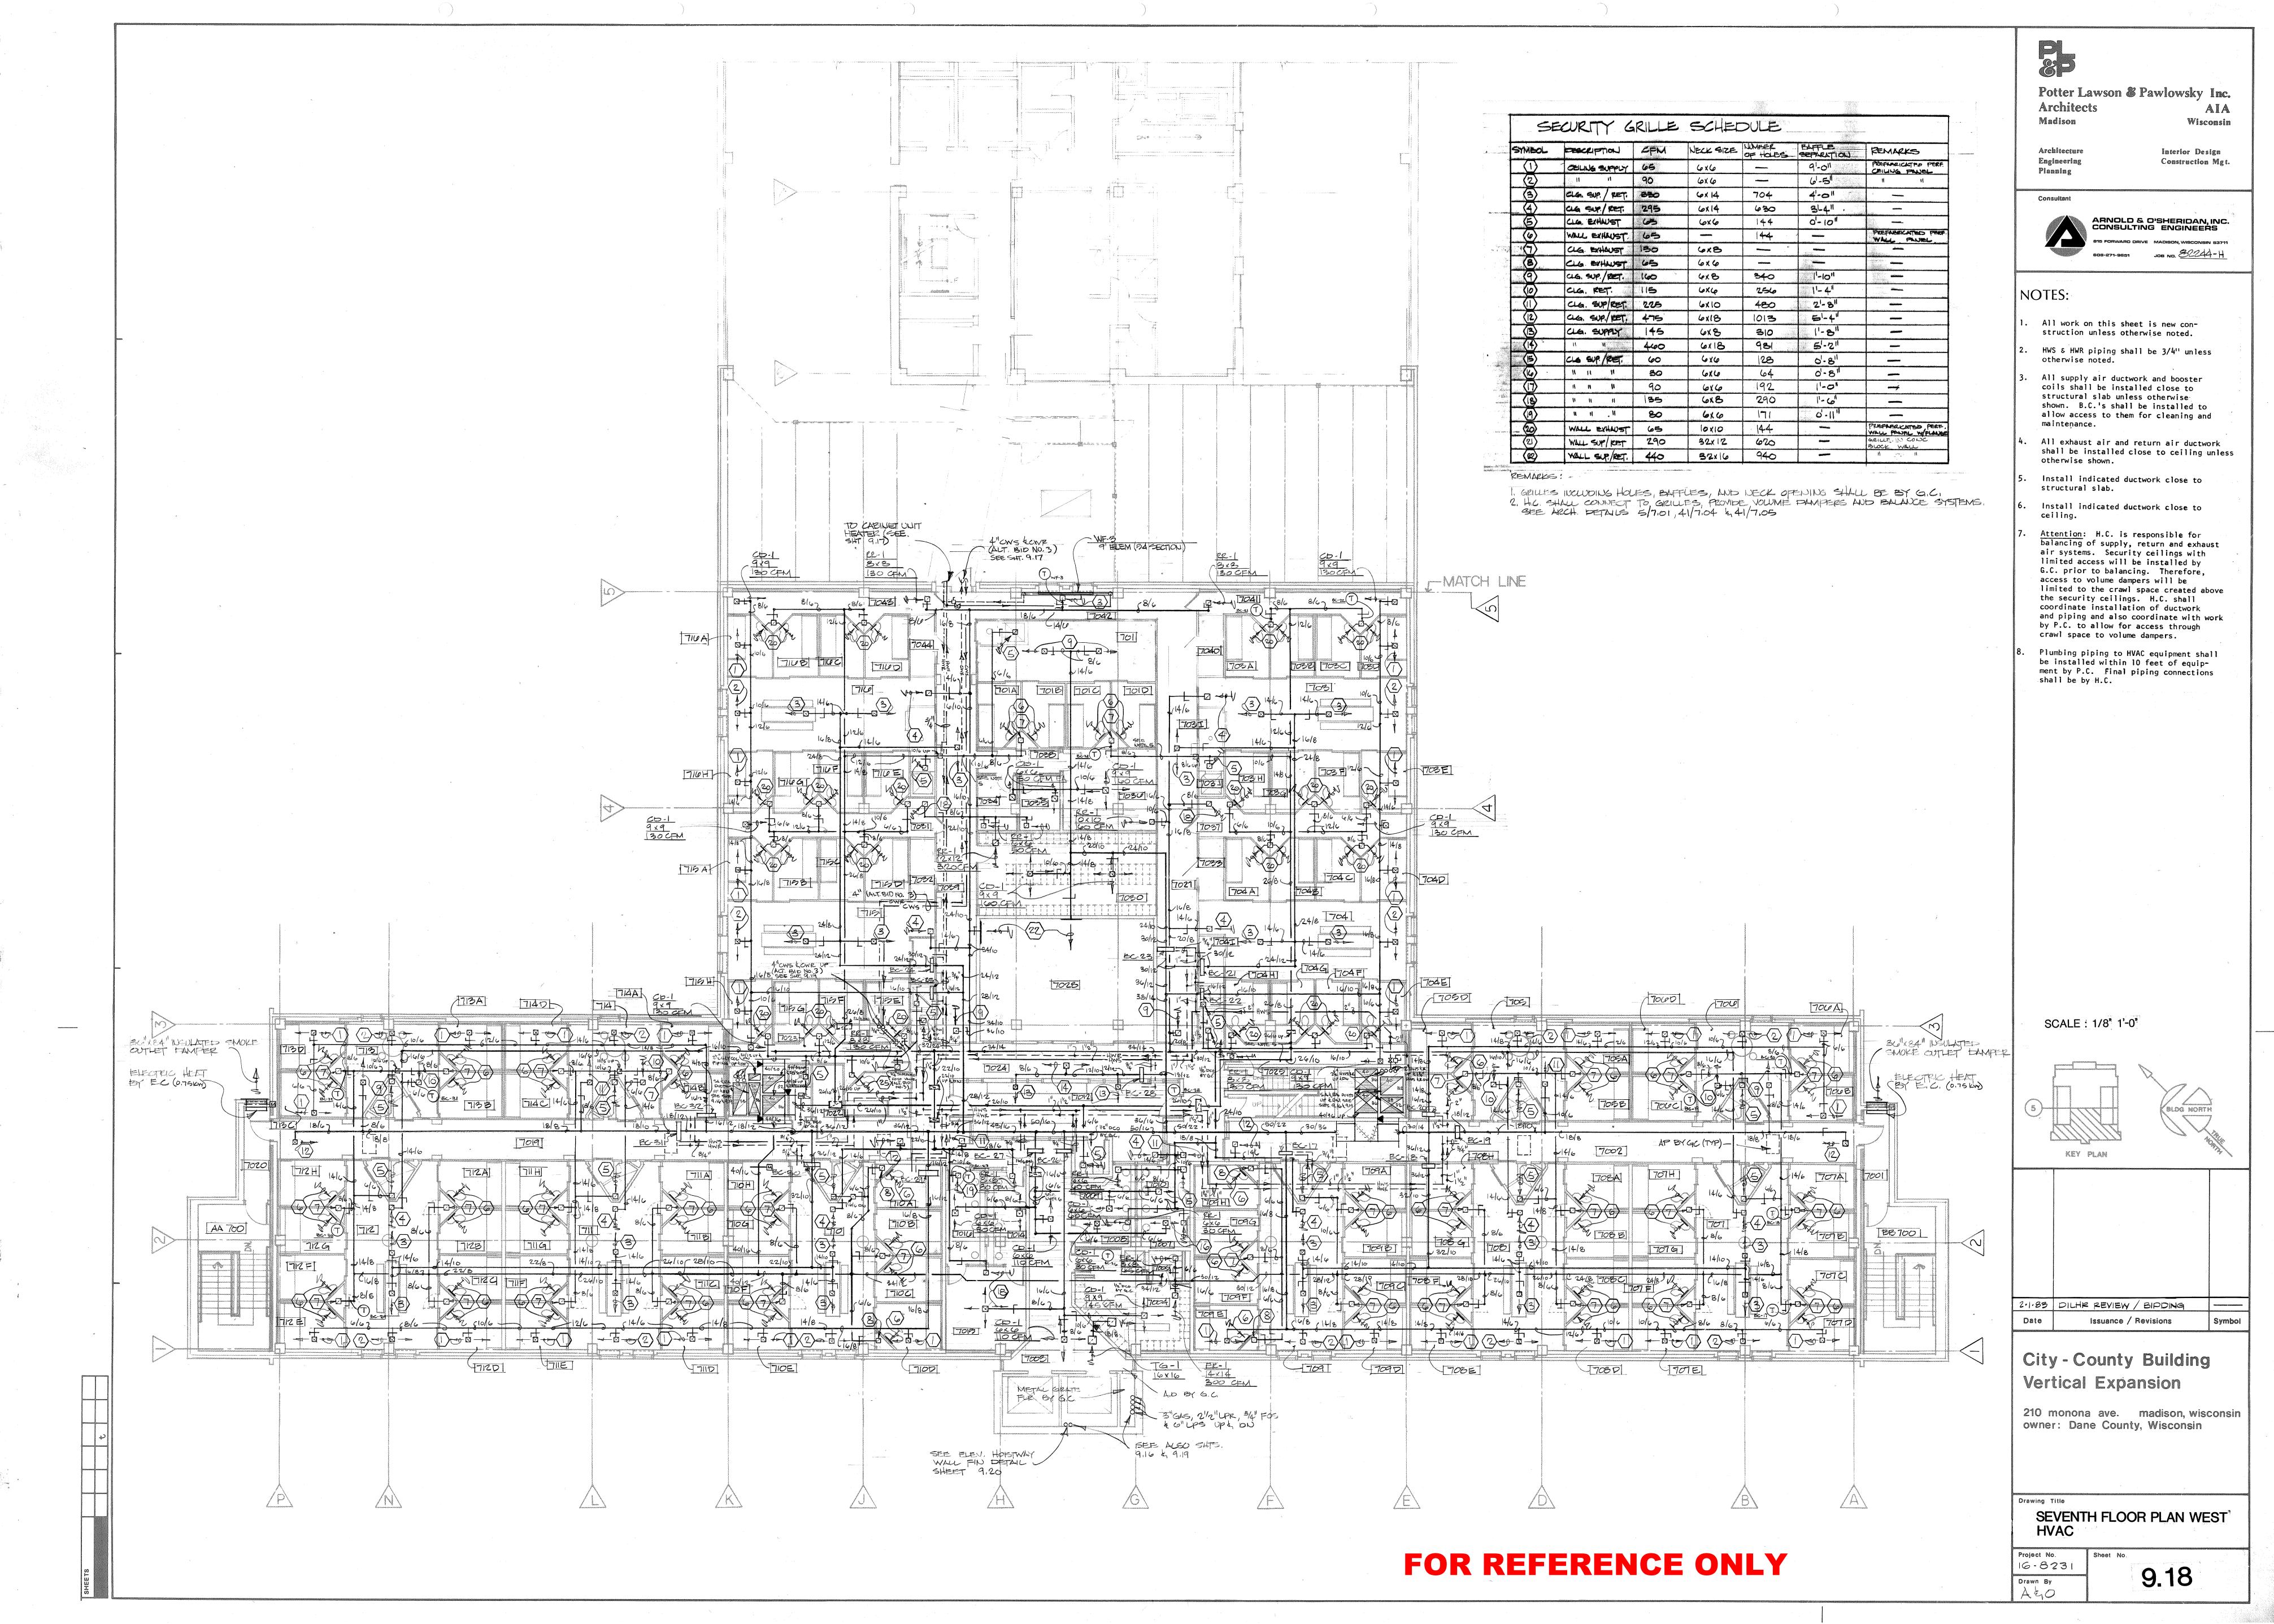

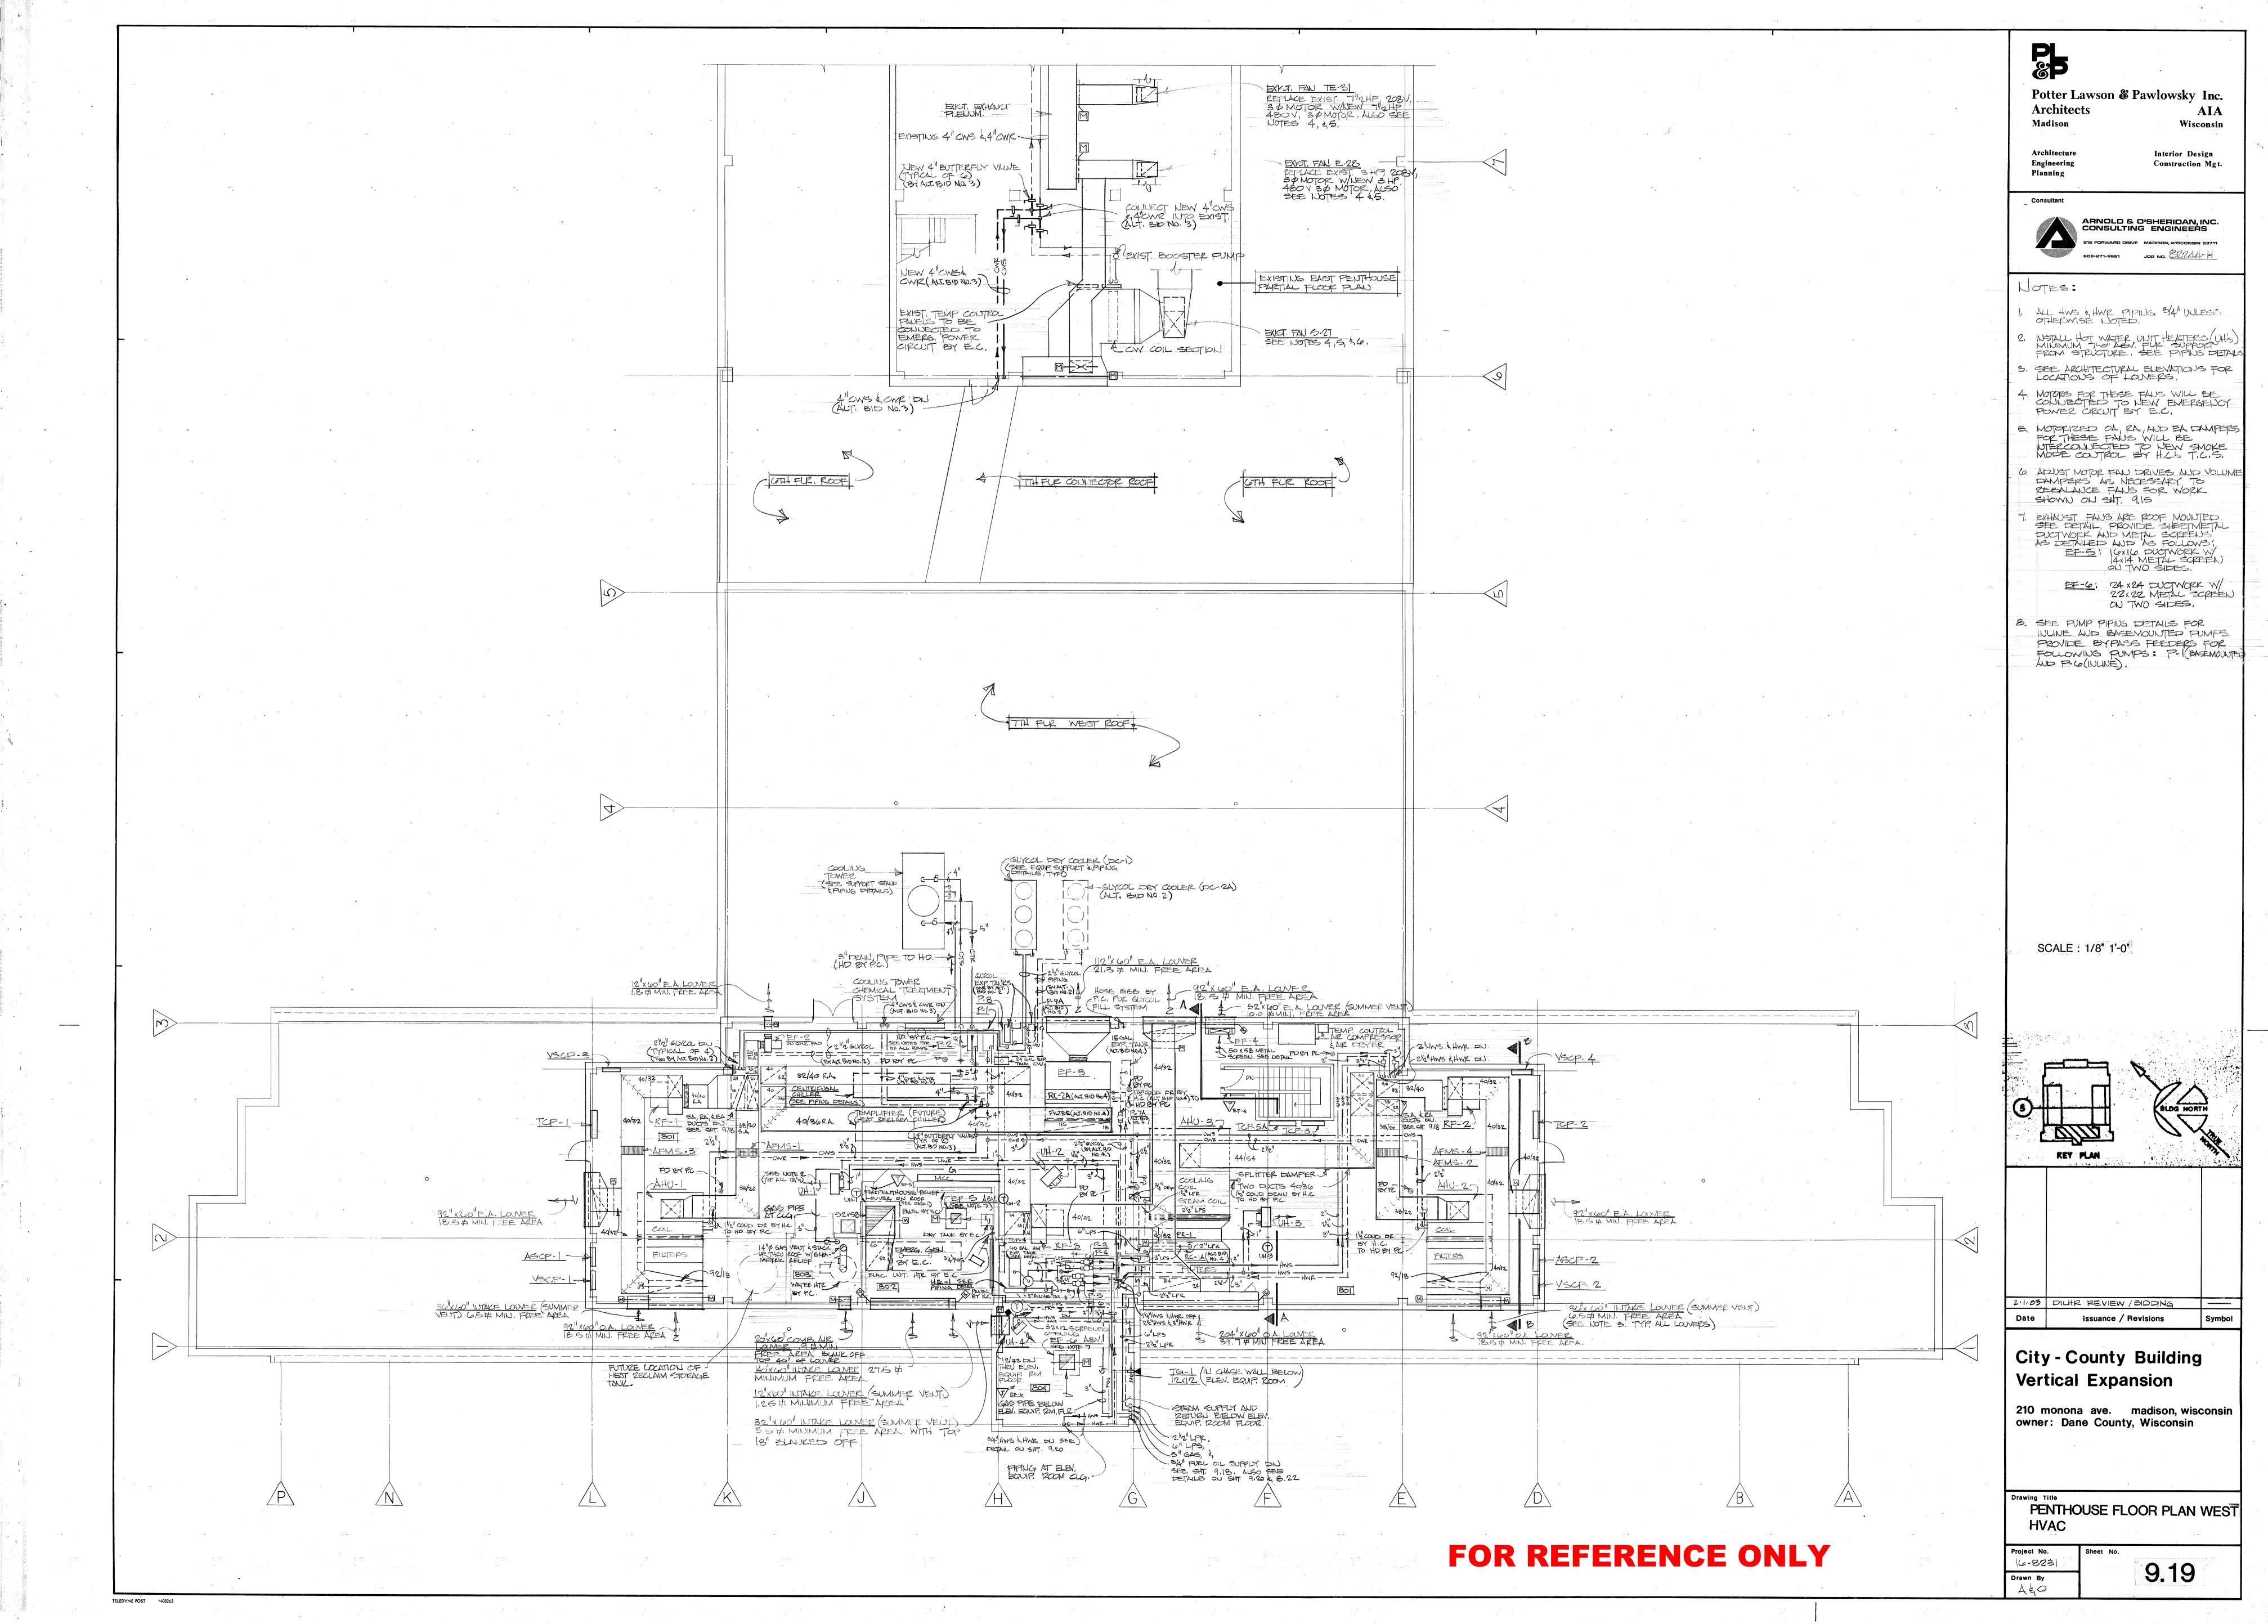

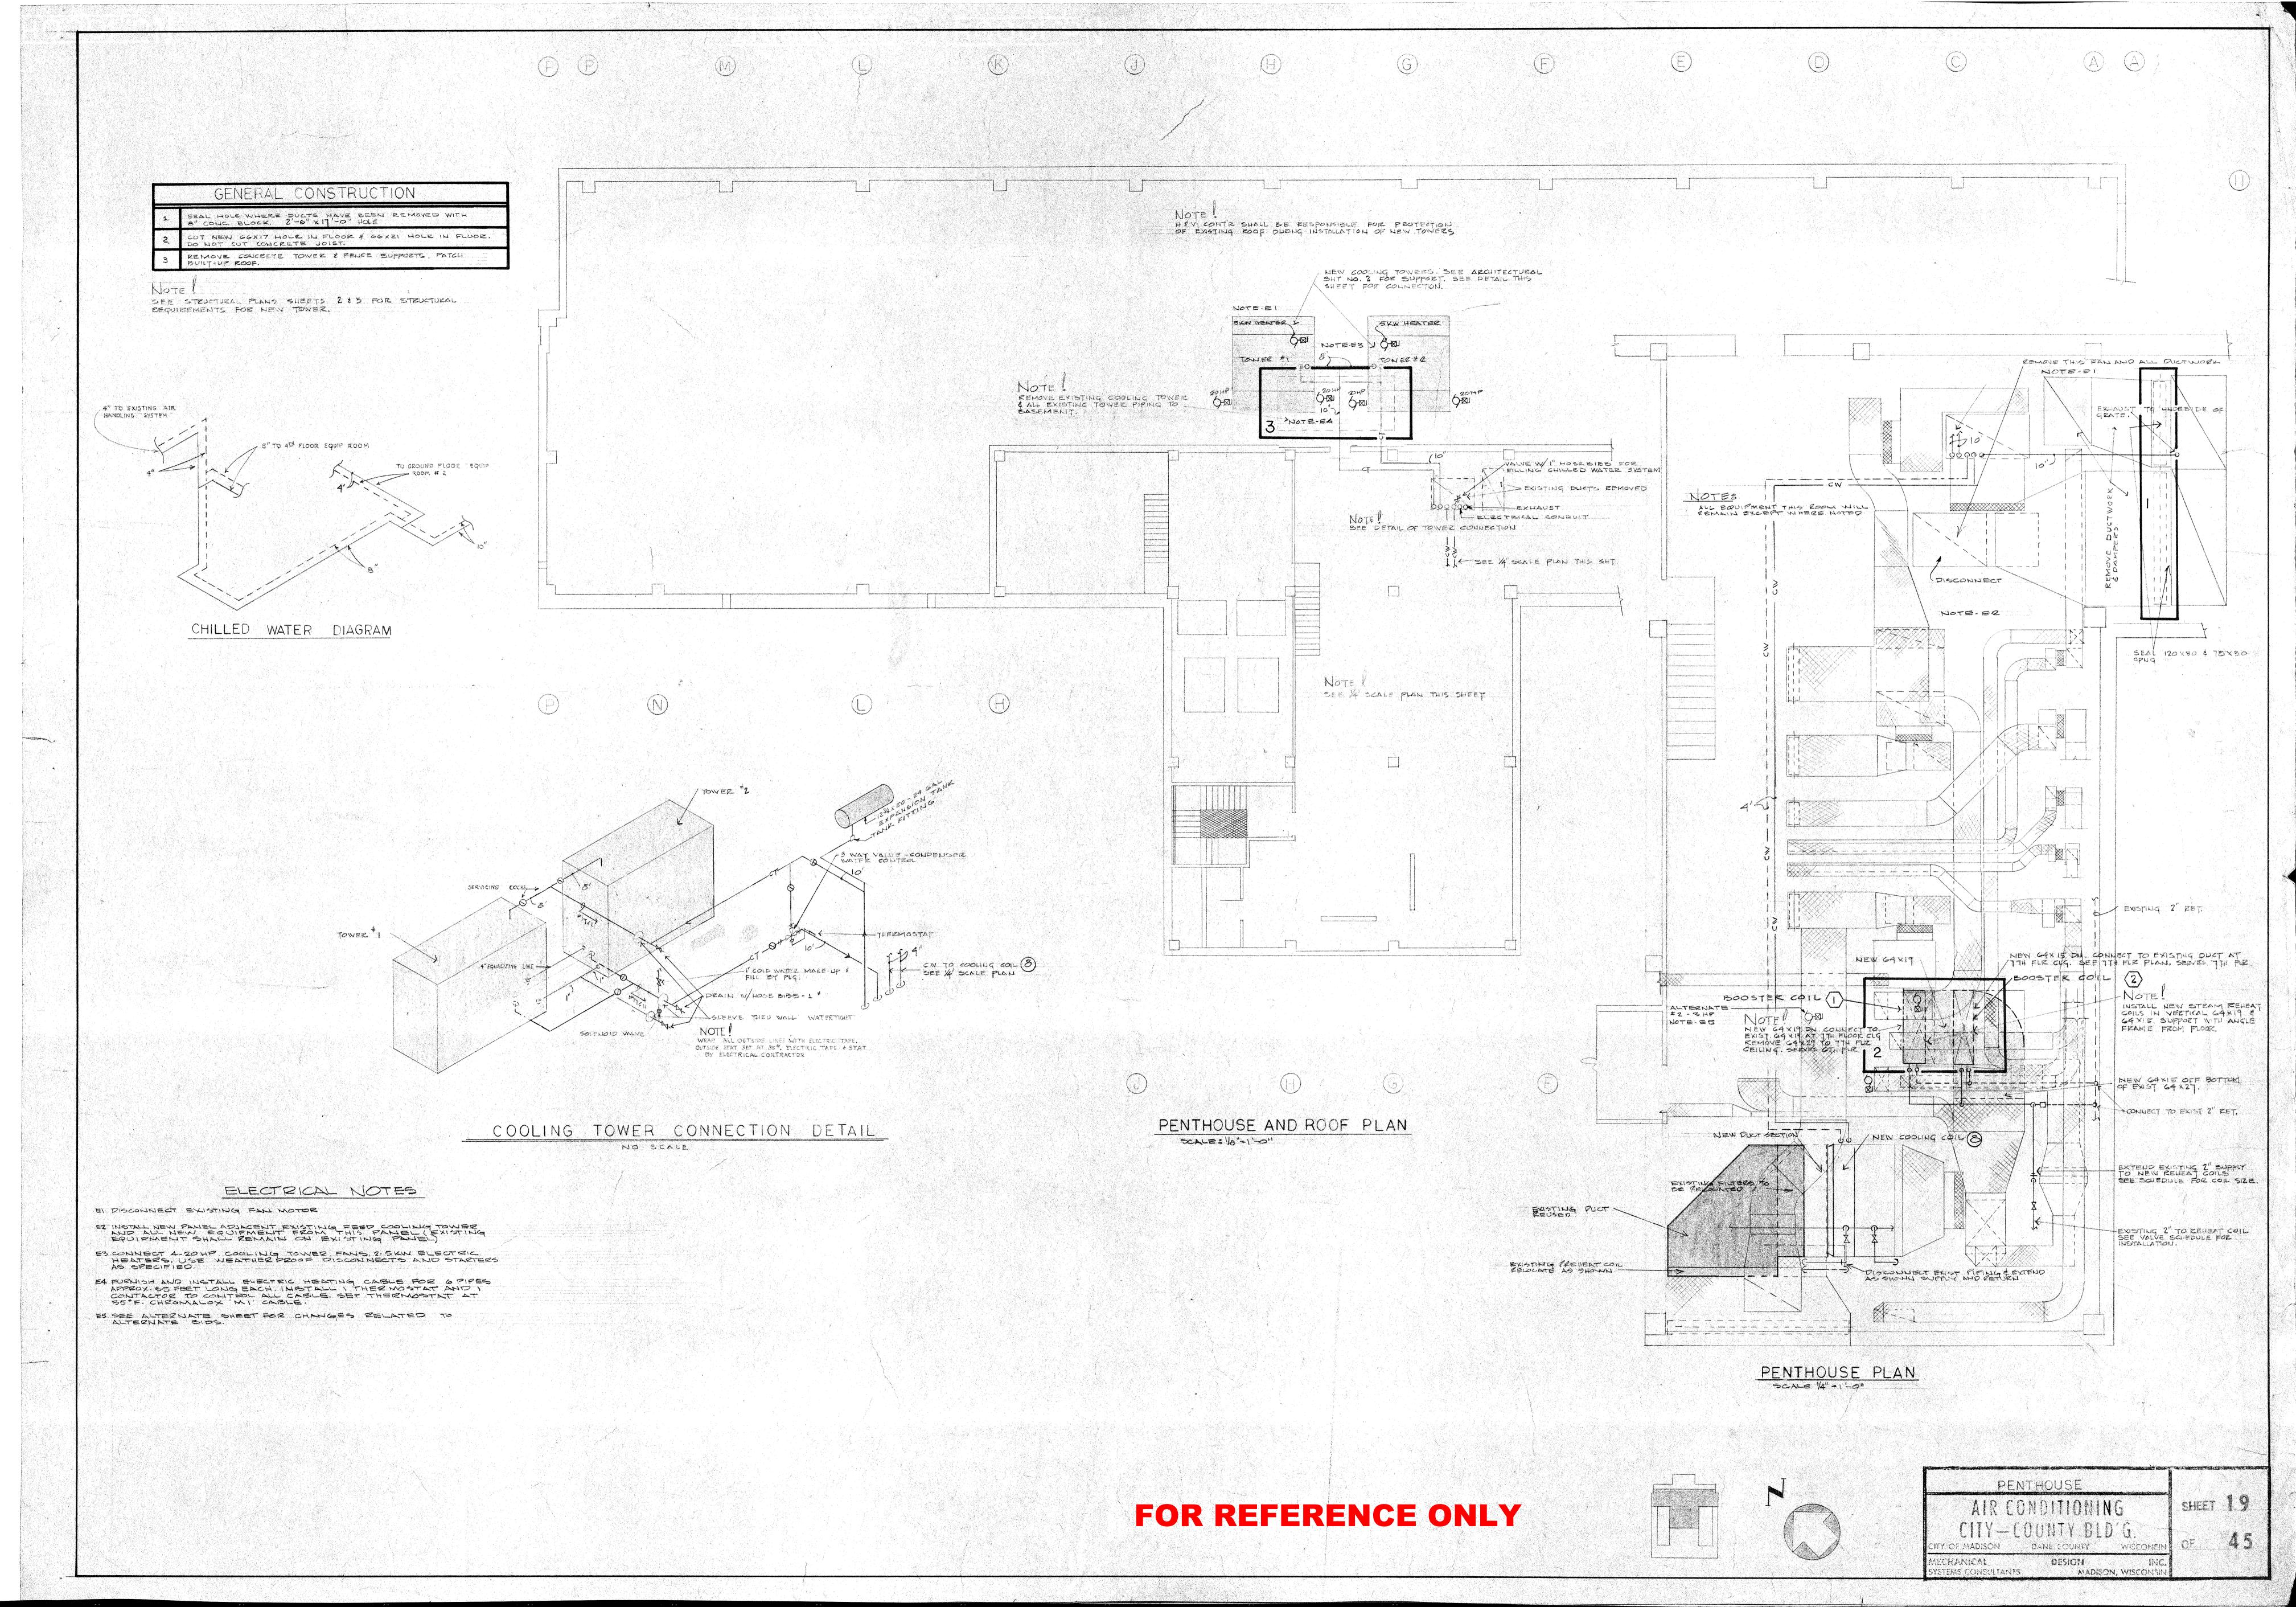



Affiliated Engineers, Inc. 625 North Segoe Road P.O. Box 5039 Madison, Wisconsin 53705-0039 Tel 608/238-2616 Fax 608/238-2614

General Notes

Plan Notes

1 VERIFY DUCT SIZES BEFORE ORDERING DAMPERS.

Revisions

Project

HVAC MODIFICATIONS
6TH AND 7TH
FLOORS CITY
COUNTY BUILDING
MADISON, WISCONSIN

Sheet Title

PARTIAL 6TH FLOOR PLAN

Date Drawn By

5/8/00 AEI


Scale

1/8" = 1'-0"


Project Number


Sheet Number

CCB-0

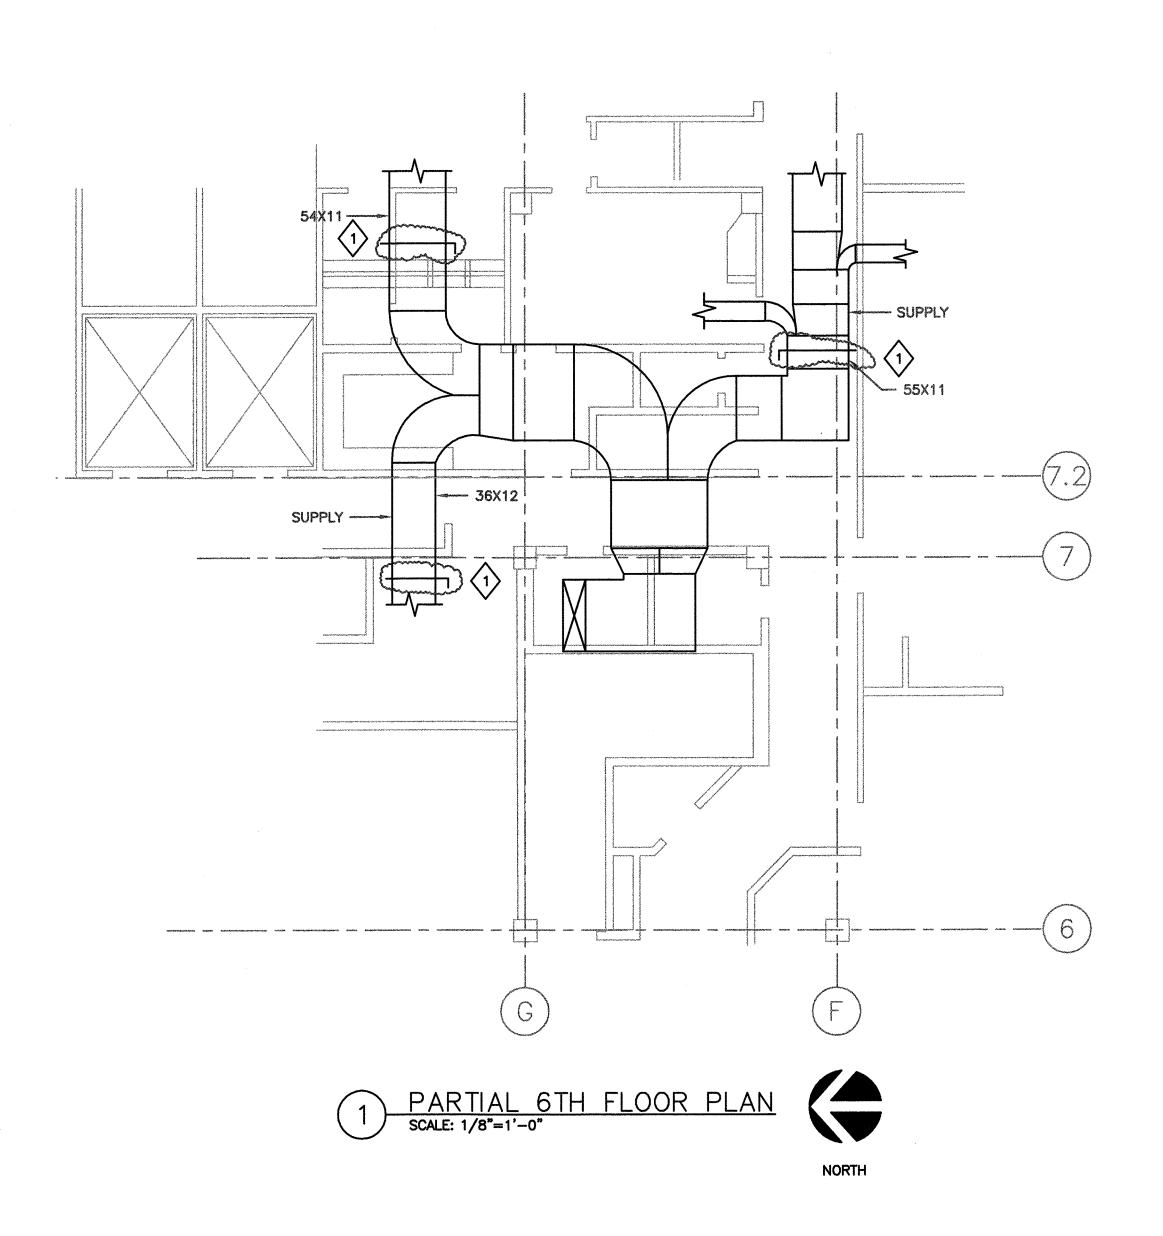

FOR REFERENCE ONLY

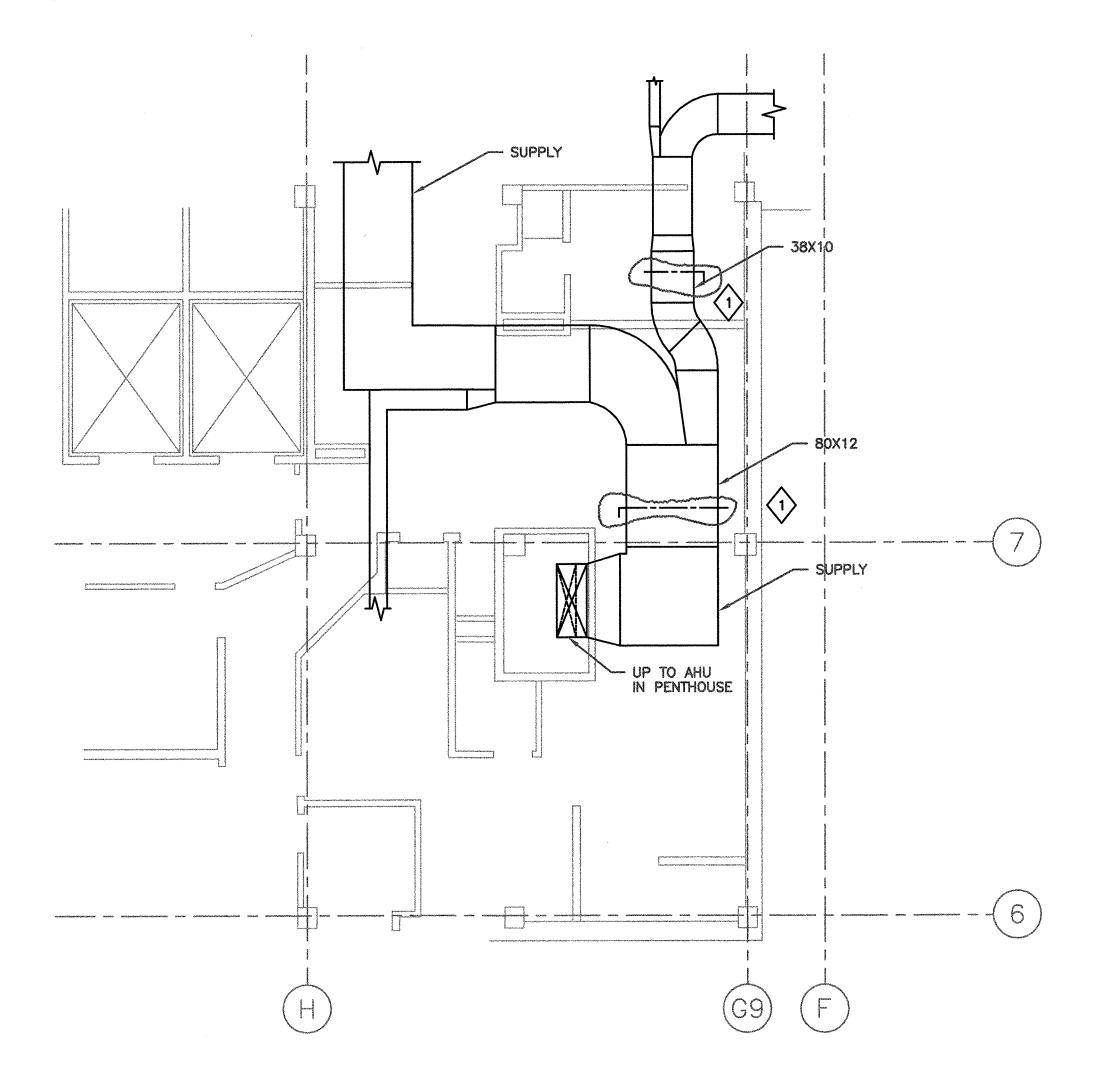

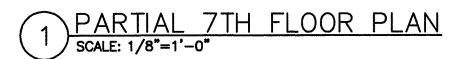



FOR REFERENCE ONLY



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General Notes

Plan Notes

VERIFY DUCT SIZES BEFORE ORDERING DAMPERS.

Revisions

Project

HVAC MODIFICATIONS
6TH AND 7TH
FLOORS CITY
COUNTY BUILDING
MADISON, WISCONSIN

Sheet Title

PARTIAL 7TH FLOOR PLAN

Date Drawn By

5/8/00 AEI

Scale


1/8" = 1'-0"

Project Number


00302-00

Sheet Number

CCB-1

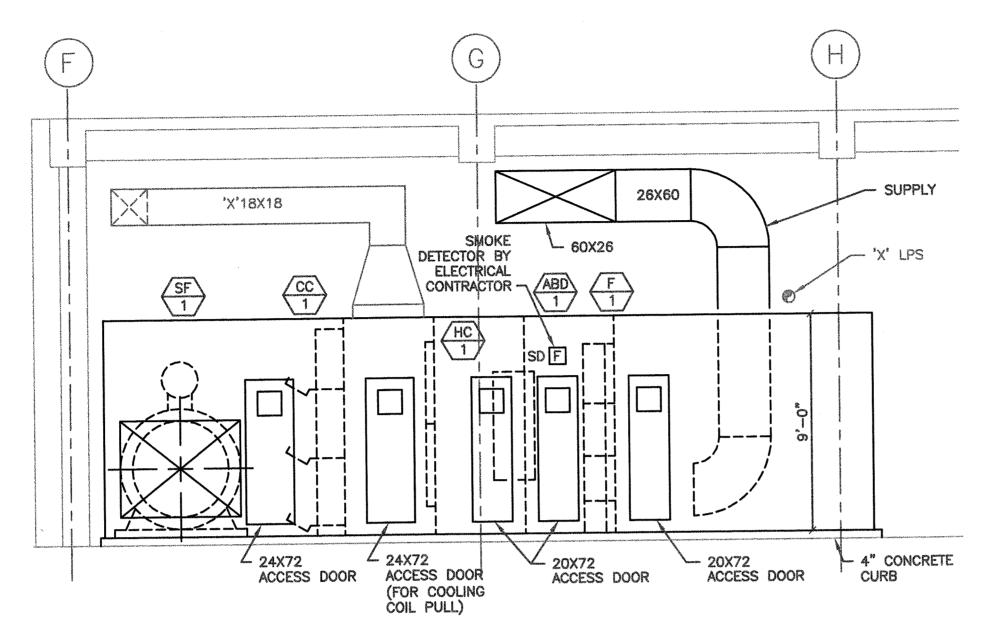



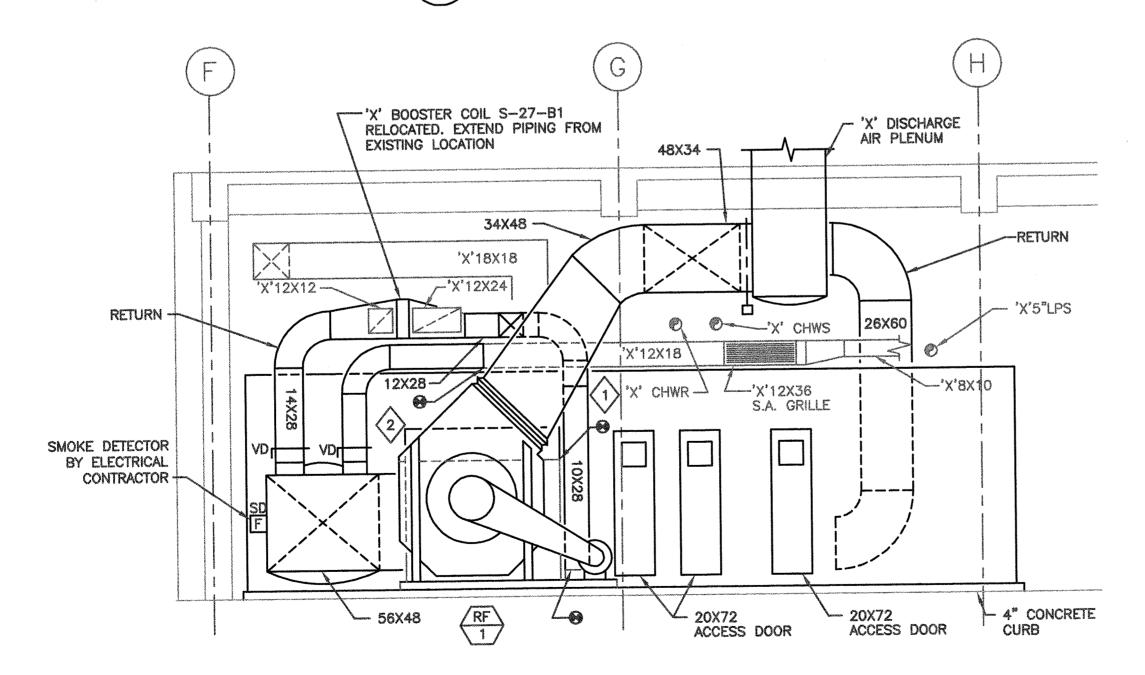

AIR HANDLING UNIT SECTION
M1-1 SCALE: 1/4"=1'-0"

AEI Affiliated Engineers

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General Notes

Plan Notes



P FLANGES AT TOP AND BOTTOM OF DUCT FOR REMOVAL TO PULL COOLING COILS

EXTEND INLET PLENUM 1'-0". RECONNECT EXISTING 10X8 DUCT.

Revisions

HVAC MODIFICATIONS 6TH AND 7TH FLOORS CITY COUNTY BUILDING MADISON, WISCONSIN

Sheet Title

PENTHOUSE SECTIONS

Drawn By 5/8/00

1/4" = 1'-0"

Project Number


00302-00

Sheet Number

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FOR REFERENCE ONLY

PLAN NORTH

Sheet Number

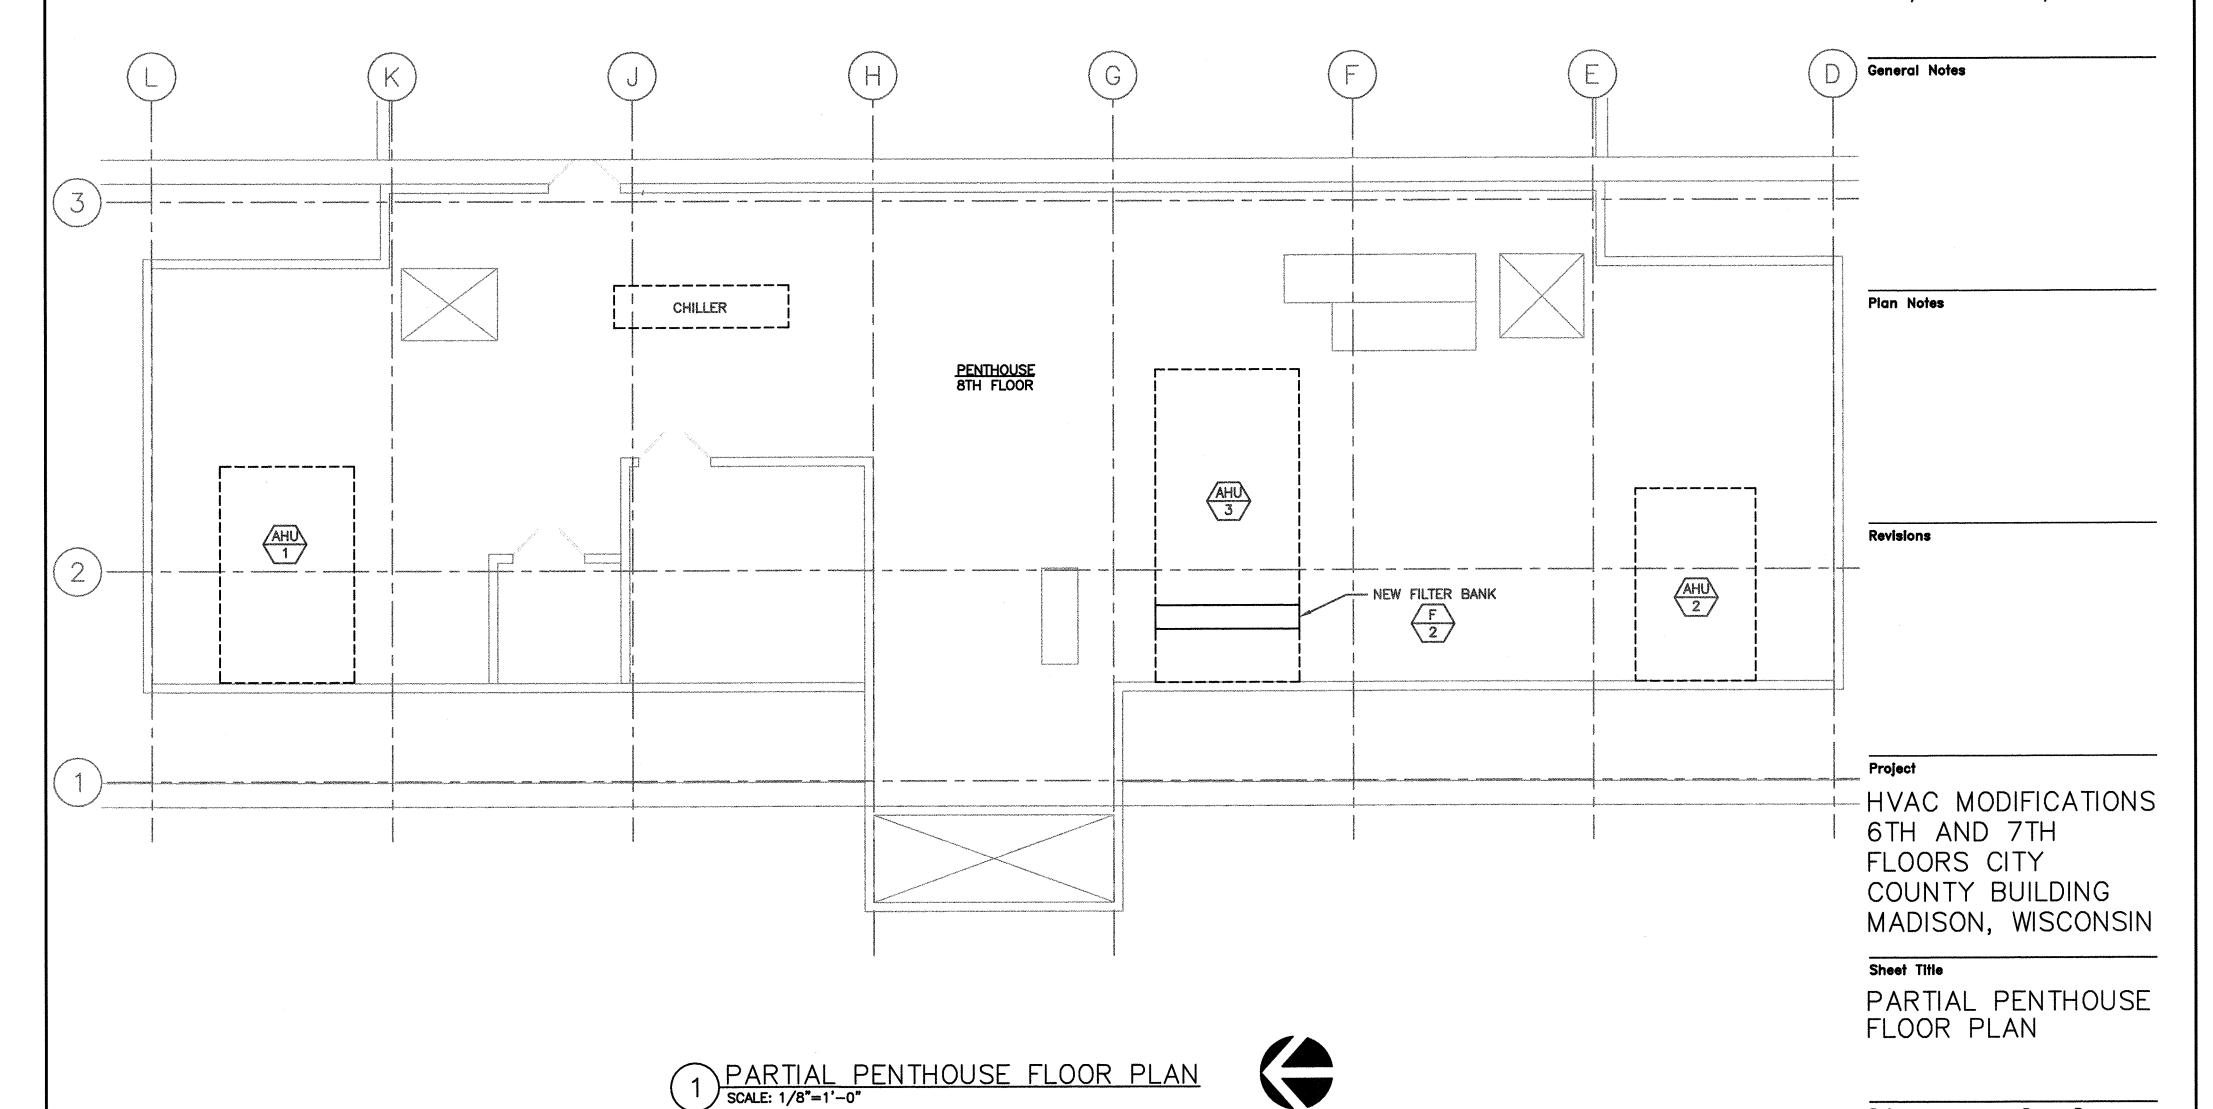Date

5/08/00

1/8' = 1'-0"

00302-00

Project Number

Scale

Drawn By

AEI

M1 - 2

VARIABLE FREQUENCY DRIVES

MARK	SYSTEM	MAX.	KVA	INPUT ELECTRIC	CAL CHARACTERIS	STICS	INTERLOCK	REMARKS
VFD	or community	HORSEPOWER	RATING	VOLT	FREQUENCY	PHASE		· .
	on Company to the Com			V- deligibles	al Community presents			
1	SF-1	75	_	460	60	3	-	ABB W/MANUAL BY-PASS
vateurossassos laines sovomessatroli excerciossocio laines (combinistes proceditos de succidente de la combina	BE 4	, ang ang an ang ang ang ang ang ang ang 	belands generalization of the received control to the control of t	460	60	one and the second and an experience of the second and the second		ABB W/MANUAL BY-PASS
	RF-1	15		400				ADD W/MANOAL DI1703
							vergeneur in our de la constitución de la constituc	
				AND		enen kanku-mannon-sauri kaminaki sigiki pemeka kani ya inja kaka dikulik eti sini kata di kaka kili kan kili ka		
				W 0	the state of the s		No. of the second secon	
						L		

AIR MIXING DEVICES

MARK	LOCATION	SERVICE	MAXIMUM			MINUMUM			OVERALL	DIMENSION	l (IN)	REMARKS
AMD			FLOW	VEL.	PD	FLOW	VEL.	PD	H_	W	L	
			RATE	(FPM)	(" WG)	RATE	(FPM)	("WG)	DIA			
			(CFM)			(CFM)			DIA.		CALVANA NAMED IN	
1	PENTHOUSE MER	MIXED AIR	35,000	1,200	0.3	21,000	750	0.1	96/48	16	132	BLENDER PRODUCTS
AND PROPERTY AND THE RESIDENCE OF THE PARTY			_		oranizacioni di socioni antico di socioni di	CANNEL CONTRACTOR AND	Participation of the Control of the	DESCRIPTION OF STATE MADE AND ARTHUR STATE OF ST			annandyseudennandeuroudennandeuroudennandeuroudennandeuro	
	Name of the state											
				ann actual de de verror production de description de service de la company de la compa		erRanceronya-yalastarian sakaranya at akina nag-amanana	***************************************	eevostavastavastavastavastestajastavat Ahtistoviataistalakkoltikoi		-	PA SLAVASSA PARKUNISKO KIVOSTAS AV PASLOVAS AV COLOR	
						and beautiful to the control of the		and the company and a decimal agreement and the company of the com			resonante programma e a antico de descripto de controlación de la descripción del descripción de la de	
				in and the second second second second								

HEATING COILS IN CENTRAL STATIONS (STEAM)

MARK	SYSTEM	NO.	TOTAL CA	∖P.	NOMINAL	SIZE		AIR SIDE				STEAM SI	DE	REMARKS
HC			MBH	CFM	FACE	DIM (IN)		MAX.	MAX.	EAT	LAT	LBS/HR		
					AREA	H	L	FACE	PD	(°F)	(°F)		(PSIG)	
					(SQ.FT)			VEL.	(*WG)					
1	AHU-1	2	1,595	35,000	18.75	30	90	950	0.35	30	72	1,650	2	TRANE TYPE N
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FOR REFERENCE ONLY

AEI Affiliated Engineers

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General	Notes

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Revisions

Project

HVAC MODIFICATIONS
6TH AND 7TH
FLOORS CITY
COUNTY BUILDING
MADISON, WISCONSIN

Sheet Title

EQUIPMENT SCHEDULES

Date	Drawn By
5/8/00	AEI
Scale	
NONE	
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00302-00	

Sheet Number

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FILTERS AND FILTER HOUSINGS

MARK F	SYSTEM	LOCATION	TYPE	CFM	MIN. FACE AREA (SQ.FT)	PRESS. DR INITIAL	OP (*WG) FINAL	PD FOR FAN TSP AND AIR BALANCE	MIN. EFF. (%)	MEDIA LENGTH (IN)	REMARKS
1	AHU-1	PENTHOUSE MER	CARTRIDGE	35,000	80	0.6	1.3	1	90	12	FARR 30/30 PREFILTER
2	AHU-3 EXISTING	PENTHOUSE MER VERTICAL EXPANSION	PLEATED	31,750	72	0.25	0.9	0.6	30	2	FARR 30/30 (18) 24X24*
nath-russnamaeathrosponnoicesholl Artist (hebre 2010) an										envoluntensi oligi että deisat ja vastatatainista tuli ili etti oni vittimi	
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^{*} REMOVE EXISTING FILTER FRAME. INSTALL NEW FRAME FOR NEW FILTERS.

SUPPLY, RETURN, AND EXHAUST FANS

MARK SF/RF/EF	LOCATION	SERVICE	CFM	SP ("WG)	FAN TYPE	DRIVE	WHEEL	TYPE MIN. DIA.	MAXIMUM RPM	FAN CLASS	FAN ARRANGEMENT
SF-1	PENTHOUSE MER	6TH AND 7TH	35,000	7 1/2	VANE AXIAL	BELT		43	1800		9
RF-1	PENTHOUSE MER	6TH AND 7TH	23,070	2 1/2	CENTRIFUGAL	BELT	AF	44	700		3
									Colon hald to the foreign group to a food over send on the state of th		
			oorlanderme dustrious en green 1900 en spiert Sonnech van en green fil jure over skele in his die die die die d				STATE OF THE STATE				
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SUPPLY, RETURN, AND EXHAUST FANS

MARK	FAN	FAN	DAMPER	INTERLOCK	MOTOR				REMARKS			
SF/RF/EF	MOTOR LOCATION	DISCHARGE AND ROTATION			HP	PH	VOLT	VFD				
SF-1			NO		75	3	460	YES	BUFFALO TYPE S ADJUSTAX 43D9 W/ INLET SCREEN			
RF-1	W	TAU/CW	NO	SF-1	15	3	460	YES	GREENHECK 44AFSW, FURNISH W/SPLIT SCROLL HOUSING			
			en de de manuel (1994 de 1994				C					
Anne Mille, blandage ende de Kordigorgi ongley i Perdik at a gane galabab bilan kitarat ingke ar Perdik Sanna			ecentalista (Corcus pro y prima de prima establica com qui incule en de missilia posso a della della colo colo della contra della colo colo colo colo colo colo colo c									

COOLING COILS IN CENTRAL STATIONS

MARK	SYSTEM	NO.	TOTAL	CAP.	NOMINA	L SIZE		AIR SII	DE					WATER	SIDE		REMARKS
CC	tilinipaaa		MBH	CFM	FACE	DIM (IN)	MAX.	MAX.	EAT (1	5)	LAT (°F	•)	GPM	MAX.	EWT	
	0.000				AREA	Н	L	FACE	PD	DB	WB	DB	WB	and Colored	PD	(°F)	
					(SQ.FT)			VEL.	("WG)						(FT)		
1	AHU-1	3		35,000	25	30	120	470	0.6	77.5	65.5	52	51.7	288	10	45	8 ROW/WD/PE/94
ne des constitutes de la constitute de l		44-16-19-19-19-19-19-19-19-19-19-19-19-19-19-	yencewanianananunin-1-4-14-14-to-14-	Service and the service of the servi			**************************************				1000000 100000000000000000000000000000					***************************************	•
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FOR REFERENCE ONLY

AEI	Affiliated
	Engineer

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Project

HVAC MODIFICATIONS
6TH AND 7TH
FLOORS CITY
COUNTY BUILDING
MADISON, WISCONSIN


Sheet Title

EQUIPMENT SCHEDULES

Date	Drawn By
5/8/00	AEI
Scale	
NONE	
Project Number	
00302-00	

Sheet Number


M2 - 1

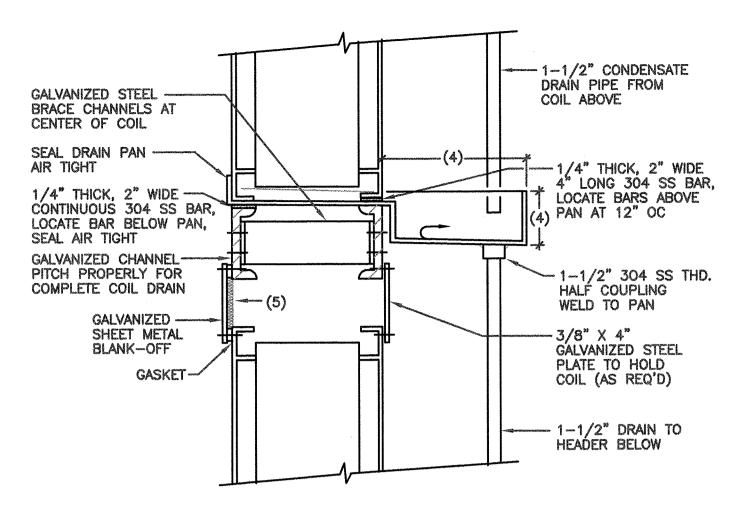

NOTES:


- (1) CONDENSATE DRAIN PAN TO BE 16 GAUGE STAINLESS STEEL ALL WELDED CONSTRUCTION.
- (2) PAN LENGTH TO BE SUFFICIENT TO COVER COIL TUBE BENDS AND UNIONS.
- (3) CONDENSATE DRAIN PIPE TO BE SCH. 40, 304 SS PIPE BOTTOM DRAIN PAN TO NEAREST HD WITH TRAP. LOCATE TRAP OUTSIDE HOUSING.
- (4) DRAIN PAN TO EXTEND NO MORE THAN 12" DOWNSTREAM OF COIL FACE WITH MINIMUM DEPTH OF 2".
- (5) 3/4" INSULATION SIMILAR TO ARMAFLEX II. PROVIDE INSULATION FOR ALL BLANK-OFF.

3 COOLING COIL SUPPORT

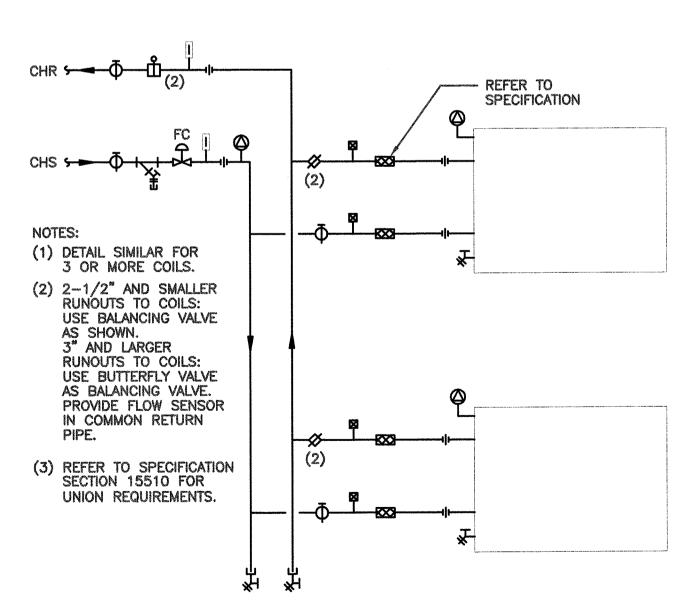


4 CHILLED WATER COOLING COIL PIPING (MULTIPLE COILS)

FOR REFERENCE ONLY

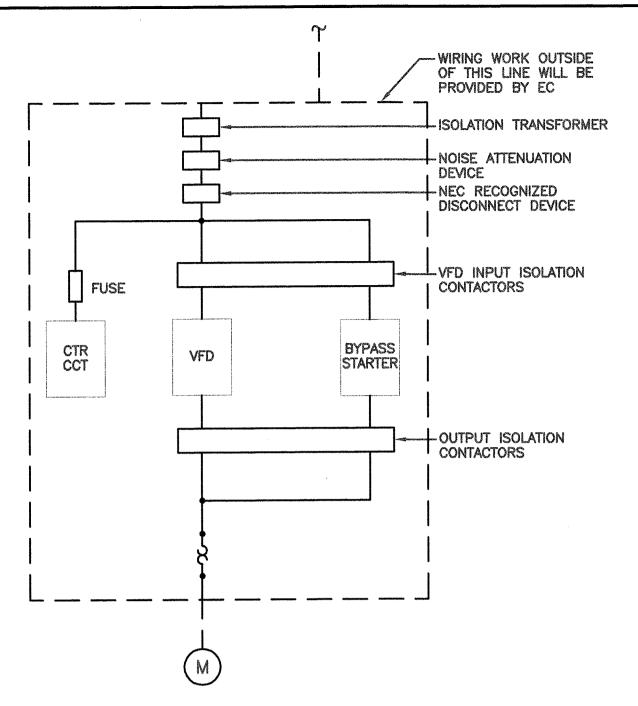

1)VFD SYSTEM WIRING BLOCK DIAGRAM
SCALE: NONE

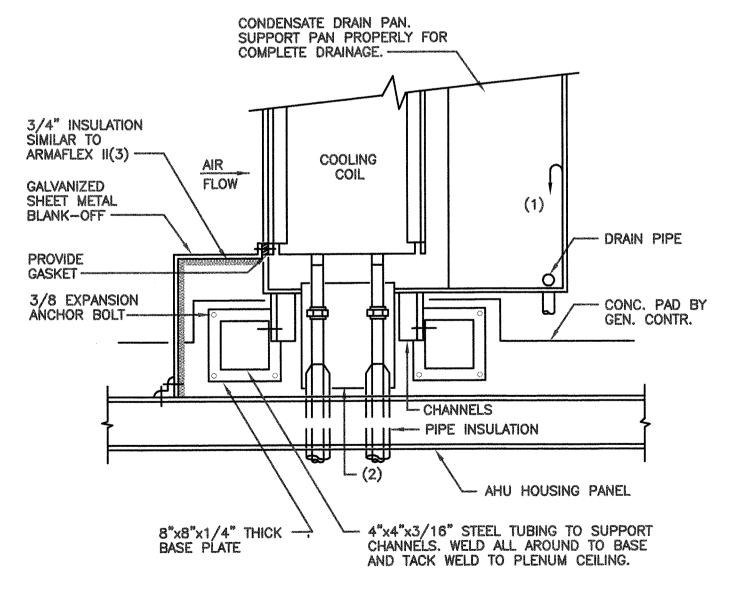

NOTES:

- (1) PITCH CONDENSATE PAN TOWARD DRAIN CONNECTION WITH MINIMUM PITCH OF 1/4" PER FOOT.
- (2) PROVIDE DRAIN PAN UNDER NON-INSULATED PIPING BETWEEN COIL AND HOUSING WALL.
- (3) PROVIDE INSULATION FOR ALL BLANK-OFF.

2 COOLING COIL SUPPORT SCALE: NONE



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General Notes

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Sheet Title

DETAILS

Date Drawn By

5/8/00 AEI

Scale

NONE

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M3-0

