

CONSTRUCTION DOCUMENTS PROJECT MANUAL

DANE COUNTY DEPARTMENT OF WASTE & RENEWABLES

1919 ALLIANT ENERGY CENTER WAY MADISON, WISCONSIN 53713

REQUEST FOR BIDS NO. 320027 CLEAN SWEEP BOILER DANE COUNTY LANDFILL SITE NO. 2 7102 US HIGHWAY 12 & 18 MADISON, WISCONSIN

Due Date / Time: TUESDAY, FEBRUARY 16, 2021 / 2:00 P.M. Location: WASTE & RENEWABLES OFFICE

Performance / Payment Bond: 100% OF CONTRACT AMOUNT Bid Deposit: 5% OF BID AMOUNT

FOR INFORMATION ON THIS REQUEST FOR BIDS, PLEASE CONTACT:

ROBERT REGAN, PROJECT MANAGER
TELEPHONE NO.: 608/516-3159
FAX NO.: 608/267-1533
E-MAIL: REGAN@COUNTYOFDANE.COM

SECTION 00 01 10

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DRAWINGS

Select drawings from the construction of the Clean Sweep (Household Hazardous Waste) Facility are included for reference purposes only. Plot drawings on 34" x 44" (ANSI E), paper for correct scale or size.

END OF SECTION

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LEGAL NOTICE

INVITATION TO BID

Dane County Dept. of Waste & Renewables, 1919 Alliant Energy Center Way, Madison, WI 53713, will receive sealed Bids until:

2:00 P.M., TUESDAY, FEBRUARY 16, 2021

RFB NO. 320027

CLEAN SWEEP BOILER

DANE COUNTY LANDFILL SITE NO. 2

7102 U.S. HIGHWAY 12 & 18

MADISON, WI

Dane County is inviting Bids for construction services for the purchase and installation of a new natural gas boiler system in the Clean Sweep building at Dane County Landfill Site No. 2. Only firms with capabilities, experience & expertise with similar projects should obtain this Request for Bids (RFB) document & submit Bids

RFB document may be obtained after **2:00 p.m. on January 19, 2021** by downloading it from bids-pwht.countyofdane.com. Please call Robert Regan, Project Manager, at 608/516-3159, or our office at 608/266-4018, for any questions or additional information.

All Bidders must be qualified as a Best Value Contractor before Bid Due Date / Time. Complete Pre-qualification Application for Contractors at <u>publicworks.countyofdane.com/bvc</u> or obtain one by calling 608/267-0119.

A pre-bid tour will be held February 2, 2021 at 10:00 a.m. at the Clean Sweep Building starting near the material drop off area. Bidders are strongly encouraged to attend this tour.

PUBLISH: JANUARY 19 & JANUARY 26, 2021 - WISCONSIN STATE JOURNAL JANUARY 20 & JANUARY 27, 2021 - THE DAILY REPORTER

END OF SECTION

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INSTRUCTIONS TO BIDDERS

Clean Sweep Boiler
DANE COUNTY LANDFILL SITE NO. 2
7102 U.S. HIGHWAY 12 & 18
MADISON, WI

1. SECURING DOCUMENTS

- A. Construction Documents may be obtained at bids-pwht.countyofdane.com.
- B. Bidder is responsible to check above website regularly for Addenda.

2. BID REQUIREMENTS

- A. Bidder shall submit lump sum bid for providing all expertise, labor, equipment, tools and materials necessary to perform all Work described in Construction Documents. Only firms with capabilities, experience and expertise with similar projects should submit Bids.
- B. Envelope containing Bid shall be clearly marked as for this project (note title at top of page). Bids shall be delivered to:

Dane County Department of Waste & Renewables 1919 Alliant Energy Center Way Madison, Wisconsin 53713

- C. One (1) Bid Form shall be submitted with your Bid. Bid Form is provided with Construction Documents; no other form or letter shall be accepted.
- D. Wisconsin Statute 77.54 (9m) allows building materials that become part of local unit government facilities to be exempt from sales & use tax. Vendors & materials suppliers may not charge Bidders sales & use tax on these purchases. This does not include highways, streets or roads.
- E. Bidders shall not add any conditions, escalator clauses of qualifying statements to Bid Form.
- F. Erasures or other changes to Bid must be explained or noted, and shall be accompanied by initials of bidder.
- G. Legally authorized official of bidder's organization shall sign Bids.
- H. Bidder's organization shall submit completed Fair Labor Practices Certification Form, included in these Construction Documents.
- I. Bid Bond shall be made payable to Dane County in amount of five percent (5%) of bid amount. Bid Bond shall be either certified check or bid bond issued by surety licensed to conduct business in the State of Wisconsin. Successful bidder's Bid Bond shall be retained until Contract is signed and required Performance / Payment Bond is submitted. Bids shall be binding on bidder for sixty (60) calendar days after Bid Due Date. Bid Bond must be submitted with Bid.
- J. Successful bidder shall furnish and pay for Performance / Payment Bond as called for in Conditions of Contract.

RFB No. 320027 Instructions to Bidders rev. 10/19 00 21 13 - 1

3. INQUIRIES

A. Written inquiries regarding intent of Construction Documents should be directed to:

Robert Regan, Waste & Renewables Project Manager Dane County Department of Waste & Renewables 1919 Alliant Energy Center Way, Madison, Wisconsin 53713 Email: Regan@countyofdane.com

- B. Bidders shall bring questions, discrepancies, omissions, conflicts or doubt as to meaning of any part of Construction Documents to attention of Department of Waste & Renewables at least ten (10) business days before due date for Bids. Prompt clarification of intent of Construction Documents shall be made available to bidders in form of Addendum. Bidder shall acknowledge all Addenda on Bid Form.
- C. Failure to request clarification of interpretation of Construction Documents shall not relieve bidders of their responsibilities to perform Work.

4. EXAMINATION OF SITE

- A. Coordinate site access activities with Robert Regan, Project Manager, 608/516-3159, regan@countyofdane.com.
- B. A bidders facility tour will be held on February 2, 2021 at 10:00 a.m. at the Clean Sweep Builing, 7102 Hwys 12&18, Madison, starting near the material drop off area. This tour will go until approximately 11:00 a.m. Bidders are strongly encouraged to attend this tour, however attendance is optional.

5. ALTERNATES

A. Not used.

6. WITHDRAWAL OF BIDS

A. Any bidder may withdraw their Bid any time prior to Bid Due Date. Withdrawn Bids shall be returned unopened.

7. BID DUE DATE

A. See Legal Notice (advertisement).

8. COMMENCEMENT AND COMPLETION OF WORK

- A. Notice to Proceed is expected to be issued on March 22, 2021. Work shall commence by as soon as practicle after issuance of Notice to Proceed.
- B. Work shall be completed within 3-months of issuance of Notice to Proceed.

9. RESERVATION

A. Dane County reserves the right to reject any or all Bids, to waive any informalities in the Bid, and to accept any Bid which shall be in the best interest of Dane County.

RFB No. 320027 Instructions to Bidders rev. 10/19 00 21 13 - 2

Name of Bidding Firm:	
Name of Bidding Firm:	

SECTION 00 41 13

BID FORM

BID NO. 320027

PROJECT: CLEAN SWEEP BOILER

DANE COUNTY LANDFILL SITE NO. 2

TO: DANE COUNTY DEPARTMENT OF WASTE & RENEWABLES

ROBERT REGAN, PROJECT MANAGER 1919 ALLIANT ENERGY CENTER WAY

MADISON, WISCONSIN 53713

NOTE: WISCONSIN STATUTE 77.54 (9M) ALLOWS FOR NO SALES & USE TAX ON THE PURCHASE OF MATERIALS FOR COUNTY PUBLIC WORKS PROJECTS.

BASE BID - LUMP SUM:

Dane County is inviting Bids for construction services for the purchase and installation of a new natural gas boiler system in the Clean Sweep building at Dane County Landfill Site No. 2. The undersigned, having examined the site where the Work is to be executed and having become familiar with local conditions affecting the cost of the Work and having carefully examined the Drawings and Specifications, all other Construction Documents and Addenda thereto prepared by Dane County Department of Waste & Renewables hereby agrees to provide all expertise, labor, materials, equipment and services necessary for the complete and satisfactory execution of the entire Work, as specified in the Construction Documents, for the Base Bid stipulated sum of:

	and /100 Dollar
Written Price	
\$	
Numeric Price	
Receipt of the following addenda and inclus acknowledged:	sion of their provisions in this Bid is hereby
Addendum No(s) the	rough
Dated	
· ·	newables must have this project completed by July 2, y March 22, 2021, what dates can you commence and
Commencement Date:	Completion Date:(final, not substantial)

Bid No. 320027 rev. 06/2020 Bid Form

I hereby certify that all statements herein are made on behalf of:
(Name of Corporation, Partnership or Person submitting Bid)
Select one of the following: 1. A corporation organized and existing under the laws of the State of, or
2. A partnership consisting of, or
3. A person conducting business as;
Of the City, Village, or Town of of the State of
I have examined and carefully prepared this Bid from the associated Construction Documents and have checked the same in detail before submitting this Bid; that I have full authority to make such statements and submit this Bid in (its) (their) (my) behalf; and that the said statements are true and correct. In signing this Bid, we also certify that we have not, either directly or indirectly, entered into any agreement or participated in any collusion or otherwise taken any action in restraint of free competition; that no attempt has been made to induce any other person or firm to submit or not to submit a Bid; that this Bid has been independently arrived at without collusion with any other bidder, competitor, or potential competitor; that this Bid has not been knowingly disclosed prior to the Bids Due Date to another bidder or competitor; that the above statement is accurate under penalty of perjury.
The undersigned is qualified as a Best Value Contractor or has proven their exemption. Qualification or exemption shall be complete before Bid Due Date / Time.
The undersigned further agrees to honor the Base Bid for sixty (60) calendar days from date of Award of Contract.
SIGNATURE: (Bid is invalid without signature)
Print Name: Date:
Title:
Address:
Telephone No.: Fax No.:

END OF SECTION

Email Address:

Contact Person:

RFB No. 32XXXX Bid Form rev. 06/2020 00 41 13 - 2

THIS PAGE IS FOR BIDDERS' REFERENCE **DO NOT SUBMIT WITH BID FORM.**

BID CHECK LIST:		
These items must be include	led with Bid:	
☐ Bid Form	☐ Bid Bond	☐ Fair Labor Practices Certification

DANE COUNTY BEST VALUE CONTRACTING QUALIFICATION

General Contractors & all Subcontractors must be qualified as a Best Value Contractor with the Dane County Public Works Engineering Division. Qualification & listing is not permanent & must be renewed every 24 months. Complete a *Best Value Contracting Application* online at:

pwht.countyofdane.com/bvc_application.aspx

DANE COUNTY VENDOR REGISTRATION PROGRAM

All bidders are strongly encouraged to be a registered vendor with Dane County. Registering allows vendors an opportunity to receive notifications for RFBs & RFPs issued by the County and provides the County with up-to-date company contact information. Complete a new form or renewal online at:

danepurchasing.com/Account/Login?

RFB No. 32XXXX Bid Form rev. 06/2020 00 41 13 - 3

COUNTY OF DANE

WASTE & RENEWABLES CONSTRUCTION CONTRACT

Contract No.	Bid No. <u>320027</u>
Authority: 2020 RES	
both parties have affixed th	and entered into as of the date by which authorized representatives of eir signatures, by and between the County of Dane (hereafter referred (hereafter, "CONTRACTOR"),
	WITNESSETH:
Energy Center Way, Madis	hose address is c/o Waste & Renewables Director, 1919 Alliant on, WI 53713, desires to have CONTRACTOR provide Clean Sweep dfill Site No. 2 ("the Project"); and
WHEREAS, CONTRACT	OR, whose address is
in accordance with the Sco	OR, whose address is is able and willing to construct the Project, be of Work document and site meeting;
parties hereinafter set forth	consideration of the above premises and the mutual covenants of the the receipt and sufficiency of which is acknowledged by each party DNTRACTOR do agree as follows:
CONTRACTOR'S own prequipment, tools, superinte to complete the Project in a Conditions of Contract, the printed or written explanate Dane County Dept of Wast Engineer"), and as enumer	to construct, for the price of \$ the Project and at the oper cost and expense to furnish all materials, supplies, machinery, indence labor, insurance, and other accessories and services necessary accordance with the conditions and prices stated in the Bid Form, drawings which include all maps, plats, plans, and other drawings and ory matter thereof, and the specifications therefore as prepared by an and Renewables (hereinafter referred to as "the Architect / sted in the Project Manual Table of Contents, all of which are made a evidence and constitute the Contract.
Contract subject to addition	the CONTRACTOR in current funds for the performance of the as and deductions, as provided in the Conditions of Contract, and to thereof as provided in Article entitled, "Payments to Contractor" of
	Contract, CONTRACTOR agrees to take affirmative action to ensure nities. The CONTRACTOR agrees in accordance with Wisconsin

Statute 111.321 and Chapter 19 of the Dane County Code of Ordinances not to discriminate on

orientation, national origin, cultural differences, ancestry, physical appearance, arrest record or conviction record, military participation or membership in the national guard, state defense force or any other reserve component of the military forces of the United States, or political beliefs. Such equal opportunity shall include, but not be limited to, the following: employment,

the basis of age, race, ethnicity, religion, color, gender, disability, marital status, sexual

Bid No. 320027 rev. 07/2020

upgrading, demotion, transfer, recruitment, advertising, layoff, termination, training, rates of pay, and any other form of compensation. CONTRACTOR agrees to post in conspicuous places, available to all employees and applicants for employment, notices setting forth the provisions of this paragraph.

- **4.** CONTRACTOR shall file an Affirmative Action Plan with the Dane County Contract Compliance Specialist in accord with Chapter 19 of the Dane County Code of Ordinances. CONTRACTOR must file such plan within fifteen (15) business days of the effective date of this Contract. During the term of this Contract CONTRACTOR shall also provide copies of all announcements of employment opportunities to COUNTY'S Office of Equity & Inclusion, and shall report annually the number of persons, by race, ethnicity, gender, and disability status, which apply for employment and, similarly classified, the number hired and number rejected.
- **5.** During the term of this Contract, all solicitations for employment placed on CONTRACTOR'S behalf shall include a statement to the effect that CONTRACTOR is an "Equal Opportunity Employer".
- **6.** CONTRACTOR agrees to furnish all information and reports required by COUNTY'S Contract Compliance Specialist as the same relate to affirmative action and nondiscrimination, which may include any books, records, or accounts deemed appropriate to determine compliance with Chapter 19, Dane County Code of Ordinances, and the provisions of this Contract.
- 7. This Contract is intended to be a Contract solely between the parties hereto and for their benefit only. No part of this Contract shall be construed to add to, supplement, amend, abridge or repeal existing rights, benefits or privileges of any third party or parties including, but not limited to, employees of either of the parties.
- **8.** The entire agreement of the parties is contained herein and this Contract supersedes any and all oral agreements and negotiations between the parties relating to the subject matter hereof. The parties expressly agree that the express terms of this Contract shall not be amended in any fashion except in writing, executed by both parties.
- 9. CONTRACTOR must be qualified as a Best Value Contractor or have proven their exemption with Dane County Public Works Engineering Division before Bid Due Date / Time. All contractors and subcontractors must be qualified as a Best Value Contractor or have proven their exemption to perform any work under this Contract.

Bid No. 320027 rev. 07/2020

IN WITNESS WHEREOF, COUNTY and CONTRACTOR, by their respective authorized agents, have caused this Contract and its Schedules to be executed, effective as of the date by which all parties hereto have affixed their respective signatures, as indicated below.

FOR CONTRACTO	PR:
Signature	Date
Printed or Typed Name and Title	
Signature	Date
Printed or Typed Name and Title	
NOTE: If CONTRACTOR is a corporation, Secretary sho Regulations, unincorporated entities are required to provid Employer Number in order to receive payment for services *******	e either their Social Security or
This Contract is not valid or effectual for any purpose until designated below, and no work is authorized until the CON proceed by COUNTY'S Waste & Renewables Director.	
FOR COUNTY:	
Joseph T. Parisi, County Executive	Date
Scott McDonell, County Clerk	Date

Bid Bond

CONTRACTOR: (Name, legal status and address)	SURETY: (Name, legal status and principal place of business)	
OWNER: (Name, legal status and address)		

This document has important legal consequences. Consultation with an attorney is encouraged with respect to its completion or modification.

Any singular reference to Contractor, Surety, Owner or other party shall be considered plural where applicable.

BOND AMOUNT:

PROJECT:

(Name, location or address, and Project number, if any)

The Contractor and Surety are bound to the Owner in the amount set forth above, for the payment of which the Contractor and Surety bind themselves, their heirs, executors, administrators, successors and assigns, jointly and severally, as provided herein. The conditions of this Bond are such that if the Owner accepts the bid of the Contractor within the time specified in the bid documents, or within such time period as may be agreed to by the Owner and Contractor, and the Contractor either (1) enters into a contract with the Owner in accordance with the terms of such bid, and gives such bond or bonds as may be specified in the bidding or Contract Documents, with a surety admitted in the jurisdiction of the Project and otherwise acceptable to the Owner, for the faithful performance of such Contract and for the prompt payment of labor and material furnished in the prosecution thereof, or (2) pays to the Owner the difference, not to exceed the amount of this Bond, between the amount specified in said bid and such larger amount for which the Owner may in good faith contract with another party to perform the work covered by said bid, then this obligation shall be null and void, otherwise to remain in full force and effect. The Surety hereby waives any notice of an agreement between the Owner and Contractor to extend the time in which the Owner may accept the bid. Waiver of notice by the Surety shall not apply to any extension exceeding sixty (60) days in the aggregate beyond the time for acceptance of bids specified in the bid documents, and the Owner and Contractor shall obtain the Surety's consent for an extension beyond sixty (60) days.

If this Bond is issued in connection with a subcontractor's bid to a Contractor, the term Contractor in this Bond shall be deemed to be Subcontractor and the term Owner shall be deemed to be Contractor.

When this Bond has been furnished to comply with a statutory or other legal requirement in the location of the Project, any provision in this Bond conflicting with said statutory or legal requirement shall be deemed deleted herefrom and provisions conforming to such statutory or other legal requirement shall be deemed incorporated herein. When so furnished, the intent is that this Bond shall be construed as a statutory bond and not as a common law bond.

Signed and sealed this day of		
	(Contractor as Principal)	(Seal)
(Witness)		
	(Title)	
	(Surety)	(Seal)
(Witness)		
	(Title)	

CAUTION: You should sign an original AIA Contract Document, on which this text appears in RED. An original assures that changes will not be obscured.



Performance Bond


CONTRACTOR: (Name, legal status and address)	SURETY: (Name, legal status and principal place of business)	
OWNER: (Name, legal status and address)		This document has important legal consequences. Consultation with an attorney is encouraged with respect to its completion or modification.
		Any singular reference to Contractor, Surety, Owner or other party shall be considered plural where applicable.
CONSTRUCTION CONTRACT Date:		AIA Document A312–2010 combines two separate bonds, a
Amount:		Performance Bond and a Payment Bond, into one form.
Description: (Name and location)		This is not a single combined Performance and Payment Bond.
BOND Date: (Not earlier than Construction Contract Date)		
Amount:		
Modifications to this Bond: None	☐ See Section 16	
CONTRACTOR AS PRINCIPAL	SURETY	
Company: (Corporate Seal)	Company: (Corporate Seal)	
Signature:	Signature:	
Name Nam	e	
and Title: (Any additional signatures appear on the last	and Title: t page of this Performance Bond.)	
(FOR INFORMATION ONLY—Name, addr AGENT or BROKER:	OWNER'S REPRESENTATIVE:	
	(Architect, Engineer or other party:)	

- § 1 The Contractor and Surety, jointly and severally, bind themselves, their heirs, executors, administrators, successors and assigns to the Owner for the performance of the Construction Contract, which is incorporated herein by reference.
- § 2 If the Contractor performs the Construction Contract, the Surety and the Contractor shall have no obligation under this Bond, except when applicable to participate in a conference as provided in Section 3.
- § 3 If there is no Owner Default under the Construction Contract, the Surety's obligation under this Bond shall arise after
 - the Owner first provides notice to the Contractor and the Surety that the Owner is considering declaring a Contractor Default. Such notice shall indicate whether the Owner is requesting a conference among the Owner, Contractor and Surety to discuss the Contractor's performance. If the Owner does not request a conference, the Surety may, within five (5) business days after receipt of the Owner's notice, request such a conference. If the Surety timely requests a conference, the Owner shall attend. Unless the Owner agrees otherwise, any conference requested under this Section 3.1 shall be held within ten (10) business days of the Surety's receipt of the Owner's notice. If the Owner, the Contractor and the Surety agree, the Contractor shall be allowed a reasonable time to perform the Construction Contract, but such an agreement shall not waive the Owner's right, if any, subsequently to declare a Contractor Default:
 - .2 the Owner declares a Contractor Default, terminates the Construction Contract and notifies the Surety; and
 - .3 the Owner has agreed to pay the Balance of the Contract/Price in accordance with the terms of the Construction Contract to the Surety or to a contractor selected to perform the Construction Contract.
- § 4 Failure on the part of the Owner to comply with the notice requirement in Section 3.1 shall not constitute a failure to comply with a condition precedent to the Surety's obligations, or release the Surety from its obligations, except to the extent the Surety demonstrates actual prejudice.
- § 5 When the Owner has satisfied the conditions of Section 3, the Surety shall promptly and at the Surety's expense take one of the following actions:
- § 5.1 Arrange for the Contractor, with the consent of the Owner, to perform and complete the Construction Contract;
- § 5.2 Undertake to perform and complete the Construction Contract itself, through its agents or independent contractors:
- § 5.3 Obtain bids or negotiated proposals from qualified contractors acceptable to the Owner for a contract for performance and completion of the Construction Contract, arrange for a contract to be prepared for execution by the Owner and a contractor selected with the Owner's concurrence, to be secured with performance and payment bonds executed by a qualified surety equivalent to the bonds issued on the Construction Contract, and pay to the Owner the amount of damages as described in Section 7 in excess of the Balance of the Contract Price incurred by the Owner as a result of the Contractor Default, or
- § 5.4 Waive its right to perform and complete, arrange for completion, or obtain a new contractor and with reasonable promptness under the circumstances:
 - After investigation, determine the amount for which it may be liable to the Owner and, as soon as practicable after the amount is determined, make payment to the Owner; or
 - .2 Deny liability in whole or in part and notify the Owner, citing the reasons for denial.
- § 6 If the Surety does not proceed as provided in Section 5 with reasonable promptness, the Surety shall be deemed to be in default on this Bond seven days after receipt of an additional written notice from the Owner to the Surety demanding that the Surety perform its obligations under this Bond, and the Owner shall be entitled to enforce any remedy available to the Owner. If the Surety proceeds as provided in Section 5.4, and the Owner refuses the payment or the Surety has denied liability, in whole or in part, without further notice the Owner shall be entitled to enforce any remedy available to the Owner.

- § 7 If the Surety elects to act under Section 5.1, 5.2 or 5.3, then the responsibilities of the Surety to the Owner shall not be greater than those of the Contractor under the Construction Contract, and the responsibilities of the Owner to the Surety shall not be greater than those of the Owner under the Construction Contract. Subject to the commitment by the Owner to pay the Balance of the Contract Price, the Surety is obligated, without duplication, for
 - .1 the responsibilities of the Contractor for correction of defective work and completion of the Construction Contract:
 - .2 additional legal, design professional and delay costs resulting from the Contractor's Default, and resulting from the actions or failure to act of the Surety under Section 5; and
 - .3 liquidated damages, or if no liquidated damages are specified in the Construction Contract, actual damages caused by delayed performance or non-performance of the Contractor.
- § 8 If the Surety elects to act under Section 5.1, 5.3 or 5.4, the Surety's liability is limited to the amount of this Bond.
- § 9 The Surety shall not be liable to the Owner or others for obligations of the Contractor that are unrelated to the Construction Contract, and the Balance of the Contract Price shall not be reduced or set off on account of any such unrelated obligations. No right of action shall accrue on this Bond to any person or entity other than the Owner or its heirs, executors, administrators, successors and assigns.
- § 10 The Surety hereby waives notice of any change, including changes of time, to the Construction Contract or to related subcontracts, purchase orders and other obligations.
- § 11 Any proceeding, legal or equitable, under this Bond may be instituted in any court of competent jurisdiction in the location in which the work or part of the work is located and shall be instituted within two years after a declaration of Contractor Default or within two years after the Contractor ceased working or within two years after the Surety refuses or fails to perform its obligations under this Bond, whichever occurs first. If the provisions of this Paragraph are void or prohibited by law, the minimum period of limitation available to sureties as a defense in the jurisdiction of the suit shall be applicable.
- § 12 Notice to the Surety, the Owner or the Contractor shall be mailed or delivered to the address shown on the page on which their signature appears.
- § 13 When this Bond has been furnished to comply with a statutory or other legal requirement in the location where the construction was to be performed, any provision in this Bond conflicting with said statutory or legal requirement shall be deemed deleted herefrom and provisions conforming to such statutory or other legal requirement shall be deemed incorporated herein. When so furnished, the intent is that this Bond shall be construed as a statutory bond and not as a common law bond.

§ 14 Definitions

- § 14.1 Balance of the Contract Price. The total amount payable by the Owner to the Contractor under the Construction Contract after all proper adjustments have been made, including allowance to the Contractor of any amounts received or to be received by the Owner in settlement of insurance or other claims for damages to which the Contractor is entitled, reduced by all valid and proper payments made to or on behalf of the Contractor under the Construction Contract.
- § 14.2 Construction Contract. The agreement between the Owner and Contractor identified on the cover page, including all Contract Documents and changes made to the agreement and the Contract Documents.
- § 14.3 Contractor Default. Failure of the Contractor, which has not been remedied or waived, to perform or otherwise to comply with a material term of the Construction Contract.
- § 14.4 Owner Default. Failure of the Owner, which has not been remedied or waived, to pay the Contractor as required under the Construction Contract or to perform and complete or comply with the other material terms of the Construction Contract.
- § 14.5 Contract Documents. All the documents that comprise the agreement between the Owner and Contractor.
- § 15 If this Bond is issued for an agreement between a Contractor and subcontractor, the term Contractor in this Bond shall be deemed to be Subcontractor and the term Owner shall be deemed to be Contractor.

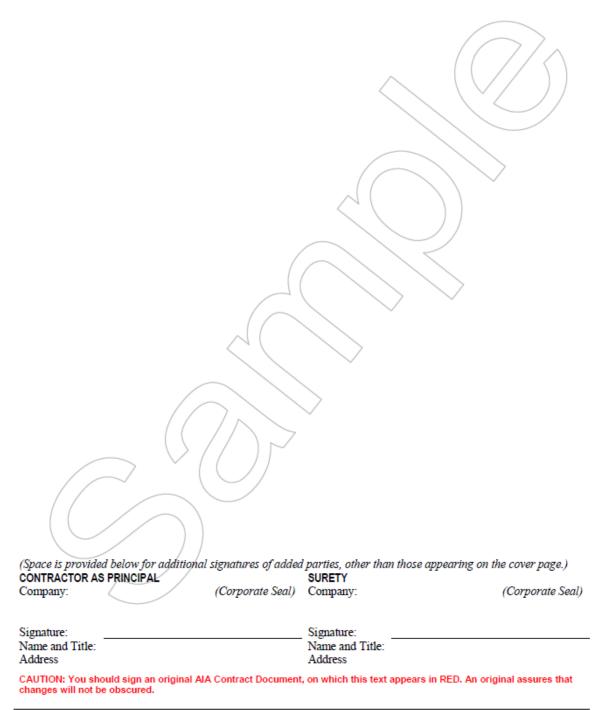



Payment Bond

CONTRACTOR: (Name, legal status and address)	SURETY: (Name, legal status and principal place of business)	
OWNER: (Name, legal status and address)		This document has important legal consequences. Consultation with an attorney is encouraged with respect to its completion or modification.
		Any singular reference to Contractor, Surety, Owner or other party shall be considered plural where applicable.
CONSTRUCTION CONTRACT Date:		AIA Document A312–2010 combines two separate bonds, a
Amount:		Performance Bond and a Payment Bond, into one form.
Description: (Name and location)		This is not a single combined Performance and Payment Bond.
BOND Date: (Not earlier than Construction Contract Date)		
Amount:		
Modifications to this Bond: None	☐ See Section 18	
CONTRACTOR AS PRINCIPAL	SURETY	
Company: (Corporate Seal)	Company: (Corporate Seal)	
Signature:	Signature:	
Name Nam	е	
and Title: (Any additional signatures appear on the last	and Title: t page of this Payment Bond.)	
(FOR INFORMATION ONLY—Name, addr AGENT or BROKER:	ress and telephone) OWNER'S REPRESENTATIVE: (Architect, Engineer or other party:)	


- § 1 The Contractor and Surety, jointly and severally, bind themselves, their heirs, executors, administrators, successors and assigns to the Owner to pay for labor, materials and equipment furnished for use in the performance of the Construction Contract, which is incorporated herein by reference, subject to the following terms.
- § 2 If the Contractor promptly makes payment of all sums due to Claimants, and defends, indemnifies and holds harmless the Owner from claims, demands, liens or suits by any person or entity seeking payment for labor, materials or equipment furnished for use in the performance of the Construction Contract, then the Surety and the Contractor shall have no obligation under this Bond.
- § 3 If there is no Owner Default under the Construction Contract, the Surety's obligation to the Owner under this Bond shall arise after the Owner has promptly notified the Contractor and the Surety (at the address described in Section 13) of claims, demands, liens or suits against the Owner or the Owner's property by any person or entity seeking payment for labor, materials or equipment furnished for use in the performance of the Construction Contract and tendered defense of such claims, demands, liens or suits to the Contractor and the Surety.
- § 4 When the Owner has satisfied the conditions in Section 3, the Surety shall promptly and at the Surety's expense defend, indemnify and hold harmless the Owner against a duly tendered claim, demand, lien or suit.
- § 5 The Surety's obligations to a Claimant under this Bond shall arise after the following:
- § 5.1 Claimants, who do not have a direct contract with the Contractor,
 - .1 have furnished a written notice of non-payment to the Contractor, stating with substantial accuracy the amount claimed and the name of the party to whom the materials were, or equipment was, furnished or supplied or for whom the labor was done or performed, within ninety (90) days after having last performed labor or last furnished materials or equipment included in the Claim; and
 - .2 have sent a Claim to the Surety (at the address described in Section 13).
- § 5.2 Claimants, who are employed by or have a direct contract with the Contractor, have sent a Claim to the Surety (at the address described in Section 13).
- § 6 If a notice of non-payment required by Section 5.1.1 is given by the Owner to the Contractor, that is sufficient to satisfy a Claimant's obligation to furnish a written notice of non-payment under Section 5.1.1.
- § 7 When a Claimant has satisfied the conditions of Sections 5.1 or 5.2, whichever is applicable, the Surety shall promptly and at the Surety's expense take the following actions:
- § 7.1 Send an answer to the Claimant, with a copy to the Owner, within sixty (60) days after receipt of the Claim, stating the amounts that are undisputed and the basis for challenging any amounts that are disputed; and
- § 7.2 Pay or arrange for payment of any undisputed amounts.
- § 7.3 The Surety's failure to discharge its obligations under Section 7.1 or Section 7.2 shall not be deemed to constitute a waiver of defenses the Surety or Contractor may have or acquire as to a Claim, except as to undisputed amounts for which the Surety and Claimant have reached agreement. If, however, the Surety fails to discharge its obligations under Section 7.1 or Section 7.2, the Surety shall indemnify the Claimant for the reasonable attorney's fees the Claimant incurs thereafter to recover any sums found to be due and owing to the Claimant.
- § 8 The Surety's total obligation shall not exceed the amount of this Bond, plus the amount of reasonable attorney's fees provided under Section 7.3, and the amount of this Bond shall be credited for any payments made in good faith by the Surety.
- § 9 Amounts owed by the Owner to the Contractor under the Construction Contract shall be used for the performance of the Construction Contract and to satisfy claims, if any, under any construction performance bond. By the Contractor furnishing and the Owner accepting this Bond, they agree that all funds earned by the Contractor in the performance of the Construction Contract are dedicated to satisfy obligations of the Contractor and Surety under this Bond, subject to the Owner's priority to use the funds for the completion of the work.

- § 10 The Surety shall not be liable to the Owner, Claimants or others for obligations of the Contractor that are unrelated to the Construction Contract. The Owner shall not be liable for the payment of any costs or expenses of any Claimant under this Bond, and shall have under this Bond no obligation to make payments to, or give notice on behalf of Claimants or otherwise have any obligations to Claimants under this Bond.
- § 11 The Surety hereby waives notice of any change, including changes of time, to the Construction Contract or to related subcontracts, purchase orders and other obligations.
- § 12 No suit or action shall be commenced by a Claimant under this Bond other than in a court of competent jurisdiction in the state in which the project that is the subject of the Construction Contract is located or after the expiration of one year from the date (1) on which the Claimant sent a Claim to the Surety pursuant to Section 5.1.2 or 5.2, or (2) on which the last labor or service was performed by anyone or the last materials or equipment were furnished by anyone under the Construction Contract, whichever of (1) or (2) first occurs. If the provisions of this Paragraph are void or prohibited by law, the minimum period of limitation available to sureties as a defense in the jurisdiction of the suit shall be applicable.
- § 13 Notice and Claims to the Surety, the Owner or the Contractor shall be mailed or delivered to the address shown on the page on which their signature appears. Actual receipt of notice or Claims, however accomplished, shall be sufficient compliance as of the date received.
- § 14 When this Bond has been furnished to comply with a statutory or other legal requirement in the location where the construction was to be performed, any provision in this Bond conflicting with said statutory or legal requirement shall be deemed deleted herefrom and provisions conforming to such statutory or other legal requirement shall be deemed incorporated herein. When so furnished, the intent is that this Bond shall be construed as a statutory bond and not as a common law bond.
- § 15 Upon request by any person or entity appearing to be a potential beneficiary of this Bond, the Contractor and Owner shall promptly furnish a copy of this Bond or shall permit a copy to be made.

§ 16 Definitions

- § 16.1 Claim. A written statement by the Claimant including at a minimum:
 - .1 the name of the Claimant;
 - .2 the name of the person for whom the labor was done, or materials or equipment furnished;
 - .3 a copy of the agreement or purchase order pursuant to which labor, materials or equipment was furnished for use in the performance of the Construction Contract;
 - .4 a brief description of the labor, materials or equipment furnished;
 - .5 the date on which the Claimant last performed labor or last furnished materials or equipment for use in the performance of the Construction Contract;
 - .6 the total amount earned by the Claimant for labor, materials or equipment furnished as of the date of the Claim:
 - .7 the total amount of previous payments received by the Claimant; and
 - .8 the total amount due and unpaid to the Claimant for labor, materials or equipment furnished as of the date of the Claim.
- § 16.2 Claimant. An individual or entity having a direct contract with the Contractor or with a subcontractor of the Contractor to furnish labor, materials or equipment for use in the performance of the Construction Contract. The term Claimant also includes any individual or entity that has rightfully asserted a claim under an applicable mechanic's lien or similar statute against the real property upon which the Project is located. The intent of this Bond shall be to include without limitation in the terms "labor, materials or equipment" that part of water, gas, power, light, heat, oil, gasoline, telephone service or rental equipment used in the Construction Contract, architectural and engineering services required for performance of the work of the Contractor and the Contractor's subcontractors, and all other items for which a mechanic's lien may be asserted in the jurisdiction where the labor, materials or equipment were furnished.
- § 16.3 Construction Contract. The agreement between the Owner and Contractor identified on the cover page, including all Contract Documents and all changes made to the agreement and the Contract Documents.

- § 16.4 Owner Default. Failure of the Owner, which has not been remedied or waived, to pay the Contractor as required under the Construction Contract or to perform and complete or comply with the other material terms of the Construction Contract.
- § 16.5 Contract Documents, All the documents that comprise the agreement between the Owner and Contractor.
- § 17 If this Bond is issued for an agreement between a Contractor and subcontractor, the term Contractor in this Bond shall be deemed to be Subcontractor and the term Owner shall be deemed to be Contractor.

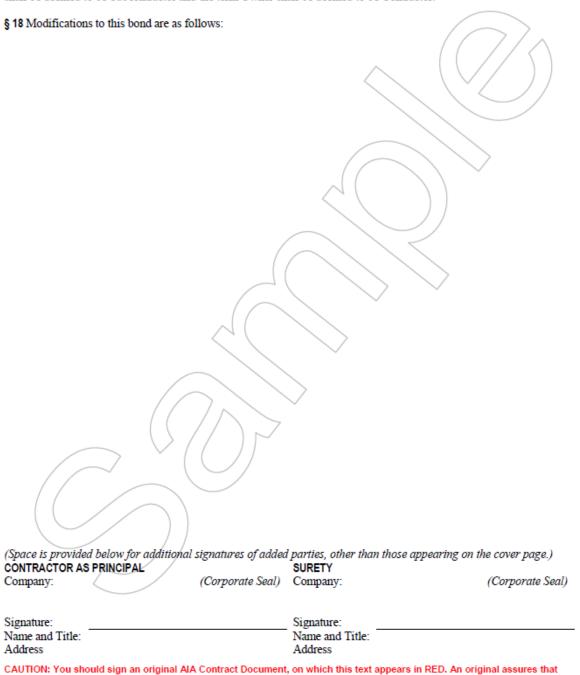

changes will not be obscured.

SECTION 00 72 12

CONDITIONS OF CONTRACT

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1. BIDS AND QUOTATIONS

- A. Addressing of Bids. Bids shall be addressed to attention of Waste & Renewables Project Manager and received at Dane County Department of Waste & Renewables, 1919 Alliant Energy Center Way, Madison, WI 53713, on or before local time and date specified herein for Bid Due Date. Seal all bids in envelopes and clearly mark front with bid number and reference to specified contents of bid. All uses of term "County" in Construction Documents shall mean Dane County.
- B. **Only One Copy Required.** Unless otherwise specified, only one copy of bid or quotation on prescribed Bid Form will be required.
- C. **Additional Data with Bid.** Bidder may submit, on firm's letterhead only, additional data and information deemed advantageous to County. County shall hold optional consideration of such data and information.
- D. **More than One Bid.** Bidders desiring to submit more than one bid may do so provided such additional bid or bids are properly submitted on Dane County Department of Waste & Renewables' Bid Form. Obtain extra sets of Construction Documents from Dane County Department of Waste & Renewables. All uses of term "Department" in Construction Documents shall mean Department of Waste & Renewables, which is a Dane County government unit.
- E. **Withdrawal or Late Bids.** County will not accept formal bids, amendments thereto, or requests for withdrawal of bid or any part thereof, after time of Bid Due Date.
- F. **Preparation and Submission.** All written bids, unless otherwise provided for, must be submitted on and in accordance with forms provided by County properly signed in ink. Bids not signed by hand are not accepted. Bidders must register in advance with Purchasing Division.
- G. **Products by Name.** Intention of Specifications of products by name is to be descriptive of quality, workmanship, finish, function and approximate characteristics desired; intention is not necessarily restriction. Consideration of products substitution for those named is possible, provided substitute offered is, in opinion of Dane County Waste & Renewables

- Project Manager, equal or superior in quality, workmanship, finish, function and approximate characteristics to that specified in Project Manual Specifications listed herein.
- H. **Visitation of Sites.** Bidder shall visit site(s) that will receive intended work or installation, and in so doing, be held responsible for job deemed satisfactory by County after completion of the Work or installation. No additional compensation shall be allowed for any condition of which bidder could have been informed.
- I. **Completeness.** Supply all information required by Construction Documents to constitute regular bid. This shall include:
 - 1. Completed Bid Form.
 - 2. Completed Fair Labor Practices Certification.
 - 3. Completed Bid Bond.
- J. **Bids Binding Sixty (60) Calendar Days.** Unless otherwise specified all formal bids submitted shall be binding for sixty (60) calendar days following Bid Due Date.
- K. Conditional Bids. Qualified bids are subject to complete rejection, or partial rejection.
- L. **All or Part.** Bids or quotations may be considered and award made for all or any part of total quantities as specified in Construction Documents.
- M. **Errors.** Unit bid price shall govern when extending total prices has errors. Carelessness in quoting prices or in preparation of bid otherwise, will not relieve bidder. Explain all erasures in bids and include signature of bidder.
- N. **Regulation by State Statutes.** Bidding and letting of contracts are subject to provisions of Wisconsin Statutes 59.52(29) and 66.0901 and all subsequent sections and amendments thereof.
- O. **Bidders Present.** Bid Due Date is time fixed for opening of formal bids. Bids' contents will be made public for information of bidders and others properly interested, who may be present either in person or by representative. Bidders are encouraged to attend all openings, and to offer constructive suggestions for improvements to bid format or ways in which County can realize greater savings.
- P. **Taxes.** Contractor does not need to pay State and local sales & use taxes. See Wisconsin Statute 77.54 (9m).

2. GUARANTEE AND BOND

A. Bid Bond / Guarantee. Bid Bond shall accompany Bids, which shall be either flat sum or percentage figure as shown on Project Manual Cover. This Bid Bond shall serve as warrant that successful bidder will fulfill terms of bid within time limit as indicated in bid after notice of award by Dane County. Bid Bond may be certified bank check (note: uncertified checks will not be acceptable), cashier's check or United State money order payable to Treasurer of Dane County; or on Bid Bond with corporate surety authorized to do business in State of Wisconsin and warranty of attorney to confess judgment thereon attached thereto. County will return negotiable Bid Bonds to unsuccessful bidders after awarding of bid. County shall return check held from Contractor after satisfactory completion of Contract or after receipt by

- County of Performance Bond from Contractor, if one is required. Surety Bid Bonds will not be returned unless specifically requested by individual bidders.
- B. **Guarantor Liability.** When guarantee is required, failure of bidder to furnish acceptable Performance Bond (Article 2.C.) within twenty (20) business days after receipt of notice of award shall render guarantor liable to County. Bids covered by certified check or bond such security shall become absolute property of County and shall be deposited with County Treasurer for benefit of County as liquidated damages. County shall forthwith proceed to collect on Bid Bond.
- C. **Performance / Payment Bond.** When required, file guarantee that successful bidder will faithfully perform obligations of bid as accepted. Such guarantee must be bond complying with Wisconsin Statute 779.14 with corporate surety authorized to do business in this State, and that Contractor or subcontractors will be responsible for all claims for injuries to persons or damages to property or premises arising out of or in connection with their operations prior to acceptance of finished work or supplies, and that they will promptly make payments to all persons supplying them with labor or materials in execution of the Work provided for in Contract; guarantee to indemnify, hold harmless and defend Dane County, its boards, commissions, agencies, officers, employees and representatives from all costs, damages and expenses growing out of or by reason of successful bidder's failure to comply and perform the Work and complete Contract in accordance with Construction Documents; attach thereto a warrant of attorney authorizing confession of judgment thereon for benefit of County.

3. SHOP DRAWINGS, PRODUCT DATA AND SAMPLES

- A. Shop Drawings are drawings, diagrams, schedules and other data specially prepared for the Work by Contractor or subcontractor, sub-subcontractor, manufacturer, supplier or distributor to illustrate some portion of the Work.
- B. Product Data are illustrations, standard schedules, performance charts, instructions, brochures, diagrams and other information furnished by Contractor to illustrate materials or equipment for some portion of the Work.
- C. Samples are physical examples that illustrate materials, equipment or workmanship and establish standards to compare the Work.
- D. Shop Drawings, Product Data, Samples and similar submittals are not Construction Documents. Purpose of their submittal is to demonstrate for those portions of the Work for which submittals are required how Contractor proposes to conform to information given and design concept expressed in Construction Documents.
- E. Contractor shall review, approve and submit toWaste & Renewables Project Manager Shop Drawings, Product Data, Samples and similar submittals required by Construction Documents with reasonable promptness and in such sequence as to cause no delay in the Work or in activities of County or of separate contractors. Submittals made by Contractor not required by Construction Documents, may be returned without action.
- F. Contractor shall perform no portion of the Work requiring submittal and review of Shop Drawings, Product Data, Samples or similar submittals until Waste & Renewables Project Manager has approved respective submittal. Such Work shall be in accordance with approved submittals.

- G. By approving and submitting, Shop Drawings, Product Data, Samples and similar submittals, Contractor represents that Contractor has determined and verified materials, field measurements and field construction criteria related thereto, or will do so, and has checked and coordinated information contained within such submittals with requirements of the Work and of Construction Documents.
- H. Contractor shall not be relieved of responsibility for deviations from requirements of Construction Documents by Waste & Renewables Project Manager's approval of Shop Drawings, Product Data, Samples and similar submittals unless Contractor has specifically informed Waste & Renewables Project Manager in writing of such deviation at time of submittal and Waste & Renewables Project Manager has given written approval to specific deviation. Contractor shall not be relieved of responsibility for errors or omissions in Shop Drawings, Product Data, Sample or similar submittals by Waste & Renewables Project Manager's approval thereof.
- I. Contractor shall in writing direct specific attention to revised and / or resubmitted Shop Drawings, Product Data, Samples or similar submittals that were not requested by Waste & Renewables Project Manager on previous submittals.
- J. Unless specified otherwise, Contractor shall submit three (3) copies of all Shop Drawings, Product Data, Samples or similar submittals for each submission, until receiving final approval. After final approval, provide five (5) additional copies for distribution and such other copies as may be required.

4. AWARDS

- A. Lowest Responsible Bidder. Award will be to lowest responsible bidder conforming to Construction Documents or on most advantageous bid to County.
- B. **Other Considerations.** Quantities involved, time of delivery, purpose for which required, competency of bidder, ability to render satisfactory service and past performance will be considered in determining responsibility.
- C. **Rejection of Bids.** County reserves right to reject any or all bids or quotations in whole or in part and to award by items, parts of items, or by any aggregate group of items specified. County also reserves right to waive technical defects when in its judgment best interests of County thereby will be served.
- D. **Notice of Acceptance.** Sufficient notification of acceptance of bid will be written notice of award to bidder in form of Purchase Order or similar, mailed or delivered to address shown on Bid Form.
- E. **Tie Bids.** If two or more bidders submit identical bids, decision of County to make award to one or more of such bidders shall be final. Cash discount will be taken into consideration in determining award. Also, see Article 7.A. IDENTICAL BIDDING, Antitrust Laws.
- F. Qualifying Bidders. Prior to solicitation and / or awarding of bid, County may require submission by bidder of complete financial statement and questionnaire describing bidder's financial ability and experience in performance of similar work. Refer to Instructions to Bidders.

- G. **Disqualification.** Awards will not be made to any person, firm or company in default of Contract with County, or to any bidder having as its sales agent or representative or as member of firm, any individual previously in default or guilty of misrepresentation.
- H. **Bid Results.** Bidders may secure information pertaining to results of bids by visiting Public Works' website, <u>bids-pwht.countyofdane.com/</u>.

5. CONTRACT PROVISIONS

- A. Acceptance Constitutes Contract. Written acceptance by Waste & Renewables Project Manager of proposal for services shall constitute Contract, which shall bind bidder to perform the Work as detailed in Construction Documents, for bid amount and in accordance with all conditions of said accepted bid. Formal Contract containing all provisions of Contract signed by both parties shall be used when required by Waste & Renewables Project Manager.
- B. Local Restrictions and Permits. All work shall be done according to applicable laws, ordinances and codes. Contractor shall procure and pay for all required permits for permanent or temporary work.
- C. Payment of Invoices. Payment may be made only after inspection and acceptance by using agency and approval by Dane County Waste & Renewables Project Manager, and, where required by ordinances, approval by Dane County Board of Supervisors. If materials or equipment were delivered, constructed, erected, installed or tested on site, payment shall be made based on ninety-five percent (95%) of value of all the Work performed up to fifty percent (50%) of scheduled values less total of previous payments. Authorized extra work will be included in progress payments. Payment of balances will be made only after approval and final acceptance by County in consideration and elimination of possibilities of imperfect work, faulty materials or equipment, liens that have been filed, or if evidence indicates possible filing of claims.
- D. **Contract Alterations.** No alterations or variables in terms of contract shall be valid or binding upon County unless made in writing and signed by Purchasing Agent or authorized agent.
- E. **Assignments.** No contract may be assigned, sublet or transferred without written consent of Waste & Renewables Project Manager.
- F. Cancellations. Contract may be canceled or voided by Waste & Renewables Project Manager upon non-performance or violation of contract provisions, and award made to next low bidder or articles specified may be purchased on open market. In either event, defaulting contractor (or their surety) shall be liable to Dane County for costs to County in excess of defaulting contractor's contract prices.

G. Right of Department to Terminate Contract.

- 1. In event that Contractor or any subcontractors violate any provisions of this Contract, County may serve written notice upon Contractor and Surety of its intention to terminate Contract. Such notice to contain reasons for such intention to terminate Contract, and unless within ten (10) business days after serving of such notice upon Contractor, such violation or delay shall cease and satisfactory arrangement or correction be made, Contract shall, upon expiration of said ten (10) business days, cease and terminate.
- 2. In event of any such termination, County shall immediately serve notice thereof upon Surety and Contractor, and Surety shall have right to take over and perform Contract

subject to County's approval. However, if Surety does not commence performance thereof within ten (10) business days from date of mailing to such Surety of notice of termination, County may take over the Work and prosecute same to completion by Contract or by force account for account and at expense of Contractor. Contractor and Surety shall be liable to County for any excess cost occasioned County thereby, and in such event County may take possession of and utilize in completing the Work, such equipment, materials and / or supplies as may be on site of the Work and therefore necessary.

- H. Non-Liability. Contractor shall not be liable in damages for delay in shipment or failure to deliver when such delay or failure is result of fire, flood, strike, transporting carrier, act of God, act of government, act of alien enemy or by any other circumstances which, in Waste & Renewables Project Manager's opinion, is beyond control of Contractor. Under such circumstances, however, Waste & Renewables Project Manager may in discretion, cancel Contract.
- I. Quality Assurance. Inspection of equipment, materials and / or supplies shall be made by or at direction of County or Agency to which goods are delivered, and any articles supplied that are defective, or fails in any way to meet Specifications or other requirements of Contract, will be rejected. Waste & Renewables Project Manager shall direct all required laboratory tests. Decision of Waste & Renewables Project Manager on acceptance shall be final.
- J. **Time for Completion.** Contractor agrees that the Work shall be prosecuted regularly and diligently and complete entire project as stated in Construction Documents.

K. Changes in the Work.

- 1. Except in cases of emergency, no changes in the Work covered by approved Construction Documents shall be made without having prior written approval of Department. Charges or credits for work covered by approved change shall be determined by one of these methods:
 - a) Unit bid prices previously approved.
 - b) Agreed lump sum based on actual cost of:
 - 1) Labor, including foremen, and all fringe benefits that are associated with their wages:
 - 2) Materials entering permanently into the Work;
 - 3) Ownership or rental cost of construction plant and equipment during time of use on extra work;
 - 4) Power and consumable supplies for operation of construction or power equipment;
 - 5) Workmen's Compensation Insurance, Contractor's Public Liability and Property Damage Insurance, and Comprehensive Automobile Liability Insurance;
 - 6) Social Security, pension and unemployment contributions;
 - 7) To cost under K.1.b), there shall be added fixed fee to be agreed upon, but not to exceed fifteen percent (15%) of actual cost of the Work performed with their own labor force; fee shall be compensation to cover cost of supervision, overhead, bond, profit and any other general expense;
 - 8) On that portion of work under K.1.b) done under subcontract, Contractor may include not over seven and one-half percent (7½%) for supervision, overhead, bond, profit and any other general expense; and
 - 9) Contractor shall keep and present in such form as directed, correct amount of cost together with such supporting vouchers as may be required by Department.
 - c) Cost-Plus Work, with not-to-exceed dollar limit, based on actual cost of:
 - 1) Labor, including foremen, and all fringe benefits that are associated with their wages;

- 2) Materials entering permanently into the Work;
- 3) Ownership or rental cost of construction plant and equipment during time of use on extra work. (Rental cost cannot exceed fifty percent (50%) replacement value of rented equipment);
- 4) Power and consumable supplies for operation of construction or power equipment;
- 5) Workmen's Compensation, Contractor's Public Liability and Property Damage Insurance, and Comprehensive Automobile Liability Insurance;
- 6) Social Security, pension and unemployment contributions;
- 7) To cost under K.1.c) there shall be added fixed fee to be agreed upon, but not to exceed fifteen percent (15%) of actual cost of the Work performed with their own labor force; fee shall be compensation to cover cost of supervision, overhead, bond, profit, and any other general expense;
- 8) On that portion of work under K.1.c) done under subcontract, Contractor may include not over seven and one-half percent (7½%) for supervision, overhead, bond, profit, and any other general expense; and
- 9) Contractor shall keep and present in such form as directed, correct amount of cost together with such supporting vouchers as may be required by Department.
- 2. If Contractor claims that by any instructions given by Waste & Renewables Project Manager, by drawings or otherwise, regarding performance of the Work or furnishing of material under Contract, involves extra cost, Contractor shall give Department written notice thereof within two weeks after receipt of such instructions and in any event before proceeding to execute work, unless delay in executing work would endanger life or property.
- 3. No claim for extra work or cost shall be allowed unless same was done in pursuance of written order of Waste & Renewables Project Manager and approved by Department, as previously mentioned, and claim presented with payment request submitted after changed or extra work is completed.
- 4. Negotiation of cost for change in the Work shall not be cause for Contractor to delay prosecution of the Work if Contractor has been authorized in writing by Waste & Renewables Project Manager to proceed.

L. Payments to Contractor.

- 1. County will make partial payments to Contractor for value, proportionate to amount of Contract, of all labor and material incorporated in the Work during preceding calendar month upon receipt and approval of Department.
- 2. Contractor shall submit to Waste & Renewables Project Manager Application and Certificate of Payment. Evidence may be required, and supplied on demand, that supports request and Contractor's right to payment claimed.
- 3. Request for payment for preparatory work and materials delivered and suitably stored at site to be incorporated into the Work at some future period, will be given due consideration. Requests involving materials stored off site, may be rejected; however, if deemed essential for reasons of job progress, protection, or other sufficient cause, requests will be considered conditional upon submission by Contractor of bills of sale and such other procedures as will adequately protect County's interest such as storage in bonded warehouse with adequate coverage. If there is any error in payment, Contractor is obligated to notify Department immediately, but no longer than ten (10) business days from receipt of payment.

- 4. Payments by County will be due within forty-five (45) business days after receipt by Department of certified request.
- 5. Five percent (5%) of each request for certification will be retained until final completion and acceptance of all the Work covered by Contract. However, anytime after fifty percent (50%) of the Work has been furnished and installed at site, remaining payments will be made in full if Waste & Renewables Project Manager finds that progress of the Work corresponds with construction progress schedule. If Waste & Renewables Project Manager find that progress of the Work does not correspond with construction progress schedule, up to ten percent (10%) of each request for payment may be retained for the Work completed.
- 6. All material and work covered by partial payments made shall become sole property of County. This provision shall not be construed as relieving Contractor from sole responsibility for care and protection of materials and work upon which payments have been made or restoration of any damaged work, or as waiver of right of County to require fulfillment of all of terms of Contract.
- 7. Final payment will be made within sixty (60) calendar days after final completion of the Work, and will constitute acceptance thereof.
- 8. On completion and acceptance of each separate division of Contract, on which stated price is separated in Contract, payment may be made in full, including retained percentages thereon, less authorized deductions.
- 9. Every contractor engaged in performance of any contract for Department of Waste & Renewables shall submit to this Department, as requested and with final application for payment for work under said contract, affidavit(s) as required to prove that all debts and claims against this Work are paid in full or otherwise satisfied, and give final evidence of release of all liens against the Work and County.

M. Withholding of Payments.

- 1. County, after having served written notice on said Contractor, may either pay directly any unpaid bills of which Department has written notice, or withhold from Contractor's unpaid compensation, sum of money deemed reasonably sufficient to pay any and all such lawful claims until satisfactory evidence is furnished that all liabilities have been fully discharged. Then payment to Contractor shall be resumed in accordance with terms of this Contract, but in no event shall these provisions be construed to impose any obligations upon County to either Contractor or Contractor's Surety.
- 2. In paying any unpaid bills of Contractor, County shall be deemed Agent of Contractor, and any payment so made by County, shall be considered as payment made under Contract by County to Contractor and County shall not be liable to Contractor for any such payment made in good faith.
- 3. Contractor shall indemnify, hold harmless and defend Dane County, its boards, commissions, agencies, officers, employees and representatives from all claims growing out of lawful demands of subcontractors, laborers, workmen, mechanics, material men, and furnishers of machinery and parts thereof, equipment, power tools, and all supplies, including commissary, incurred in performance of this Contract.
- 4. At Department's request, Contractor shall furnish satisfactory evidence that all obligations of nature designated above have been paid, discharged or waived.

N. Acceptance of Final Payment as Release.

- 1. Making of final payment shall constitute waiver of all claims by County except those arising from:
 - a) Unsettled lien;
 - b) Faulty or defective work appearing after substantial completion;
 - c) Failure of the Work to comply with requirements of Construction Documents; or
 - d) Terms of any special guarantees required by Construction Documents.
- 2. Acceptance of final payment shall constitute waiver of all claims by Contractor.
- O. Lien Waivers. Contractor warrants that title to all work covered by application for Payment will pass to County no later than time of payment. Contractor further warrants that upon submittal of Application for Payment all work for which Certificates for Payment have been previously issued and payments received from County shall, to best of Contractor's knowledge, information and belief, be free and clear of liens, claims, security interests or encumbrances in favor of Contractor, subcontractor, material suppliers, or other persons or entities making claim by reason of having provide labor, materials and equipment related to the Work.
- P. Use and Occupancy Prior to Acceptance. Contractor agrees to use and occupancy of portion or unit of project before formal acceptance by Department, provided Department:
 - 1. Secures written consent of Contractor; except when in opinion of Department's Waste & Renewables Project Manager, Contractor is chargeable with unwarranted delay in final cleanup of punch list items or other Contract requirements;
 - 2. Secures endorsement from insurance carrier and consent of Surety permitting occupancy of building or use of project during remaining period of construction, or, secures consent of Surety;
 - 3. Assumes all costs and maintenance of heat, electricity and water; and
 - 4. Accepts all work completed within that portion or unit of project to be occupied, at time of occupancy.

O. Correction of Work.

- 1. All work, all materials whether incorporated in the Work or not, and all processes of manufacture shall at all times and places be subject to inspection of Waste & Renewables Project Manager who shall be judge of quality and suitability of work, materials, and processes of manufacture for purposes for which they are used. Should they fail to meet Waste & Renewables Project Manager's approval they shall be reconstructed, made good, replaced or corrected, as case may be, by Contractor at Contractor's expense. Rejected material shall immediately be removed from site.
- 2. If Contractor defaults or neglects to carry out the Work in accordance with Construction Documents or fails to perform any provision of Contract, Department may, after ten (10) business days written notice to Contractor and without prejudice to any other remedy County may have, make good such deficiencies. In such case, appropriate Change Order shall be issued deducting from payments then or thereafter due Contractor cost of correcting such deficiencies, including cost of additional services made necessary by such default, neglect or failure.

6. GENERAL GUARANTEE

A. Neither final certificate of payment nor any provision in Construction Documents nor partial or entire occupancy of premises by County shall constitute acceptance of work not done in

accordance with Construction Documents or relieve Contractor of liability in respect to any expressed warranties or responsibility for faulty materials or workmanship.

- 1. In no event shall making of any payment required by Contract constitute or be construed as waiver by County of any breach of covenants of Contract or waiver of any default of Contractor and making of any such payment by County while any such default or breach shall exist shall in no way impair or prejudice right of County with respect to recovery of damages or other remedy as result of such breach or default.
- B. Contractor shall remedy and make good all defective workmanship and materials and pay for any damage to other work resulting therefrom, which appear within period of one year from date of substantial completion, providing such defects are not clearly due to abuse or misuse by County. Department will give notice of observed defects with reasonable promptness.
- C. Guarantee on work executed after certified date of substantial completion will begin on date when such work is inspected and approved by Waste & Renewables Project Manager.
- D. Where guarantees or warrantees are required in sections of Construction Documents for periods in excess of one year, such longer terms shall apply; however, Contractor's Performance / Payment Bond shall not apply to any guarantee or warranty period in excess of one year.

7. IDENTICAL BIDDING

A. **Antitrust Laws.** All identical bids submitted to County because of advertised procurement for materials, supplies, equipment or services exceeding \$1,000,000.00 in total amount shall be reported to Attorney Generals of the United States and State of Wisconsin for possible violation and enforcement of antitrust laws.

8. BINDING CONTRACTS

A. Contract Commitment. Any contracts resulting from this bid shall be binding on successful bidder(s) to its conclusion and on its assigns, heirs, executors, administrators or successors.

9. AFFIRMATIVE ACTION PROVISION AND MINORITY / WOMEN / DISADVANTAGED BUSINESS ENTERPRISES

- A. Affirmative Action Provisions. During term of its Contract, Contractor agrees not to discriminate on basis of race, religion, color, sex, handicap, age, sexual preference, marital status, physical appearance, or national origin against any person, whether recipient of services (actual or potential), employee, or applicant for employment. Such equal opportunity shall include, but not be limited to following: employment, upgrading, demotion, transfer, recruitment, advertising, layoff, termination, training, rates of pay, and any other form of compensation or level of service(s). Contractor agrees to post in conspicuous places, available to all employees, service recipients and applicants for this paragraph. Listing of prohibited bases for discrimination shall no be construed to amend in any fashion state or federal law setting forth additional bases and exceptions shall be permitted only to extent allowable in state or federal law.
- B. Contractor is subject to this paragraph only if Contractor has twenty (20) or more employees and receives \$20,000.00 or more in annual aggregate contracts with County. Contractor shall file Affirmative Action Plan with Dane County Contract Compliance Specialist in accord with Chapter 19 of Dane County Code of Ordinances. Contractor must file such plan within

- fifteen (15) business days of effective date of this Contract and failure to do so by that date shall constitute grounds for immediate termination of Contract. During term of this Contract, Contractor shall also provide copies of all announcements of employment opportunities to County's Office of Equity & Inclusion, and shall report annually number of persons, by race, sex and handicap status, which apply for employment, and, similarly classified, number hired and number rejected.
- C. Contact Dane County Contract Compliance Specialist at Dane County Office of Equity & Inclusion, 210 Martin Luther King, Jr. Blvd., Room 356, Madison, WI 53703, 608/266-4192.
- D. In all solicitations for employment placed on Contractor's behalf during term of this Contract, Contractor shall include statement to effect that Contractor is "Equal Opportunity Employer."
- E. Contractor agrees to furnish all information and reports required by County's Contract Compliance Specialist as same relate to affirmative action and nondiscrimination, which may include any books, records, or accounts deemed appropriate to determine compliance whit Chapter 19, Dane County Code of Ordinances, and provision of this Contract.
- F. Minority / Women / Disadvantaged / Emerging Small Business Enterprises. Chapter 19.508 of Dane County Code of Ordinances is official policy of Dane County to utilize Minority Business Enterprises (MBEs), Women Business Enterprises (WBEs), Disadvantage Business Enterprises (DBEs) and Emerging Small Business Enterprises (ESBEs) fully.

10. COMPLIANCE WITH FAIR LABOR STANDARDS

- A. During term of this Contract, Contractor shall report to County Contract Compliance Specialist, within ten (10) business days, any allegations to, or findings by National Labor Relations Board (NLRB) or Wisconsin Employment Relations Commission (WERC) that Contractor has violated statute or regulation regarding labor standards or relations. If investigation by Contract Compliance Specialist results in final determination that matter adversely affects Contractor's responsibilities under this Contract, and which recommends termination, suspension or cancellation of this Contract, County may take such action.
- B. Contractor may appeal any adverse finding by Contract Compliance Specialist as set forth in Dane County Ordinance 25.015(11)(c) through (e).
- C. Contractor shall post this statement in prominent place visible to employees: "As condition of receiving and maintaining contract with Dane County, this employer shall comply with federal, state and all other applicable laws prohibiting retaliation or union organizing."

11. DOMESTIC PARTNERSHIP BENEFITS

A. Not Used.

12. INSURANCE REQUIREMENTS

A. Contractor shall indemnify, hold harmless and defend Dane County, its boards, commissions, agencies, officers, employees and representatives from and against all claims, damages, losses and expenses including attorneys' fees arising out of or resulting from performance of the Work, provided that any such claim, damage, loss or expense is attributable to bodily injury, sickness, disease or death, or to injury to or destruction of tangible property (other than the Work itself) including loss of use resulting there from, and is caused in whole or in

- part by any act or omission of Contractor, any subcontractor, anyone directly or indirectly employed by any of them or anyone for whose acts any of them may be liable, regardless of whether or not it is caused in part by a part indemnified hereunder.
- B. In any and all claims against Dane County, its boards, commissions, agencies, officers, employees and representatives or by any employee of Contractor, any subcontractor, anyone directly or indirectly employed by any of them or anyone for whose acts any of them may be liable, indemnification obligation under this Contract shall not be limited in any way by any limitation on amount or type of damages, compensation or benefits payable by or for Contractor or any subcontractor under worker's compensation acts, disability benefits or other employee benefit acts.
- C. Obligations of Contractor under this Contract shall not extend to liability of Department, its agents or employees arising out of (1) preparation or approval of maps, drawings, opinion, reports, surveys, change orders, designs or specifications; or (2) giving of or failure to give directions or instruction by Department, its agents or employees provided such giving or failure to give is primary cause of injury or damage.
- D. County shall not be liable to Contractor for damages or delays resulting from work by third parties or by injunctions or other restraining orders obtained by third parties.
- E. Contractor Carried Insurance. In order to protect itself and County, Contractor shall not commence work under this Contract until obtaining all required insurance and County has approved such insurance. Contractor shall not allow any subcontractor to commence work on subcontract until insurance required of subcontractor has been so obtained and approved.
 - 1. Worker's Compensation Insurance Contractor shall procure and shall maintain during life of this Contract, Worker's Compensation Insurance as required by statute for all of its employees engaged in work at site of project under this Contract and, in case of such work sublet, Contractor shall require subcontractor similarly to provide Worker's Compensation Insurance for all of latter's employees to be engaged in such work unless such employees are covered by protection afforded by Contractor's Worker's Compensation Insurance.
 - 2. Contractor's Public Liability and Property Damage Insurance Contractor shall procure and maintain during life of this Contract, Contractor's Public Liability Insurance and Contractor's Property Damage Insurance in amount not less then \$1,000,000.00 per occurrence for bodily injury and death, and Contractor's Property Damage Insurance in amount not less than \$1,000,000.00 and shall be primary with Dane County as "Additional Insured".
 - 3. Auto Liability Insurance
 Contractor shall procure and maintain during life of this Contract, Comprehensive
 Automobile Liability Insurance covering owned, non-owned and hired automobiles for
 limits of not less than \$1,000,000.00 and shall be primary with Dane County as
 "Additional Insured".
- F. Contractor either (1) shall require each subcontractors to procure and to maintain during life of subcontract, subcontractor's Public Liability Property Damage Insurance, and Comprehensive Automobile Liability Insurance of type and in same amount specified in preceding paragraphs; or (2) insure that activities of subcontractors in their own policy.
- G. Contractor shall furnish County with certificates showing type, amount, class of operations covered, effective dates and dates of expiration of policies. Such certificates shall also

- contain substantially this statement: "Insurance covered by this certificate will not be canceled or materially altered, except after ten (10) business days written notice has been received by County."
- H. **Builder's Risk.** County shall provide Builder's Risk insurance coverage for its insurable interests in construction or renovation projects with completed value of \$1,000,000 or less. Therefore, if project completed value is more than \$1,000,000, Contractor shall obtain and maintain in force, at its own expense, Builder's Risk Insurance on all risks for amount equal to full completed value of covered structure or replacement value of alterations or additions. Any deductible shall not exceed \$25,000 for each loss. Policy shall include occupancy clause and list Dane County as loss payee.

END OF SECTION



Department of Public Works, Highway & Transportation

Public Works Engineering Division

Gerald J. Mandli, P.E.

Commissioner / Director

Deputy Director Todd Draper 608/266-4018

Joseph T. Parisi
County Executive

1919 Alliant Energy Center Way Madison, Wisconsin 53713 Fax: 608/267-1533 www.countyofdane.com/pwht/public_works.aspx

BEST VALUE CONTRACTING APPLICATION

CONTRACTORS / LICENSURE APPLICANTS

The Dane County Department of Public Works requires contractors & subcontractors to be a Best Value Contractor before being hired. Contractor & subcontractor application documents should be turned in immediately. Contractor approval or exemption must be complete prior to Bid Due Date / Time. All subcontractors must also be approved or prove their exemption before performing any work under a County contract. This document shall be completed, properly executed, along with the necessary attachments and additional information that the County requires for the protection and welfare of the public in the performance of a County contract.

Contractors or subcontractors of any tier who attain qualification status will retain that status for a period of two (2) years from the date of qualification. Contractors shall notify the Dane County Department of Public Works, Highway & Transportation within fifteen (15) days of any changes to its business or operations that are relevant to the application. Failure to do so could result in suspension, revocation of the contractor's qualification, debarment from County contracts for up to three (3) years and / or other sanctions available under the law.

No contracts will be awarded for construction work performed on Dane County projects unless the contractor is currently approved as a Wisconsin Trade Trainer or has applied for approval as an Apprenticeship Trade Trainer to the Wisconsin Department of Workforce Development and agrees to an acceptable apprenticeship program. If you are not currently approved as a Wisconsin Trade Trainer, or have not applied for approval as an Apprenticeship Trade Trainer, please contact the Department of Workforce Development - Bureau of Apprenticeship Standards at 608/266-3133 or visit their web site at: https://dwd.wisconsin.gov/apprenticeship/.

EXEMPTIONS

- Contractors who employ less than five (5) apprenticeable trade workers are not required to qualify.
- Contractors performing work that does not apply to an apprenticeable trade, as outlined in Appendix A.
- The contractor / subcontractor provides sufficient documentation to demonstrate one or more of the following:
 - o apprentices are not available in a specific geographic area;
 - o the applicable apprenticeship program is unsuitable or unavailable; or
 - o there is a documented depression of the local construction market which prevents compliance.

SEC.	PROOF OF RESPONSIBILITY	CHECK IF APPLICABLE
1	Does your firm possesses all technical qualifications and resources,	
	including equipment, personnel and financial resources, necessary to	
	perform the work required for any project or obtain the same through	Yes: No:
	the use of responsible, qualified subcontractors?	
2	Will your firm possess all valid, effective licenses, registrations or	
	certificates required by federal, state, county, or local law, which are	
	necessary for the type of work to be performed including, but not	Yes: No:
	limited to, those for any type of trade work or specialty work?	
3	Will your firm meet all bonding requirements as required by applicable	w D
	law or contract specifications?	Yes: No: No:
4	Will your firm meet all insurance requirements as required by	
	applicable law or specifications, including general liability insurance,	X N.
	workers compensation insurance and unemployment insurance	Yes: No:
	requirements?	
5	Will your firm maintain a substance abuse policy for employees hired	Voc.
	for public works contracts that comply with Wis. Stats. Sec. 103.503?	Yes: No:
6	Will your firm fully abide by the equal opportunity and affirmative	
	action requirements of all applicable laws, including County	Yes: No:
	ordinances?	
7	In the past three (3) years, has your firm had control or has another	
	corporation, partnership or other business entity operating in the	Yes: No:
	construction industry controlled it? If so, please attach a statement	If Yes, attach details.
_	explaining the nature of the firm relationship?	
8	In the past three (3) years, has your firm had any type of business,	Yes: No:
	contracting or trade license, certification or registration revoked or	If Yes, attach details.
	suspended?	Tros, actaon details.
9	In the past three (3) years, has your firm been debarred by any federal,	Yes: No:
10	state or local government agency?	If Yes, attach details.
10	In the past three (3) years, has your firm defaulted or failed to complete	Yes: No:
1.1	any contract?	If Yes, attach details.
11	In the past three (3) years, has your firm committed a willful violation	Yes: No:
	of federal, state or local government safety laws as determined by a	If Yes, attach details.
12	final decision of a court or government agency authority.	
12	In the past three (3) years, has your firm been in violation of any law relating to your contracting business where the penalty for such	Yes: No:
	violation resulted in the imposition of a penalty greater than \$10,000?	If Yes, attach details.
13	Is your firm an active Wisconsin Trade Trainer as determined by the	
1.5	Wisconsin Bureau of Apprenticeship Standards?	Yes: No:
14	Is your firm exempt from being qualified with Dane County?	
17	15 Jour IIIII exempt from boing quantied with Dane County!	Yes: No: No:
1.5		If Yes, attach reason for exemption.
15	Does your firm acknowledge that in doing work under any County	
	Public Works Contract, it will be required to use as subcontractors only	Yes: No:
	those contractors that are also qualified with the County or become so	
1.6	within five (5) days after the Bid Due Date?	
16	Contractor has been in business less than one year?	Yes: No:
17	Is your firm a first time Contractor requesting a one time exemption,	
	but, intend to comply on all future contracts and are taking steps	Yes: No:
	typical of a "good faith" effort?	100.
	1 At	

SIGNATURE SECTION

Your firm's Officer, or the individual who would sign a bid and / or contract documents must sign this document.

I do hereby certify that all statements herein contained are true and correct to the best of my knowledge:

Signature:	
(A _I	pplication is invalid without signature)
Print Name:	Date:
Title:	

NAME AND ADDRESS OF CONTRACTOR	
Name of Firm:	
Address:	
City, State, Zip:	
Phone Number:	
Fax Number:	
E-mail Address:	

REMEMBER!

RETURN ALL TO FORMS AND ATTACHMENTS, OR QUESTIONS TO:

TODD DRAPER EMAIL: DRAPER@COUNTYOFDANE.COM OFFICE: (608) 267-0119, FAX: (608) 267-1533

DANE COUNTY DEPARTMENT OF PUBLIC WORKS, HGHWAY & TRANSPORTATION 1919 ALLIANT ENERGY CENTER WAY MADISON, WI 53713

rev. 07/2020 00 73 07 - 3

APPENDIX A

APPRENTICEABLE TRADES:

- Bricklayer
- Carpenter
- Cement Mason (Concrete Finisher)
- Cement Mason (Heavy Highway)
- Construction Craft Laborer
- Data Communications Installer
- Electrician
- Elevator Mechanic / Technician
- Environmental Systems Technician / HVAC Service Technician / HVAC Install & Service
- Glazier
- Heavy Equipment Operator / Operating Engineer
- Insulation Worker (Heat & Frost)
- Iron Worker (Assembler, Metal Buildings)
- Painter / Decorator
- Plasterer
- Plumber
- Roofer / Waterproofer
- Sheet Metal Worker
- Sprinkler Fitter
- Steamfitter (Service & Refrigeration)
- Taper & Finisher
- Telecommunications (Voice, Data & Video) Installer / Technician
- Tile Setter

END OF SECTION

SECTION 00 73 11

FAIR LABOR PRACTICES CERTIFICATION

The undersigned, for and on behalf of the BIDDER, APPLICANT or PROPOSER named herein, certifies as follows:

A. That he or she is an officer or duly authorized agent of the above-referenced BIDDER, APPLICANT or PROPOSER, which has a submitted a bid, application or proposal for a contract or agreement with the county of Dane.

B. That BIDDER, APPLICANT or PROPOSER has (check one):

______ not been found by the National Labor Relations Board ("NLRB") or the Wisconsin Employment Relations Commission ("WERC") to have violated any statute or regulation regarding labor standards or relations in the seven years prior to the signature date of this Certification.

______ been found by the National Labor Relations Board ("NLRB") or the Wisconsin Employment Relations Commission ("WERC") to have violated any statute or regulation regarding labor standards or relations in the seven years prior to the signature date of this Certification.

Officer or Authorized Agent Signature

Date

NOTE: You can find information regarding the violations described above at: www.nlrb.gov and www.nlrb.gov

For reference, Dane County Ordinance 25.09 is as follows:

Printed or Typed Name and Title

Printed or Typed Business Name

(1) BIDDER RESPONSIBILITY. (a) Any bid, application or proposal for any contract with the county, including public works contracts regulated under chapter 40, shall include a certification indicating whether the bidder has been found by the National Labor Relations Board (NLRB) or the Wisconsin Employment Relations Committee (WERC) to have violated any statute or regulation regarding labor standards or relations within the last seven years. The Controller shall investigate any such finding and make a recommendation to the committee, which shall determine whether the conduct resulting in the finding affects the bidder's responsibility to perform the contract.

If you indicated that the NLRB or WERC have found you to have such a violation, you must include copies of any relevant information regarding such violation with your proposal, bid or application.

Include this completed Certification with your bid, application or proposal.

END OF SECTION

Bid No. 320027 Fair Labor Practices Certification rev. 10/19 00 73 11 - 1

SECTION 01 00 00

GENERAL REQUIREMENTS

PART 1 GENERAL

1.1 SUMMARY

A	α	т '	1 1
Α.	Section	ınc	ludes:

- 1. Summary
- 2. Summary of the Work
- 3. Contractor Use of Premises
- 4. Applications for Payment
- 5. Change Procedures
- 6. Alternates
- 7. Coordination
- 8. Cutting and Patching
- 9. Conferences
- 10. Progress Meetings
- 11. Submittal Procedures
- 12. Proposed Products List
- 13. Shop Drawings
- 14. Product Data
- 15. Samples
- 16. Manufacturers' Instructions
- 17. Manufacturers' Certificates
- 18. Quality Assurance / Quality Control of Installation
- 19. References
- 20. Interior Enclosures
- 21. Protection of Installed Work
- 22. Parking
- 23. Staging Areas
- 24. Occupancy During Construction and Conduct of Work
- 25. Protection
- 26. Progress Cleaning
- 27. Products
- 28. Transportation, Handling, Storage and Protection
- 29. Product Options
- 30. Substitutions
- 31. Starting Systems
- 32. Demonstration and Instructions
- 33. Contract Closeout Procedures
- 34. Final Cleaning
- 35. Adjusting
- 36. Operation and Maintenance Manual
- 37. Spare Parts and Maintenance Materials
- 38. As-Built and Record Drawings and Specifications

1.2 SUMMARY OF THE WORK

- A. Project Description: Perform the Work as outlined below and specified and detailed in Construction Documents package.
 - Provide and Install new LAARS Neo Therm 600 MBH condensing boiler or equivalent approved by Waste & Renewables Project Manager.
 - a. Natural gas fired with modulation down to 20%
 - b. Stainless steel heat exchanger with a minimum 10 year warranty
 - c. Honeywell Sola touch screen programmer.
 - d. Boiler meets FM and UL/CSD-1 Codes.
 - Provide and install 4-inch concrete pad under boiler.
 - Provide and install natural gas piping (tie into existing overhead natural gas lines within mezzanine).
 - Provide and install new vent piping with sidewall termination (west wall, can retrofit existing 8-inch penetration if desired).
 - Provide and install new fresh air piping from inside the building to the boiler (horizontal intake, minimum 8-feet above grade).
 - Provide, install, and insulate new supply and return piping and isolation valves (One isolation valve each on new supply and return piping, one isolation valve on existing supply piping, existing piping overhead from proposed boiler location).
 - Provide and install four temperature probe wells (two temperature probe wells each on new supply and return piping).
 - Provide and install two thermometers (one thermometer each on new supply and return piping).
 - Provide and install new drain piping along with a condensate acid neutralizer kit.
 - Provide and install conduit and electrical wiring, including all terminations (existing circuit on south wall adjacent to boiler install).
 - Provide a full factory startup and commissioning, to include combustion analysis and firing rate adjustments
- B. Work by Owner: Not applicable.
- C. Permits: Prior to commencement of the Work, Contractor to secure any and all necessary permits for completion of the Work and facility occupancy. Provide Waste & Renewables Project Manager with copies of all permits.

1.3 CONTRACTOR USE OF PREMISES

- A. Limit use of premises to allow work by others and work by Owner.
- B. Coordinate utility outages and shutdowns with Owner.
- C. Contractors or Subcontractors shall not visit the site if they are or have recently been ill.

1.4 APPLICATIONS FOR PAYMENT

- A. Submit each Application for Payment on AIA G702TM and G703TM forms or approved contractors invoice form. Contractor shall have these forms notarized and signed.
- B. Content and Format: Utilize Schedule of Values for listing items in Application for Payment.
- C. Payment Period: Monthly.
- D. Submit Applications for Payment to Waste & Renewables Project Manager for approval & processing for payment.

1.5 CHANGE PROCEDURES

A. Contractor's costs for Products, delivery, installation, labor, insurance, payroll, taxes, bonding, equipment rental, overhead and profit will be included in Change Orders authorizing expenditure of funds from contingency allowance.

1.6 ALTERNATES

- A. Alternates quoted on Bid Form shall be reviewed and accepted or rejected at Owner's option.
- B. Coordinate related work and modify surrounding work as required.
- C. Schedule of Alternates: there are no alternates proposed for this project.

1.7 COORDINATION

- A. Coordinate scheduling, submittals, and work of various sections of Specifications to assure efficient and orderly sequence of installation of interdependent construction elements.
- B. Verify utility requirement characteristics of operating equipment are compatible with building utilities.
- C. Coordinate space requirements and installation of mechanical and electrical work that are indicated diagrammatically on Drawings.

- D. Contractor shall provide Waste & Renewables Project Manager with work plan that ensures the Work will be completed within required time of completion.
- E. Construct work to accommodate Dane County Clean Sweep operations.
- F. Waste & Renewables Project Manager may choose to photograph or videotape site or workers as the Work progresses.

1.8 CUTTING AND PATCHING

- A. Employ skilled and experienced installer to perform cutting and patching new work; restore work with new Products.
- B. Submit written request in advance of cutting or altering structural or building enclosure elements.
- C. Fit work tight to adjacent elements. Maintain integrity of wall, ceiling, or floor construction; completely seal voids.
- D. Refinish surfaces to match adjacent finishes.

1.9 CONFERENCES

- A. Project shall have pre-bid conference; see Instructions to Bidders.
- B. Contractor shall submit Construction Schedule at pre-construction meeting.
- C. When required in individual Specification section, convene pre-installation conference at project site prior to commencing work of Section.
- D. Safe distancing & face masks are required for all conference attendees. Please limit number of attending staff & subcontractors.

1.10 PROGRESS MEETINGS

- A. Day & time of progress meetings to be determined at pre-construction meeting.
- B. Owner shall schedule and administer meetings throughout progress of the Work at minimum of one (1) per week.
- C. Owner shall preside at meetings, record minutes, and distribute copies within two (2) business days to those affected by decisions made.
- D. Attendance at progress meetings by General Contractor, subcontractors, or their authorized representative, is mandatory.
- E. Contractors shall give verbal reports of progress on the Work, discuss schedule for upcoming period and present all conflicts, discrepancies or other difficulties for resolution.

F. In-person meetings shall be limited & shall follow current *Public Health - Madison & Dane County* procedures & recommendations (see publichealthmdc.com/documents/office_space_checklist.pdf and publichealthmdc.com/coronavirus/forward-dane/current-order). Whenever possible, meetings shall be held via teleconference or videoconference, to be hosted by contractor or consultant. Dane County reserves right to mandate safe physical distancing & use of face masks by all personnel while inside any County facility or on any County grounds.

1.11 SUBMITTAL PROCEDURES

- A. Submittal form to identify Project, Contractor, Subcontractor or supplier; and pertinent Construction Documents references.
- B. Apply Contractor's stamp, signed or initialed, certifying that review, verification of Products required, field dimensions, adjacent construction work, and coordination of information is in accordance with requirements of the Work and Construction Documents.
- C. Identify variations from Construction Documents and Product or system limitations that may be detrimental to successful performance of completing the Work.
- D. Revise and resubmit submittals as required; identify all changes made since previous submittal.

1.12 PROPOSED PRODUCTS LIST

A. Within fifteen (15) business days after date of Award of Contract, submit complete list of major Products proposed for use, with name of manufacturer, trade name, and model number of each Product.

1.13 SHOP DRAWINGS

A. Submit number of copies that Contractor requires, plus three (3) copies that shall be retained by Waste & Renewables Project Manager.

1.14 PRODUCT DATA

- A. Submit number of copies that Contractor requires, plus two (2) copies that shall be retained by Waste & Renewables Project Manager.
- B. Mark each copy to identify applicable products, models, options, and other data.

 Supplement manufacturer's standard data to provide information unique to this Project.

1.15 SAMPLES

- A. Submit samples to illustrate functional and aesthetic characteristics of Product.
- B. Submit samples of finishes from full range of manufacturers' standard colors, textures, and patterns for Waste & Renewables Project Manager's selection.

1.16 MANUFACTURERS' INSTRUCTIONS

A. When specified in individual Specification sections, submit manufacturers' printed instructions for delivery, storage, assembly, installation, start-up, adjusting, and finishing, in quantities specified for Product Data.

1.17 MANUFACTURERS' CERTIFICATES

- A. When specified in individual Specification sections, submit manufacturers' certificate to Waste & Renewables Project Manager for review, in quantities specified for Product Data.
- B. Indicate material or Product conforms to or exceeds specified requirements. Submit supporting reference data, affidavits, and certifications as appropriate.

1.18 QUALITY ASSURANCE / QUALITY CONTROL OF INSTALLATION

- A. Monitor quality control over suppliers, manufacturers, Products, services, site conditions, and workmanship, to produce work of specified quality.
- B. Comply fully with manufacturers' instructions.
- C. Comply with specified standards as minimum quality for the Work except when more stringent tolerances, codes, or specified requirements indicate higher standards or more precise workmanship.

1.19 REFERENCES

- A. Conform to reference standard by date of issue current as of date for receiving bids.
- B. Should specified reference standard conflict with Construction Documents, request clarification from Waste & Renewables Project Manager before proceeding.

1.20 INTERIOR ENCLOSURES

A. Provide temporary partitions as required to separate work areas from Owner occupied areas, to prevent distribution of dust and moisture into Owner occupied areas, and to prevent damage to existing materials and equipment.

1.21 PROTECTION OF INSTALLED WORK

A. Protect installed work and provide special protection where specified in individual Specification sections.

1.22 PARKING

A. Coordinate temporary parking areas with Waste & Renewables Project Manager to accommodate construction personnel.

- B. All contractors and their employees shall cooperate with General Contractor and others in parking of vehicles to avoid interference with normal operations and construction activities.
- C. Do not obstruct existing service drives and parking lots with equipment, materials and / or vehicles. Keep accessible for Owner's use at all times.

1.23 STAGING AREAS

- A. Coordinate staging areas with Waste & Renewables Project Manager prior to starting the Work.
- B. On-site space for use as staging areas and storage of materials is limited and will be apportioned among various Contractors as their needs dictate with due regard for storage requirements of each Contractor. Each Contractor shall be responsible for safety of equipment and materials that are stored on site.

1.24 OCCUPANCY DURING CONSTRUCTION AND CONDUCT OF WORK

- A. Contractors are asked to not work at facility if they are ill with something contagious.
- B. All contractors are expected to leave work areas in conditions; such that area can be occupied immediately upon leaving area.
- C. Smoking is prohibited on Dane County property.
- D. Owner reserves right at any time to dismiss from premises any Contractor or construction personnel that do not uphold requirements of this Section.
- E. Owner shall not be held liable for any lost time, wages, or impacts to construction schedule by any Contractor or construction personnel dismissed for failure to uphold requirements of this Section.
- F. Areas of existing facility will be occupied during period when the Work is in progress. Work may be done during normal business hours (7:00 am to 2:45 pm), but confer with Owner, schedule work and store materials so as to interfere as little as possible with normal use of premises.
- G. Work shall be done and temporary facilities furnished so as not to interfere with access to any occupied area and so as to cause least possible interference with normal operation of facility or any essential service thereof.
- H. Contractor shall, at all times, provide approved, safe walkways and facility entrances for use by Owner, employees and public.
- I. Contractor shall provide adequate protection for all parts of facility, its contents and occupants wherever the Work under this Contract is to be performed.

- J. Each Contractor shall arrange with Owner to make necessary alterations, do new work, make connections to all utilities, etc., and at such times as will not cause interruption of utility services to facility. Contractor doing this work shall protect, cap, cut off and / or replace and relocate existing pipes, electrical work and other active utilities encountered which may interfere with new construction work.
- K. New work in extension of existing work shall correspond in all respects with that to which it connects or similar existing work unless otherwise indicated or specified.
 - 1. Existing work shall be cut, altered, removed or replaced as necessary for performance of Contract obligations.
 - 2. Work remaining in place, damaged or defaced by reason of work done under this Contract shall be restored equal to its condition at time of Award of Contract.
 - 3. If removal of work exposes discolored or unfinished surfaces or work out of alignment, such surfaces shall be refinished or materials replaced as necessary to make continuous work uniform and harmonious.
- L. Contractor is not responsible for providing & maintaining temporary toilet facilities.
- M. Contractor & subcontractors shall follow all current *Public Health Madison & Dane County* procedures & recommendations (see publichealthmdc.com/documents/office_space_checklist.pdf and publichealthmdc.com/coronavirus/forward-dane/current-order). Dane County reserves right to mandate safe physical distancing & use of face masks by all personnel while inside any County facility or on any County grounds.

1.25 PROTECTION

A. Contractor shall protect from damage / injury all mechanical, electrical & plumbing equipment and pay for any damage to same resulting from insufficient or improper protection.

1.26 PROGRESS CLEANING

A. Maintain areas free of waste materials, debris, and rubbish. Maintain site in clean and orderly condition.

1.27 PRODUCTS

- A. Products: Means new material, machinery, components, equipment, fixtures, and systems forming the Work, but does not include machinery and equipment used for preparation, fabrication, conveying and erection of the Work. Products may also include existing materials or components specifically identified for reuse.
- B. Do not use materials and equipment removed from existing premises, except as specifically identified or allowed by Construction Documents.

1.28 TRANSPORTATION, HANDLING, STORAGE AND PROTECTION

A. Transport, handle, store and protect Products in accordance with manufacturer's instructions.

1.29 PRODUCT OPTIONS

- A. Where definite material is specified, it is not intentional to discriminate against "equal" product made by another manufacturer. Intention is to set definite standard of material quality. Should bidder choose to bid materials other than those specified, bidder shall submit said materials specifications to [Public Works, Waste & Renewables] Project Manager for approval at least seven (7) business days prior to Bid Due Date.
- B. Products and materials that are not specified, but have been approved for use by [Public Works, Waste & Renewables] Project Manager shall be identified in addenda to all bidding contractors.
- C. Requests for material or product substitutions submitted after Bid Due Date shall not be considered. Owner reserves right to approve or reject substitutions based on Specification requirements and intended use.

1.30 SUBSTITUTIONS

- A. Waste & Renewables Project Manager shall consider requests for Substitutions only up to eleven (11) business days prior to date of Bid Due Date.
- B. Document each request with complete data substantiating compliance of proposed Substitution with Construction Documents.
- C. Submit three (3) copies of requests for Substitution for consideration. Limit each request to one (1) proposed Substitution.
- D. Substitutions shall not change contract price established at Bid Due Date.

1.31 STARTING SYSTEMS

- A. Provide written notification prior to start-up of each equipment item or system.
- B. Ensure that each piece of equipment or system is ready for operation.
- C. Execute start-up under supervision of responsible persons in accordance with manufacturers' instructions.
- D. Submit written report that equipment or system has been properly installed and is functioning correctly.

1.32 DEMONSTRATION AND INSTRUCTIONS

- A. Demonstrate operation and maintenance of Products to Owner's personnel prior to date of final inspection.
- B. Demonstrate start-up, operation, control, adjustment, trouble-shooting, servicing, maintenance, and shutdown of each item of equipment at agreed-upon times, at designated location.
- C. Owner may choose to photograph or videotape demonstration session; demonstration and demonstrator shall be to level of satisfaction of Owner.

1.33 CONTRACT CLOSEOUT PROCEDURES

- A. Submit written certification that Construction Documents have been reviewed, the Work has been inspected, and the Work is complete in accordance with Construction Documents and ready for Waste & Renewables Project Manager's inspection.
- B. Submit final Application for Payment identifying total adjusted Contract Sum / Price, previous payments, and amount remaining due.

1.34 FINAL CLEANING

- A. Execute final cleaning prior to final inspection.
- B. Clean interior and exterior surfaces exposed to view.
- C. Remove waste and surplus materials, rubbish, and construction facilities from site.

1.35 ADJUSTING

A. Adjust operating Products and equipment to ensure smooth and unhindered operation.

1.36 OPERATION AND MAINTENANCE MANUAL

A. Provide two (2) bound, hard-copy operation and maintenance manuals that include all systems, materials, products, equipment, mechanical and electrical equipment and systems supplied and installed in the Work. Provide electronic version of operation and maintenance manual also.

1.37 SPARE PARTS AND MAINTENANCE MATERIALS

- A. Provide Products, spare parts, maintenance and extra materials in quantities specified in individual Specification Sections.
- B. Deliver to the Work site and place in location as directed.

1.38 AS-BUILT AND RECORD DRAWINGS AND SPECIFICATIONS

A. Contractor-produced Drawings and Specifications shall remain property of Contractor whether Project for which they are made is executed or not. Contractor shall furnish Waste & Renewables Project Manager with original marked up redlines of Construction Documents' drawings and specifications that shall include all Addendums, Change Orders, Construction Bulletins, on-site changes, field corrections, etc. These are project As-Built Drawings & Specifications.

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Not Used.

PART 3 EXECUTION

Not Used.

END OF SECTION

SECTION 01 74 19

CONSTRUCTION WASTE MANAGEMENT, DISPOSAL & RECYCLING

PART 1 GENERAL

1.1 SUMMARY

- A. Section Includes:
 - 1. Summary
 - 2. Waste Management Goals
 - 3. Construction and / or Demolition Waste Management
 - 4. Waste Management Plan
 - 5. Reuse
 - 6. Recycling
 - 7. Materials Sorting and Storage On Site
 - 8. Lists of Recycling Facilities Processors and Haulers
 - 9. Waste Management Plan Form

B. Related Sections:

1. Section 01 00 00 - General Requirements

1.2 WASTE MANAGEMENT GOALS

A. Dane County requires that as many waste materials as possible produced as result of this project be salvaged, reused or recycled in order to minimize impact of construction waste on landfills and to minimize expenditure of energy and cost in fabricating new materials. Additional information may be found in Dane County Green Building Policy, Resolution 299, 1999-2000.

1.3 CONSTRUCTION AND / OR DEMOLITION WASTE MANAGEMENT

- A. All construction and demolition waste suitable for recycling must go to Dane County Construction & Demolition Recycling Facility located at 7102 US Hwy 12, Madison, located across from Yahara Hills Golf Course. This facility can receive mixed loads of construction and demolition waste. For complete list of acceptable materials see

 www.countyofdane.com/pwht/recycle/CD_Recycle.aspx.
- B. Dane County Landfill, also at 7102 US Hwy 12, Madison, must receive all other waste from this project. www.countyofdane.com/pwht/recycle/landfill.aspx.

1.4 WASTE MANAGEMENT PLAN

- A. Contractor shall develop Waste Management Plan (WMP) for this project. Dane County's Special Projects & Materials Manager may be contacted with questions. Outlined in RECYCLING section of this specification are examples of materials that can be recycled or reused as well as recommendations for waste sorting methods.
- B. Contractor shall complete WMP and include cost of recycling / reuse in Bid. WMP will be submitted to Public Works Project Manager within fifteen 15

business days of Bid Due date. Copy of blank WMP form is in this Section. Submittal shall include cover letter and WMP form with:

- 1. Information on:
 - a. Types of waste materials produced as result of work performed on site;
 - b. Estimated quantities of waste produced;
 - c. Identification of materials with potential to be recycled or reused;
 - d. How materials will be recycled or reused;
 - e. On-site storage and separation requirements (on site containers);
 - f. Transportation methods; and
 - g. Destinations.

1.5 REUSE

A. Contractors and subcontractors are encouraged to reuse as many waste materials as possible. Salvage should be investigated for materials not reusable on site.

1.6 RECYCLING

- A. These materials must be recycled at Dane County Construction & Demolition Recycling Facility:
 - 1. Wood.
 - 2. Wood Pallets.
 - 3. PVC Plastic (pipe, siding, etc.).
 - 4. Asphalt & Concrete.
 - 5. Bricks & Masonry.
 - 6. Vinyl Siding.
 - 7. Cardboard.
 - 8. Metal.
 - 9. Unpainted Gypsum Drywall.
 - 10. Shingles.
- B. These materials can be recycled elsewhere in Dane County area:
 - 1. Fluorescent Lamps.
 - 2. Foam Insulation & Packaging (extruded and expanded).
 - 3. Carpet Padding.
 - 4. Barrels & Drums.
- C. All materials must be recycled at WDNR permitted waste processing facilities that adhere to all State Statutes.

1.7 MATERIALS SORTING AND STORAGE ON SITE

- A. Contractor shall provide separate containers for recyclable materials. Number of containers will be dependent upon project and site conditions.
- B. Contractor shall provide on-site locations for subcontractors supplied recycling containers to help facilitate recycling.
- C. Mixed loads of recycled materials are allowed only per instructions at www.countyofdane.com/pwht/recycle/CD_Recycle.aspx.

1.8 LISTS OF RECYCLING FACILITIES PROCESSORS AND HAULERS

- A. Refer to www.countyofdane.com/pwht/recycle/CD_Recycle.aspx for information on Dane County Construction & Demolition Recycling Facility.
- B. Web site www.countyofdane.com/pwht/recycle/categories.aspx lists current information for Dane County Recycling Markets. Contractors can also contact Allison Rathsack at 608/266-4990, or local city, village, town recycling staff listed at site www.countyofdane.com/pwht/recycle/contacts.aspx. Statewide listings of recycling / reuse markets are available from UW Extension at https://www.uwgb.edu/shwec/.

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Not Used.

PART 3 EXECUTION

Not Used.

END OF SECTION

WASTE MANAGEMENT PLAN FORM

STY OF DEL	Contractor Name:	
	Address:	
1339 ST	Phone No.:	Recycling Coordinator:

MATERIAL	ESTIMATED QUANTITY	DISPOSAL ME' (CHECK ON		RECYCLING / REUSE COMPANY OR DISPOSAL SITE
Salvaged &	cu. yds.	Recycled	Reused	
reused building materials	tons	Landfilled	Other	Name:
	cu. yds.	Recycled	Reused	
Wood	tons		Other	Name:
		Recycled	Reused	
Wood Pallets	units		Other	Name:
	cu. ft.	Recycled	Reused	
PVC Plastic	lbs.		Other	Name:
Asphalt &	cu. ft.	Recycled	Reused	
Concrete	lbs.		Other	Name:
Bricks &	cu. ft.	Recycled	Reused	
Masonry	lbs.		Other	Name:
	cu. ft.	Recycled	Reused	
Vinyl Siding	lbs.		Other	Name:
	cu. ft.	Recycled	Reused	
Cardboard	lbs.		Other	Name:
	cu. yds.	Recycled	Reused	
Metals	tons		Other	Name:
Unpainted	cu. yds.	Recycled	Reused	
Gypsum / Drywall	tons	Landfilled	Other	Name:
	cu. yds.	Recycled	Reused	
Shingles	tons	Landfilled	Other	Name:
Fluorescent	cu. ft.	Recycled	Reused	
Lamps	lbs.	Landfilled	Other	Name:
	cu. ft.	Recycled	Reused	
Foam Insulation	lbs.	Landfilled	Other	Name:
C	cu. ft.	Recycled	Reused	
Carpet Padding	lbs.	Landfilled	Other	Name:
Barrels & Drums		Recycled	Reused	
Daileis & Druins	units	Landfilled	Other	Name:
Glass	cu. yds.	Recycled	Reused	
U1433	tons	Landfilled	Other	Name:

WASTE MANAGEMENT PLAN FORM

Other	 RecycledReusedOther	Name:
Other	 RecycledReusedOther	Name:
Other	 RecycledReusedLandfilledOther	Name:
Other	 RecycledReusedLandfilledOther	Name:
Other	RecycledReusedLandfilledOther	Name:

Drawings for Reference Purposes Only

DANE COUNTY WASTE TRANSFER STATION AND

HOUSEHOLD HAZARDOUS WASTE FACILITY RODEFELD LANDFILL

7102 US HIGHWAY 12 & 18 MADISON, WISCONSIN



One Honey Creek Corporate Center 125 South 84th Street, Suite 401 Milwaukee, WI 53214-1470 414 / 259 1500 414 / 259 0037 fax

www.graef-usa.com

CONSULTANTS:

PROJECT TITLE:

DANE COUNTY WASTE TRANSFER STATION AND HOUSEHOLD HAZARDOUS WASTE FACILITY RODEFELD LANDFILL

BID SET

SUBMITTALS

05-11-2010


Clean Sweep Boiler to be


Installed in Mezzanine

(Upper) Level of Clean Sweep


Facilty

(Household Hazardous Waste)

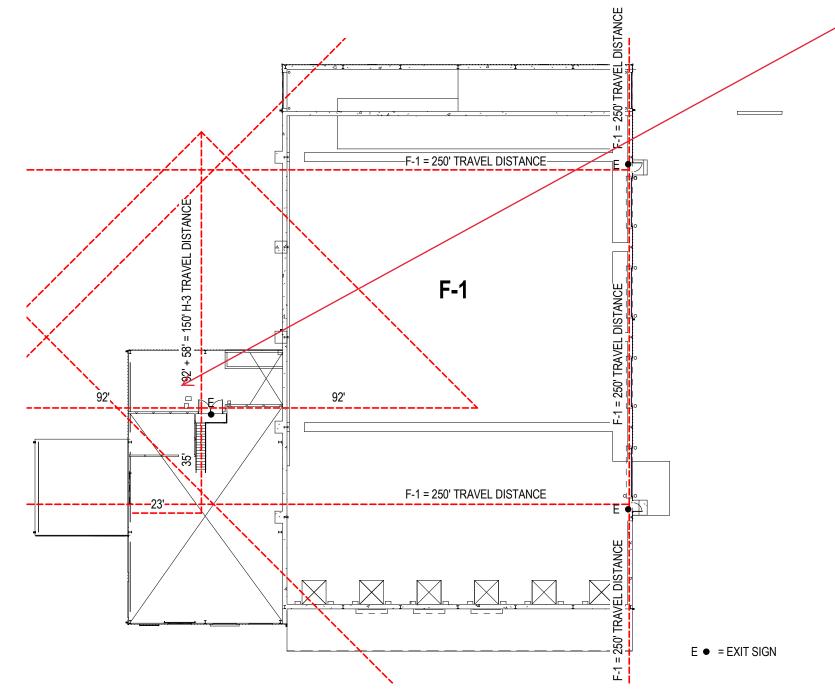

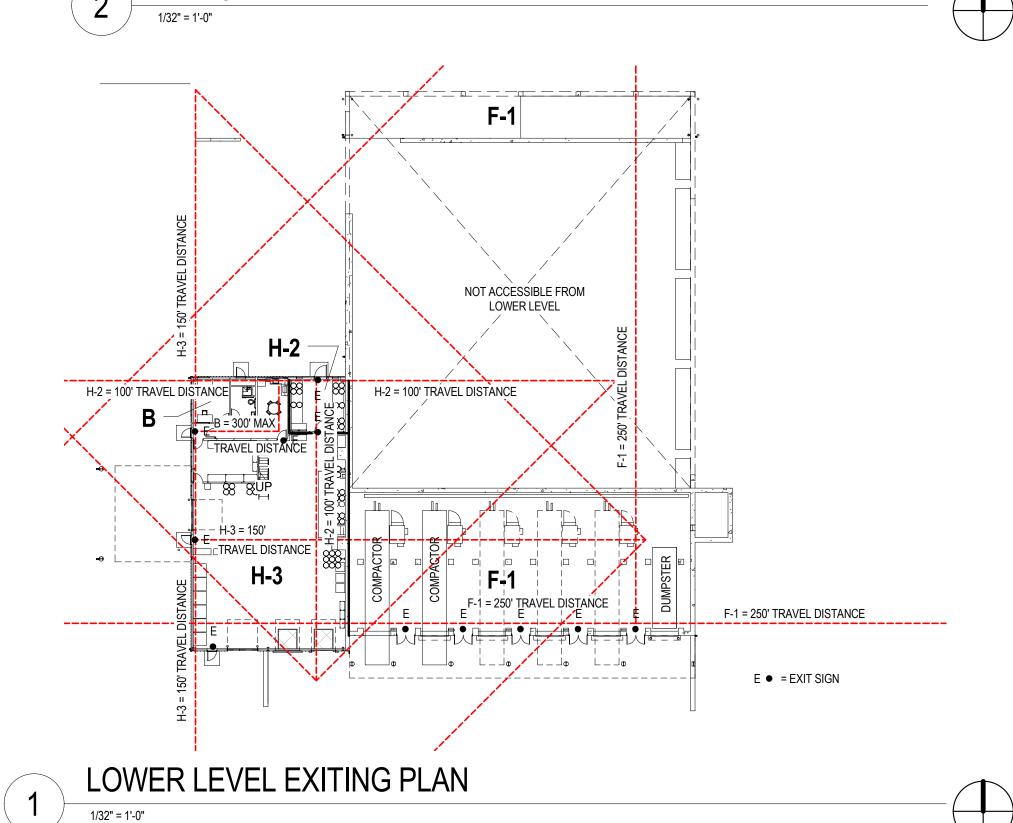

Exiting MEZZANINE / UPPER LEVEL EXITING PLAN

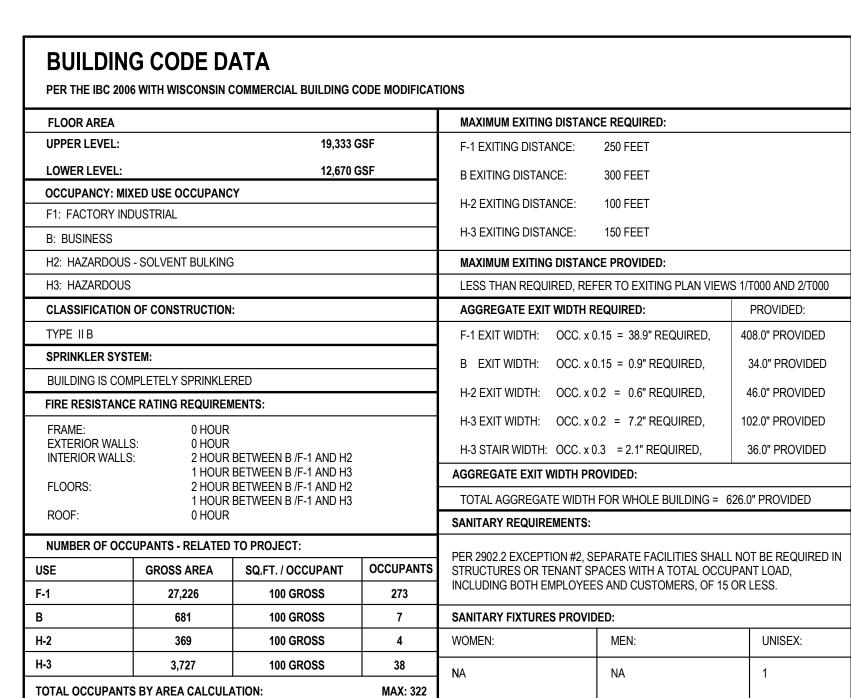

ACTUAL OCCUPANT TOTAL:

a Madis	on on			Cottage Grove
Bucke	90		A constructive and the second second	
		5	PROJECT LOCATION	
Monona 12	18	12	LOCATION	
		AB	12	
(51)	Sign	gelkow 90		
Lake Waubesa	IcFarland			

LOCATION MAP

SHEET NUMBER:

PROJECT INFORMATION

05-11-2010

AS NOTED

SHEET TITLE:

PROJECT NUMBER: 2009-0328.00

DATE:

SCALE:

CHECKED BY:

TITLE SHEET

APPROVED BY:

T000

CIVIL

C200 DEMOLITION AND EROSION CONTROL PLAN

C300 SITE AND LANDSCAPE PLAN

C400 GRADING PLAN

C500 UTILITY PLAN C700 JOINTING PLAN

C900 EROSION CONTROL DETAILS

C901 PAVING DETAILS

C902 UTILITY DETAILS

ARCHITECTURAL

C903 SITE DETAILS

HHW FIRST FLOOR PLAN/ WTS LOWER LEVEL PLAN

A102 HHW MEZZANINE PLAN / WTS UPPER LEVEL PLAN

A103 HHW FIRST FLOOR EQUIPMENT PLAN - FOR REFERENCE ONLY A121 ROOF PLAN

A300 BUILDING ELEVATIONS

BUILDING ELEVATIONS

A400 BUILDING SECTIONS

A401 BUILDING SECTIONS ENLARGED PARTIAL PLAN AND DETAILS

A600 DOOR SCHEDULE AND DOOR, WINDOW AND FRAME ELEVATIONS

STRUCTURAL

S000 GENERAL NOTES

S100 FOUNDATION PLAN

S101 STRUCTURAL UPPER LEVEL PLAN

S500 DETAILS

S501 DETAILS S502 DETAILS

MECHANICAL

M000 MECHANICAL SYMBOLS, ABBREVIATIONS AND SHEET INDEX

M201 HHW FIRST FLOOR / WTS LOWER LEVEL HVAC PLAN

M202 HHW MEZZANINE / WTS UPPER LEVEL HVAC PLAN

M203 GENERATOR BUILDING HVAC PLANS

M800 MECHANICAL DETAILS

M801 MECHANICAL DETAILS

M900 MECHANICAL SCHEDULES

ELECTRICAL

E000 ELECTRICAL SYMBOLS, ABBREVIATIONS AND SHEET INDEX

E001 SITE ELECTRICAL PLAN, LIGHTING FIXTURE SCHEDULE, AND DETAILS

E002 SITE PHOTOMETRIC PLAN

E101 HHW FIRST FLOOR / WTS LOWER LEVEL ELECTRICAL PLAN

E102 HHW MEZZANINE / WTS UPPER LEVEL ELECTRICAL PLAN

E103 HHW / WTS GROUNDING SYSTEM ELECTRICAL PLAN

E201 HHW FIRST FLOOR / WTS LOWER LEVEL SYSTEM PLAN

E202 HHW MEZZANINE / WTS UPPER LEVEL SYSTEM PLAN E401 ELECTRICAL SCHEDULES

E402 ELECTRICAL SCHEDULES & ONE-LINE DIAGRAMS

E500 ELECTRICAL DETAILS

PLUMBING

P000 PLUMBING SYMBOLS, ABBREVIATIONS & SCHEDULES

P100 HHW FIRST/ WTS LOWER LEVEL BELOW SLAB PLUMBING PLAN

P101 HHW FIRST/ WTS LOWER LEVEL PLUMBING PLAN

P102 HHW MEZZANINE /WTS UPPER LEVEL PLUMBING PLAN


P300 PLUMBING ISOMETRICS

P500 PLUMBING DETAILS

FIRE PROTECTION

FP101 HHW FIRST/ WTS LOWER LEVEL FIRE PROTECTION PLAN


FP102 HHW MEZZANINE/ WTS UPPER LEVEL FIRE PROTECTION PLAN

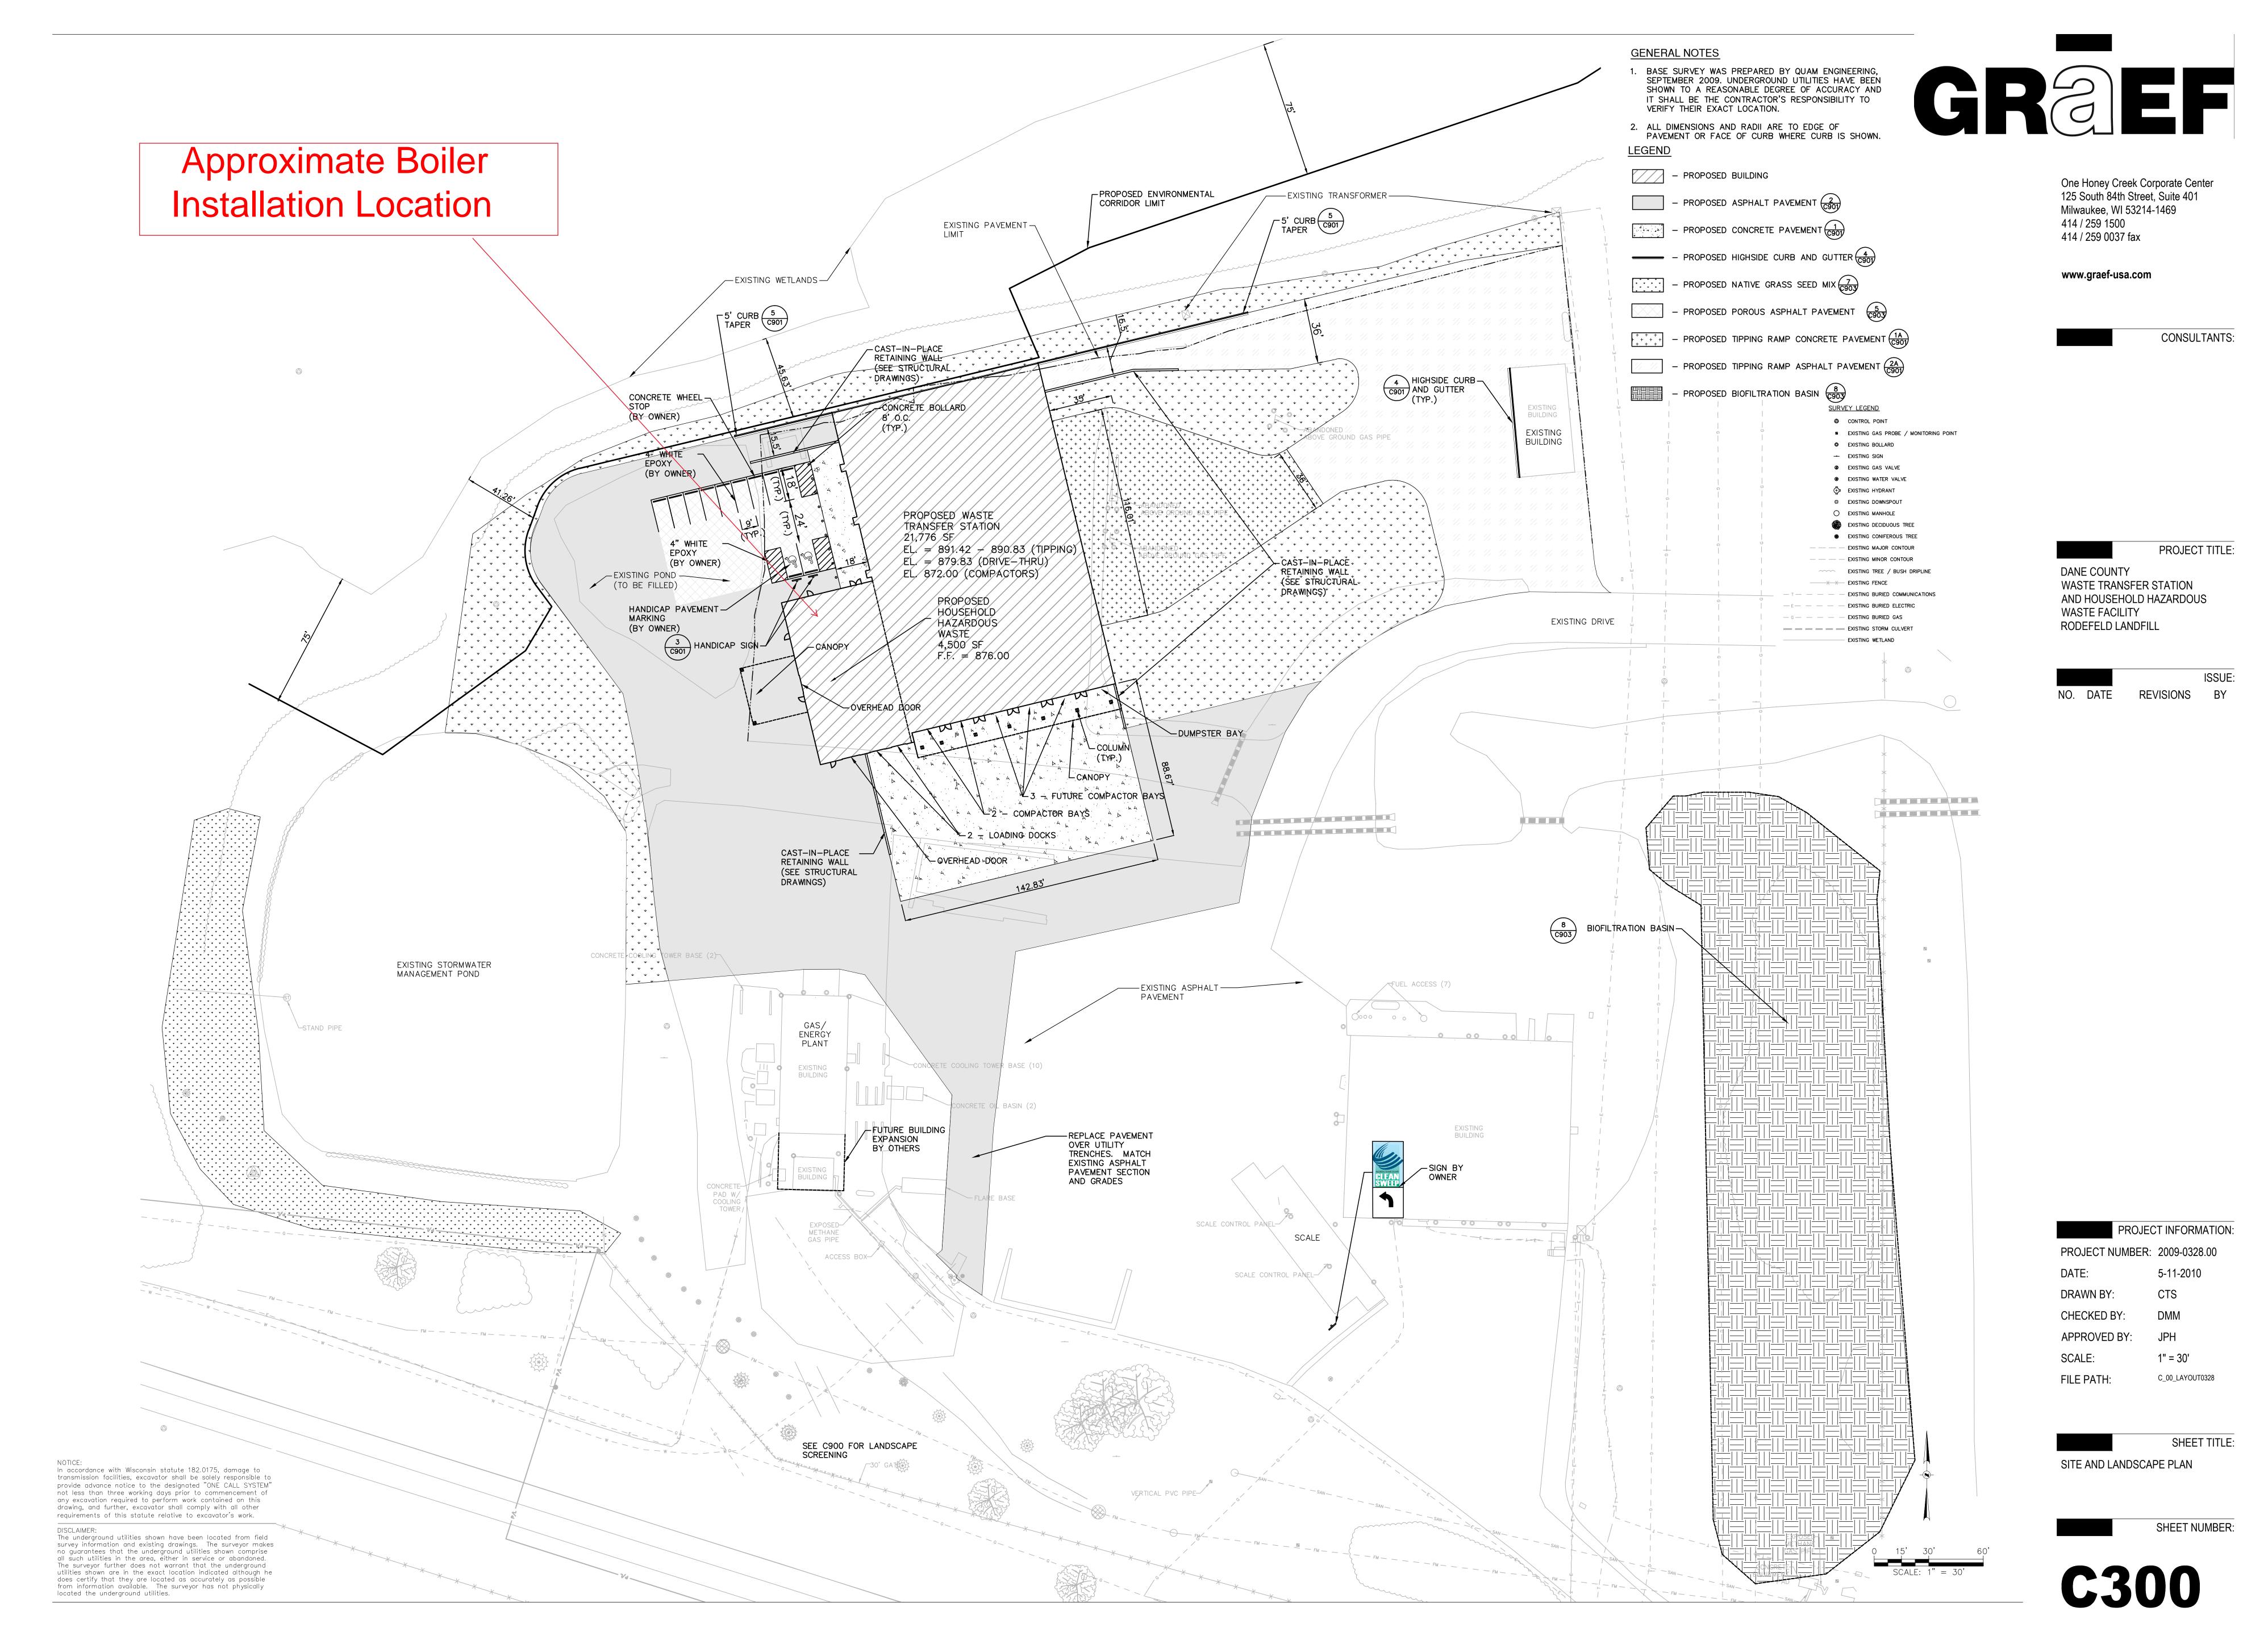



ELECTRICAL SYMBOLS AND ABBREVIATIONS

NOTE: NOT ALL SYMBOLS AND ABBREVIATIONS INDICATED HERE ARE USED IN DRAWINGS AND MAY NOT APPLY TO CURRENT PROJECT. ADDITIONAL SYMBOLS MAY BE INDICATED ON DRAWINGS.

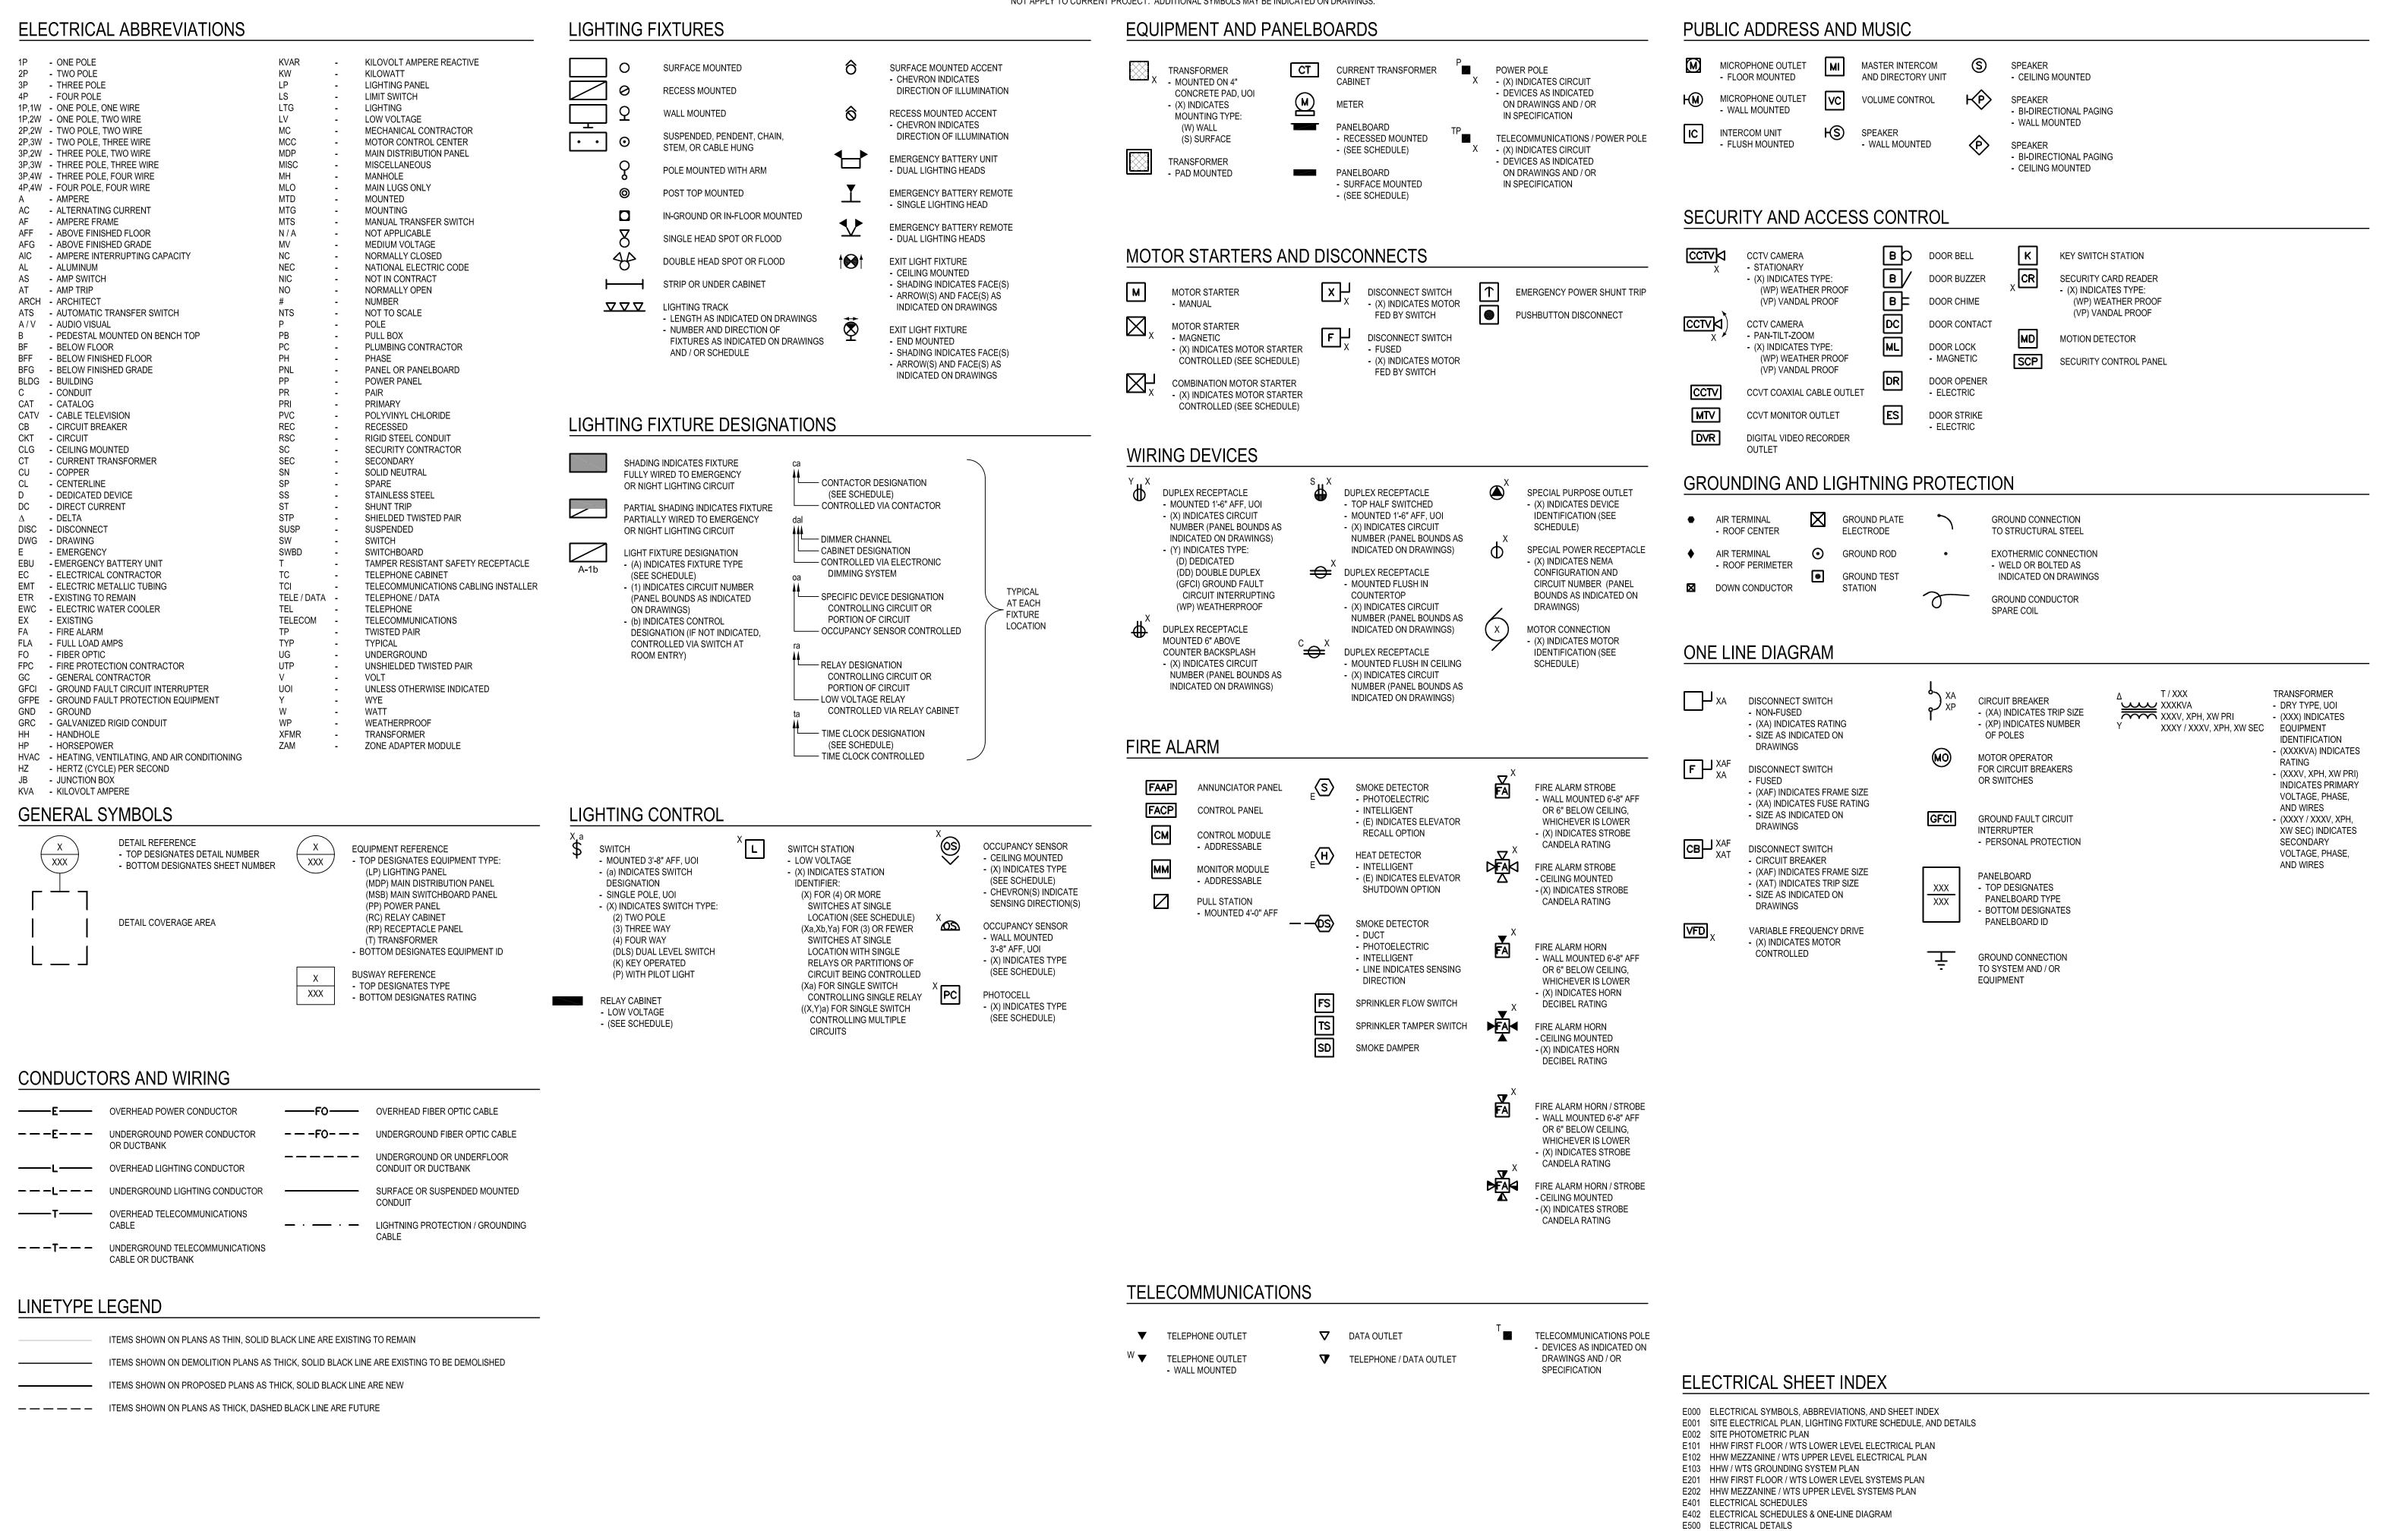

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PROJECT TITLE:

DANE COUNTY
WASTE TRANSFER STATION
AND HOUSEHOLD HAZARDOUS
WASTE FACILITY
RODEFELD LANDFILL

ISSUE:

PROJECT INFORMATION:
PROJECT NUMBER: 2009-0328.00

DATE: 05-11-2010
DRAWN BY: JAH
CHECKED BY: AAS

APPROVED BY: AAS


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SHEET TITLE:

ELECTRICAL SYMBOLS, ABBREVIATIONS AND SHEET INDEX



E000

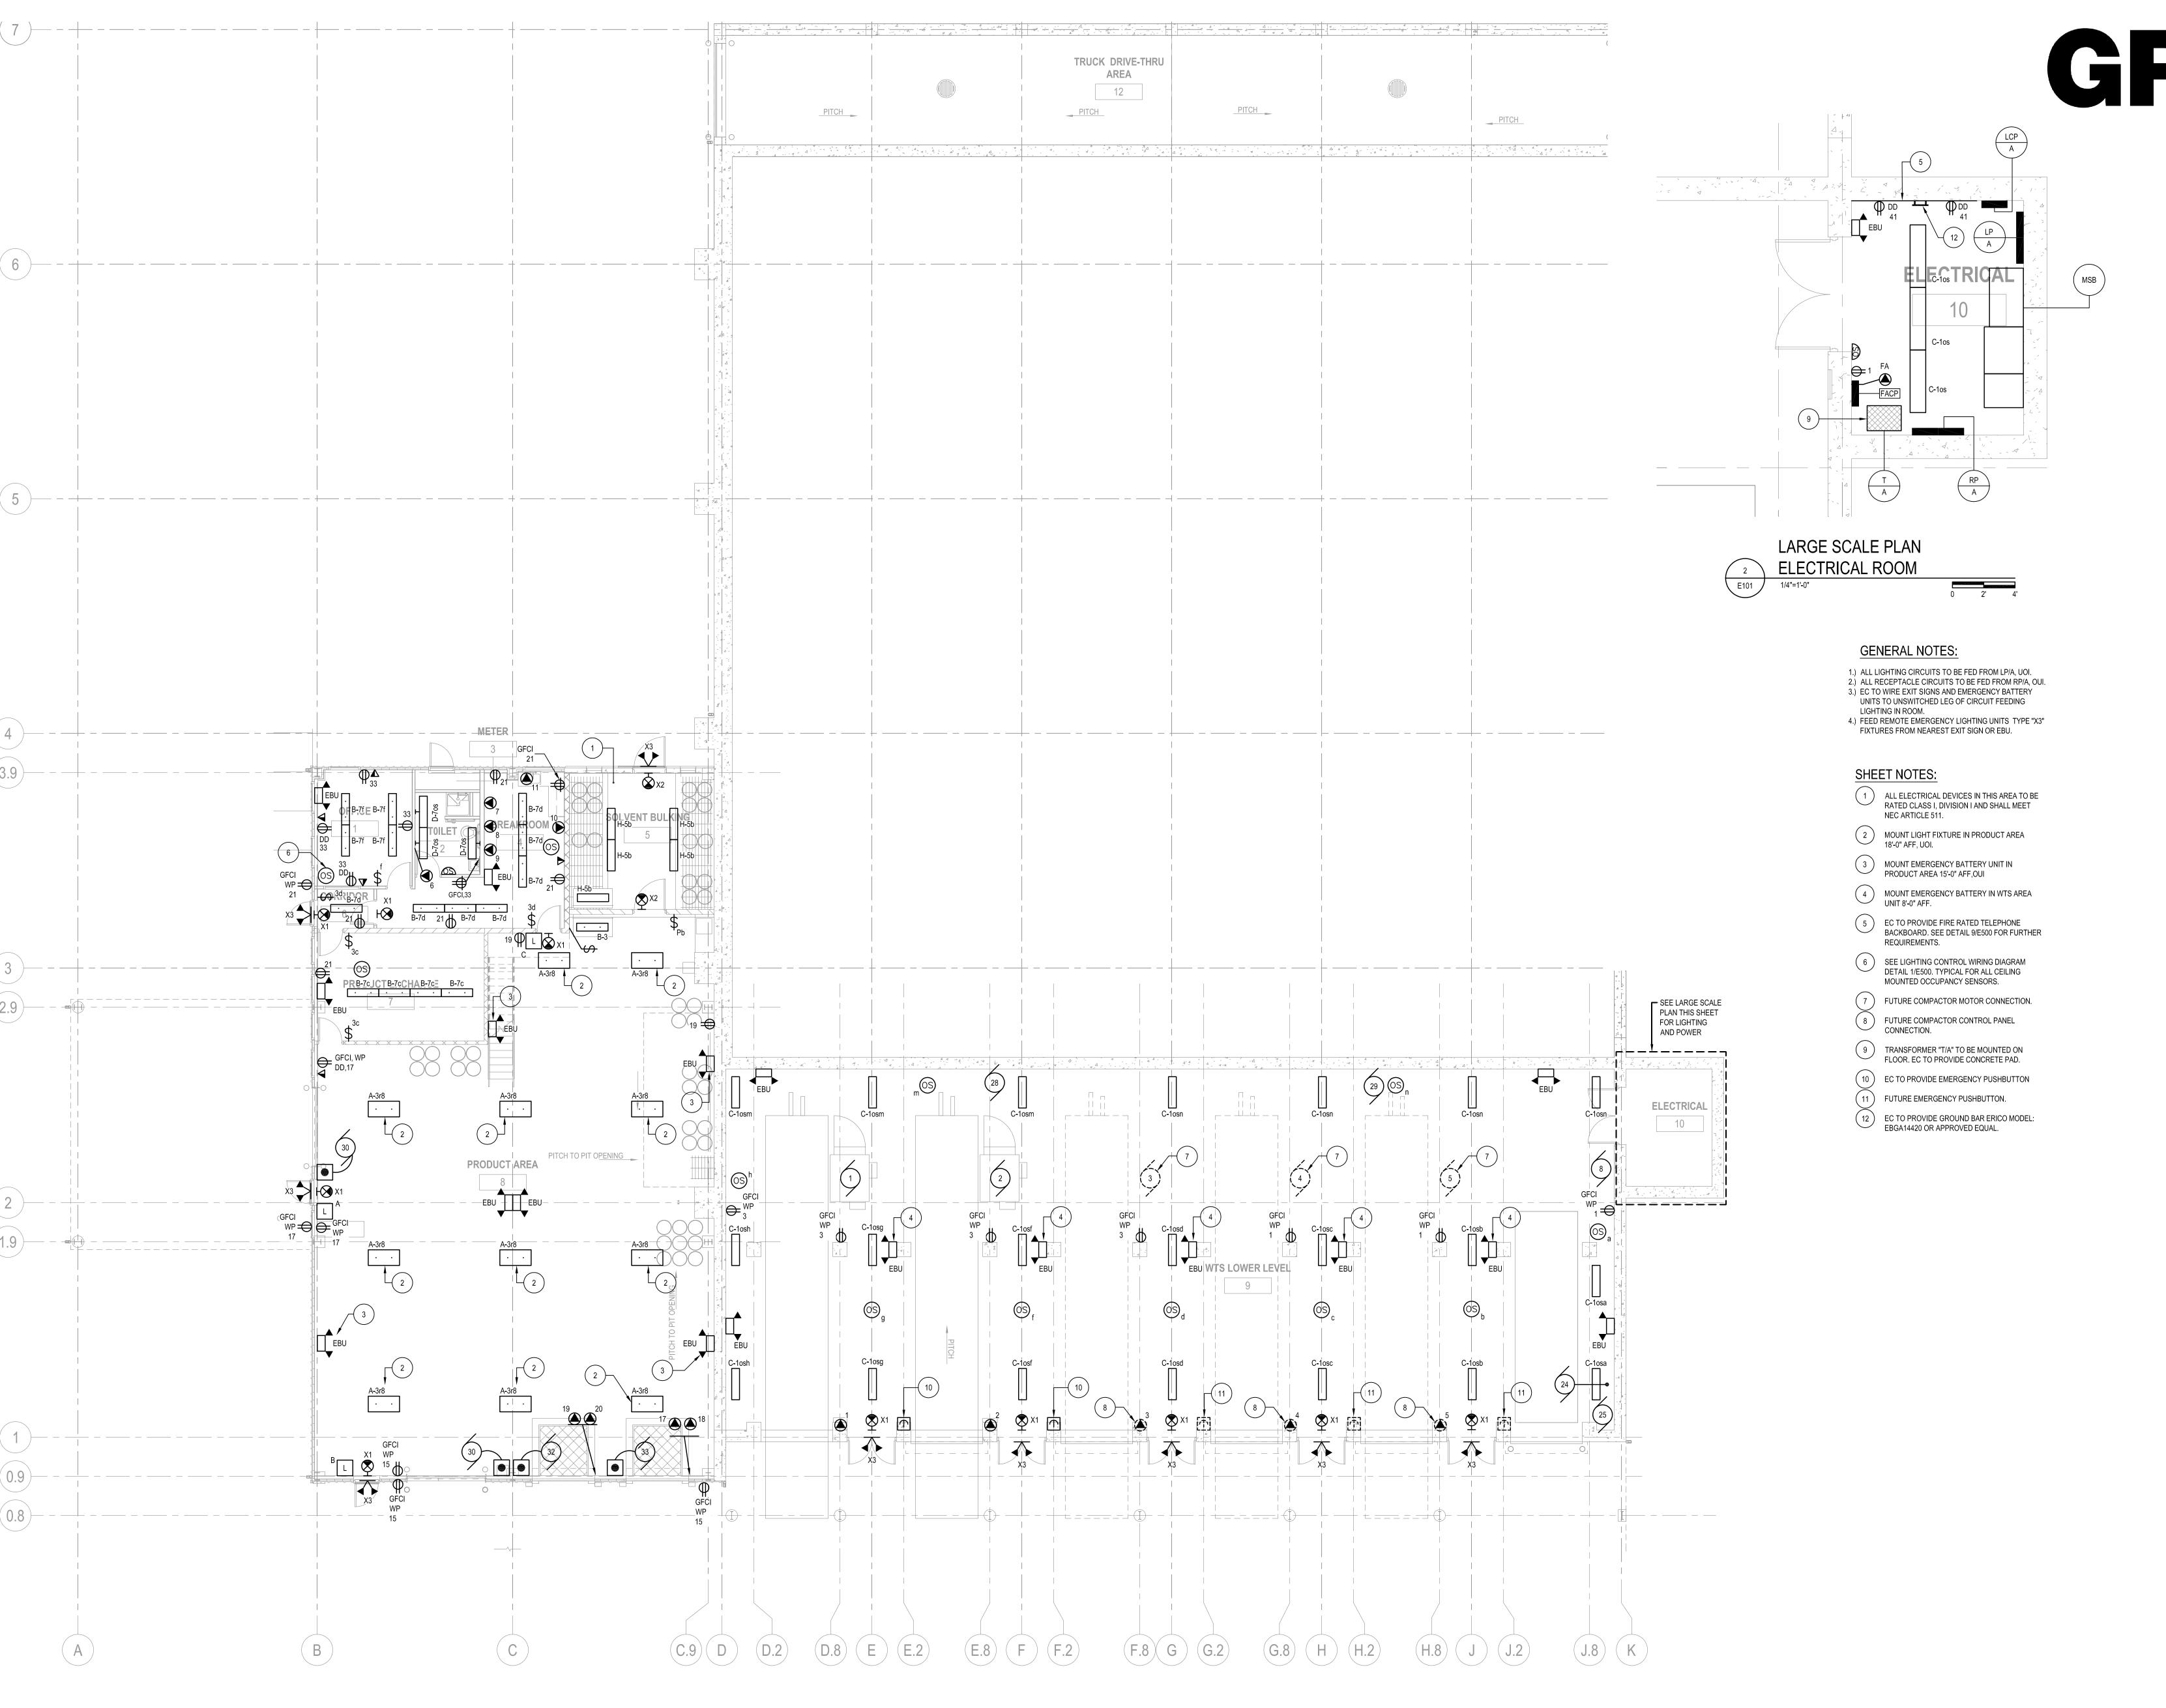

HHW FIRST FLOOR / WTS LOWER LEVEL ELECTRICAL PLAN

1/8"=1'-0"

GREF

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WASTE FACILITY
RODEFELD LANDFILL

ISSUE:

PROJECT INFORMATI

PROJECT NUMBER: 2009-0328.00
DATE: 05-11-2010

DRAWN BY: CHECKED BY:

APPROVED BY: JHK


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HHW FIRST FLOOR / WTS LOWER LEVEL ELECTRICAL PLAN

SHEET NUMBER:

E101



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ISSUE:

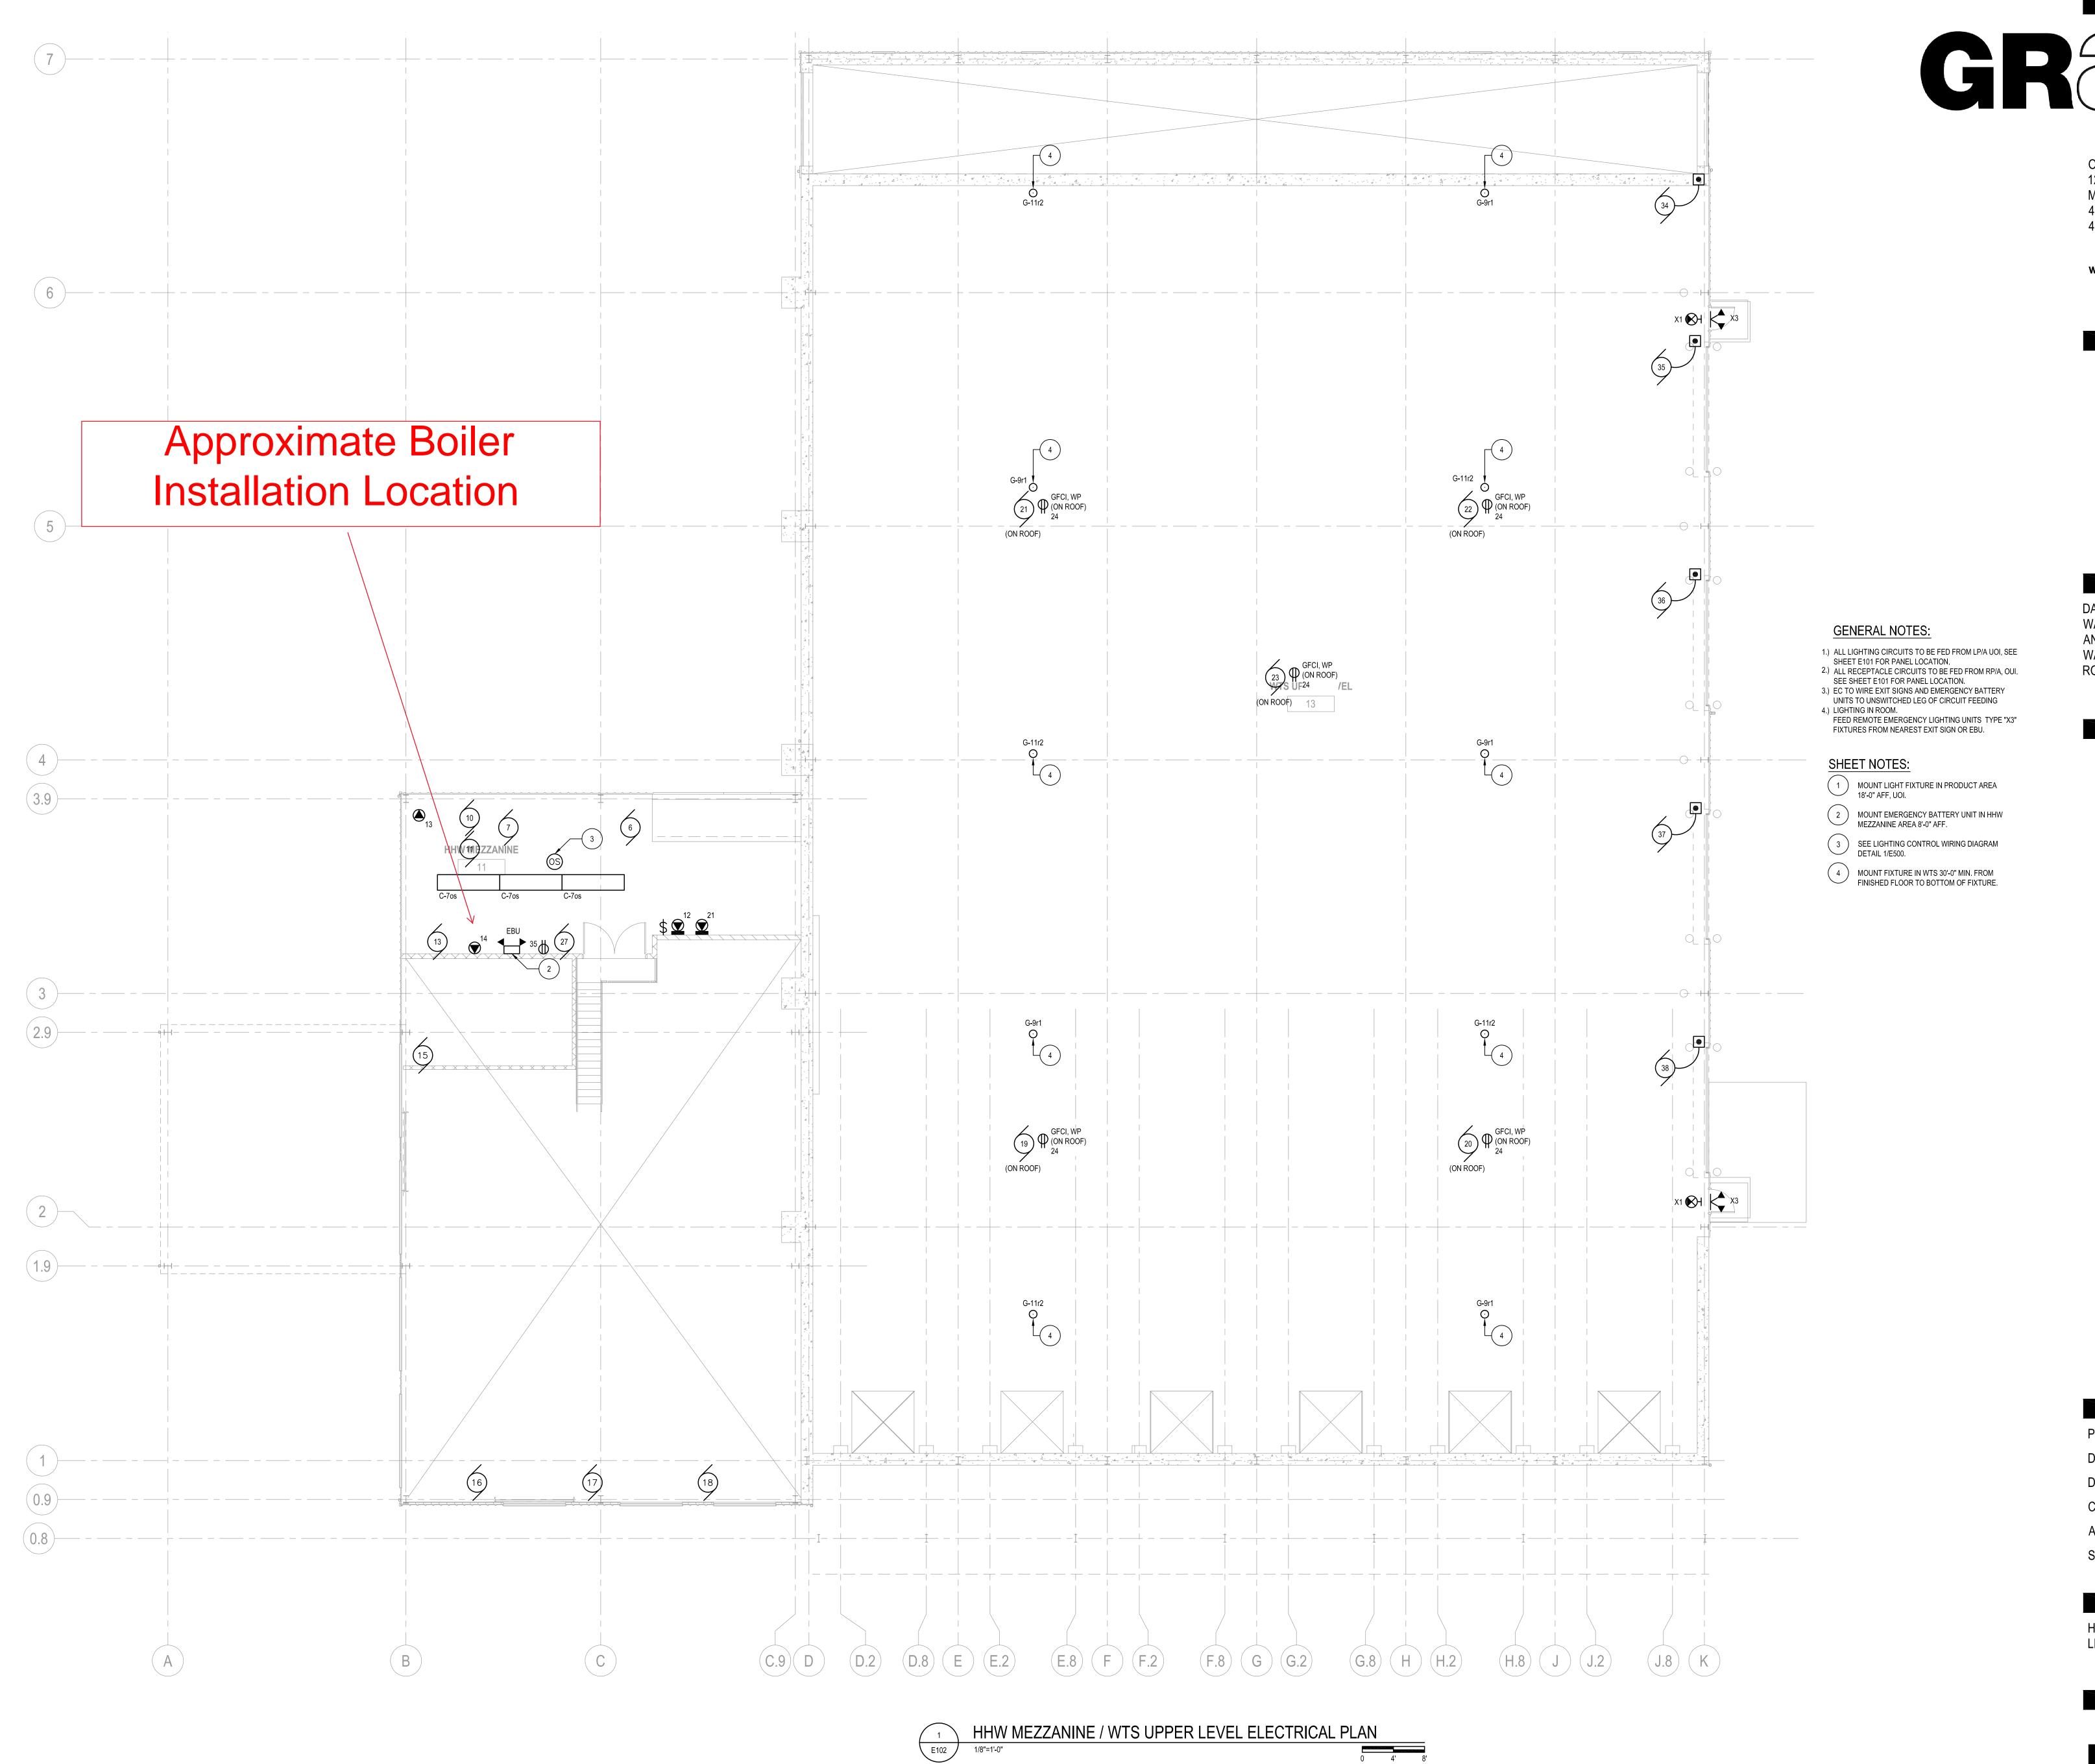
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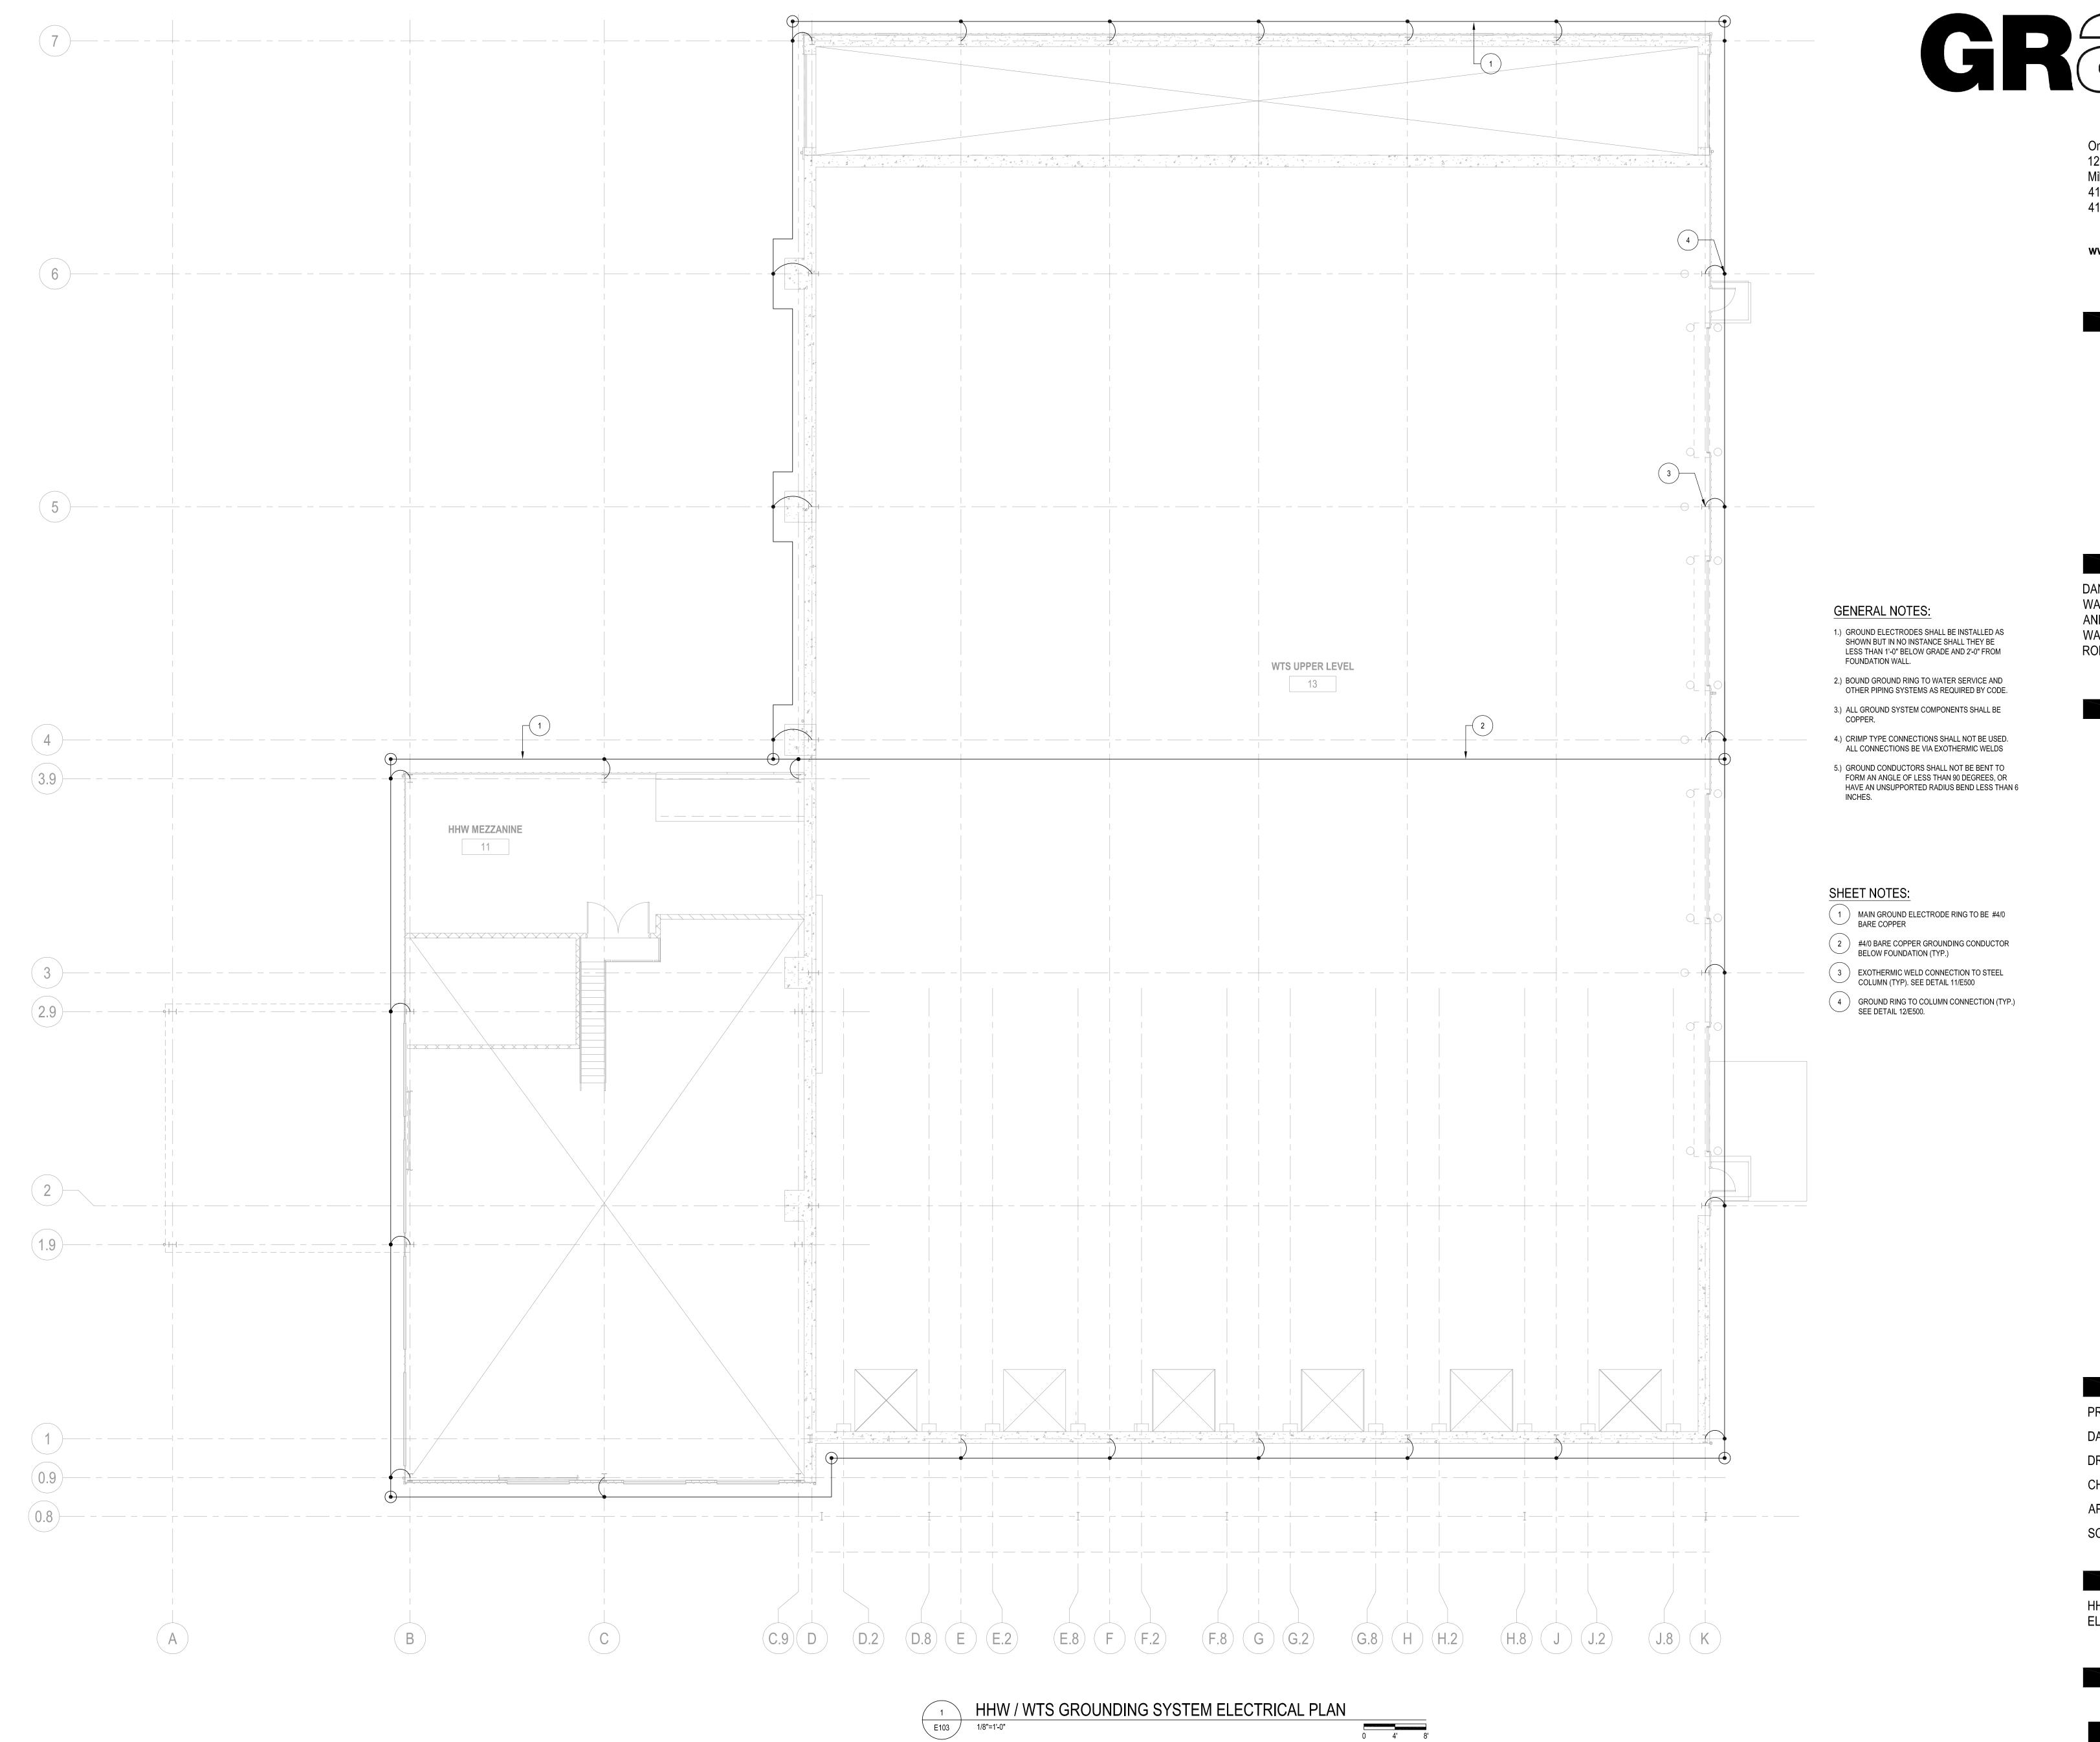
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SHEET TITLE:

HHW MEZZANINE / WTS UPPER LEVEL ELECTRICAL PLAN





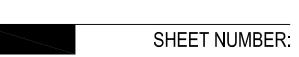

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DANE COUNTY WASTE TRANSFER STATION AND HOUSEHOLD HAZARDOUS WASTE FACILITY RODEFELD LANDFILL

ISSUE:

PROJECT NUMBER: 2009-0328.00 05-11-2010


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APPROVED BY: JHK SCALE: AS NOTED

SHEET TITLE:

HHW / WTS GROUNDING SYSTEM ELECTRICAL PLAN

SHEET NUMBER:



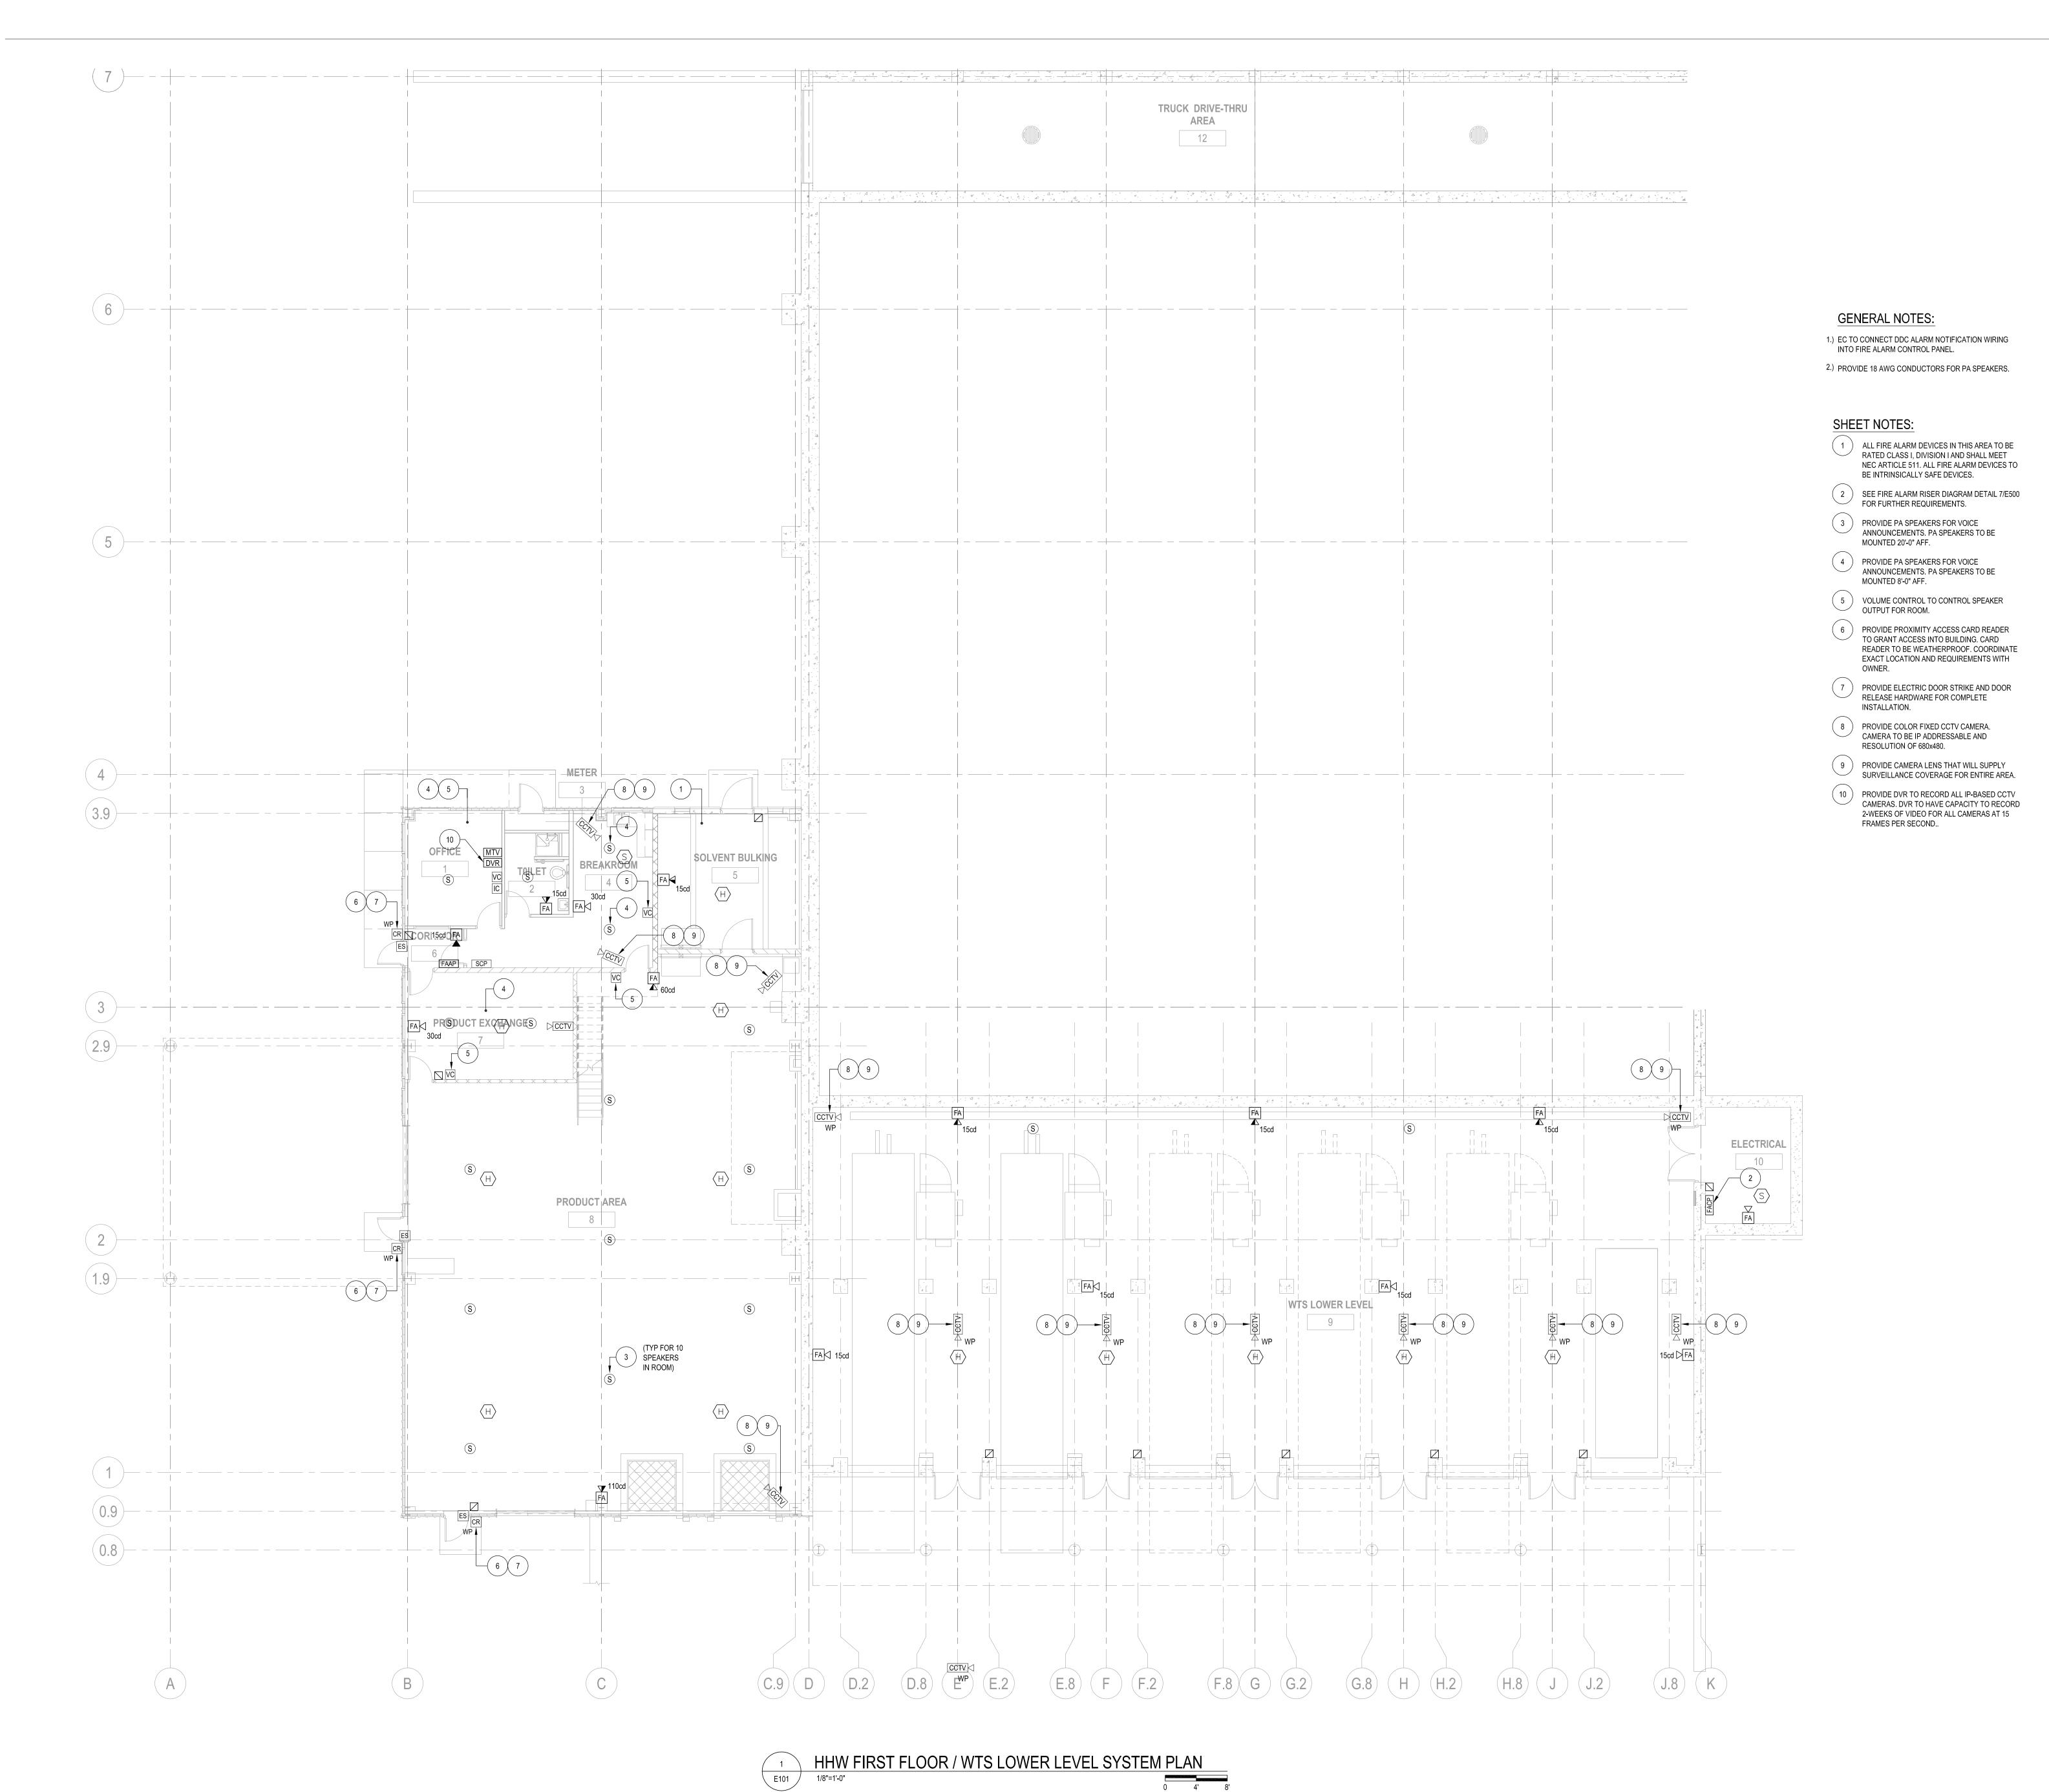

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WASTE FACILITY
RODEFELD LANDFILL

ISSUE:

PROJECT INFORMATION

PROJECT NUMBER: 2009-0328.00
DATE: 05-11-2010


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APPROVED BY: JHK


SCALE: AS NOTED

SHEET TITLE: HHW FIRST FLOOR / WTS LOWER

LEVEL SYSTEM PLAN



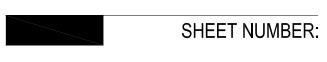

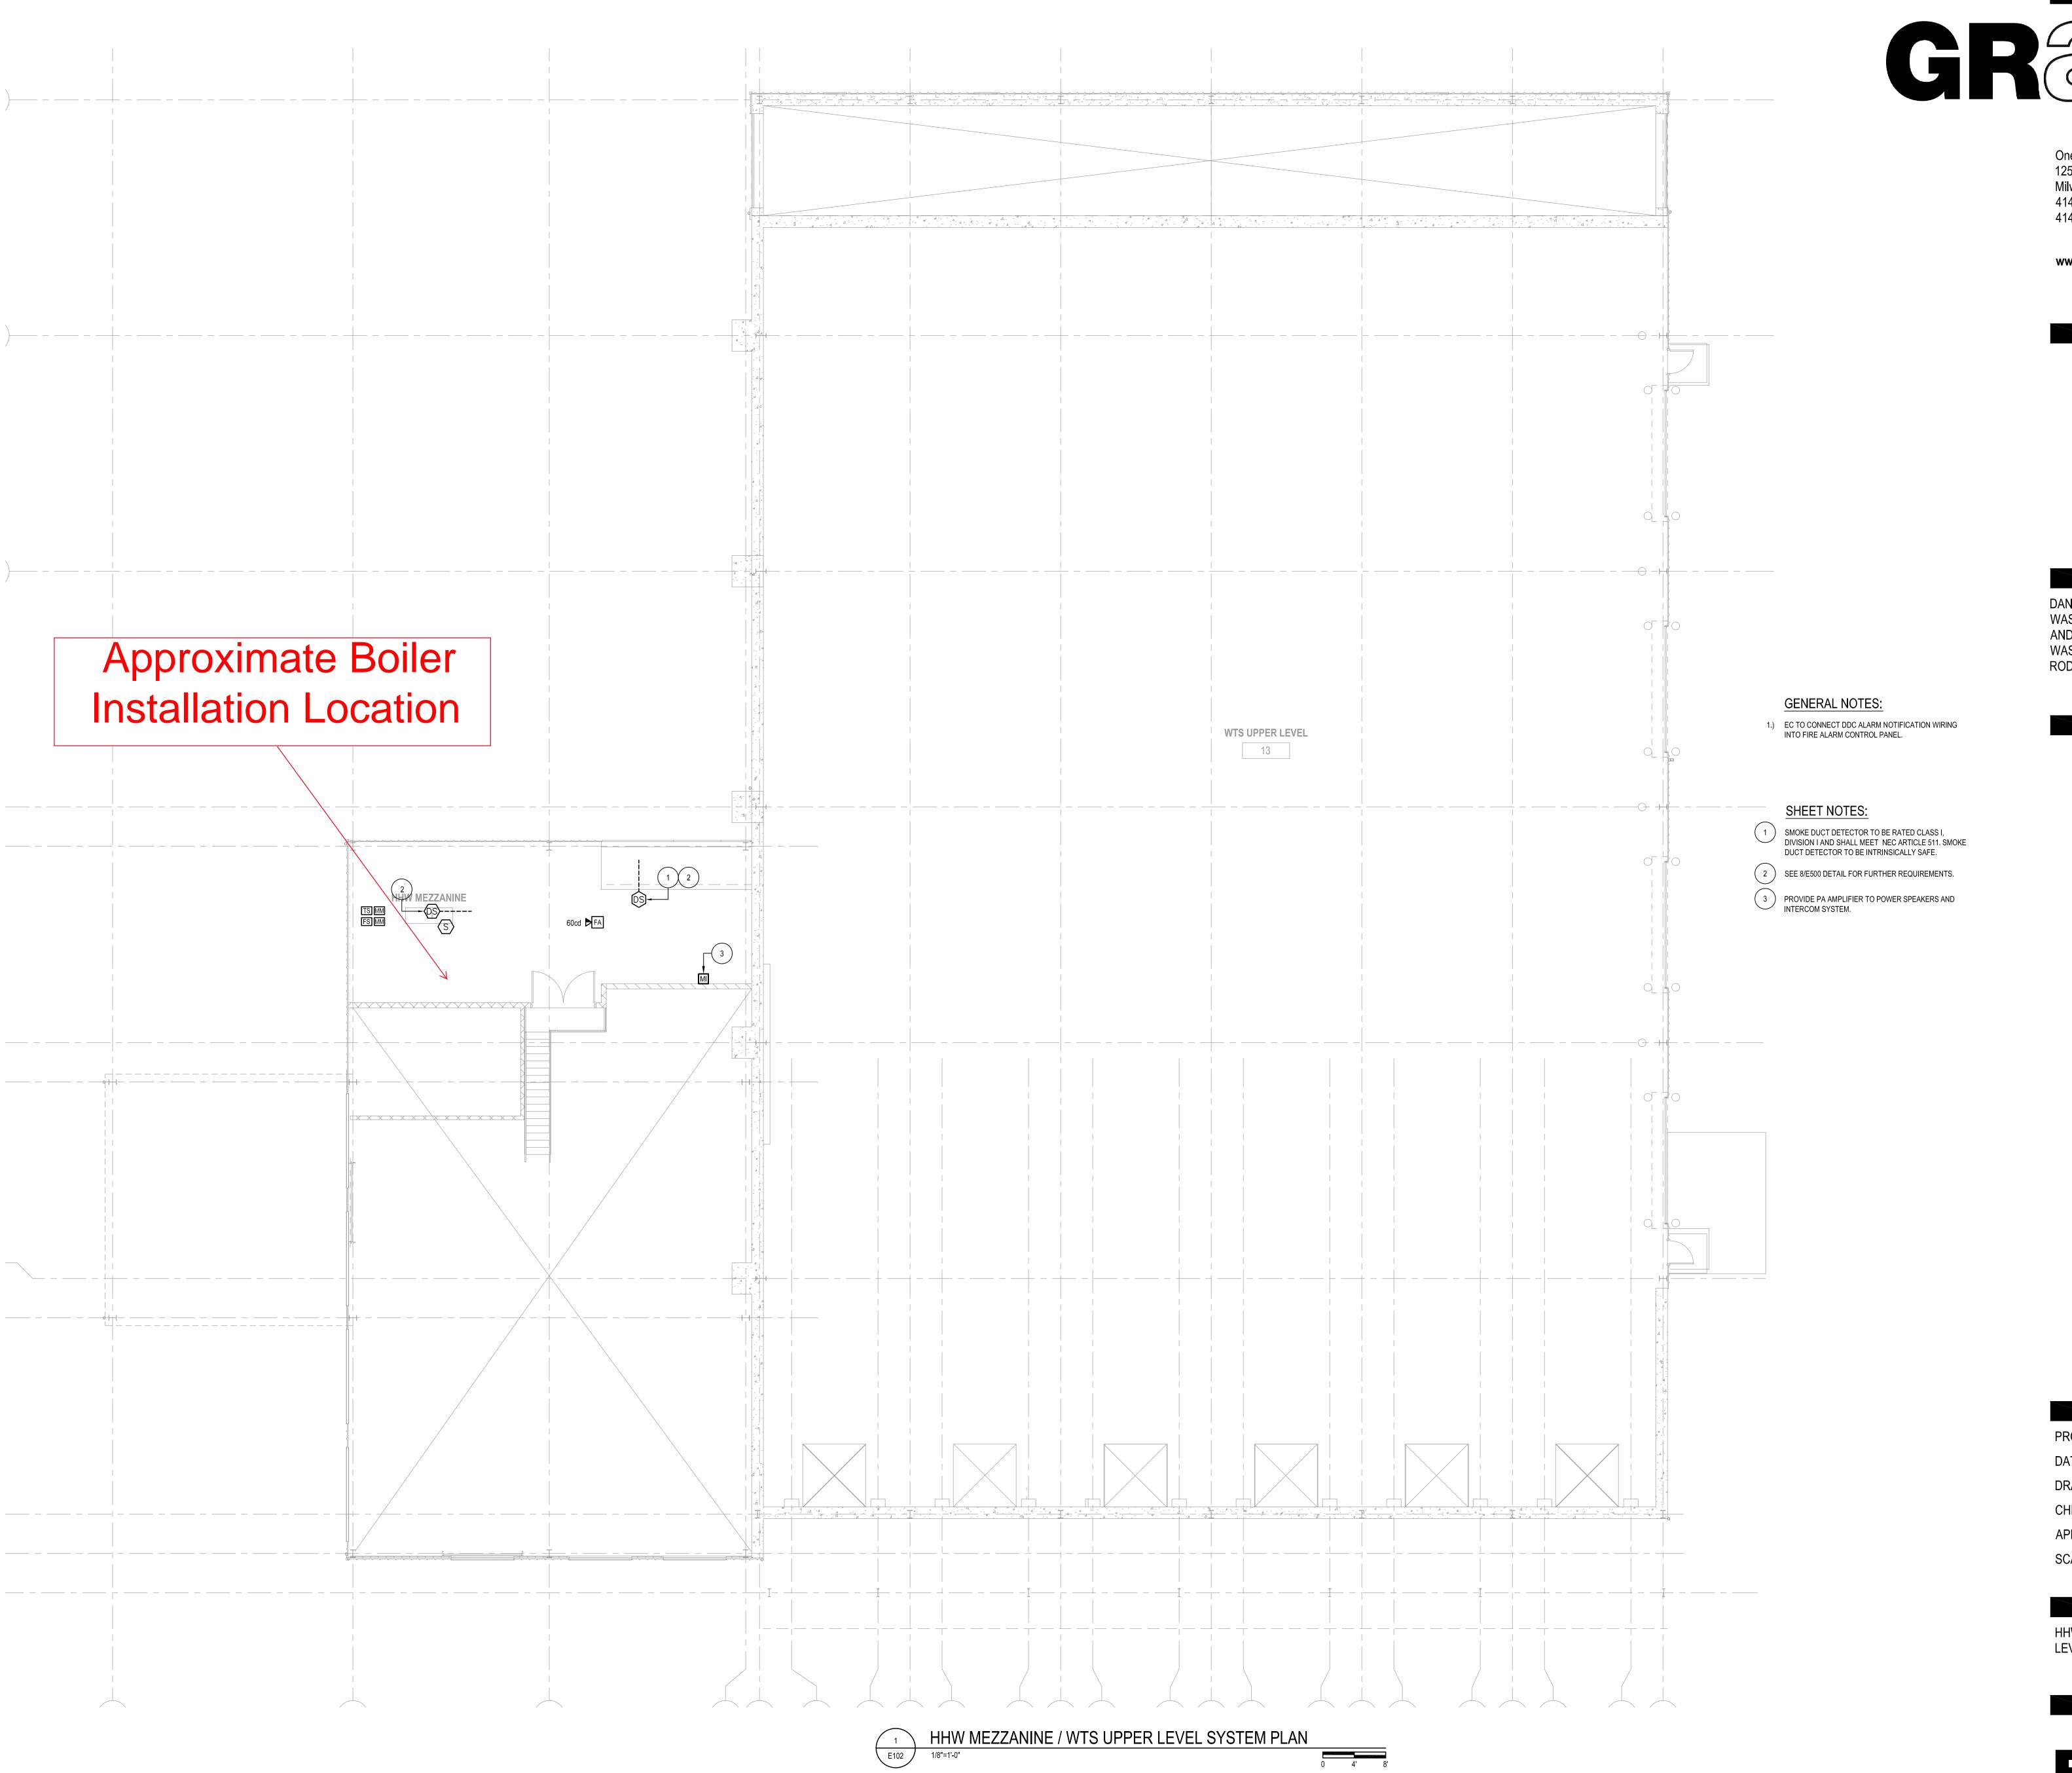

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ISSUE:


PROJECT NUMBER: 2009-0328.00 05-11-2010

CHECKED BY:

APPROVED BY: JHK SCALE: AS NOTED

SHEET TITLE:

HHW MEZZANINE / WTS UPPER LEVEL SYSTEM PLAN

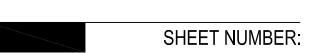



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		ALL CO		ION STARTERS SHALL BE CIRCUIT BREAKER TYPE U CONNECT SWITCH FOR ALL MOTORS LOCATED IN SI			ED.						AL TO UNIT	ATION, MAGNETIC, ILTAGE VERSING	FIC, FULL VOLTAGE		TATE REDUCED	EED, 1 WINDING	EED. 2 WINDING	AENT	ACTURER VICAL	ACTOR ICAL CONTRACTOR	, PUSHBUTTON	, SWITCH	FF-AUTO	GHT		¥	AL TO UNIT	<u></u> ≒ 1	SED SWITCH OTOR	ICH NEAF	BREAKER NEAR	X ENCLOSURE	ENT	VICAL ACTOR ICAL CONTRACTOR	, PUSHBUTTON	LICTING	, SWITCH	5	LIGHI E LOSS PROTECTION	DRAWINGS	<u> </u>	T\	TES		
#	LOAD	VOLT	PH	LOC (RM) DRIVING	FEED PANEL	FROM	+	AKER	#		H WIRING		INTEGRA	COMBINA FULL VOL NON-REV		VFD	SOLID STATE!	TWO SP	TWO SP		MANUFA MECHAN	CONTRA	ON-OFF,	ON-OFF,	HAND-0	PILOT LIG	PHASE	NEMA ST	INTEGR/	NOT REQU	NON-FUSED 8	FUSIBLE SWIT	MOTOR	NEMA 4)	EQUIPM MANUF	MECHANI CONTRAC ELECTRIC	ON-OFF,	- 1	ON-OFF.	ر الح	PILOI LIG		MANUAL	INTEGR/	SEE NO.	#	
1	200A	480	3	9 COMPACTOR	MSB-1	-		1	E ONE LIN		l		•								•											•				•									3	1	1
2	200A	480	3	9 COMPACTOR	MSB-1	-	-	SEI	E ONE LIN	IE DIAGR	XAM ——	-	•							•	•											•				•									3	2	
3	200A	480	3	9 COMPACTOR (FUTURE)	MSB-1	-	-	— SEI	E ONE LIN	IE DIAGR	RAM —	-								•												•				•									3	3	
4	200A	480	3	9 COMPACTOR (FUTURE)	MSB-1	-	-	— SEI	E ONE LIN	IE DIAGR	RAM —	-	•							•												•				•									4	4	
5	200A	480	3	9 COMPACTOR (FUTURE)	MSB-1	-	-	— SEI	E ONE LIN	IE DIAGR	RAM —	-								•												•				•									4	5	
6	10HP	480	3	11 MAU-1 (SUPPLY)	LP/A	2,4,6	30	3	3	10	10	3/4"				•					•				•						•					•									2	6	
7	10HP	480	3	11 MAU-1 (EXHAUST)	LP/A	8,10,12	30	3	3	10	10	3/4"				•					•	9			•						•					•									2	7	
8	7 FLA	120	1	11 ERV-1	RP/A	2	20	1	2	12	12	3/4"	1 1																						•	•					\perp				2	8	
9	22MCA	208	1	11 ACCU-1	RP/A	4,6	35	1	3	8	10	3/4"	+ +							•					-											•				\perp					1,2	9	
10	7.5HP	480	+	11 PP-1	LP/A	14,16,18	20	3	3	12	12	3/4"	+ +			•					•				•						•					•	_			+	+		_		2	10	4
11	7.5HP	480	-	11 PP-2	LP/A	20,22,24	20	3	3	12	12	3/4"				•				•	-				•						•					•	-			+			_		2	11	4
12	3/4HP	480	-	1 5	LP/A	26,28,30	-	3	3	12	12	3/4"		•						•	-										•					•	+			+					1,2		4
13	1/2HP	120		11 01 2	LP/A	28	20	1	2	12	12	3/4"	+ -							•	-		_			-	_									•	-								1,2		4
14	3/4HP	480	+		LP/A	38,40,42	-	3	3	12	12	3/4"	+ +							•	•															•	-			+					1,2	14	4
15	.15HP	120	+	11 UH-1	RP/A	8	20	1 1	2	12	12	3/4"	+ +																							•	_			+	+		+		2	15	\dashv
16	.15HP	120	+	11 UH-2 11 UH-3	RP/A RP/A	10	20	1	2	12	12	3/4"																								•	-			+					2	10	4
18	.15HP .15HP	120		11 UH-4	RP/A	12	20	1	2	12 12	12	3/4"											-			+	+				•					•	+			+	+				2	17	\dashv
19	3/4HP	480	-	11 EF-1	LP/A	43,45,47	<u> </u>	3	3	12		3/4"		•																					•		+			_					1,2	2 19	\dashv
20	3/4HP	480	-	+ +	LP/A	49,51,53	<u> </u>	3	3	12	12	3/4"	+ +							•	-										•				•					+					1,2	_	+
21	3/4HP	480	-	+ +	LP/A	55,57,59	1	3	3	12	12	3/4"	++	•							_										•				•		+			+	+				1,2		+
22	3/4HP	480		11 EF-4	LP/A	61,63,65	<u> </u>	3	3	12	12	3/4"		•							-										•				•					+					1,2		\exists
23	1/4HP	120	1	11 EF-5	RP/A	26	20	1	2	12	12	3/4"	+ +	•							-																			+	+				1,2	2 23	\dashv
24	1 1/2HP	480	3	9 EF-6	LP/A	63,65,67	20	3	3	12	12	3/4"	1	•																									+	+					1,2	2 24	+
25	1 1/2HP	480	3	9 EF-7	LP/A	73,75,77	20	3	3	12	12	3/4"	1 1	•																					•										1,2	2 25	1
26	1/3HP	120	1	9 EF-8	RP/A	30	20	3	3	12	12	3/4"		•						•	•														•				\top	\top					1,2	2 26	
27	1/4HP	208	1	11 FC-1	RP/A	32,34	20	1	2	12	12	3/4"		•						•	•														•	1									1,2	2 27	
28	3/4HP	480	3	9 IFP-1	LP/A	52,54,56	20	3	3	12	12	3/4"		•						•																•									3	28	
29	3/4HP	480	3	9 IFP-2	LP/A	58,60,62	20	3	3	12	12	3/4"		•						•											•					•									3	29	
30	1HP	120	1	8 OVERHEAD DOOR	RP/A	51	20	1	3	12	12	3/4"	•							•											•					•									3	30	
31	1HP	120	1	8 OVERHEAD DOOR	RP/A	53	20	1	3	12	12	3/4"	•							•											•					•									3	31	
32	1HP	120	1	8 OVERHEAD DOOR	RP/A	55	20	1	3	12	12	3/4"	•							•														\prod		•									3,5	32	
33	1HP	120	1	8 OVERHEAD DOOR	RP/A	57	20	1	3	12	12	3/4"	•							•											•					•		\perp		\perp					3,5	5 33	
34	2HP	120	1	WTS OVERHEAD DOOR	RP/A	59	20	1	3	12	12	3/4"	•							•	_										•					•		\perp							3,5	34	
35	2HP	120	1	WTS OVERHEAD DOOR	RP/A	61	20	1	3	12	12	3/4"	•							•											•					•		\perp		\perp					3,5	35	
36	2HP	120	1	WTS OVERHEAD DOOR	RP/A	63	20	1	3	12	12	3/4"	+ +							•	_										•					•									3,5		
37	2HP	120	-	WTS OVERHEAD DOOR	RP/A	65	20	1	3	12	12	3/4"								•	_										•					•				\perp					3,5		_
38	2HP	120	1	WTS OVERHEAD DOOR	RP/A	67	20	1	3	12	12	3/4"								•																•									3,5	38	
MOT	OR STA	RTER	R / W	IRING SCHEDULE NOTES:																																											

MOTOR STARTER / WIRING SCHEDULE NOTES:

- . EC TO PROVIDE HACR BREAKERS. EC TO COORDINATE WITH MECHANICAL CONTRACTOR FOR EXACT REQUIREMENTS.
- EC TO COORDINATE WITH EQUIPMENT MANUFACTURER FOR EXACT REQUIREMENTS. EC TO PROVIDE SPARE CIRCUIT BREAKER FOR FUTURE COMPACTORS.
- 5. EC TO COORDINATE EXACT HORSEPOWER AND VOLTAGE WITH DOOR MANUFACTURER. PROVIDE ALL WIRING INTERFACES WITH LIMIT SWITCHES, DOOR CONTROLLER, ETC.

			SPECIA	_ PURPOSE	OUTLE	T SCHE	DULE						
			FEED	FROM	BRE,	AKER		WIRING				_	SEE
#	SERVING	LOC	PANEL	CIRCUIT	SIZE	POLE	#	SIZE	COND	VOLT	PHASE	LOAD	NOTE
1	COMPACTOR CONTROL PANEL	9	RP/A	5	20	1	3	12	3/4"	120	1		1
2	COMPACTOR CONTROL PANEL	9	RP/A	7	20	1	3	12	3/4"	120	1		1
3	COMPACTOR CONTROL PANEL	9	RP/A	9	20	1	3	12	3/4"	120	1		1
4	COMPACTOR CONTROL PANEL (FUTURE)	9	RP/A	11	20	1	3	12	3/4"	120	1		1
5	COMPACTOR CONTROL PANEL (FUTURE)	9	RP/A	13	20	1	3	12	3/4"	120	1		1
6	EWH-1	2	RP/A	37,39	30	2	4	10	3/4"	208	1	3.0KW	1,2
7	VENDING MACHINE	4	RP/A	27	20	1	3	12	3/4"	120	1		
8	VENDING MACHINE	4	RP/A	29	20	1	3	12	3/4"	120	1		
9	VENDING MACHINE	4	RP/A	31	20	1	3	12	3/4"	120	1		
10	REFRIGERATOR	4	RP/A	23	20	1	3	12	3/4"	120	1		
11	MICROWAVE	4	RP/A	25	20	1	3	12	3/4"	120	1		
12	TEMPERATURE CONTROL PANEL	11	RP/A	22	20	1	3	12	3/4"	120	1		1
13	WH-1	11	RP/A	16,18,20	20	3	4	12	3/4"	208	3	4.5KW	1
14	BOILER	11	MSB-1	-	-	- SEE ONE	LINE DIAG	RAM —	-	480	3	300KW	1,2
15	HAZARDOUS MATERIAL STORAGE	-	RP/A	43,45	50	2	2 1	8 10	3/4"	208	1	Ī	2
16	HAZARDOUS MATERIAL STORAGE	-	RP/A	47,49	50	2	2 1	8 10	3/4"	208	1	-	2
17	DOCK LEVELER	8	LP/A	44,46,48	20	3	4	12	3/4"	480	3	-	3
18	DOCK VEHICLE RESTRAINT	8	RP/A	46	20	3	3	12	3/4"	120	1	-	1
19	DOCK LEVELER	8	LP/A	44,46,48	20	3	4	12	3/4"	480	3	-	3
20	DOCK VEHICLE RESTRAINT	8	RP/A	46	20	1	3	12	3/4"	120	1	-	1
21	GAS MOTOR CONTROL PANEL	11	RP/A	22	20	1	3	12	3/4"	120	1	-	1
FA	FIRE ALARM PANEL	-	RP/A	44	20	1	3	12	3/4"	120	1	-	1

SPECIAL PURPOSE OUTLET SCHEDULE NOTES:

- 1. EC TO COORDINATE EXACT REQUIREMENTS WITH MANUFACTURER. 2. EC TO PROVIDE DISCONNECT.
- 3. FOR INSTALLATION SEE DETAIL 1/E401, 2/E401, 3/E401. CONFIRM EXACT INSTALLATION DETAILS WITH SHOP DRAWINGS AND ACTUAL EQUIPMENT PURCHASED FOR PROJECT.

				LIGH	TING FIXTURE SCH	EDULE						
		REFERENCED	ECIFICATIONS SECTIONS FOR ADDITIONAL INFORMATIONAL INFORMATION THE COLUMN TITLED "OPTIONS/ACCESSORIES". MAMANUFACTURERS MUST MEET THE PHOTOMETRIC PER	NUFACTURERS LISTED AS ACCEPTAB					RIES			
		ABBREVIATIO	DNS: DW = DRY WALL ES = EXPOSED STRUCTURE LG = LAY-IN GRID	PL = PLASTER S	= RECESS V = SURFACE = WALL MOUNTED	VARIES						
DES		LAMP DATA	DESCRIPTION	LIGHTING FI	XTURE	VOLT	MOUNT	CEILING	FIXTURE	OPTIONS/ ACCESSORIES	ACCEPTABLE MANUFACTURERS	SEE NOTE
	#	TYPE	3233.W 113.W	MANUFACTURER	CATALOG SERIES	, , , ,		TYPE	DEPTH	or money modes on the	ACCEL MARKET MARKET ACCELLATE	022 110 12
Α	6	F32T8	HIGH BAY FLUORESCENT	COOPER	2HB-632-MPC6	277	Р	ES			LITHONIA, DAYBRITE, LSI	
В	2	F32T8	INDUSTRIAL STRIPS	COOPER	J8-R-232-TBW	277	Р	ES			LITHONIA, DAYBRITE, LSI	
С	2	F32T8	VAPORTIGHT FLUORESCENT	COOPER	-	277	S	ES			LITHONIA, DAYBRITE, LSI	
D	2	F32T8	BATHROOM VANITY FLUORESCENT	COOPER	BAU-EB	277	S	ES			LITHONIA, DAYBRITE, LSI	
G	1	320W PSMH	HID HIGHBAY	COOPER	MPLX-PD-FC3-FH-1	277	₽	ES			LITHONIA, DAYBRITE, LSI	
Н	2	F32T8	EXPLOSION PROOF LINEAR	LDPI	380-T8-2L-4-277	277	S	ES				
К	1	200W A21	-	-	-	277	S	ES				
X1	2	12W MR16	EXIT SIGN WITH BATTERY BACK	EMERGI-LITE	BBSVX24NRDA2MK	277	W	ES			COOPER, LITHONIA, DAYBRITE	
X2	2	12W MR16	SOLVENT EXIT SIGN WITH BATTERY BACK	COOPER	HZX21	277	W	ES			EMERGI-LITE	
Х3	2	20W MR16	REMOTE HEADS	EMERGI-LITE	EF39-MD	277	W	ES			COOPER, LITHONIA, DAYBRITE	
EBU	2	20W MR16	EMERGENCY BATTERY UNIT	EMERGI-LITE	B12SV24N-2MW-DA	277	W	ES			COOPER, LITHONIA, DAYBRITE	


LIGHTING FIXTURE SCHEDULE NOTES:

	LOW VOLTAGE RELAY	CABINET SCHEDULI	Ē
CABINET DESIGN	IATION: LCP/A		
DELAY#	CIRCUIT CONTROLLED	CONTROL	LLED BY
RELAY#	CIRCUIT CONTROLLED	SWITCH STATION	SWITCH DES
1	LP/A-9		
2	LP/A-11		
3	LP/A-13	PHOTOCELL	PHOTOCELL
4	LP/A-15	PHOTOCELL	PHOTOCELL
5	LP/A-17	PHOTOCELL	PHOTOCELL
6	LP/A-19	PHOTOCELL	PHOTOCELL
7	LP/A-21	PHOTOCELL	PHOTOCELL
8	LP/A-3	A,B,C	а

LOW VOLTAGE RELAY CABINET SCHEDULE NOTES: 1. SEE LIGHTING CONTROL SCHEMATIC DETAIL 2/E500 FOR FURTHER REQUIREMENTS.

SEE	RELAY CABINET	CIRCUITS CONTROLLED	SWITCH	LOCATION	DESIGNATION
	LCP/A	LP/A-3	а	8	А
	LCP/A	LP/A-3	а	8	В
	LCP/A	LP/A-3	а	8	С

1. PROVIDE WEATHER-PROOF ENCLOSURE FOR OVER RIDE SWITCH

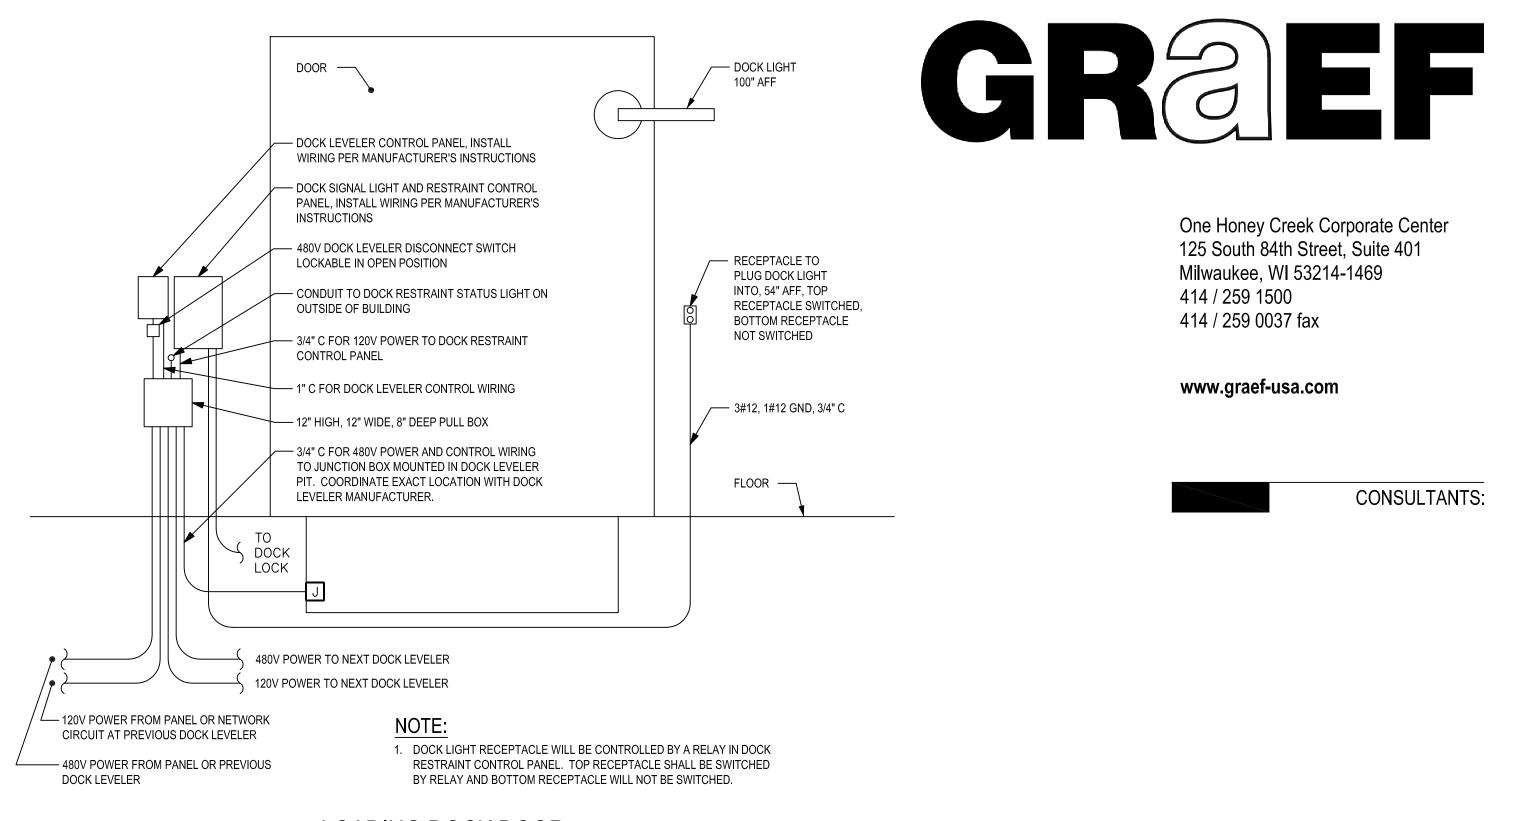

One Honey Creek Corporate Center 125 South 84th Street, Suite 401 Milwaukee, WI 53214-1469 414 / 259 1500 414 / 259 0037 fax

www.graef-usa.com

CONSULTANTS:

LOADING DOCK DOOR (INSIDE BUILDING)

OUTSIDE DOCK DOOR —

PROJECT TITLE: DANE COUNTY WASTE TRANSFER STATION AND HOUSEHOLD HAZARDOUS WASTE FACILITY RODEFELD LANDFILL

ISSUE:

BOXES INSIDE BUILDING, SEE DETAIL 1/E402 (TYP) — DOCK RESTRAINT STATUS LIGHT BUILDING DOCK LEVELER

> — SURFACE MOUNTED JUNCTION BOX


SEE DETAIL 3/E402. SUPPORT EVERY 2 FEET.

— 3/4" LIQUID TIGHT FLEXIBLE CONDUIT FOR DOCK LOCK MOTOR AND LIMIT SWITCHES,

LOADING DOCK DOOR (OUTSIDE BUILDING) E402 NOT TO SCALE

DOCK LOCK —

GRADE -

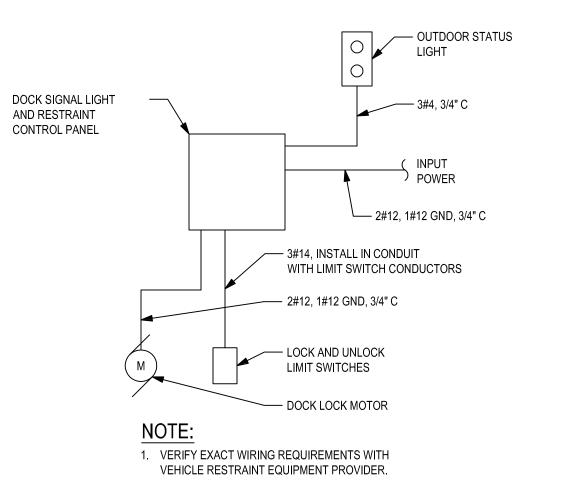


VEHICLE RESTRAINT

PROJECT INFORMATION: PROJECT NUMBER: 2009-0328.00

DATE: 05-11-2010 CHECKED BY: APPROVED BY: JHK SCALE: AS NOTED

SHEET TITLE:

ELECTRICAL SCHEDULES

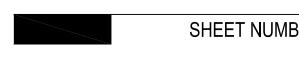

PA	NELBOARD SC	HEDL	JLE:	_LP	P/A (TL	ΙB	-1))					
PHAS SINTE	SE/WIRE: <u>3P/4W</u> ERVICE ENTRANCE LABEL RRUPTING RATING: .000 AMPS SYMMETRICAL	MAIN TYF	ONLY EED (D	CO	NTACTED TH	TOR IRU	3	X GR	COPP ALUM 200% OUND STAN	ER INUM NEUTR ING: DARD (AL	AMI SULATE	X SURFACE☐ FLUSHENCLOSURE:X NEMA 1	
CCT #	LOAD DESCRIPTION	V A	A/PHAS	E C	TRIP				TRIP	V	A/PHAS	E C	LOAD DESCRIPTION	CCT #
1	LIGHTING	1,500			20/1	1	ΥΥ	7 2	30/3	-			MOTOR #6	2
3	LIGHTING		1,980		20/1	3		4	Х		=		-	4
5	LIGHTING			240	20/1	5		6	Х			-	-	6
7	LIGHTING	1,260			20/1	7	$\ $	8	30/3	-			MOTOR #7	8
9	LIGHTING		2,275		20/1	9		10	Х		-		-	10
11	LIGHTING			2,275	20/1	11	Ĭ	12	Х			-	-	12
13	LIGHTING	216			20/1	13	Ħ	14	20/3	-			MOTOR #10	14
15	LIGHTING		3,185		20/1	15		16	Х		-		-	16
17	LIGHTING			1,820	20/1	17	I	18	Х			-	-	18
19	LIGHTING	2,275			20/1	19	Ħ	20	20/3	-			MOTOR #11	20
21	SPARE		-		20/1	21	Ħ	22	Х		-		-	22
23	SPARE			-	20/1	23	I	24	Х			-	-	24
25	SPARE	-			20/1	25	Ħ	26	20/3 HACR	-			MOTOR #12	26
27	SPARE		-		20/1	27		28	T		-		-	28
29	SPARE			-	20/1	29	ľ	30	X/1			-	-	30
31	SPARE	-			20/1	31	Ħ	32	20/1	-			SPARE	32
33	SPARE		-		20/1	33	\dagger	34	20/1		-		SPARE	34
35	SPARE			-	20/1	35		36	20/1			-	SPARE	36
37	SPARE	-			20/1	37	\parallel	38	20/3 HACR	-			MOTOR #14	38
39	SPARE	-		20/1	39	† †	40			-		-	40	
41	SPARE			-	20/1	41		42	Х			-	-	42
A - B - C TOTAL CONNECTED: -														
	TOTAL DEMAND: -													
													ABBREVIATIONS: HB HANDLE-BLOCKING DEVICE GFCI GROUND FAULT CIRCUIT INTERRUPT HACR HEATING AND AIR-CONDITIONING RA	

PA	NELBOARD SCHEDULE NOTES:
1.	PROVIDE HACR CIRCUIT BREAKERS FOR CIRCUITS 26,28,30 AND 38,40,42.

PHAS SINTE	SE/WIRE: 3P/4W SERVICE ENTRANCE LABEL RRUPTING RATING: .000 AMPS SYMMETRICAL SERIES RATED	MAIN TYF LUGS SUB-F SHUN	ONLY EED (C	CO	NTAC [*]	TOR HRU		XI II II II II II	COPPI ALUMI 200% I DUNDI STANI	ER INUM NEUTR NG: DARD (AL NON-IN	SULATE	X SURFACE☐ FLUSHENCLOSURE:X NEMA 1	
CCT #	LOAD DESCRIPTION	A	A/PHAS	SE C	TRIP				TRIP	V A	A/PHAS B	E C	LOAD DESCRIPTION	С
43	MOTOR #19	443			20/3 HACR	43	ΥΥ	44	20/3	1024			SPO #17, 19	Γ.
45	-		443		Х	45	\prod	46	Χ		1024		-	١.
47	-			443	Х	47		48	Х			1024	-	
49	MOTOR #20	443			20/3 HACR	49		50	20/1	ı			SPARE	
51	-		443		Х	51	\prod	52	20/3		256		MOTOR #28	
53	-			443	Х	53		₹	Х			256	-	
55	MOTOR #21	443			20/3 HACR	55		₹ 56	Х	256				
57	-		443		Х	57	\parallel	58	20/3		256		MOTOR #29	
59	-			443	Х	59		60	Χ			256	-	
61	MOTOR #22	443			20/3 HACR	61		62	Х	256			-	
63	-		443		Х	63	\prod	64					SPACE	
65	-			443	Х	65		66					SPACE	
67	MOTOR #24	832			20/3 HACR	67		68					SPACE	
69	-		832		Х	69	\prod	70					SPACE	
71	-			832	Х	71	$\ $	72					SPACE	
73	MOTOR #25	832			20/3 HACR	73		74					SPACE	
75	-		832		Х	75	\prod	76					SPACE	
77	-			832	Х	77	$\ $	78					SPACE	
79	SPACE					79		80					SPACE	
81	SPACE				81	\parallel	82					SPACE		
83 SPACE 83 84 SPACE														
25,270 B 27,459 C 24,354 TOTAL CONNECTED: 77,083VA														
					•								TOTAL DEMAND: 101	1.3
													ABBREVIATIONS: HB HANDLE-BLOCKING DEVICE GFCI GROUND FAULT CIRCUIT INTERRUPTER HACR HEATING AND AIR-CONDITIONING RATE	


PANELBOARD SCHEDULE NOTES:

1. PROVIDE HACR CIRCUIT BREAKERS FOR CIRCUITS 43 THRU 77.

PHAS SINTE	TAGE: 208/120 SE/WIRE: 3P/4W SERVICE ENTRANCE LABEL RRUPTING RATING: .000 AMPS SYMMETRICAL SERIES RATED	MAIN TYP 2 LUGS SUB-F SHUN	25 ONLY EED (D	COI	NTACTED TH	ΓOR IRU		X GR	COPP ALUM 200% DUND STAN	ER INUM NEUTR ING: DARD (AL	AM SULATE	X SURFACE☐ FLUSHENCLOSURE:X NEMA 1	
CCT #	LOAD DESCRIPTION	V A	A/PHAS B	E C	TRIP				TRIP	V A	A/PHAS	SE C	LOAD DESCRIPTION	CO
1	RECEPTACLES	720			20/1	1	M	7 2	30/1	840			MOTOR #8	:
3	RECEPTACLES		540		20/1	3		1 4	35/2 HACR		2,288		MOTOR #9	4
5	SPO #1			600	20/1	5		6	Х			2,288	-	(
7	SPO #2	600			20/1	7			20/1	114			MOTOR #15	8
9	SPO #3		600		20/1	9		10	20/1		114		MOTOR #16	1
11	SPO #4			600	20/1	11		12	20/1			114	MOTOR #17	1
13	SPO #5	600			20/1	13	Т	14	20/1	114			MOTOR #18	1
15	RECEPTACLES		540		20/1	15		16	20/3		1,500		SPO #13	1
17	RECEPTACLES			540	20/1	17		18	20/1			1,500	-	1
19	RECEPTACLES	360			20/1	19	ľ	20	20/1	1,500			-	2
21	RECEPTACLES		900		20/1	21		22	20/1		600		SPO #12	2:
23	SPO #10			1,200	20/1	23	Ť	24	20/1			-	RECEPTACLES	2
25	SPO #11	1,200			20/1	25	ľ	26	20/1	696			MOTOR #23	20
27	SPO #7		1,200		20/1	27		28	20/1 HACR		1,176		MOTOR #13	28
29	SPO #8			1,200	20/1	29	Ť	20	20/1 HACR			696	MOTOR #26	30
31	SPO #9	1,200			20/1	31	Ħ	32	20/2 HACR	130			MOTOR #27	32
33	RECEPTACLES		1,080		20/1	33		34	Х		130		-	34
35	RECEPTACLES			180	20/1	35		36	20/1			-	SPARE	36
37	SPO 36	1,500			30/2	37		38	20/1	-			SPARE	38
39	-		1,500		Х	39		40	20/1		-		SPARE	40
41	SPARE			-	20/1	41	Ť	42	20/1			-	SPARE	42
		A	-		В		_			С	-	•	TOTAL CONNECTED:	
													TOTAL DEMAND: ABBREVIATIONS: HB HANDLE-BLOCKING DEVICE GFCI GROUND FAULT CIRCUIT INTERRUPT HACR HEATING AND AIR-CONDITIONING RA	TER


PANELBOARD SCHEDULE NOTES:

1. PROVIDE HACR CIRCUIT BREAKERS FOR CIRCUITS 4,6,28,30,32,34.

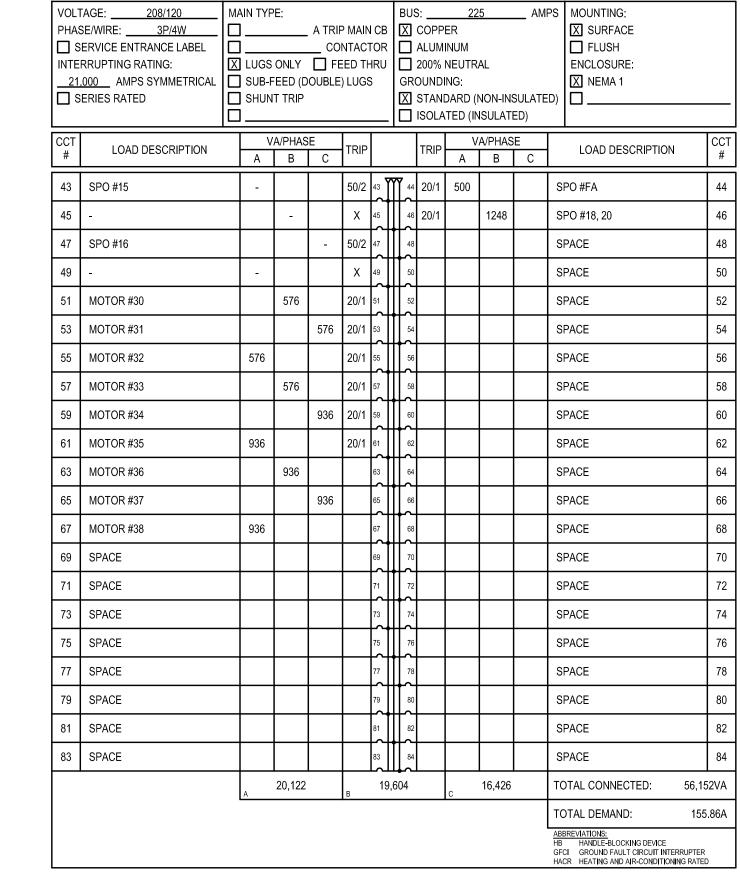

PANELBOARD SCHEDULE: RP/A (TUB-2)

PANELBOARD SCHEDULE NOTES:

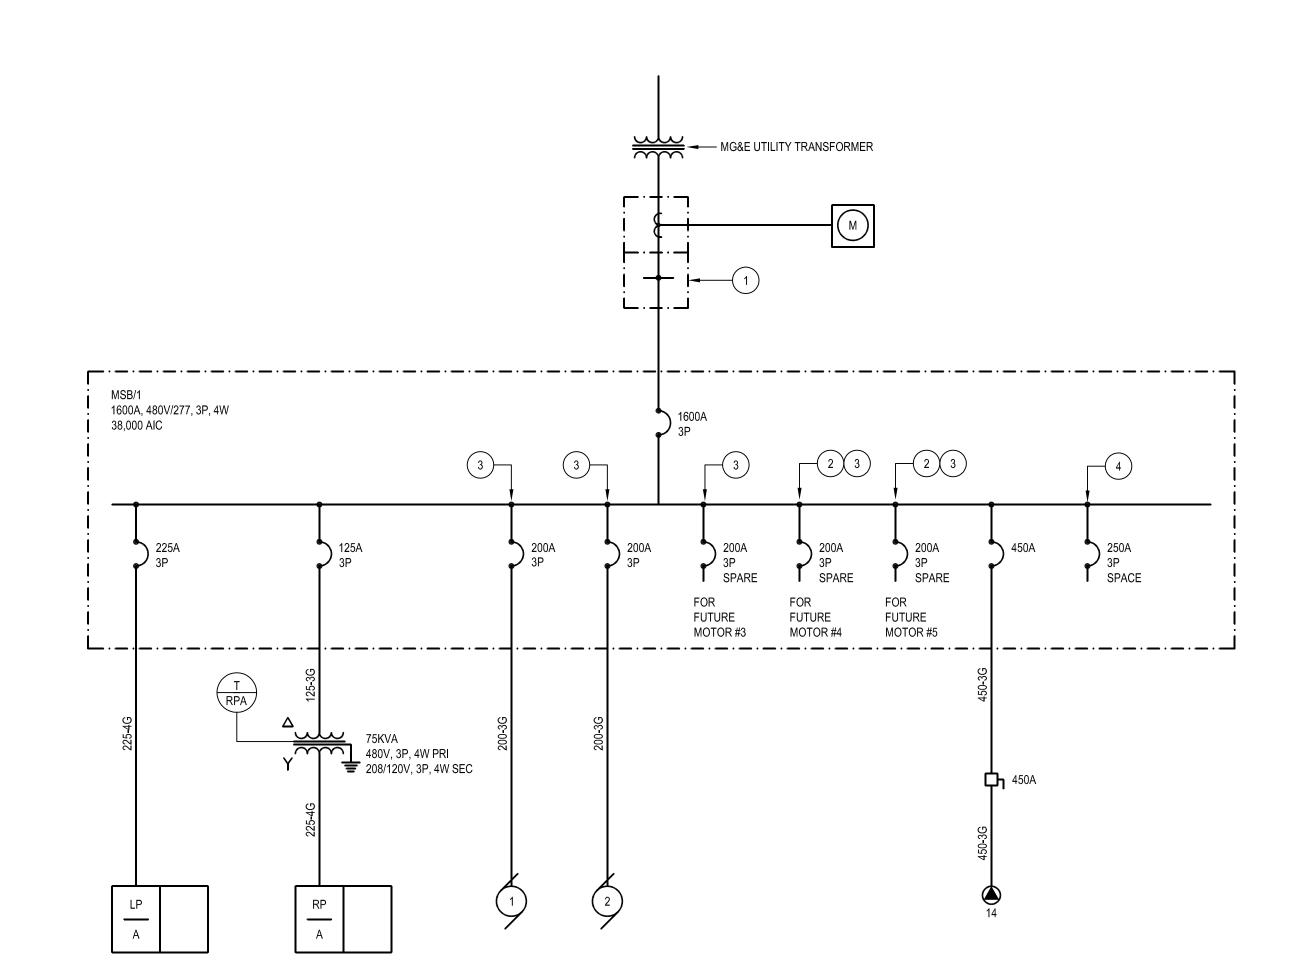


ONE LINE DIAGRAM NOTES:

- 1 EC TO PROVIDE 1,600A, 480VOLT, 3-PHASE, 4-WIRE TRANSOCKET WITH METER SOCKET. EC TO COORDINATE WITH UTILITY FOR ACCEPTABLE MANUFACTURES FOR EXACT REQUIREMENTS.
- 2 EC TO PROVIDE 200A, 3-POLE, SPACE CIRCUIT BREAKERS FOR FUTURE COMPACTORS
- 3 EC TO PROVIDE INVERSE TIME BREAKER FOR COMPACTORS.
- EC TO PROVIDE SPACES FOR (5) ADDITIONAL 250A 3P BREAKERS

	FEE	EDER SCHE	DULE	
FEEDER	CONDUCTOR	SIZE (kcmil)	CONDU	JIT SIZE
AMPACITY	PH AND N	GRD	(3) AND (3G)	(4) AND (4G)
50	#8	#10	3/4"	1"
70	#4	#8	1-1/4"	1-1/4"
80	#4	#8	1-1/4"	1-1/4"
100	#3	#8	1-1/4"	1-1/4"
110	#2	#6	1-1/4"	1-1/2"
125	#1	#6	1-1/2"	2"
150	#1/0	#6	1-1/2"	2"
175	#2/0	#6	2"	2"
200	#3/0	#6	2"	2-1/2"
225	#4/0	#4	2"	2-1/2"
250	#250	#4	2-1/2"	3"
300	#350	#4	3"	3"
350	#500	#3	3"	3-1/2"
380	#500	#3	3"	3-1/2"
400	(2) #3/0	(2) #3	(2) 2"	(2) 2-1/2"
450	(2) #4/0	(2) #2	(2) 2"	(2) 2-1/2"
500	(2) #250	(2) #2	(2) 2-1/2"	(2) 3"
600	(2) #350	(2) #1	(2) 3"	(2) 3"
700	(2) #500	(2) #1/0	(2) 3"	(2) 3-1/2"
800	(2) #600	(2) #1/0	(2) 3-1/2"	(2) 4"
1000	(3) #400	(3) #2/0	(3) 3"	(3) 3-1/2"
1200	(3) 600	(3) #3/0	(3) 3-1/2"	(3) 4"
1600	(4) 600	(4) #4/0	(4) 3-1/2"	(4) 4"
2000	(5) 600	(5) #250	(5) 3-1/2"	(5) 4"

GENERAL NOTES:

- ABOVE FEEDER SCHEDULE IS SCHEDULE OF TYPICAL FEEDERS AND SOME SIZES MAY NOT BE UTILIZED.
- ALL CONDUCTOR AMPACITIES ARE BASED ON TABLE 310-16 OF NEC FOR COPPER CONDUCTOR TYPE THW / THWN.
- 3. FEEDER SIZES SHOWN ON RISER DIAGRAM INDICATE FEEDER AMPACITIES AND DO NOT NECESSARILY CORRESPOND TO CIRCUIT BREAKER AMPACITIES. CERTAIN FEEDERS MAY BE SIZED FOR DERATING FACTORS REQUIRED BY CODE AND / OR ARE OVERSIZED FOR

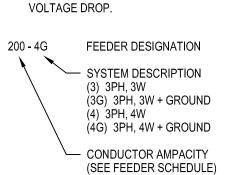



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CONSULTANTS:

PROJECT TITLE:

DANE COUNTY
WASTE TRANSFER STATION
AND HOUSEHOLD HAZARDOUS
WASTE FACILITY
RODEFELD LANDFILL

ISSUE:

PROJECT INFORMATION:

PROJECT NUMBER: 2009-0328.00

DATE: 05-11-2010

DRAWN BY: JAH

CHECKED BY: AAS


APPROVED BY: JHK
SCALE: AS NOTED

SHEET TITLE:

ELECTRICAL SCHEDULES & ONE-LINE DIAGRAM



E402

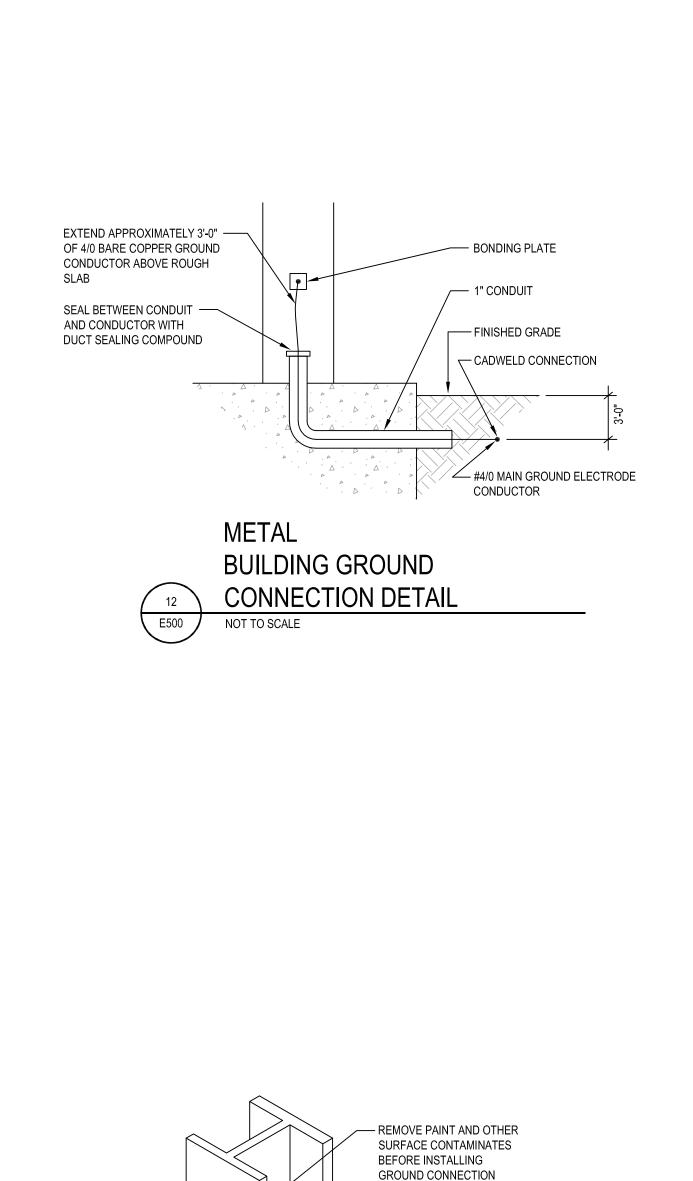

— EXOTHERMIC WELD TO

— INSTALL PULL STRING IN

AT BOTH ENDS

CEILING CAVITY

TELEPHONE / DATA

OUTLET DETAIL

∠ 3/4" CONDUIT STUBBED INTO NEAREST ACCESSIBLE

CONDUIT AND BUSHINGS

✓ 4" SQUARE BOX WITH


SINGLE-GANG TRIM

GROUND

NOT TO SCALE

CONNECTION DETAIL

STRUCTURAL STEEL COLUMN

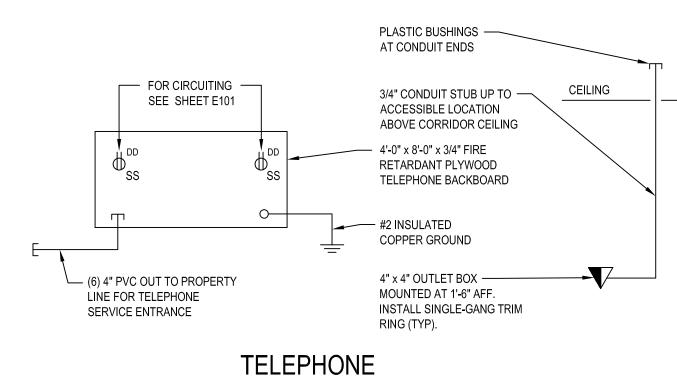

SERVICE RISER DIAGRAM

CELL AIR RETURN DUCT

— ACCESS PANEL BY

- FLEXIBLE CONDUIT

JUNCTION BOX

ON FIXED WALL

HVAC CONTRACTOR SHALL CUT HOLE —

IN ACCESS PANEL AS DIRECTED BY EC.

JUNCTION BOX, AND FACE OF ACCESS

EC SHALL PROVIDE CLOSED CELL,

NEOPRENE GASKET BETWEEN

MOUNTED SMOKE

DETECTOR DETAIL

NOT TO SCALE

SURFACE

ELEVATION OF DUCT

FROM WITHIN CHASE

HVAC CONTRACTOR

JUNCTION BOX MOUNTED

TO DUCT ACCESS PANEL

- SMOKE


DETECTOR


MOUNTED IN DUCT


SECTION

THROUGH DUCT


NOT TO SCALE

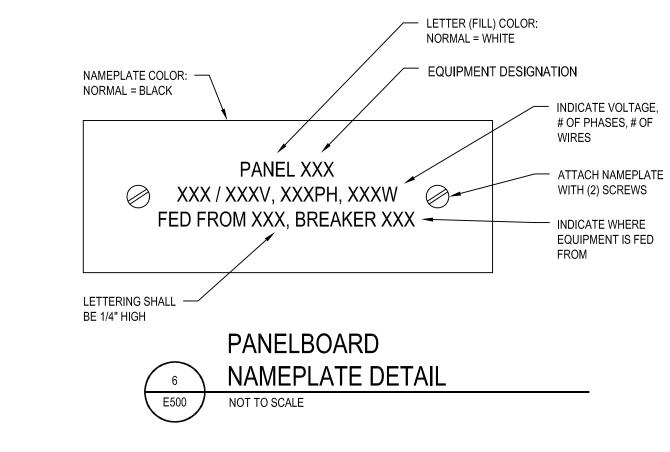


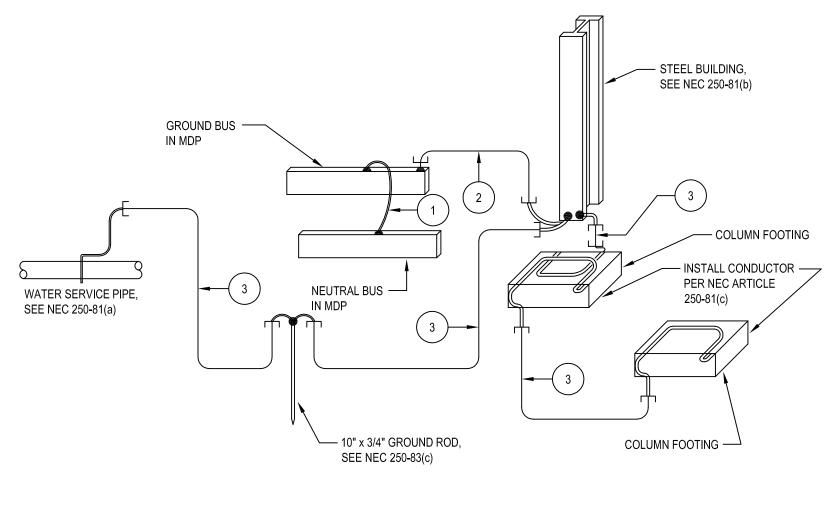


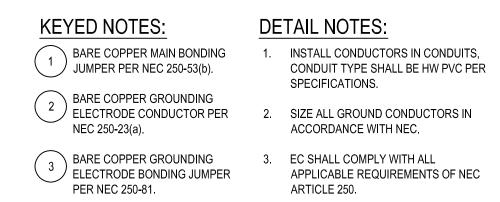





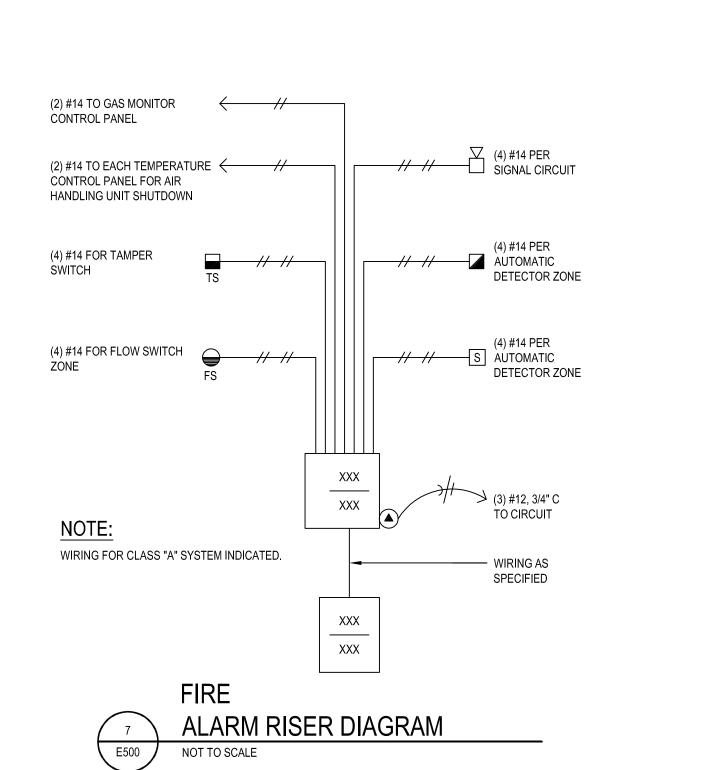

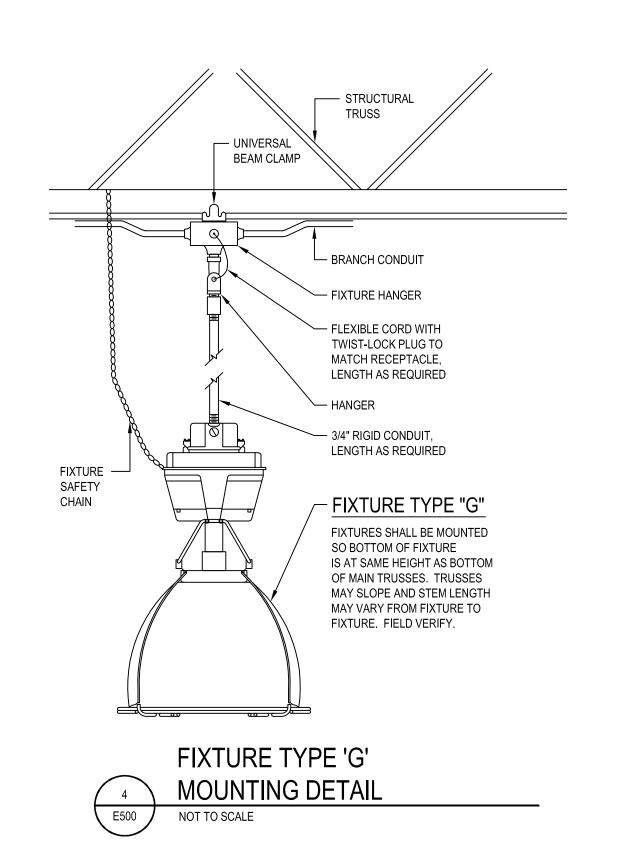

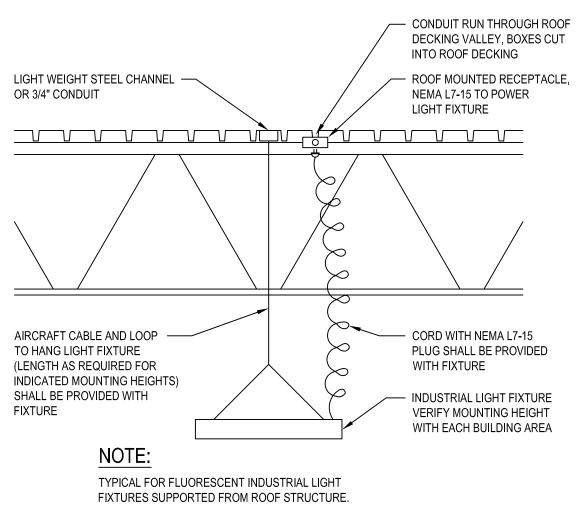

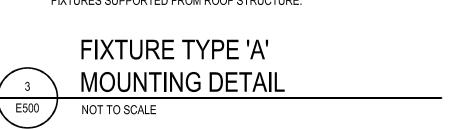

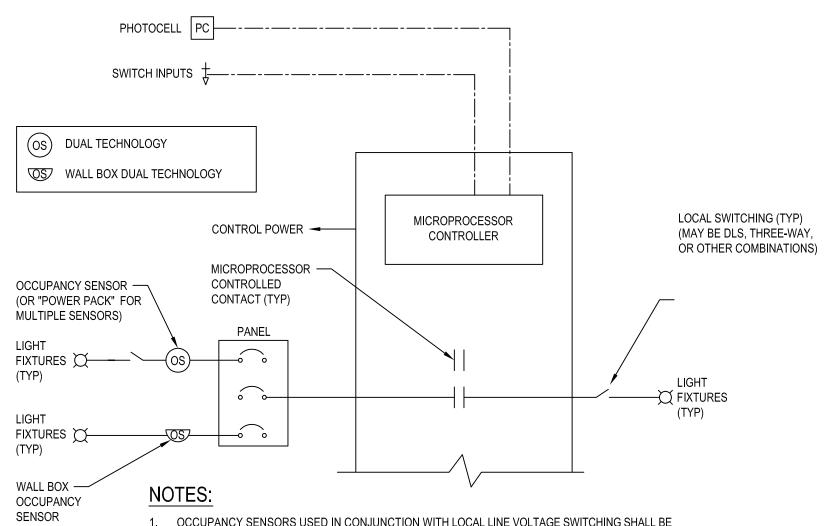

1. OCCUPANCY SENSORS USED IN CONJUNCTION WITH LOCAL LINE VOLTAGE SWITCHING SHALL BE ELECTRICALLY LOCATED ON PANEL SIDE OF SWITCH, AS INDICATED IN ABOVE DIAGRAM, UOI


2. BOTH SENSORS CONTROL SAME LIGHT FIXTURES VIA COMMON "POWER PACK" IN ROOMS SHOWN WITH (2) OR MORE OCCUPANCY SENSORS, UOI.

3. WHENEVER FEASIBLE, POWER PACKS SHALL BE LOCATED IN CEILING SPACE DIRECTLY ABOVE LOCAL WALL SWITCH.

4. USE OF OCCUPANCY SENSOR SYMBOL IN ROOM INDICATES TYPE OF SENSOR TO BE USED TO CONTROL ALL LIGHTS IN SPACE. EXACT LOCATION, MOUNTING, AND CONFIGURATION OF SENSOR SHALL BE DETERMINED IN FIELD, BASED UPON MANUFACTURER'S RECOMMENDATIONS AND GUIDELINES.

5. SPECIFIC MODEL OF OCCUPANCY SENSOR SHALL BE COORDINATED WITH ROOM SIZE, LAYOUT, CEILING HEIGHT, AND MOUNTING REQUIREMENTS, SENSOR MANUFACTURER, AND CONTRACTOR. VERIFY DEVICE COLOR WITH ARCHITECT PRIOR TO ORDERING.

6. OCCUPANCY SENSOR MANUFACTURER SHALL PROVIDE HARD COPIES AND ELECTRONIC AUTOCAD DRAWINGS FILES OF LOCATION AND MODEL NUMBERS OF ALL ASSOCIATED EQUIPMENT.

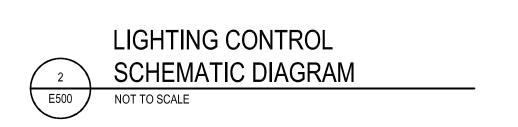

____ 277V ____ ROOM LIGHTING CIRCUIT — ROOM LIGHTING OCCUPANCY SENSOR -ROOM TOGGLE SWITCH



SYSTEM POWER PACK

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CONSULTANTS:

PROJECT TITLE:

DANE COUNTY WASTE TRANSFER STATION AND HOUSEHOLD HAZARDOUS WASTE FACILITY RODEFELD LANDFILL

ISSUE:


PROJECT INFORMATION:

PROJECT NUMBER: 2009-0328.00 DATE: 05-11-2010 CHECKED BY: APPROVED BY: JHK


SCALE: AS NOTED

SHEET TITLE:

ELECTRICAL DETAILS

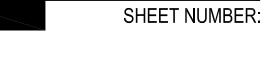

E500

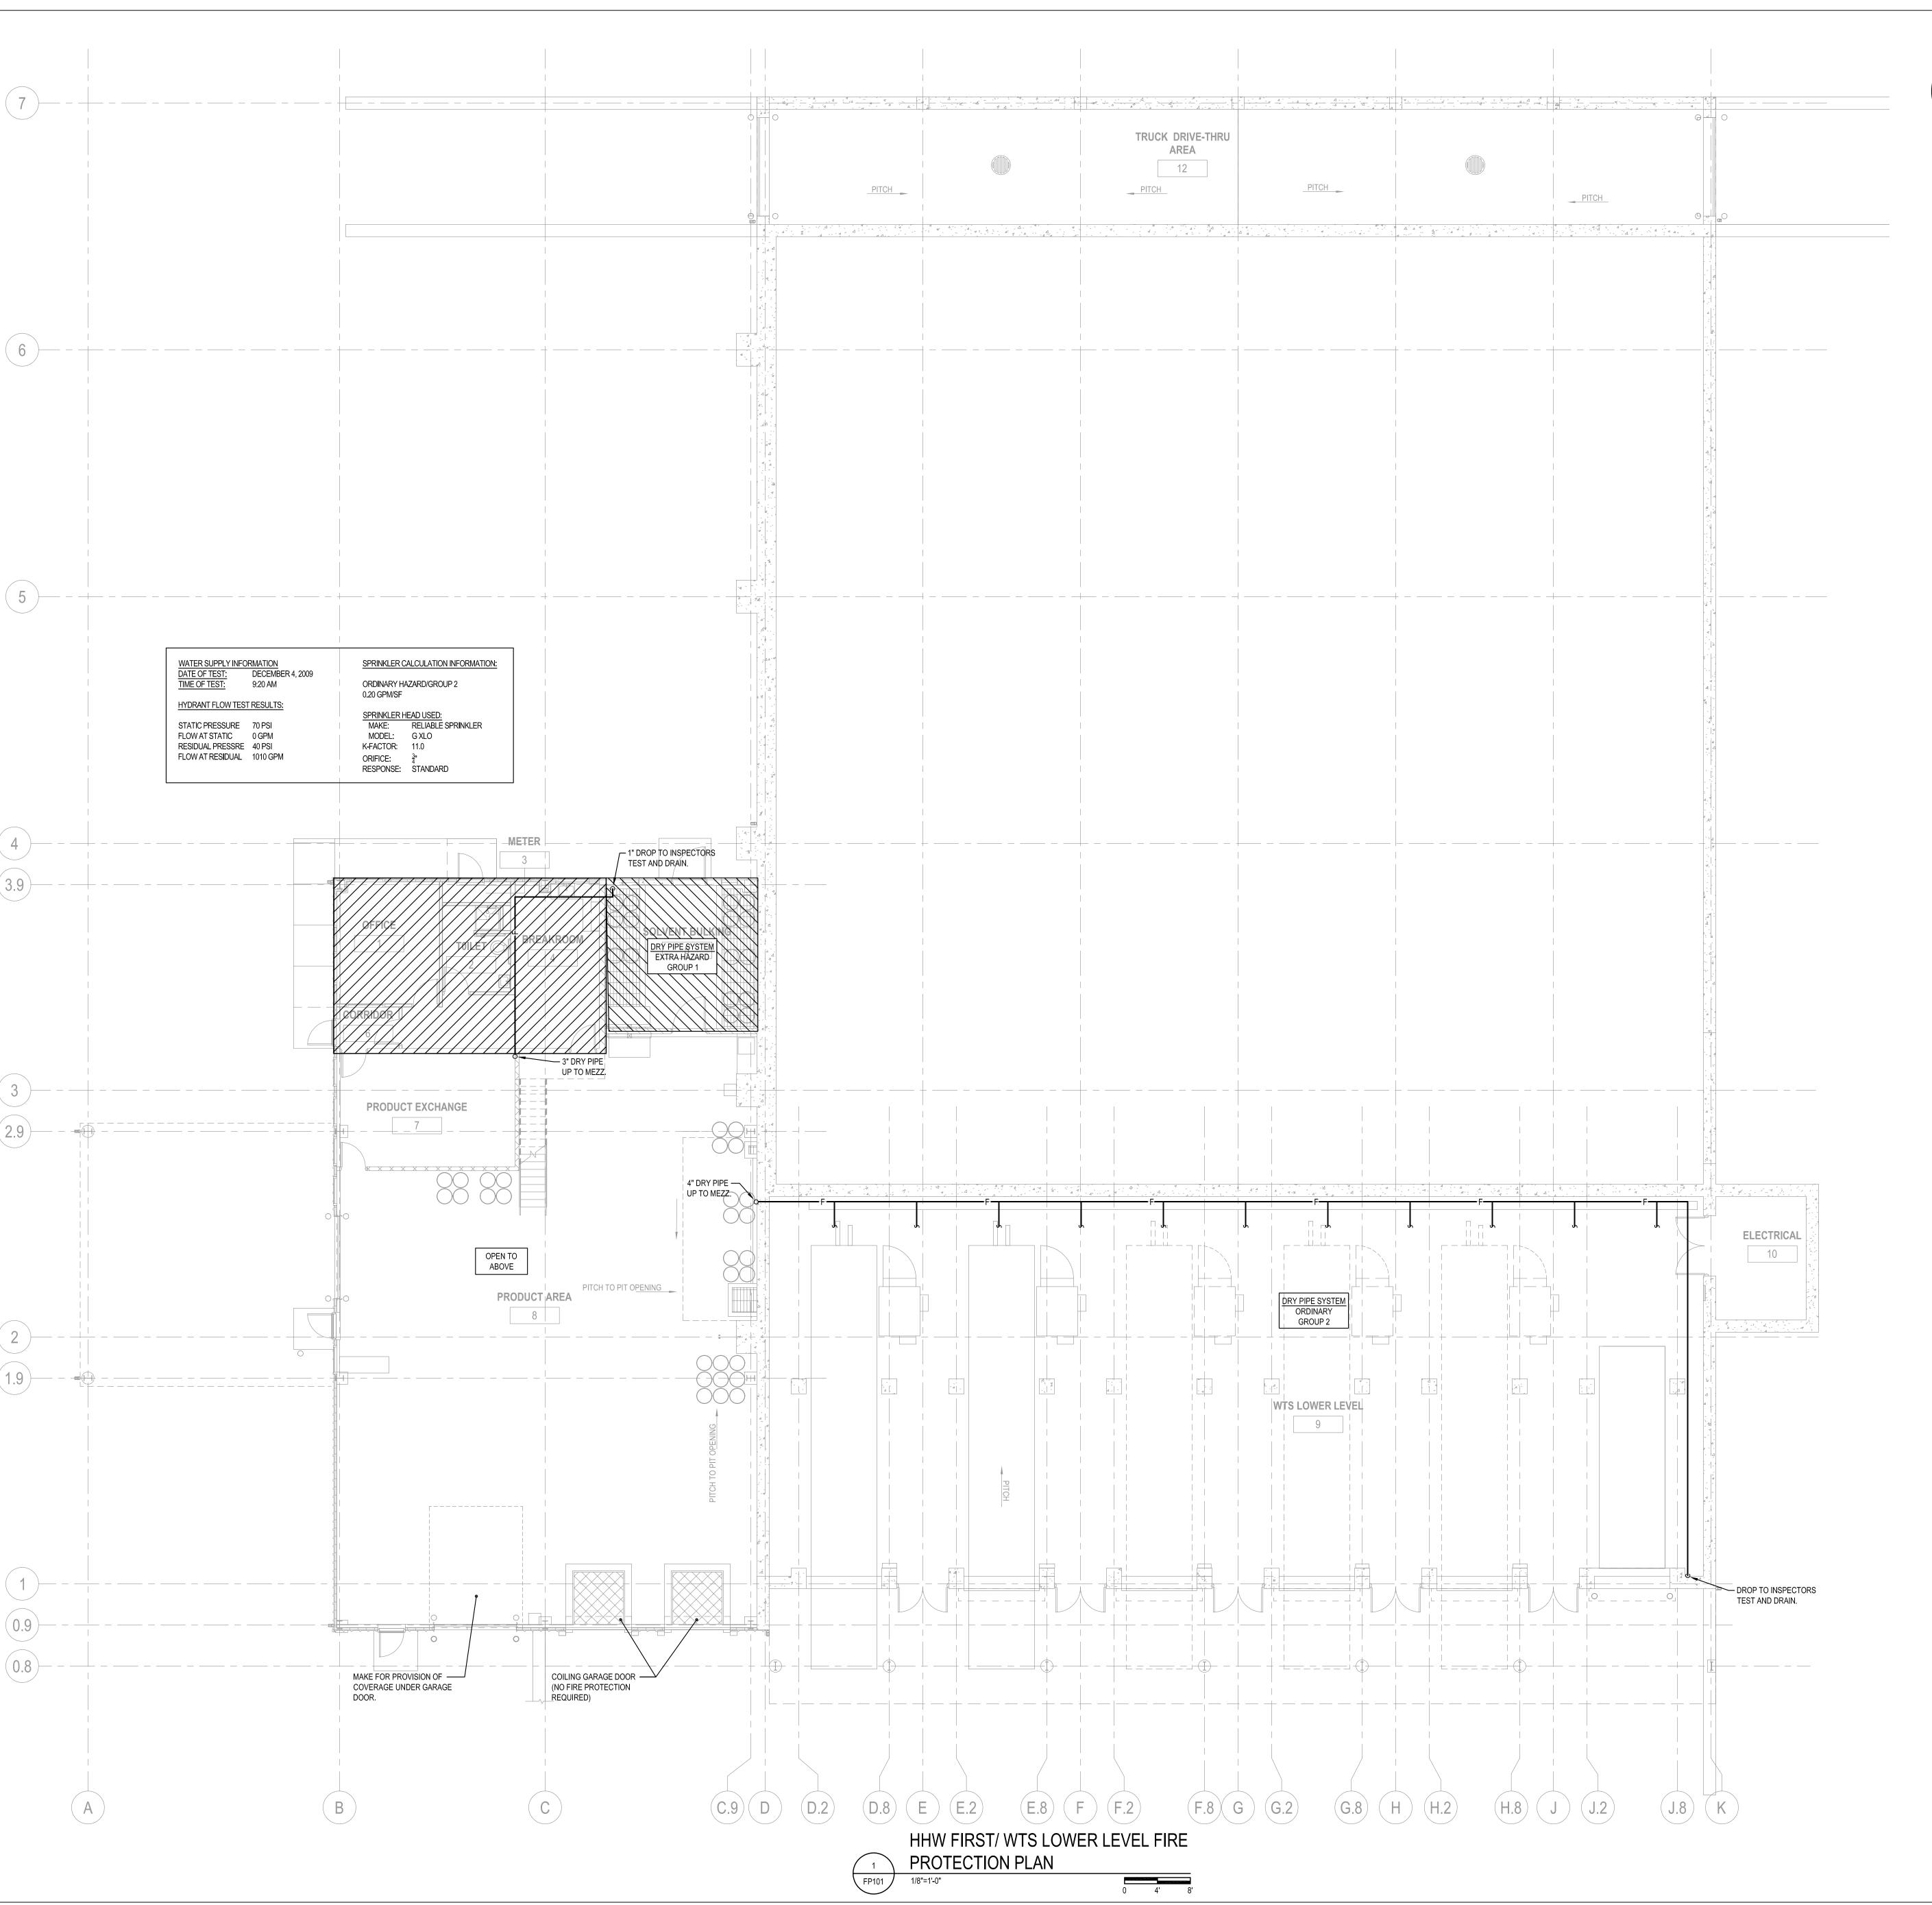

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CONSULTANTS:

PROJECT TITLE:

DANE COUNTY
WASTE TRANSFER STATION
AND HOUSEHOLD HAZARDOUS
WASTE FACILITY
RODEFELD LANDFILL

ISSUE:

PROJECT INFORMATION

PROJECT NUMBER: 2009-0328.00

ATE: 05-11-2010

DRAWN BY


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APPROVED BY: PDZ


SCALE: AS NOTED

SHEET TITLE:

HHW FIRST/WTS LOWER
LEVEL FIRE PROTECTION PLAN

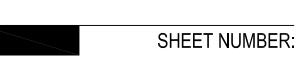

FP101

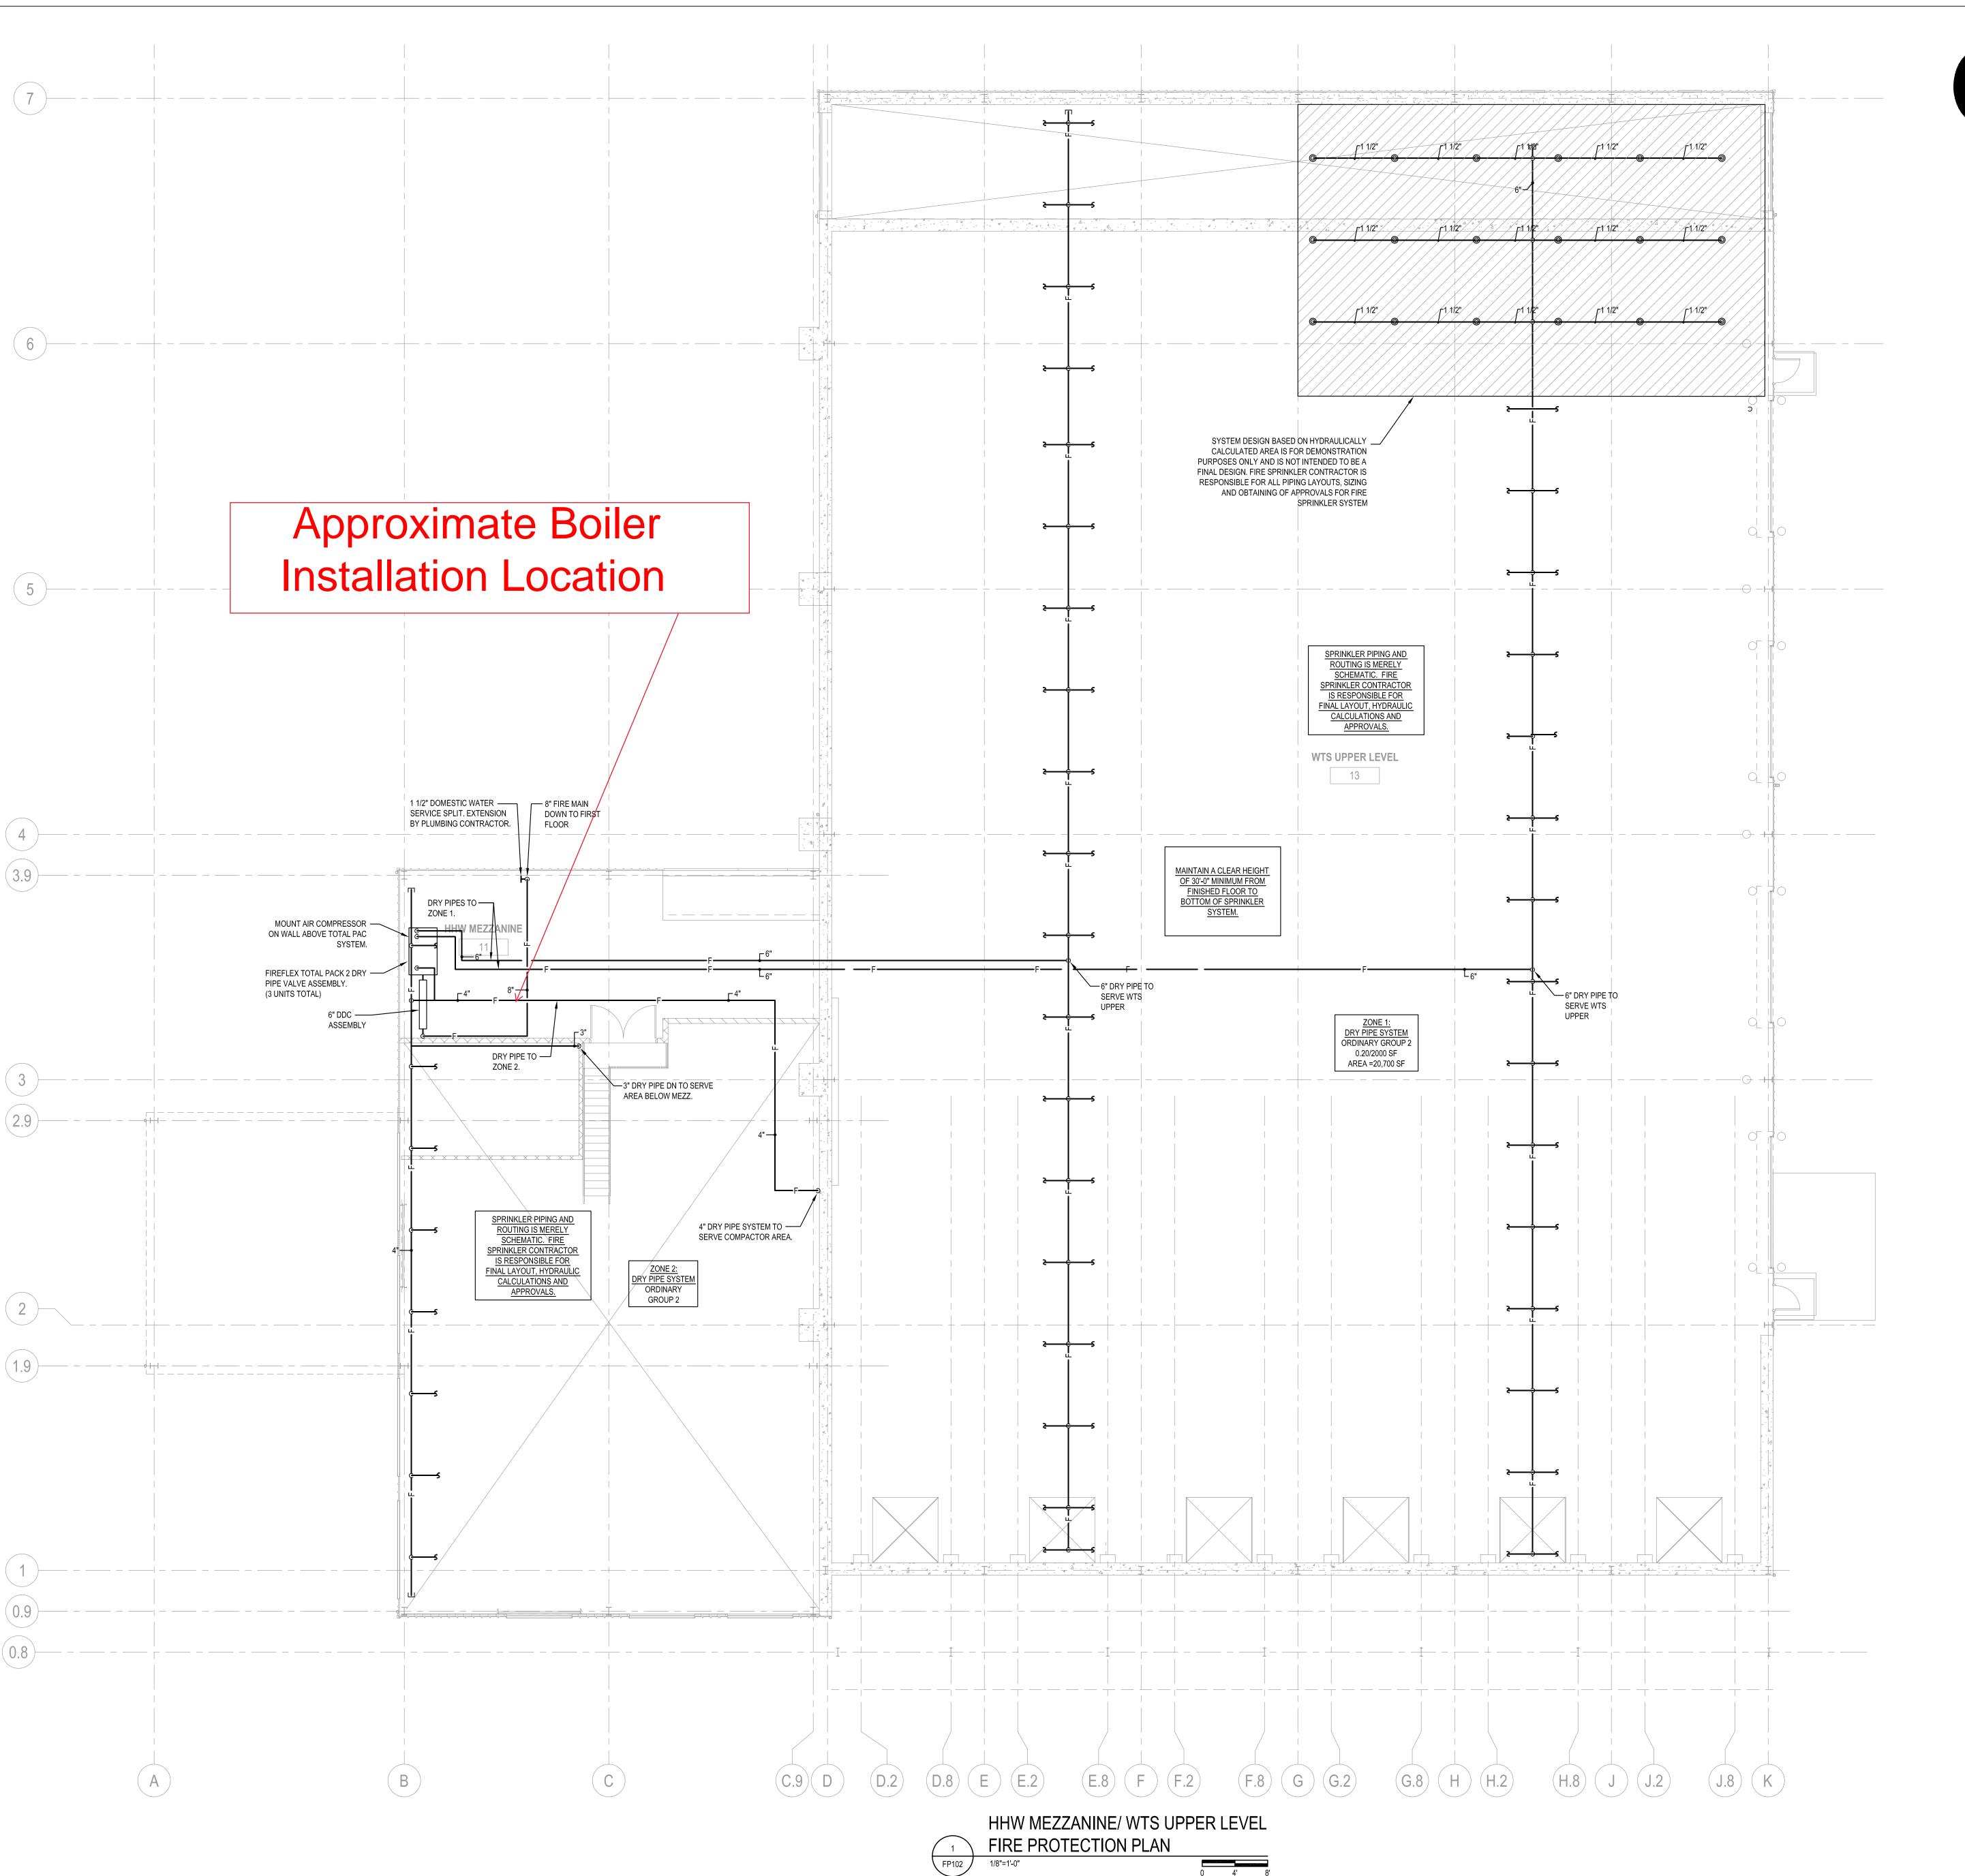

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CONSULTANTS:

PROJECT TITLE:

ISSUE:

DANE COUNTY
WASTE TRANSFER STATION
AND HOUSEHOLD HAZARDOUS
WASTE FACILITY
RODEFELD LANDFILL

PROJECT INFORMATION


PROJECT NUMBER: 2009-0328.00

DRAWN BY: BE
CHECKED BY: RA

APPROVED BY: PDZ
SCALE: AS NOTED

SHEET TITLE:


HHW MEZZANINE/WTS UPPER LEVEL FIRE PROTECTION PLAN

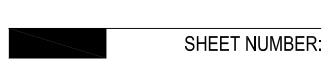

FP102

MECHANICAL SYMBOLS AND ABBREVIATIONS

NOTE: NOT ALL SYMBOLS AND ABBREVIATIONS INDICATED HERE ARE USED IN THE DRAWINGS AND MAY NOT APPLY TO THIS PROJECT. ADDITIONAL SYMBOLS MAY BE INDICATED IN THE DRAWINGS.

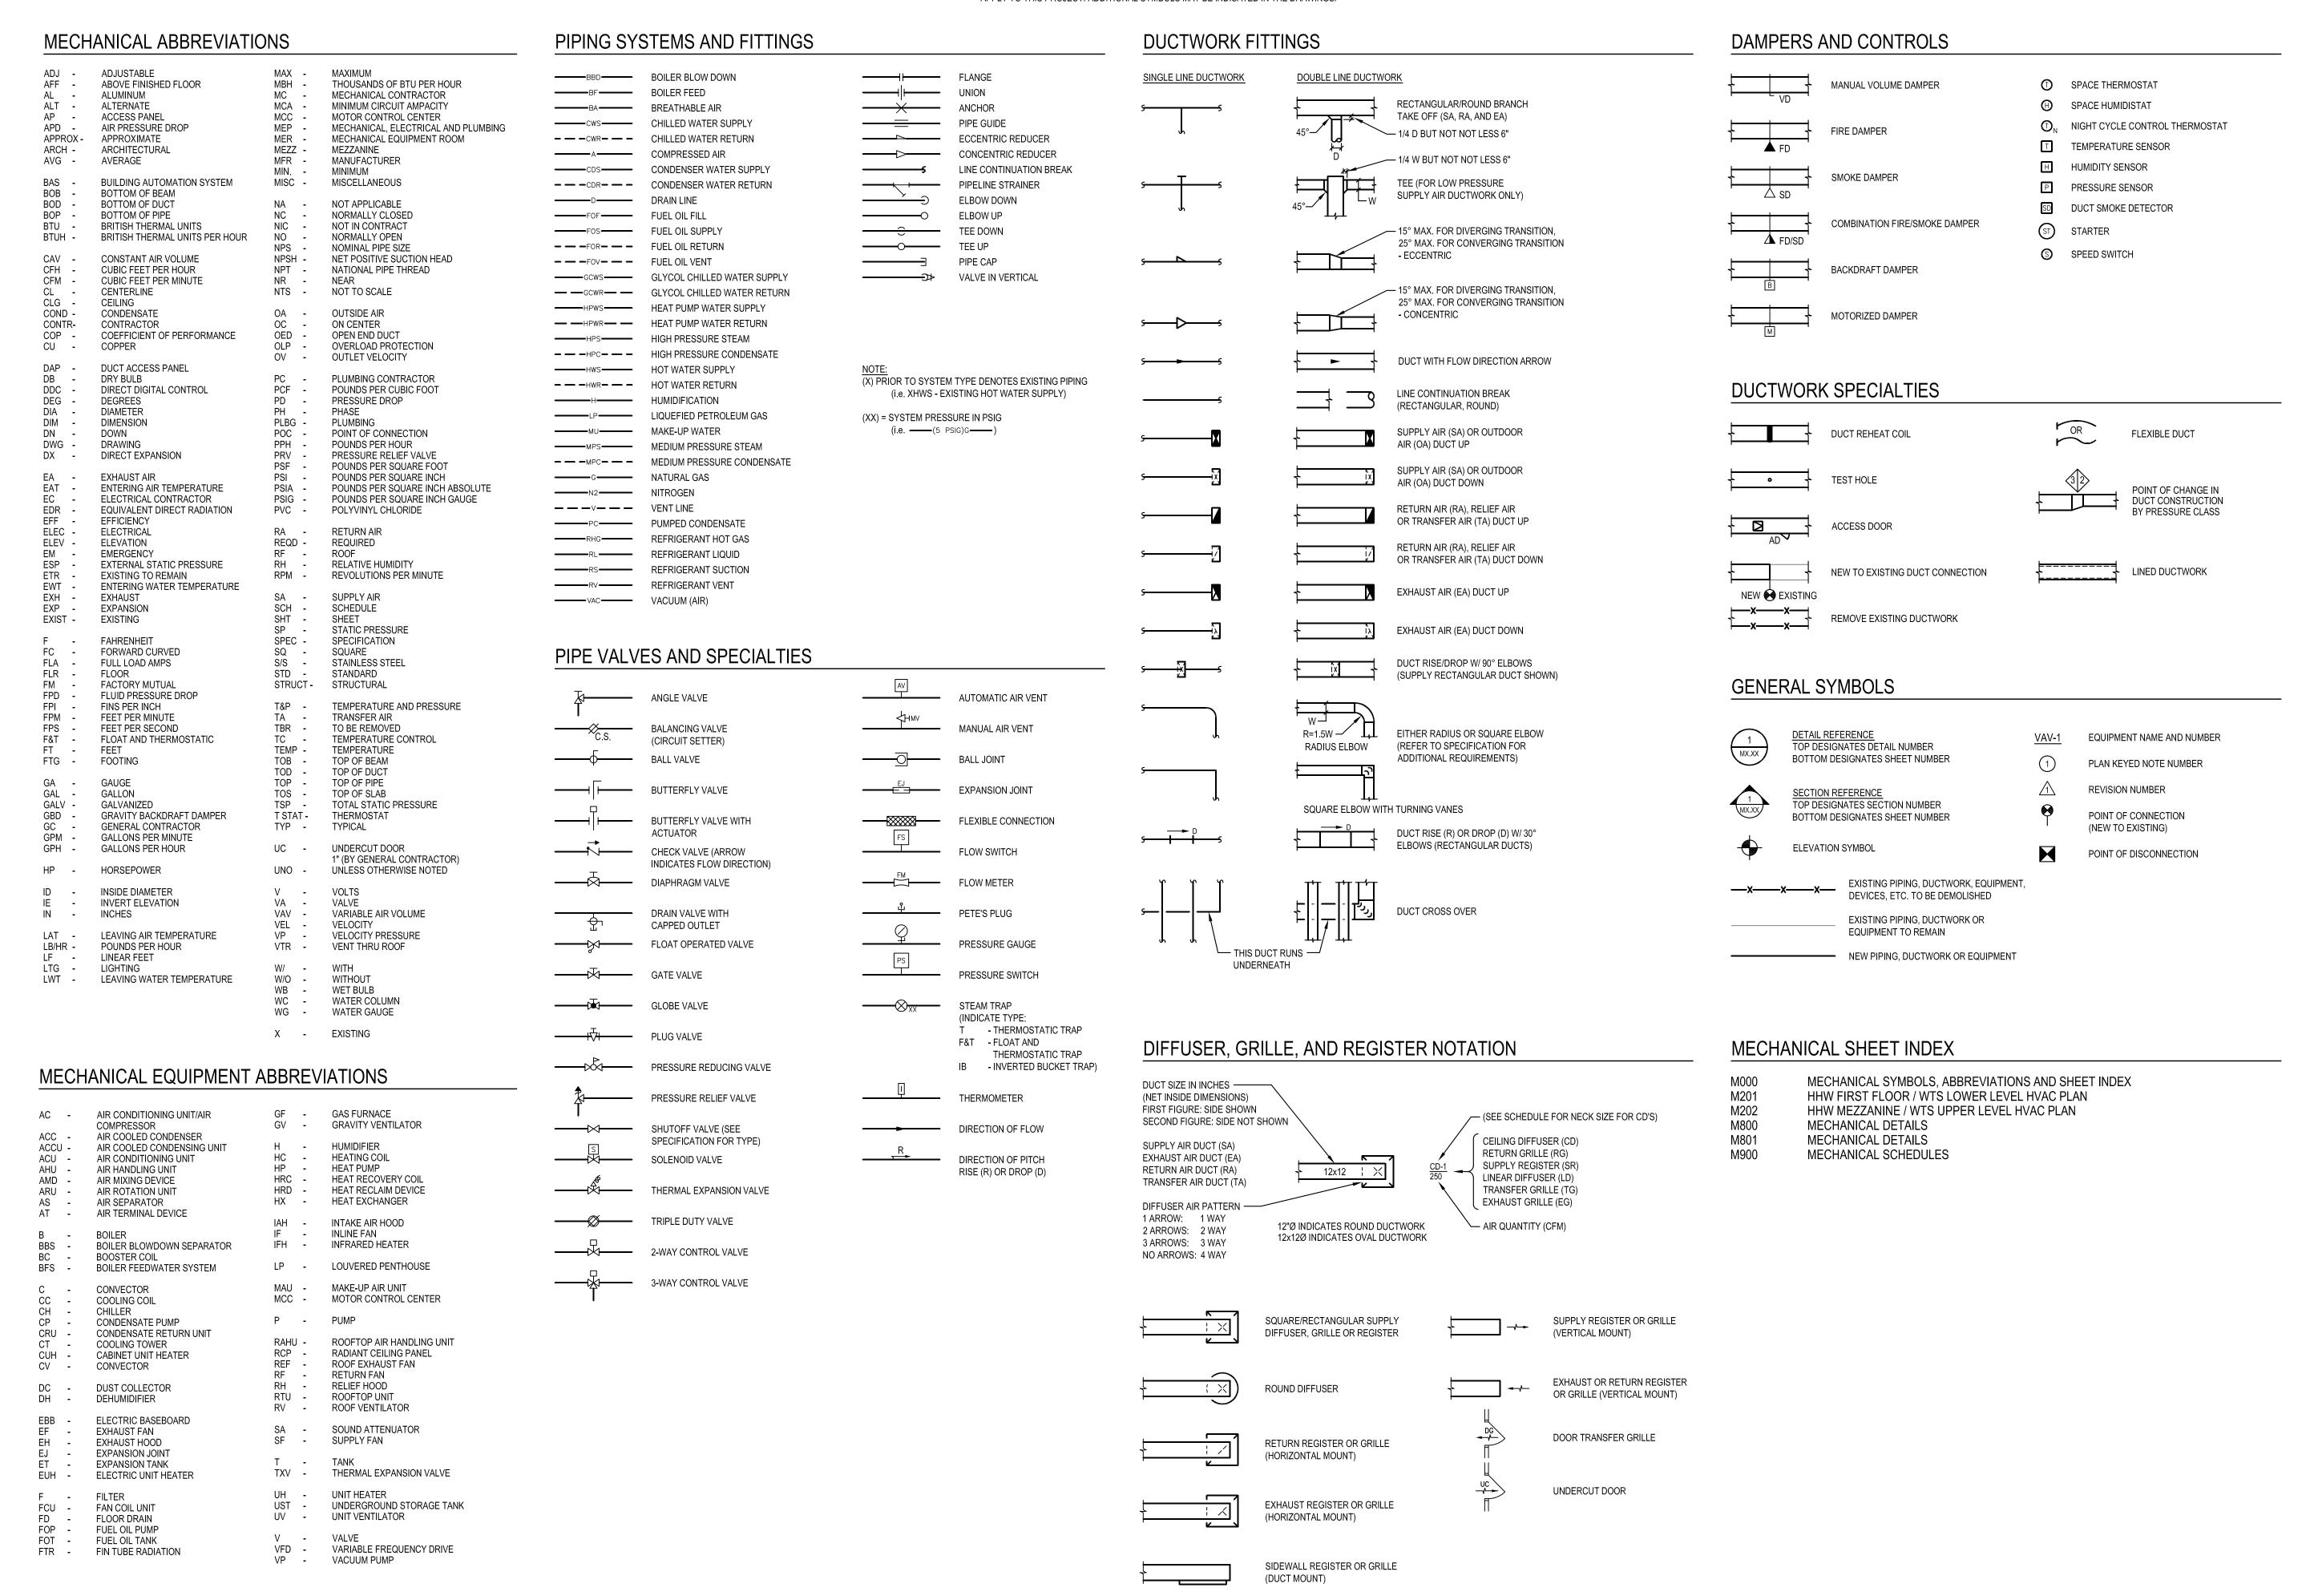



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WASTE FACILITY
RODEFELD LANDFILL

ISSUE:

PROJECT INFORMATION:
PROJECT NUMBER: 2009-0328.00

DATE: 05-11-2010 DRAWN BY: MHS

CHECKED BY: MEL APPROVED BY: PDZ


SCALE: AS NOTED

SHEET TITLE:

MECHANICAL SYMBOLS,
ABBREVIATIONS AND SHEET INDEX

SHEET NUMBER:

M000

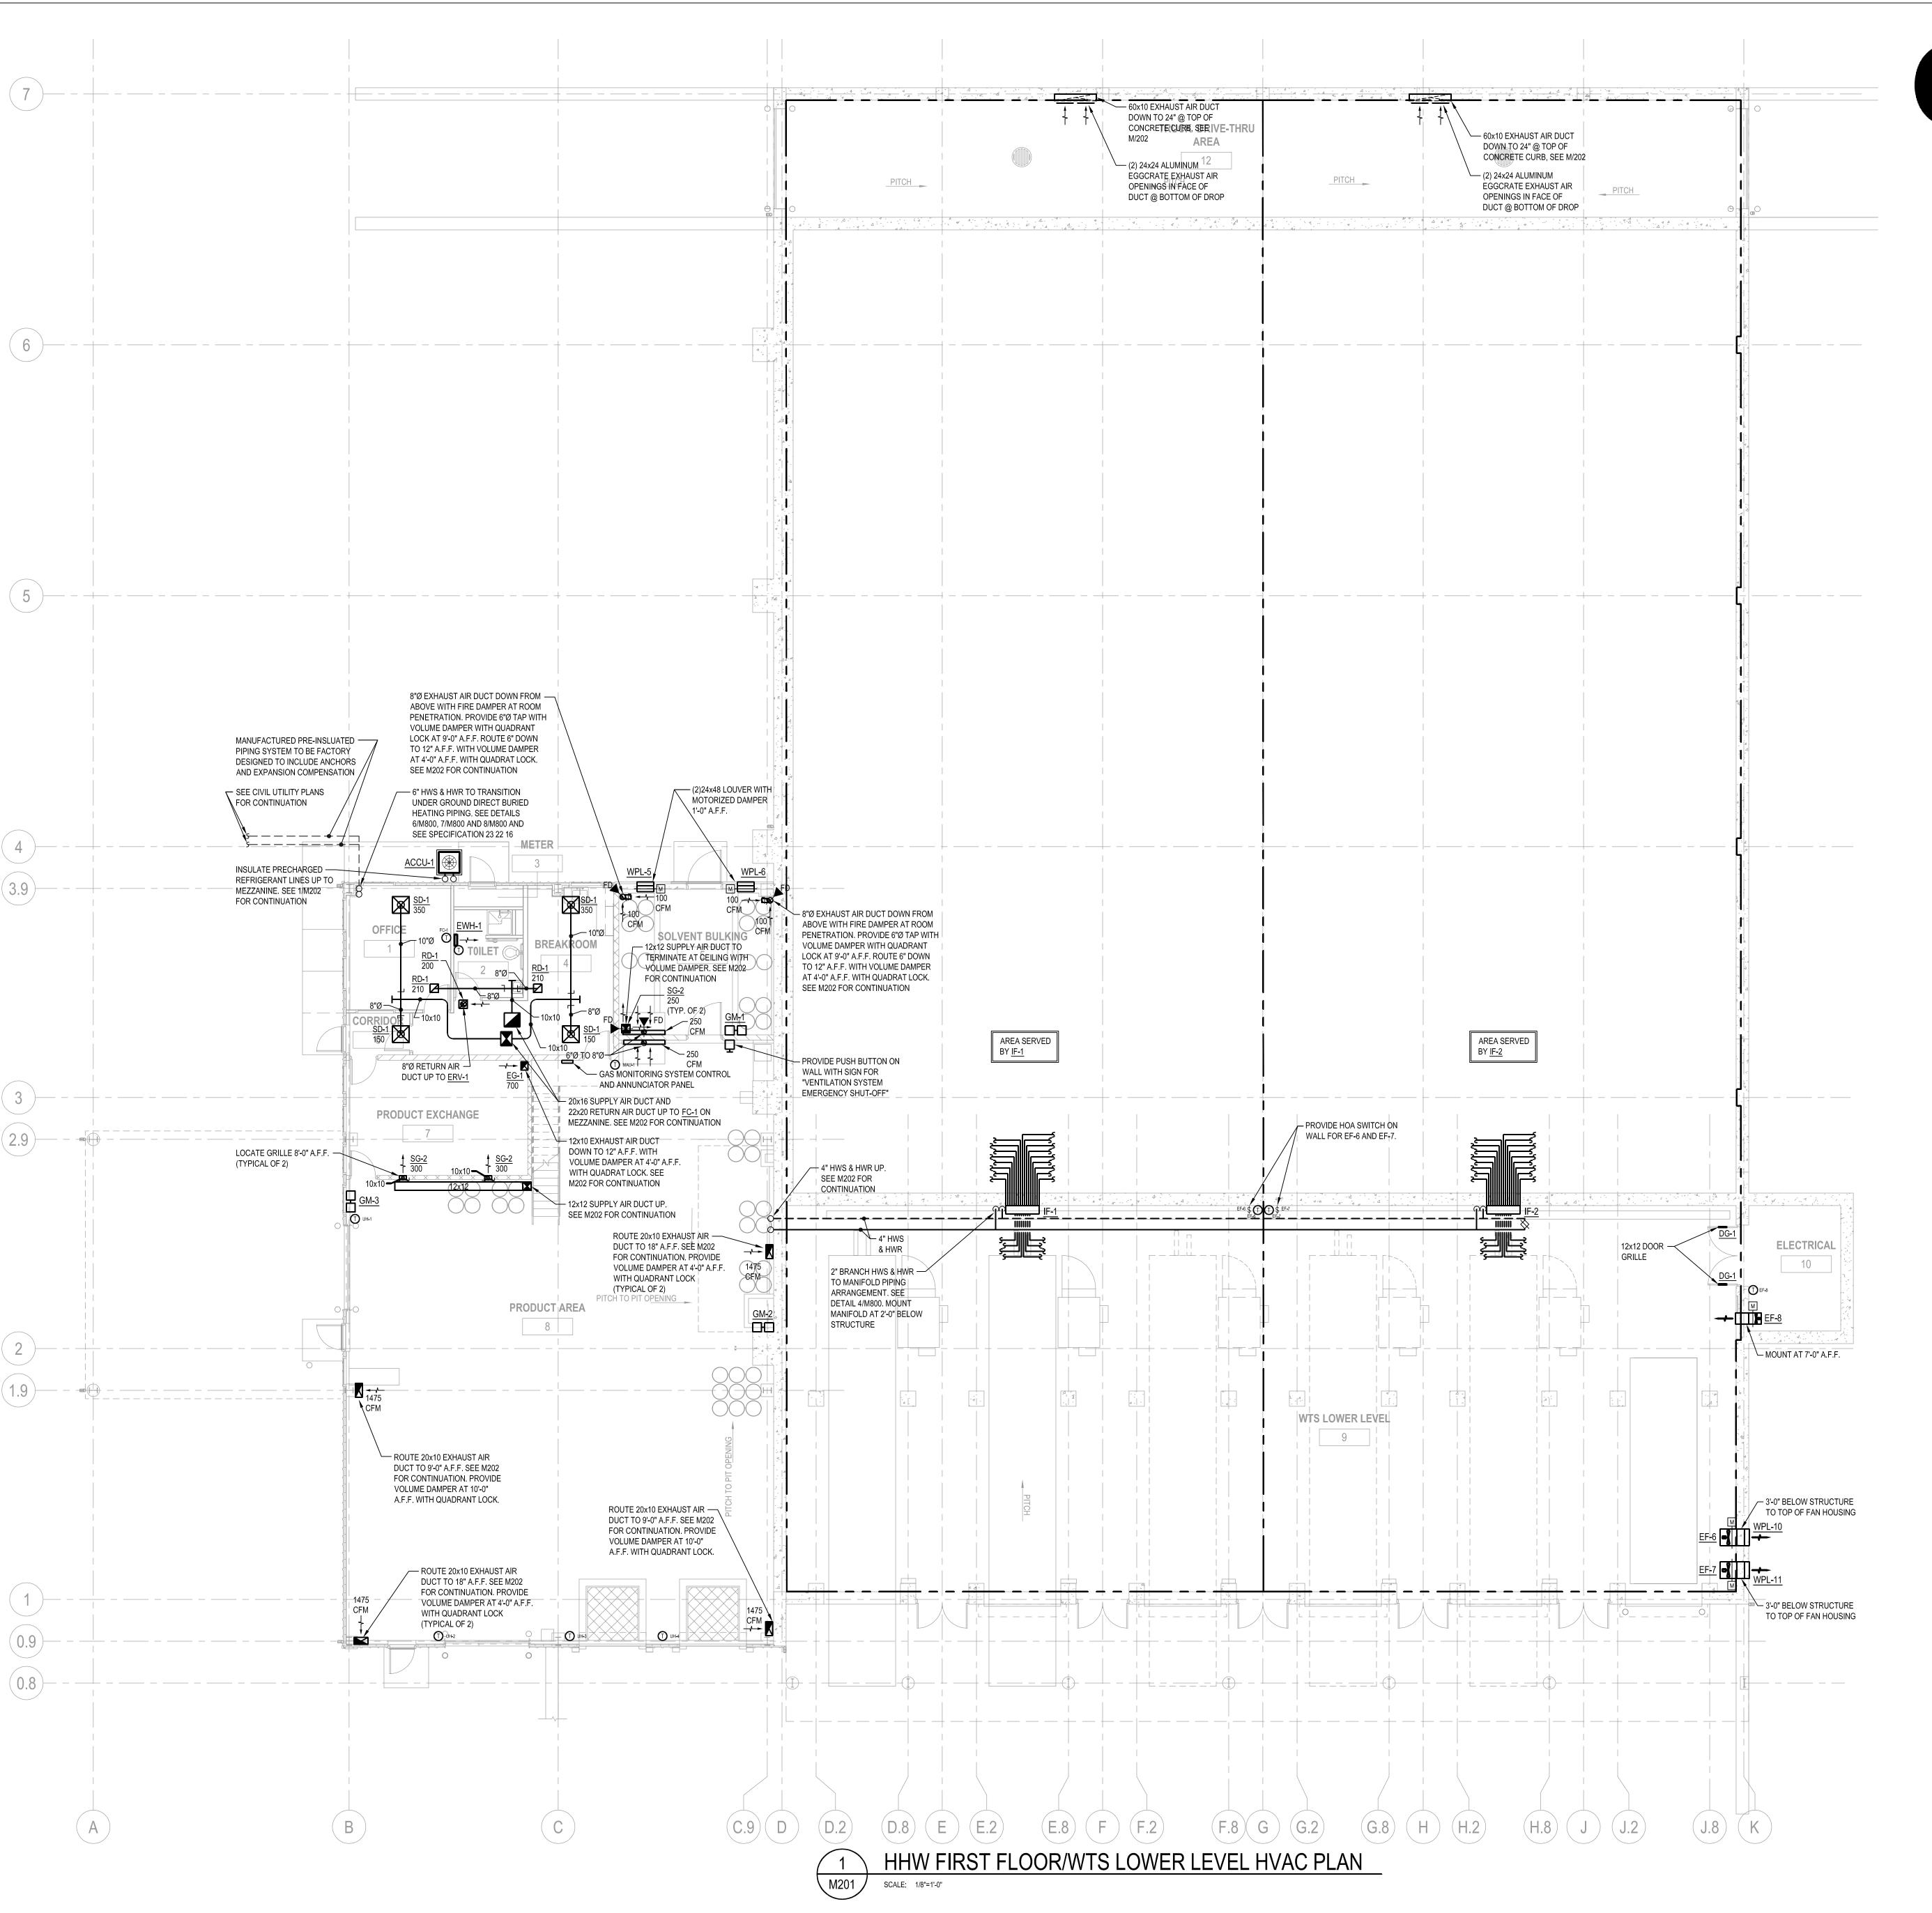

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DANE COUNTY
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WASTE FACILITY
RODEFELD LANDFILL

ISSUE:

PROJECT INFORMATION

PROJECT NUMBER: 2009-0328.00
DATE: 05-11-2010

DRAWN BY: ME


APPROVED BY: PDZ
SCALE: AS NOTED

SHEET TITLE:

HHW FIRST FLOOR/WTS LOWER LEVEL HVAC PLAN

SHEET NUMBER:

M201

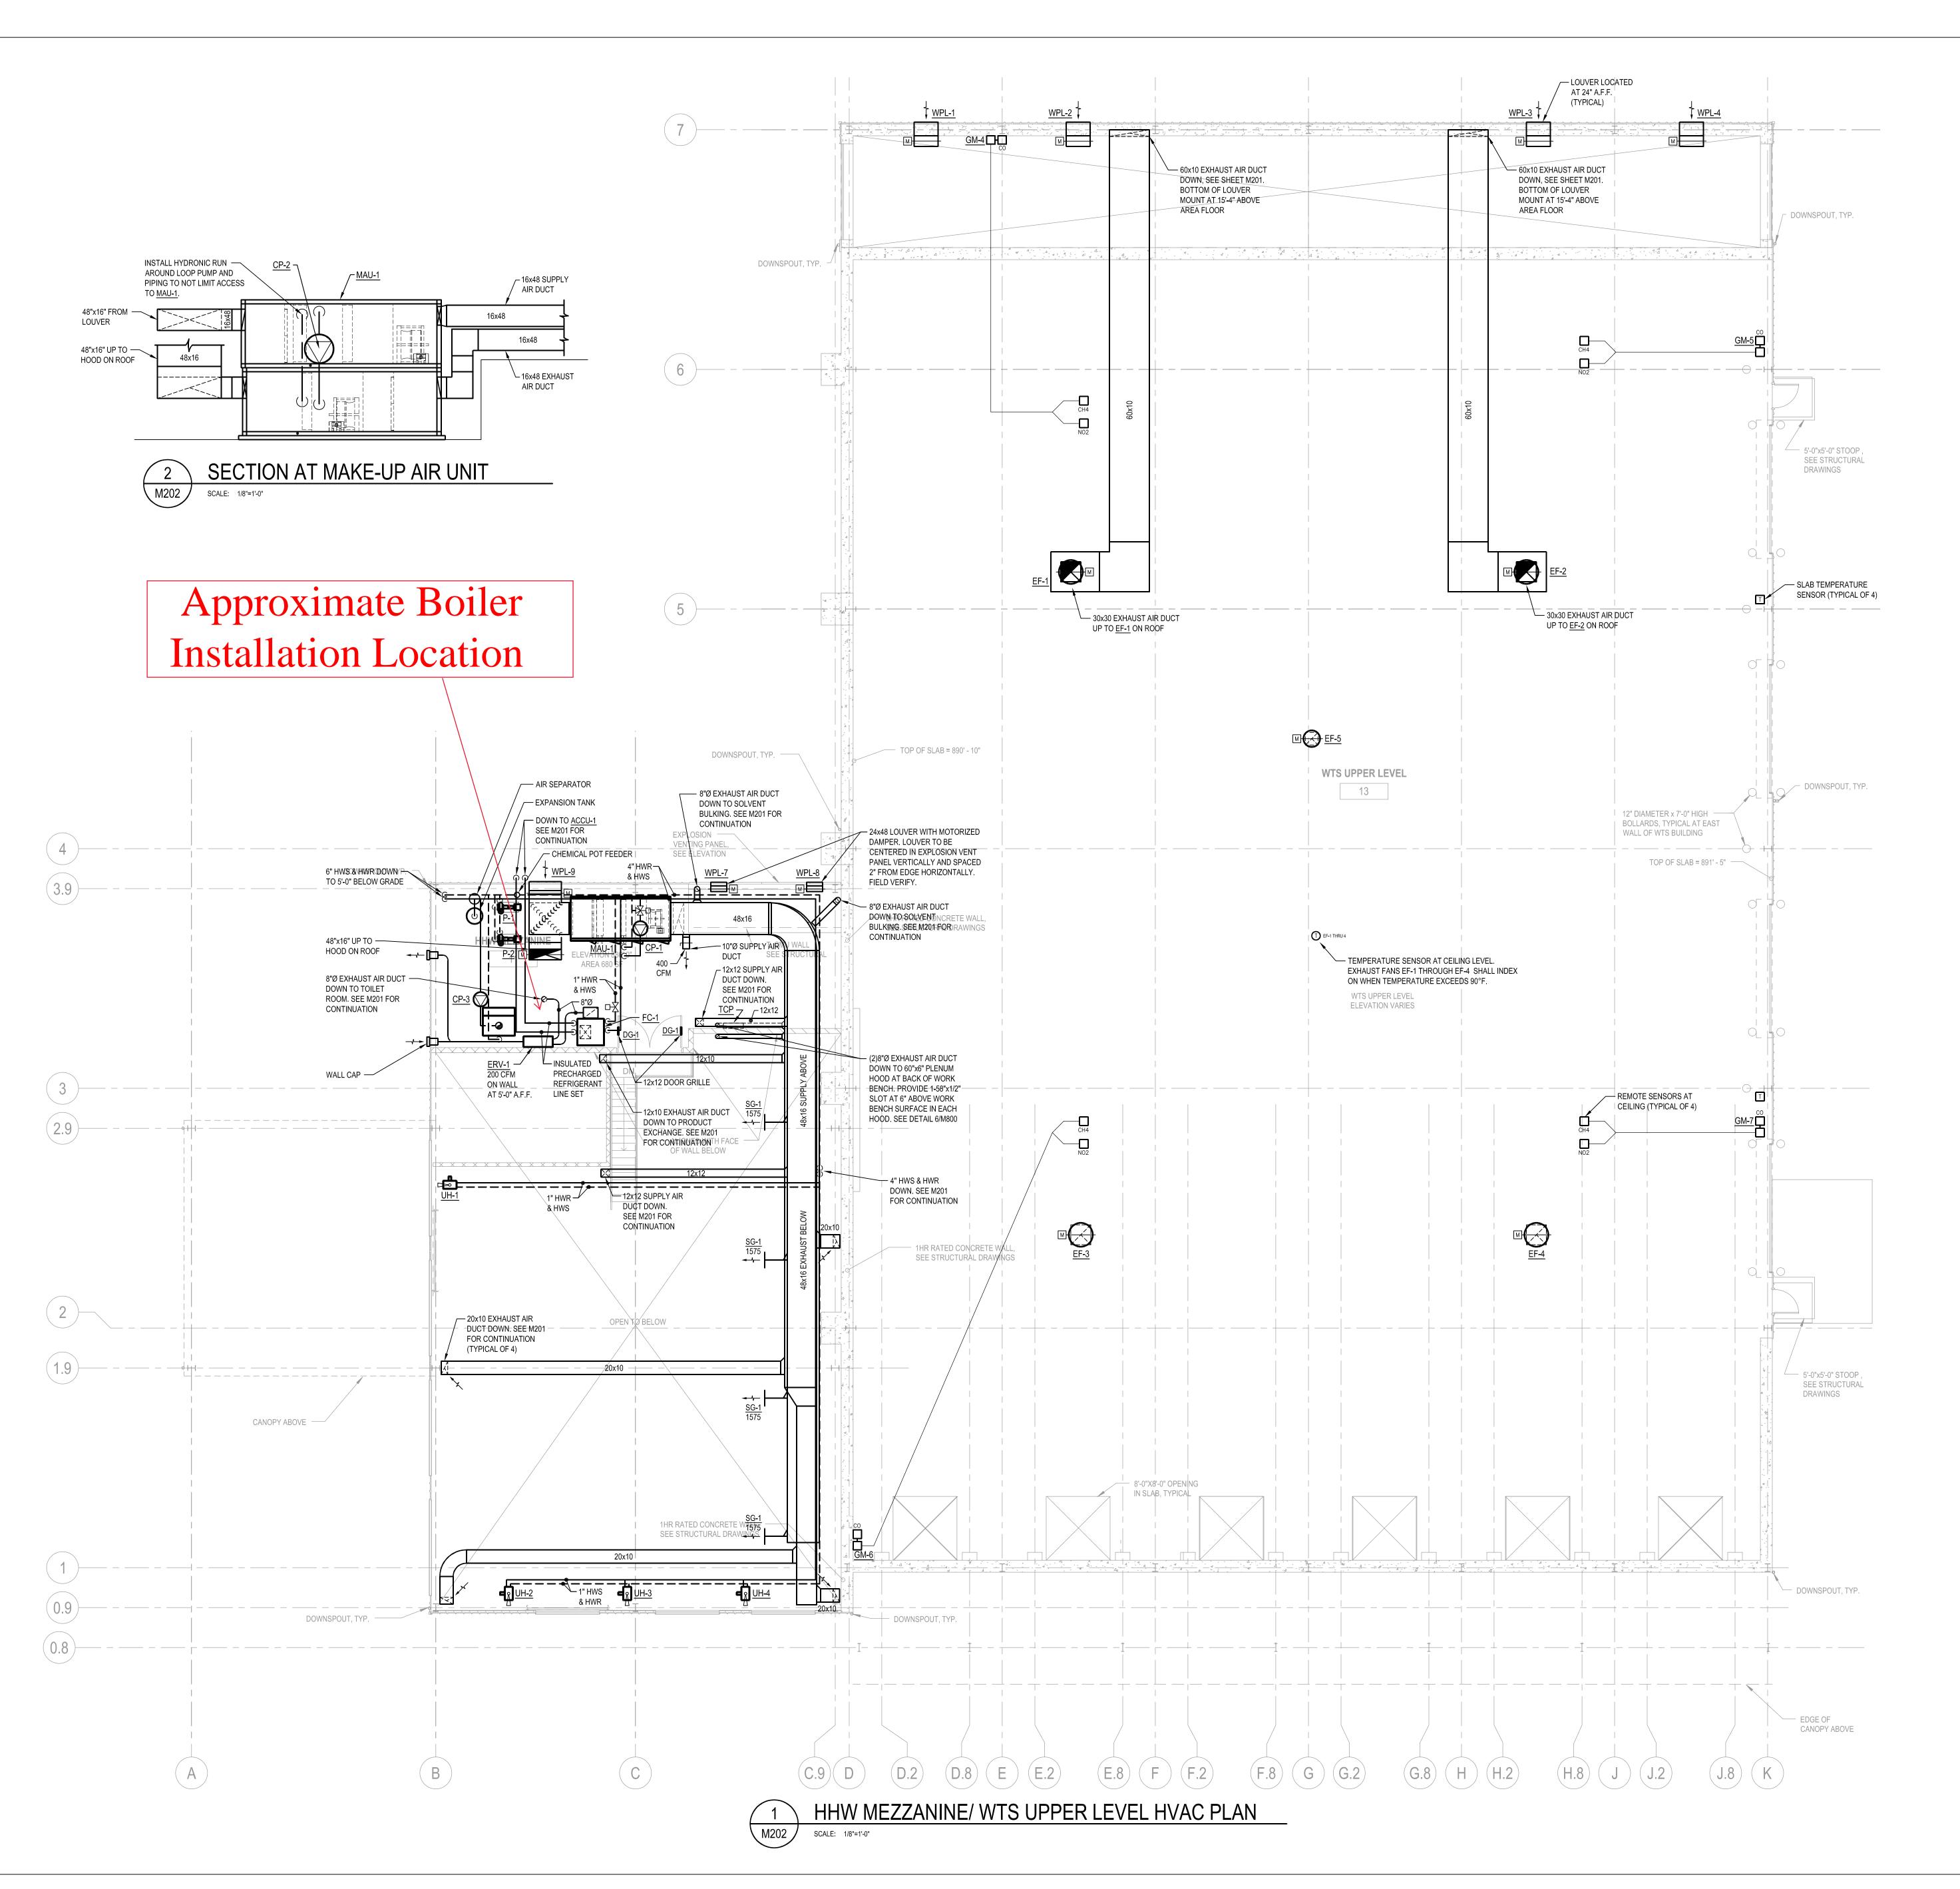



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CONSULTANTS:

PROJECT TITLE:

DANE COUNTY
WASTE TRANSFER STATION
AND HOUSEHOLD HAZARDOUS
WASTE FACILITY
RODEFELD LANDFILL

ISSUE:

PROJECT INFORMATION

PROJECT NUMBER: 2009-0328.00

DATE: 05-11-2010

DRAWN BY: MHS

CHECKED BY: MEL

APPROVED BY: PDZ

SCALE: AS NOTED

SHEET TITLE:

HHW MEZZANINE/WTS UPPER LEVEL

HVAC PLAN

SHEET NUMBER:

M202

MAKE-UP AIR UNIT WITH ENERGY RECOVERY (MAU) SUPPLY AIR SIDE EXHAUST AIR SIDE WINTER PERFORMANCE SERVES CONTROLS MANUFACTURER MODEL REMARKS FILTER SECTION ENERGY RECOVERY SECTION - WINTER FILTER SECTION FAN MOTOR ENERGY RECOVERY COIL SECTION HOT WATER COIL SECTION TYPE DRIVE BHP HP VOLT/PH TYPE EFFICIENCY EDB (°F) EWB (°F) LDB (°F) LWB (°F) MBH APD GPM GLYCOL (%) EAT (°F) LAT (°F) GPM WPD GLYCOL (%) TYPE DRIVE HP VOLT/PH TYPE | EFFICIENCY | EDB (°F) | EWB (°F) | LDB (°F) | LWB (°F) | VFD, DAT JOHNSON CONTROLS | SOLUTION 51x66



NOTES: VFD: PROVIDE SEPARATE VARIABLE FREQUENCY DRIVE FOR SUPPLY AND EXHAUST FAN SECTIONS. PROVIDE AIR FLOW METERS IN DUCT TO ALLOW FANS TO MATCH VOLUME FLOWRATES. DAT: CONTROL MODULATING HOT WATER FROM DISCHARGE AIR TEMPERATURE CONTROLLER TO PROVIDE A SUPPLY AIR TEMPERATURE OF 75° F (FIELD ADJUSTABLE).

- PROVIDE UNIT WITH MANUFACTURER PROVIDED VFDS. PROVIDE UNIT WITH DDC UNIT CONTROLLER WITH BACNET IP INTERFACE FOR BAS CONNECTION. CONTROLLER SHALL BE ACCESSIBLE FROM EXTERIOR OF UNIT VIA ACCESS DOOR OPENING.
- PROVIDE UNIT WITH FOLLOWING FACTORY MOUNTED OPTIONS: a. MOTOR OPERATED OUTDOOR AIR AND EXHAUST AIR LOW LEAKAGE DAMPERS. 4. EXHAUST FAN SHALL BE EXPLOSION PROOF MOTOR AND ALUMINUM WHEEL AND HOUSING.

		RAD	IANT F	LOOR F	PERFO	RMANC	E SCHEDU	JLE			
			ŀ	HYDRONIC	S			LOOP	PS		
UNIT NO.	AREA (SQ. FT.)	HEAT (BTU/SQ. FT.)	EWT (°F)	LWT (°F)	GPM	GLYCOL (%)	CONTROL VALVE	NUMBER OF LOOPS	SPACING (IN.)	SIZE (IN.)	HEAD (FT. HD)
IF-1	13,000	38.5	140	120	46	30 PG	3-WAY MIXING	19	18" O.C.	3/4" PEX	23
IF-2	13,000	38.5	140	120	46	30 PG	3-WAY MIXING	19	18" O.C.	3/4" PEX	23

OUTDOOR AIR RESET.

SLAB TEMPERATURE SENSORS AVERAGED (4). 3. ROTH RADIANT SYSTEMS USED AS BASIS OF DESIGN, AS REPRESENTED BY FLUID HANDLING

INCORPORATED (414) 358-2646.

		GAS MONITO	ORING DE	VICE SCHED	ULE (GN	1)		
UNIT		GAS MONITOR SENSOR INFORMATION		DISPLAY		POWER SUPPLY		
NO.	CONSTRUCTION	SENSOR TYPE(S)	ALARM POINT(S)	CONFIGURATION	OUTPUTS	(VOLT / PHASE)	MANUFACTURER	MODEL
GM-1	EXPLOSION PROOF CL 1, DIV 1	COMBUSTIBLE GAS - SOLVENTS	25% LEL	3.5" LCD GREEN LED RED LED	4-20 mA 1 RELAY	115 / 1	MSA	ULTIMA XE
014.0	EXPLOSION	COMBUSTIBLE GAS - SOLVENTS	25% LEL	3.5" LCD	4-20 mA	445.14		
GM-2	PROOF CL 1, DIV 2	COMBUSTIBLE GAS - PETRO VAPORS	25% LFL	GREEN LED RED LED	1 RELAY	115 / 1	MSA	ULTIMA X
214.2	EXPLOSION	COMBUSTIBLE GAS - SOLVENTS	25% LEL	3.5" LCD	4-20 mA	445.14		
GM-3	PROOF CL 1, DIV 2	COMBUSTIBLE GAS - PETRO VAPORS	25% LFL	GREEN LED RED LED	1 RELAY	115 / 1	MSA	ULTIMA X
	EXPLOSION	CARBON MONOXIDE (CO)	35 PPM	3,5" LCD	4.00			
GM-4	PROOF	METHANE (CH4)	25% LEL	GREEN LED	4-20 mA 1 RELAY	115 / 1	MSA	ULTIMA X
	CL 1, DIV 2	NITROGEN DIOXIDE (NO2)	1 PPM	RED LED	INCLAI			
	EXPLOSION	CARBON MONOXIDE (CO)	35 PPM	3.5" LCD	4 00 4			
GM-5	PROOF	METHANE (CH4)	25% LEL	GREEN LED	4-20 mA 1 RELAY	115 / 1	MSA	ULTIMA X
	CL 1, DIV 2	NITROGEN DIOXIDE (NO2)	1 PPM	RED LED	TINELAT			
	EXPLOSION	CARBON MONOXIDE (CO)	35 PPM	3.5" LCD	4 00 4			
GM-6	PROOF	METHANE (CH4)	25% LEL	GREEN LED	4-20 mA 1 RELAY	115 / 1	MSA	ULTIMA X
	CL 1, DIV 2	NITROGEN DIOXIDE (NO2)	1 PPM	RED LED	TILLIT			
	EXPLOSION	CARBON MONOXIDE (CO)	35 PPM	3.5" LCD	4 20 m 4			
GM-7	PROOF	METHANE (CH4)	25% LEL	GREEN LED	4-20 mA 1 RELAY	115 / 1	MSA	ULTIMA X
	CL 1, DIV 2	NITROGEN DIOXIDE (NO2)	1 PPM	RED LED				1

INTERLOCK GAS MONITORS WITH WITH ANNUCIATOR PANEL, CONTROL PANEL, AND BUILDING AUTOMATION SYSTEM TO INDEX

- ASSOCIATED VENTILATION SYSTEM TO HIGHEST VENTILATION MODE UPON SENSING AN ALARM CONDITION. PROVIDE DISPLAY PANEL INDICATION OF ALARM CONDITION AS WELL AS ALARM SIGNAL IN BAS.
- PROVIDE PUSH BUTTON FOR EACH MONITOR TO ALLOW ALARM ACKNOWLEDGEMENT AND MENU ACCESS.
- POWER SUPPLY WIRING SHALL BE THE RESPONSIBILITY OF THE TEMPERATURE CONTROLS CONTRACTOR. 5. MOUNTING HEIGHTS OF SENSORS SHALL BE AS DICTATED BY AHJ AND ACCEPTABLE PRACTICE FOR GAS BEING DETECTED.

					HE	AT E	(CHAI	NGER	WATE	ER TO	CAW C	ΓER (HX)			
Ī.,				ENGI	NE JAC	KET WA	TER	PI	ROCESS	WATE	7		OONITROI		
	NIT IO.	SERVICE	LOCATION	GPM	EWT (°F)	LWT (°F)	WPD (PSI)	GPM	EWT (°F)	LWT (°F)	WPD (PSI)	MBH	CONTROL VALVE	MANUFACTURER	MODEL
Н	X-1	ENGINE 1	COGEN BUILDING	370	230	213	4.76	310	160	180	3.12	2,952	ELECTRONIC PID	SONDEX	S22-IG10-45-TK-LIQUID
Н	X-2	ENGINE 2	COGEN BUILDING	370	230	213	4.76	310	160	180	3.12	2,952	ELECTRONIC PID	SONDEX	S22-IG10-45-TK-LIQUID
Н	X-3	ENGINE 3	COGEN BUILDING	370	230	213	4.76	310	160	180	3.12	2,952	ELECTRONIC PID	SONDEX	S22-IG10-45-TK-LIQUID

CONTACT MIKE KIME AT E.D.NEWELL CO. 1-262-857-6871.

2. CONTRACTOR SHALL RE-BALANCE ENGINE JACKET WATER CIRCUIT TO PROVIDE PROPER WATER FLUID FLOW THROUGH ENGINE.

							WEATI	HERPR(OOF LO	UVERS	(WPL)					
UNIT			DESIGN	0)	SIZE (IN)		MAX.	MAX.	FREE	BLADE						
NO.	LOCATION	SERVES	(CFM)	L	Н	D	APD (IN. WC)	VEL. (FPM)	AREA (SQ. FT.)	ANGLE	BLADE TYPE	CONSTRUCTION	FINISH	SCREEN	MANUFACTURER	MODEL
WPL-1-4	TIPPING FLOOR	EF-1, -2, -3, -4	3,250	36	36	6	0.08	690	4.71	37.5	DRAINABLE	ALUMINUM	ANODIZED	BIRD	RUSKIN	ELF6375DX
WPL-5-8	SOLVENT BULKING	EXP. CNTL.	400	24	48	6	0.05	100	4.0	37.5	DRAINABLE	ALUMINUM	ANODIZED	BIRD	RUSKIN	ELF6375DX
WPL-9	MEZZANINE	MAU-1	7,500	48	54	6	0.10	745	10.06	37.5	DRAINABLE	ALUMINUM	ANODIZED	BIRD	RUSKIN	ELF6375DX
WPL-10-11	COMPACTOR	EF-6, -7	10,125	42	42	6	0.25	1510	6.74	37.5	DRAINABLE	ALUMINUM	ANODIZED	BIRD	RUSKIN	ELF6375DX

WPL-5-8 SHALL BE PROVIDED WITH THERMALLY BROKEN. INSULATED BLADE DAMPER SIMILAR TO TAMCO 9000 SERIES.

DAMPER SHALL BE WIRED SO THAT IN THE EVENT OF LOSS OF POWER, DAMPER SHALL SPRING RETURN OPEN. 2. WPL-5-8 ACTUATOR TO BE MOUNTED IN EXPLOSION PROOF ENCLOSURE. USE LOW VOLTAGE ACTUATOR, MOUNT ACTUATOR ON WALL SYSTEM AND USE JACK SHAFT TO LOUVER IN EXPLOSION RELIEF PANEL.

						PUM	PS AND	CIRC	ULATORS	(P)					
UNIT					HEAD	OPER.			MOTOR			MIN.			GLYCOL
NO.	SERVICE	SIZE	LOCATION	GPM	(FT. HD)	TEMP. (°F)	RPM	HP	VOLTS	PH	TYPE	EFF. %	MANUFACTURER	MODEL	(%)
PP-1	PROCESS LOOP	3	MEZZANINE	300	45	180	1,750	7.5	460	3	BASE MOUNT	70	TACO	3007	30 PG
PP-2	PROCESS LOOP	3	MEZZANINE	300	45	180	1,750	7.5	460	3	BASE MOUNT	70	TACO	3007	30 PG
CP-1	MAU COIL	2	MAU-1	75	15	180	1,750	3/4	460	3	INLINE	60	TACO	1935	30 PG
CP-2	HEAT RECOVERY	1-1/4	MAU-1	36	15	25	1,750	1/2	120	1	INLINE	55	TACO	1911	40 PG
CP-3	BOILER	2	B-1	102	15	180	1,750	3/4	460	3	INLINE	55	TACO	1935	30 PG
IFP-1	MANIFOLD 1	1-1/2	IF-1	45	25	140	1,750	3/4	460	3	INLINE	55	TACO	1915	30 PG
IFP-2	MANIFOLD 2	1-1/2	IF-2	45	25	140	1,750	3/4	460	3	INLINE	55	TACO	1915	30 PG

							BOILERS (B)		
UNIT	7.495	1011	OUTPUT			E	ELECTRICAL			MODE
NO.	TYPE	KW	MBH	AMPS VOLTS PH ELEMENTS STEP				STEPS	MANUFACTURER	MODEL
B-1	ELECTRIC RESISTANCE	300	1,024	361	460	3	30	8	HYDRO STEAM INDUSTRIES	HWR2438

PROVIDE LOAD LIMITOR DEVICE TO CONTROL DEMAND RESPONSE. PROVIDE DOOR INTERLOCK TO DISABLE OPERATION.

PROVIDE PROPORTIONAL STEP CONTROLLER WITH PROGRESSIVE SEQUENCE.

						SI	DEWA	ALL EXH	AUSTI	ER (SE)				
UNIT	SERVICE	CFM	TOTAL S.P.	FAN SPEED	OPERATING POWER	DRIVE		МОТ	O R		MOTOR	WALL OPENING	MANUFACTURER	MODEL
NO.	SERVICE	CFINI	(IN. WC)	(RPM)	(BHP)	DRIVE	HP	VOLTS	PH	SPEED CONTROL	TYPE	(IN. x IN.)	WANUFACTURER	WODEL
EF-6	COMPACTOR	10,125	0.25	1,160	1.3	DIRECT	1-1/2	460	3	N/A	TEFC	39-3/4 x 39-3/4	GREENHECK	SCE3-30-420
EF-7	COMPACTOR	10,125	0.25	1,160	1.3	DIRECT	1-1/2	460	3	N/A	TEFC	39-3/4 x 39-3/4	GREENHECK	SCE3-30-420
EF-8	ELECTRICAL	2,476	0.25	1,160	0.27	DIRECT	1/4	120	1	N/A	TEFC	27-1/4 x 27-1/4	GREENHECK	SCE3-20-617

PROVIDE WITH WALL HOUSING, MOTOR OPERATED DAMPER AND FAN GUARDS.

						R00	F EXH	AUSTERS	(RE)						
UNIT	SERVICE	CFM	TOTAL S.P.	HIGH SPEED	OPERATING POWER	DRIVE		МОТО) R		MOTOR	PRE-FA	AB CURB	MANUFACTURER	MODEL
NO.	SERVICE	CFIVI	(IN. WC)	(RPM)	(BHP)	DRIVE	HP	VOLTS	PHASE	SPEED CONTROL	TYPE	STD.	ATTEN.	WANDFACTURER	WODEL
EF-1	TIPPING FLOOR	3,250	0.60	833	0.65	BELT	3/4	460	3	N/A	EXP	12"	N/A	GREENHECK	GB-200
EF-2	TIPPING FLOOR	3,250	0.60	833	0.65	BELT	3/4	460	3	N/A	EXP	12"	N/A	GREENHECK	GB-200
EF-3	TIPPING FLOOR	3,250	0.60	833	0.65	BELT	3/4	460	3	N/A	EXP	12"	N/A	GREENHECK	GB-200
EF-4	TIPPING FLOOR	3,250	0.60	833	0.65	BELT	3/4	460	3	N/A	EXP	12"	N/A	GREENHECK	GB-200
EF-5	TIPPING FLOOR	1,300	0.60	1,210	0.15	BELT	1/4	120	1	N/A	EXP	12"	N/A	GREENHECK	GB-121

1. SS - SOLID STATE SPEED CONTROL DEVICE.

2. EXP - EXPLOSION PROOF MOTOR. 3. ALUMINUM HOUSING, WHEEL AND RUB RING.

						ŀ	AW TOI	TER HE	ATING	COIL (HC)						
UNIT NO.	SERVES	CFM	MBH	S I Z (IN L		FACE AREA (SQ. FT.)	VELOCITY		MAX. APD (IN. WC)	EAT (°F)	LAT (°F)	GPM	EWT (°F)	LWT (°F)	MAX. WPD (FT. HD)	MANUFACTURER	MODEL
HC-1	FC-1	1,000	70	18.5	22	2.75	365	2	0.09	35	95	7	180	160	6.2	CARRIER	HC2XX021020

CASED, HORIZONTAL COIL SHALL BE MATCHED WITH FAN COIL (FC-1). 2. UNIT CONFIGURATION IS DOWN FLOW WITH COIL ON DISCHARGE OF FAN COIL.

							FAN C	OIL (JNIT	(FC)						
UNIT NO.	SERVICE	UNIT ARRANGEMENT	TOTAL CFM	O.A. CFM	EXT. SP. "WC	FILTER	VOLTS/ PH		F)	(°	AT F)	TOTAL MBH	SENS. MBH	REFRIGERANT	MANUFACTURER	MODEL
FC 4	OFFICE (PREM)	VERTICAL	4.000	000			000.14	DB	WB	DB	WB	04.4	47.0	440. A	OARDIED.	EV/4ANE000
FC-1	OFFICE / BREAK	DOWNFLOW	1,000	200	0.50	2" PLEAT	208 / 1	81.1	70.2	55.3	53.7	34.4	17.9	410-A	CARRIER	FY4ANF036

					A	IR COOLED	COMPRE	ESSOF	R-CONDENSE	R UN	IT (ACC	CU)					
					COMPRESSOR	₹			OUTSIDE	CON	DENSING F	ANS		ELECTRI	CAL		
UNIT NO.	SERVICE	МВН	TONS	REFRIGERANT TYPE	SUCTION TEMPERATURE (°F)	UNLOADING	H.G. BYPASS	SEER	AIR TEMPERATURE (°F)	TOTAL CFM	NO.	HP EACH	MOCP	MCA	VOLTS / PHASE	MANUFACTURER	MODEL
ACCU-1	FC-1	36	3	410-A	109	1 STAGE	NO	14	95	3800	1	1/5	35	22	208 / 1	CARRIER	24ACA436

					ELE	CTRI	C WALL HEATER (EW	H)			
UNIT NO.	SERVICE	WATTS	BTU/HR.	RECE	SS DIMEN (IN)	SION	MOUNTING ABOVE FLOOR	VOLTS	PHASE	MANUFACTURER	MODEL
				W	Н	D	(IN)	, 5 2 1 5			
EWH-1	TOILET	3,000	10,245	15.75	19.25	2	18	208	1	QMARK	CWH3404

. PROVIDE INTEGRAL THERMOSTAT. PROVIDE WHITE FINISH.

				DIFF	USER, RE	EGISTER, & GR	ILLE SCHEDUL	.E			
UNIT NO.	SERVICE	MAXIMUM APD (IN WC)	MAXIMUM NC	PATTERN	SIZE (IN)	FINISH	MATERIAL	MOUNTING	ACCESSORIES	MANUFACTURER	MODEL NO.
SD-1	OFFICE	0.03	12	4-WAY	24	WHITE	ALUMINUM	SURFACE	N/A	TITUS	TMSA-AA
SG-1	PRODUCT AREAS	0.02	25	DOUBLE DEFLECTION	36x12	WHITE	ALUMINUM	SURFACE	N/A	TITUS	300FL
SG-2	PRODUCT EXCHANGE	0.07	15	DOUBLE DEFLECTION	10x10	WHITE	ALUMINUM	SURFACE	N/A	TITUS	300FL
RD-1	OFFICE	0.01	-	EGG CRATE	10x10	WHITE	ALUMINUM	SURFACE	N/A	TITUS	50F
EG-1	PRODUCT AREAS	0.01	-	EGG CRATE	24x24	WHITE	ALUMINUM	SURFACE	N/A	TITUS	50F
DG-1	MEZZANINE DOOR	0.04	26	LINEAR GRILLE	12x12	ALUMINUM	ALUMINUM	SURFACE	N/A	TITUS	CT-700

											ENE	RGY R	ECOVE	RY VE	NTILAT	OR (ER'	V)						
UNIT NO.	SERVICE	LOCATION			HAUST A		APD			JPPLY A		APD	SUPP	FILT LY AIR	TERS EXHAL	IST AIR		AN SEC	CTION VOLTS/	MBH	EFF.	MANUFACTURER	MODEL
110.			CFM	°F	°F	°F	"WC	CFM	°F	°F	°F	"WC	EFF	SIZE	EFF	SIZE	FLA	HP	PH		70		
ERV-	OUTDOOR AIR	MEZZANINE	200	70	54.5	45	0.5	200	-15	-1	54.7	0.5	MERV 8	14x20	MERV 8	14x20	7	0.6	120 / 1	18.1	77	RENEW-AIRE	EV450IN

1. PROVIDE A 6" ALUMINUM SIDEWALL VENT CAP FOR EXHAUST AIR PENETRATION, BROAN MODEL 641 OR SIMILAR.

2. PROVIDE A 6" ALUMINUM SIDEWALL FRESH AIR CAP FOR OUTDOOR AIR PENETRATION, BROAN MODEL 641FA OR SIMILAR.

							НО	T WATER	R UNIT HE	ATER (U	H)						
UNIT NO.	SERVICE	TYPE			FAN					COIL			SUPPLY PIPE CONN.	RETURN PIPE CONN.	DIFFUSER TYPE	MANUFACTURER	MODEL NO.
NO.			CFM	RPM	HP	VOLTS	PHASE	MBH	EAT (°F)	GPM	EWT	LWT	(IN.)	(IN.)	TIFE		
UH-1	HHW	PROPELLER	1,250	1,600	0.15	180	1	85	50	8.5	180	160	1-1/4	1-1/4	LOUVERED	REZNOR	WS 60/85
UH-2	HHW	PROPELLER	1,250	1,600	0.15	180	1	85	50	8.5	180	160	1-1/4	1-1/4	LOUVERED	REZNOR	WS 60/85
UH-3	HHW	PROPELLER	1,250	1,600	0.15	180	1	85	50	8.5	180	160	1-1/4	1-1/4	LOUVERED	REZNOR	WS 60/85
UH-4	HHW	PROPELLER	1,250	1,600	0.15	180	1	85	50	8.5	180	160	1-1/4	1-1/4	LOUVERED	REZNOR	WS 60/85

				MOT	OR CONTROL	SCHEDULE						
UNIT	ELECTRICAL	VOLTS/ DU		МОТО	R STARTER			CONTROL		С	ISCONNECT B	Υ
UNIT	LOAD	VOLTS/ PH	TYPE	FURN BY	LOCATION	ACCESSORIES	TYPE	FURN BY	LOCATION	TYPE	FURN BY	LOCATION
MAU-1 SUPPLY FAN	10 HP	480 / 3	VFD	M.C.	NEAR	HOA, DC	BAS	T.C.	INTEGRAL	NFDS	E.C.	NFDS
MAU-1 EXHAUST FAN	10 HP	480 / 3	VFD	M.C.	NEAR	HOA, DC	BAS	T.C.	INTEGRAL	NFDS	E.C.	NFDS
FC-1	1/3 HP	208 / 1	FVNR	MANF	INTEGRAL	N/A	AUTOMATIC	T.C.	REMOTE	NFDS	E.C.	ON
ACCU-1	1/3 HP	208 / 1	FVNR	MANF	INTEGRAL	N/A	AUTOMATIC	T.C.	REMOTE	NFDS	E.C.	ON
PP-1	7.5 HP	460 / 3	VFD	M.C.	NEAR	HOA, DC	BAS	T.C.	REMOTE	NFDS	E.C.	NFDS
PP-2	7.5 HP	460 / 3	VFD	M.C.	NEAR	HOA, DC	BAS	T.C.	REMOTE	NFDS	E.C.	NFDS
CP-1	3/4 HP	460 / 3	FVNR	MANF	INTEGRAL	N/A	BAS	T.C.	REMOTE	NFDS	E.C.	NFDS
CP-2	1/2 HP	120 / 1	FVNR	MANF	INTEGRAL	N/A	AUTOMATIC	T.C.	REMOTE	NFDS	E.C.	NFDS
CP-3	3/4 HP	460 / 3	FVNR	MANF	INTEGRAL	N/A	AUTOMATIC	T.C.	REMOTE	NFDS	E.C.	NFDS
IFP-1	3/4 HP	460 / 3	FVNR	MANF	INTEGRAL	N/A	BAS	T.C.	REMOTE	NFDS	E.C.	NFDS
IFP-2	3/4 HP	460 / 3	FVNR	MANF	INTEGRAL	N/A	BAS	T.C.	REMOTE	NFDS	E.C.	NFDS
UH-1	1/8 HP	120 / 1	MANUAL	MANF	INTEGRAL	N/A	AUTOMATIC	T.C.	REMOTE	NFDS	E.C.	NFDS
UH-2	1/8 HP	120 / 1	MANUAL	MANF	INTEGRAL	N/A	AUTOMATIC	T.C.	REMOTE	NFDS	E.C.	NFDS
UH-3	1/8 HP	120 / 1	MANUAL	MANF	INTEGRAL	N/A	AUTOMATIC	T.C.	REMOTE	NFDS	E.C.	NFDS
UH-4	1/8 HP	120 / 1	MANUAL	MANF	INTEGRAL	N/A	AUTOMATIC	T.C.	REMOTE	NFDS	E.C.	NFDS
ERV-1	2/3 HP	120 / 1	FVNR	MANF	INTEGRAL	N/A	AUTOMATIC	T.C.	REMOTE	NFDS	MANF.	ON
EWH-1	3 KW	208 / 1	MANUAL	MANF	INTEGRAL	N/A	AUTOMATIC	T.C.	REMOTE	NFDS	E.C.	REMOTE
EF-1 THROUGH EF-4	3/4 HP	480 / 3	FVNR	MANF	INTEGRAL	N/A	BAS	T.C.	REMOTE	NFDS	MANF.	ON
EF-5	1/4 HP	480 / 3	FVNR	MANF	INTEGRAL	N/A	BAS	T.C.	REMOTE	NFDS	E.C.	ON
EF-6 AND EF-7	1-1/2 HP	480 / 3	FVNR	MANF	INTEGRAL	N/A	AUTOMATIC	T.C.	REMOTE	NFDS	E.C.	ON
EF-8	1/4 HP	480 / 3	FVNR	MANF	INTEGRAL	N/A	AUTOMATIC	T.C.	REMOTE	NFDS	E.C.	ON

1. ALL STARTERS TO BE FURNISHED BY ABB, SQUARE D, OR APPROVED EQUIVALENT.

MOTOR STARTER TYPES

1. MAN. - MANUAL COMBINATION MOTOR STARTER CIRCUIT BREAKER

2. FVNR - FULL VOLTAGE, NON-REVERSING, MAGNETIC, COMBINATION MOTOR STARTER CIRCUIT BREAKER 3. FVR - FULL VOLTAGE, REVERSING, MAGNETIC, COMBINATION MOTOR STARTER CIRCUIT BREAKER 4. SSRV - SOLID STATE, REDUCED VOLTAGE, COMBINATION MOTOR STARTER CIRCUIT BREAKER

300 KW 480 / 3 MANUAL

MANF

INTEGRAL

5. 2S1W - TWO SPEED, SINGLE WINDING, COMBINATION MOTOR STARTER CIRCUIT BREAKER 6. 2S2W - TWO SPEED, DUAL WINDING, COMBINATION MOTOR STARTER CIRCUIT BREAKER 7. VFD - VARIABLE FREQUENCY DRIVE WITH INTEGRAL CIRCUIT BREAKER AND PILOT LIGHT INDICATORS

MOTOR STARTER MOUNTING LOCATIONS

1. NEAR - MOUNT MOTOR STARTER WITHIN SIGHT OF EQUIPMENT, PREFERABLY WITHIN THE SAME ROOM 2. ON - MOUNT MOTOR STARTER ON UNIT IN LOCATION APPROVED BY EQUIPMENT MANUFACTURER AND ENGINEER 3. INT. - MOTOR STARTER SHALL BE INTEGRAL TO THE UNIT, PROVIDE FACTORY MOUNTED WHEN POSSIBLE 4. REMOTE - MOTOR STARTER SHALL BE MOUNTED REMOTE TO UNIT LOCATION, SEE PLANS FOR DETAILS

MOTOR STARTER RESPONSIBILITY

1. M.C. - MECHANICAL CONTRACTOR 2. E.C. - ELECTRICAL CONTRACTOR

3. T.C. - TEMPERATURE CONTROLS CONTRACTOR 4. G.C. - GENERAL CONTRACTOR

5. MANF. - EQUIPMENT MANUFACTURER

MOTOR STARTER ACCESSORIES 1. DS - INTEGRAL DISCONNECT SWITCH

2. HOA - INTEGRAL HAND-OFF-AUTO SELECTOR SWITCH 3. TS - FACE MOUNTED ON-OFF TOGGLE SWITCH

4. PB - FACE MOUNTED ON-OFF PUSH BUTTON SWITCH 5. PL(G) - FACE MOUNTED PILOT LIGHT INDICATING STATUS (COLOR OF LIGHT, G=GREEN, Y=YELLOW, R=RED, W=WHITE) 6. DC - PROVIDE WITH SPARE SETS OF DRY CONTACTS, 2 SETS NORMALLY OPEN & 1 SET NORMALLY CLOSED

DISCONNECT TYPES

MANUAL

1. NFDS. - NON-FUSED DISCONNECT SWITCH, MOUNTED NEAR MOTOR 2. FDS - FUSED DISCONNECT SWITCH, MOUNTED NEAR MOTOR

REMOTE

1. NEAR - MOTOR STARTER IS IN SIGHT OF EQUIPMENT, PREFERABLY WITHIN THE SAME ROOM

2. ON - MOTOR STARTER ON UNIT IN LOCATION APPROVED BY EQUIPMENT MANF. & ENGINEER

3. INT. - MOTOR STARTER SHALL BE INTEGRAL TO UNIT, PROVIDE FACTORY MOUNTED 4. REMOTE - MOUNT MOTOR STARTER REMOTE FROM UNIT LOCATION, SEE PLANS FOR DETAILS

DISCONNECT MOUNTING LOCATIONS

DISCONNECT RESPONSIBILITY 1. M.C. - MECHANICAL CONTRACTOR 2. E.C. - ELECTRICAL CONTRACTOR 3. T.C. - TEMPERATURE CONTROLS CONTRACTOR

5. MANF. - EQUIPMENT MANUFACTURER CONTROL TYPES

4. G.C. - GENERAL CONTRACTOR

1. MAN. - MANUAL CONTROL 2. AUTO - AUTOMATIC CONTROL, LOCAL TO UNIT

3. BAS - BUILDING AUTOMATION SYSTEM BASED CONTROL

					INTAK	E RELIEF OR E	XHAUST H	100D				
UNIT	LOCATION	SERVICE	CFM	APD		DIMENSIONA	L DATA		DAMPER	ROOF CURB	MANUFACTURER	MODEL
NO.	200/11/011	02.11102	01111	(IN. WC)	THROAT (IN)	CURB CAP (IN)	HOOD (IN)	HEIGHT (IN)	TYPE	HEIGHT (IN)	IIII III III III III III III III III I	0522
EH-1	ROOF	MAU-1	7,500	0.009	90x46	96x52	120x69	26.75	MOD	12	GREENHECK	FGR

ALUMINUM BIRDSCREEN. ALUMINUM BLADE MOTORIZED DAMPER IN CRUB TRAY.

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CONSULTANTS:

PROJECT TITLE:

DANE COUNTY WASTE TRANSFER STATION AND HOUSEHOLD HAZARDOUS WASTE FACILITY RODEFELD LANDFILL

ISSUE:

PROJECT INFORMATION:

PROJECT NUMBER: 2009-0328.00

CHECKED BY:

APPROVED BY: PDZ SCALE: AS NOTED

SHEET TITLE: MECHANICAL SCHEDULES





PLUMBING SYMBOLS, ABBREVIATIONS & SCHEDULES

NOTE: NOT ALL SYMBOLS AND ABBREVIATIONS INDICATED HERE ARE USED IN THE DRAWINGS AND MAY NOT APPLY TO THIS PROJECT. ADDITIONAL SYMBOLS MAY BE INDICATED IN THE DRAWINGS.

PLUMBING ABBREVIATIONS

A	-	AIR	L		LAVATORY
AFF	-	ABOVE FINISHED FLOOR	LBS.	-	POUNDS
AFG ALT	-	ABOVE FINISHED GRADE ALTERNATE	LB/HR	-	POUNDS PER HOUR
AP	-	ACCESS PANEL	MAX	-	MAXIMUM
APPROX. ARCH	-	APPROXIMATELY ARCHITECTURAL	MB MBH	- -	MOP BASIN THOUSANDS OF BTU PER HOUR
AV	-	ACID VENT	MC	-	MECHANICAL CONTRACTOR
AVG AW	-	AVERAGE ACID WASTE	MEP MER	-	MECHANICAL, ELECTRICAL AND PIPING MECHANICAL EQUIPMENT ROOM
	-		MEZZ	-	MEZZANINE
BFF	-	BELOW FINISHED FLOOR	MFR	-	MANUFACTURER
BLDG BOT	-	BUILDING BOTTOM	MH MIN.	-	MANHOLE MINIMUM
ВОР	-	BOTTOM OF PIPE	MISC	-	MISCELLANEOUS
BT BTU	-	BATHTUB	MTD MTG	-	MOUNTED MOUNTING
BTU BTUH	-	BRITISH THERMAL UNITS BRITISH THERMAL UNITS PER HOUR	MTG	-	MOUNTING
3V	-	BALANCING VALVE	NA	-	NOT APPLICABLE
CAP	_	CEILING ACCESS PANEL	NIC NO	-	NOT IN CONTRACT NUMBER
CC	-	CAPPED CONNECTION	NPS	-	NOMINAL PIPE SIZE
CFH	-	CUBIC FEET PER MINUTE	NTS	-	NOT TO SCALE
CFM CL	-	CUBIC FEET PER HOUR CENTERLINE	ОС	-	ON CENTER
CLG	-	CEILING	OD	-	OUTSIDE DIAMETER
CLV CLW	-	CLEAR WATER VENT CLEAR WATER WASTE	OFCI OFOI	<u>-</u>	OWNER FURNISHED, CONTRACTOR INSTALLED OWNER FURNISHED, OWNER INSTALLED
CO	-	CLEANOUT		-	
COND	-	CONDUCTOR	P BC	-	PUMP
CONT	-	CONTRACTOR CENTER	PC PCF	- -	PLUMBING CONTRACTOR POUNDS PER CUBIC FOOT
CU	-	COPPER	PD	-	PRESSURE DROP
CV CW/	-	CHECK VALVE	PH PLRG	-	PHASE PLUMBING
CW CWFU	-	COLD WATER COLD WATER FIXTURE UNITS	PLBG POC	-	PLUMBING POINT OF CONNECTION
CWS	-	COLD WATER SOFT	PP	-	POLYPROPYLENE
OD		DRAIN DECK	PPH PRV	-	POUNDS PER HOUR PRESSURE RELIEF VALVE
טכ DET	-	DETAIL	PRV PSF	-	POUNDS PER SQUARE FOOT
DFU	-	DRAINAGE FIXTURE UNITS	PSI	-	POUNDS PER SQUARE INCH
DIA DIM	-	DIAMETER DIMENSION	PSIA PSIG	-	POUNDS PER SQUARE INCH ABSOLUTE POUNDS PER SQUARE INCH GAUGE
NC	-	DOWN	PVC	-	POLYVINYL CHLORIDE
OS OT	-	DOWNSPOUT	חם		POOE DRAIN
OT OTR	-	DRAIN TILE DRAIN TILE RECEIVER	RD REC	-	ROOF DRAIN RECESSED
DWG.	-	DRAWING	RF	-	ROOF
OW	-	DISH WASHER	RI RPZ	-	ROUGH-IN REDUCED PRESSURE ZONE VALVE
=	-	EXISTING	RPZ RV	-	REDUCED PRESSURE ZONE VALVE RELIEF VALVE
EEW	-	EMERGENCY EYEWASH			
ELEV EM	-	ELEVATION EMERGENCY	S SCH	-	SLOPE SCHEDULE
EQUIP	-	EQUIPMENT	SH	-	SHOWER
ES =T	-	EMERGENCY SHOWER	SHT SOG	-	SHEET SLAR ON GRADE
ET ETR	-	EXPANSION TANK EXISTING TO REMAIN	SOG SPEC	-	SLAB ON GRADE SPECIFICATION
EWC	-	ELECTRIC WATER COOLER	SQ	-	SQUARE
EWH EXST	-	ELECTRIC WATER HEATER EXISTING	SS S/S	-	SERVICE SINK STAINLESS STEEL
	-	LAIGHHO	S/S STD	-	STANDARD
=	-	FUTURE			
-CO -D	-	FLOOR CLEANOUT FLOOR DRAIN	T&P TBR	-	TEMPERATURE AND PRESSURE TO BE REMOVED
FE	-	FINISHED FLOOR ELEVATION	TD	-	TRENCH DRAIN
FLR FD	-	FLOOR	TDFU	-	TOTAL DRAIN FIXTURE UNITS
FP FPM	-	FIREPROOF FEET PER MINUTE	TEMP TOP	-	TEMPERATURE TOP OF PIPE
FPS	-	FEET PER SECOND	TOS	-	TOP OF SLAB
FS F&T	-	FLOOR SINK FLOAT AND THERMOSTATIC	T STAT TWFU	<u>-</u>	THERMOSTAT TOTAL WATER FIXTURE UNITS
-& I =T	-	FEET	TYP	-	TYPICAL
-TG	-	FOOTING			
=U	-	FIXTURE UNITS	UNO	-	UNLESS OTHERWISE NOTED
3	-	GAS	V	-	VENT
GAL	-	GALLON CENERAL CONTRACTOR	VB	-	VACCUM BREAKER
GC GPM	-	GENERAL CONTRACTOR GALLONS PER MINUTE	VB VTR	-	VALVE IN BOX VENT THRU ROOF
GPH	-	GALLONS PER HOUR			
ar ar		HOSE DIDD	W	-	WASTE
HB HD	-	HOSE BIBB HUB DRAIN	W/ W/O	-	WITH WITHOUT
HP	-	HORSE POWER	WHA	-	WATER HAMMER ARRESTOR
⊣VAC ⊣W	-	HEATING, VENTILATING & AIR CONDITIONING HOT WATER	WCO WC	<u>-</u>	WALL CLEANOUT WATER CLOSET
⊣w ⊣WFU	-	HOT WATER FIXTURE UNITS	WF	- -	WASH FOUNTAIN
HWR	-	HOT WATER RETURN	WH	-	WATER HEATER
D	-	INSIDE DIAMETER	WM WSFU	-	WASHING MACHINE WATER SUPPLY FIXTURE UNITS
E	-	INVERT ELEVATION	WG	-	WATER GAUGE
N	-	INCHES			
(0	-	KNOCK-OUT	YCO	-	YARD CLEAN OUT
			TTIN : 0 0		
		PIPE FI	IIINGS	5	
		— FLANGE			———— BLBOW DOWN
		— UNION			—————O ELBOW UP
					-C ELDOVY UP
	\times	— ANCHOR			───── TEE DOWN
		— PIPE GUIDE			———— TEE UP
_	<u>-</u>				_
		TEE BRANCH			PIPE CAP
		LINE CONTINUATION BREAK			———⊃≯ VALVE IN VERTICAL
	`	DI HIMDINO EIVTUDE STORS			-
	\longrightarrow	PLUMBING FIXTURE STOPS			I
	 	— PIPELINE STRAINER			├── │ <u>│</u> WYE
	7				\\ \\ \\ \\ \\ \\ \\ \\ \\ \\ \\ \\ \
					WYE WITH VENT UP
		-	-		
		DRAINS AND	CLEAN	IOUT	S
	Ø	FLOOR DRAIN			O── FIXTURE WASTE TRAP
	_				-
		FLOOR SINK			CO CLEANOUT

○— FCO FLOOR CLEANOUT

HUB DRAIN

PIPING SYSTEM LABELS

NATER PIP	ING SYSTEMS:	SITE PIPING SYSTEMS:	TAG	MANUFACT
	· COLD WATER	—— SAN —— SANITARY SEWER	WH-1	A.O. SM
	HOT WATER	ST STORM SEWER		
	HOT WATER RETURN	—— W —— WATER LINE	EXP-1	AMTRO
— F —	FIRE PROTECTION			7
<u> — т —</u>	TEMPERED WATER		CP-1	BELL &
NASTE ANI	O VENT SYSTEMS:		01-1	GOSSE
			TMV-1	LAWLE
—— CWV ——	CLEARWATER VENT			2, 444
——CWW——	CLEARWATER WASTE			
— OD —	OVERFLOW DRAIN LINE			
—— ST ——	STORM		RPBP-1	WATT
— SSD —	SUBSOIL DRAIN LINE	NOTE: (E) PRIOR TO SYSTEM TYPE DENOTES EXISTING PIPING		
	UNDERFLOOR FOR WASTE OR SOIL, SUBSOIL, STORM & FORCE MAIN	(F) PRIOR TO SYSTEM TYPE DENOTES FUTURE PIPING	HB-1	WOODFO
	SANITARY VENT			
—— SAN ——	WASTE OR SOIL LINE			

PIPE VALVES AND SPECIALTIES

<u> </u>	ANGLE VALVE	- >	BACKFLOW PREVENTER
	BALANCING VALVE	<u> </u>	PRESSURE GAUGE
	BALL VALVE		
 ф	BUTTERFLY VALVE	<u> </u>	THERMOMETER
	CHECK VALVE	— НВ	HOSE BIBB AND WALL HYDRANT
<u>_</u>	DRAIN VALVE	<u> </u>	WATER HAMMER ARRESTOR
 _	GAS SHUTOFF VALVE	── \ ★	PRESSURE RELIEF VALVE
	GATE VALVE		

REFERENCE SYMBOLS

1 P200	DETAIL REFERENCE TOP DESIGNATES DETAIL NUMBER BOTTOM DESIGNATES SHEET NUMBER	VP 1	EQUIPMENT NAME AND NUMBER
•		1	PLAN NOTE NUMBER
1 P200	SECTION REFERENCE TOP DESIGNATES SECTION NUMBER BOTTOM DESIGNATES SHEET NUMBER	1	REVISION NUMBER
	DEGIGINATES GITEET NOMBER		POINT OF CONNECTION
	ELEVATION SYMBOL	Ħ	POINT OF DISCONNECTION

WATER SUPPLY CALCULATION

USING THE FORMULA, FIND THE PRESSURE AVAILABLE FOR UNIFORM LOSS (PSI/100' OF PIPE) $A = \frac{B - (C + D + E)X100}{F}$

A. 10.4 PRESSURE AVAILABLE FOR UNIFORM LOSS (PSI/100' OF PIPE)

B. <u>50.0</u> AVAILABLE PRESSURE AT THE CONTROL VALVE. C. <u>25.0</u> PRESSURE NEEDED AT CONTROLLING FIXTURE.

D. <u>5.2</u> DIFFERENCE IN ELEVATION BETWEEN WATER METER AND CONTROLLING FIXTURE IN FEET 12 X .434 PSI/FT

E. 12.0 PRESSURE LOSS DUE TO WATER SOFTENERS, WATER TREATMENT DEVICES, INSTANTANEOUS WATER HEATERS, AND BACKFLOW PREVENTORS. CONVENTIONAL WATER HEATERS USUALLY DO NOT HAVE A PRESSURE LOSS. (EXISTING POOL FILL EQUIPM.)

F. <u>75</u> DEVELOPED LENGTH FROM WATER METER TO CONTROLLING FIXTURE

WITH PRESSURE AVAILABLE FOR UNIFORM LOSS, GO TO APPLICABLE TABLE FOR DISTRIBUTION SIZING.

PLUMBING EQUIPMENT SCHEDULE			
TAG	MANUFACTURER	MODEL NO.	REMARKS
WH-1	A.O. SMITH	DEN-66	ELECTRIC WATER HEATER, 66 GALLON STORAGE CAPACITY, 70 DEGREE TEMPERATURE RISE (120 DEGREE DISCHARGE TEMP), 4500W/4500W DUAL ELEMENT, 25 GPH RECOVERY CAPACITY. INCLUDE INSULATION, METAL PROTECTIVE JACKET, T&P RELIEF VALVE, DRAIN VALVE.
EXP-1	AMTROL	ST-5	STEEL EXPANSION TANK, 40 PSIG FACTORY PRE-CHARGED, EPDM DIAPHRAGM, POLYPROPYLENE LINER, 2 GALLON CAPACITY.
CP-1	BELL & GOSSETT	SERIES 100	3/4", 1/12 HP, 120 VOLT, 1 PHASE, ALL BRONZE CIRCULATING PUMP.
TMV-1	LAWLER	911E/F	ALL BRONZE THERMOSTATIC MIXING VLAVE W/OUTLET TEMPERATURE AT FACTORY SET POINT. NOTE: HOT WATER RETURN TEMPERATURE MUST HAVE MINIMUM 10° TEMPERATURE DECREASE FROM OUTLET TEMPERATURE.
RPBP-1	WATTS	009	3/4" REDUCED PRESSURE ZONE BACKFLOW PREVENTOR, BRONZE BODY CONSTRUCTION, DUAL CHECK VALVE ASSEMBLY.
HB-1	WOODFORD	MODEL 24	WALL HYDRANT WITH INTEGRAL VACUUM BREAKER, 3/4" HOSE THREAD NOZZLE AND LOOSE TEE KEY.

	PLUMBING FIXTURE SCHEDULE			
TAG	MANUFACTURER	MODEL NO.	REMARKS	
WC-1	KOHLER	WELLCOMME K-4349	VITREOUS CHINA ,FLOOR OUTLET, 1.6 GALLON MANUAL OPERATED FLUSH VALVE.	
	BEMIS	1955-SSC	ENLONGATED OPEN FRONT SEAT, LESS COVER, WITH STAINLESS STEEL SELF-SUSTAINING, CHECK HINGE.	
	SLOAN	"ROYAL" 111	CHROME PLATED TOP SPUD, 1.6 GALLON MANUAL OPERATED FLUSH VALVE.	
L-1	KOHLER	GREENWICH K-2032	VITREOUS CHINA, 20" X 18" WALL HUNG, 4" FAUCET CENTERS, ADA COMPLIANT, COLOR WHITE.	
	CHICAGO	2200-4E2805CP	MANUAL, SINGLE CONTROL FAUCET, POLISHED CHROME, WITH GRID STRAINER, CERAMIC CARTRIDGES.	
	MCGUIRE	PWV8902	1-1/4" x 1-1/2" P-TRAP, BRASS, 17 GAUGE WITH CLEAN-OUT.	
		2165CC	ANGLE STOPS AND SUPPLIES.	
		PW2000	INSULATION KIT.	
		-	PROVIDE COMMERCIAL GRADE CONCEALED ARM LAVATORY CARRIER.	
SH-1	SYMMONS	SAFETYMIX 1-100	SAFETYMIX SHOWER SYSTEM WITH PRESSURE-BALABCING MIXING VALVE, LEVE HANDLE, ADJUSTABLE STOP SCREW, BRONZE BODY VALVE, INTERGRAL SERVICE STOPS & ESCUTCHEON COVER. SHOWER HEAD TO BE CHROME PLATED MOUNTE AT 6'-0" ABOVE FLOOR WITH 2.0 GPM FLOW RESTRICTOR.	
S-1	KOHLER	BANNON K-6719	CAST RION, 24"x20.25" WALL HUNG SERVICE SINK, SINGLE COMPARTMENT, BLANI BACK, ACID RESISTANT FINISH & STAINLESS STEEL RIM GUARD.	
	CHICAGO	897-RCF	POLISHED CHROME PLATED WALL MOUNTED SERVICE SINK FAUCET WITH INTEGRAL STOPS.	
		E27	SPOUT OUTLET VACUUM BREAKER	
	KOHLER	K-6673	3" ADJUSTABLE IRON TRAP WITH STRAINER, CLEANOUT AND FLOOR PLATE.	
EW/SH-1	ACORN	S1310	PEDESTAL MOUNTED COMBINATION SHOWER/EYEWASH STATION, PLASTIC BOW STAY-OPEN 1/2" BALL VALVE WITH PUSH HANDLE, PLASTIC SHOWERHEAD AND 1" STAY-OPEN BALL VALVE WITH PULL ROD. 20 GPM SHOWERHEAD.	

PLUMBING DRAIN AND CLEANOUT SCHEDULE			
TAG	MANUFACTURER	MODEL NO.	REMARKS
FD-1	ZURN	Z415-B	CAST IRON BODY, ADJUSTABLE STRAINER HEAD, COMBINATION INVERTIBLE MEMBRANE CLAMP AND ADJUSTABLE COLLAR WITH NICKEL BRONZE TOP.
TD-1	ABT DRAINS, INC. POLYDRAIN	TF-14 TRENCH DRAIN FORMING SYSTEM	CAST-IN-PLACE TRENCH DRAIN AND CATCH BASIN, PRE-MANUFACTURED FORMING INSERTS WITH TRENCH DRAIN RAILS AND TF-14 SLOTTED DUCTILE IRON GRATE (HEAVY DUTY).
HD-1	ZURN	Z-326-DB	CAST IRON BODY, 9" INDIRECT WASTE FUNNEL WITH DOME BOTTOM STRAINER
HD-2	ZURN	Z-415-E	CAST IRON BODY, ADJUSTABLE STRAINER HEAD, COMBINATION INVERTIBLE MEMBRANE CLAMP AND ADJUSTABLE COLLAR WITH NICKEL BRONZE TOP WITH 4" DIA FUNNEL.
FCO	ZURN	Z1400-BP	CAST IRON BODY, ADJUSTABLE FLOOR CLEANOUT WITH NICKEL BRONZE TOP AND GAS AND WATERTIGHT ABS TAPERED BRONZE PLUG (USE IN FINISHED AREAS).
		Z1474	CAST IRON BODY, HEAVY DUTY CLEANOUT HOUSING, WITH NICKEL BROZE TOP AND INTERNAL CLEANOUT (USE IN UNFINISHED AREAS, MECHANICAL ROOMS, JANITOR CLOSETS, ETC.).
YCO	ZURN	Z1440-BP	CAST IRON BODY FERRULE WITH BRONZE PLUG. PROVIDE WITH FROST SLEEVE AND HEAVY DUTY WATER TIGHT TOP.
WCO	ZURN	Z1468	ROUND STAINLESS STEEL WALL ACCESS COVER WITH SECURING SCREW, BRONZE RAISED HEX HEAD PLUG.
СО	ZURN	Z1440-BP	CAST IRON BODY FERRULE WITH BRONZE PLUG.

SHEET INDEX

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- P101 HHW FIRST/WTS LOWER LEVEL PLUMBING PLAN
- P102 HHW MEZZANINE/WTS UPPER LEVEL PLUMBING PLAN
- P300 PLUMBING ISOMETRICS P500 - PLUMBING DETAILS
- FP101 HHW FIRST/WTS LOWER LEVEL FIRE PROTECTION PLAN FP102 - HHW MEZZANINE/WTS UPPER LEVEL FIRE PROTECTION PLAN

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CONSULTANTS:

PROJECT TITLE:

DANE COUNTY WASTE TRANSFER STATION AND HOUSEHOLD HAZARDOUS WASTE FACILITY RODEFELD LANDFILL

ISSUE:

PROJECT NUMBER: 2009-0328.00

CHECKED BY: APPROVED BY: PDZ SCALE: AS NOTED


SHEET TITLE:

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RODEFELD LANDFILL

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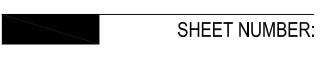
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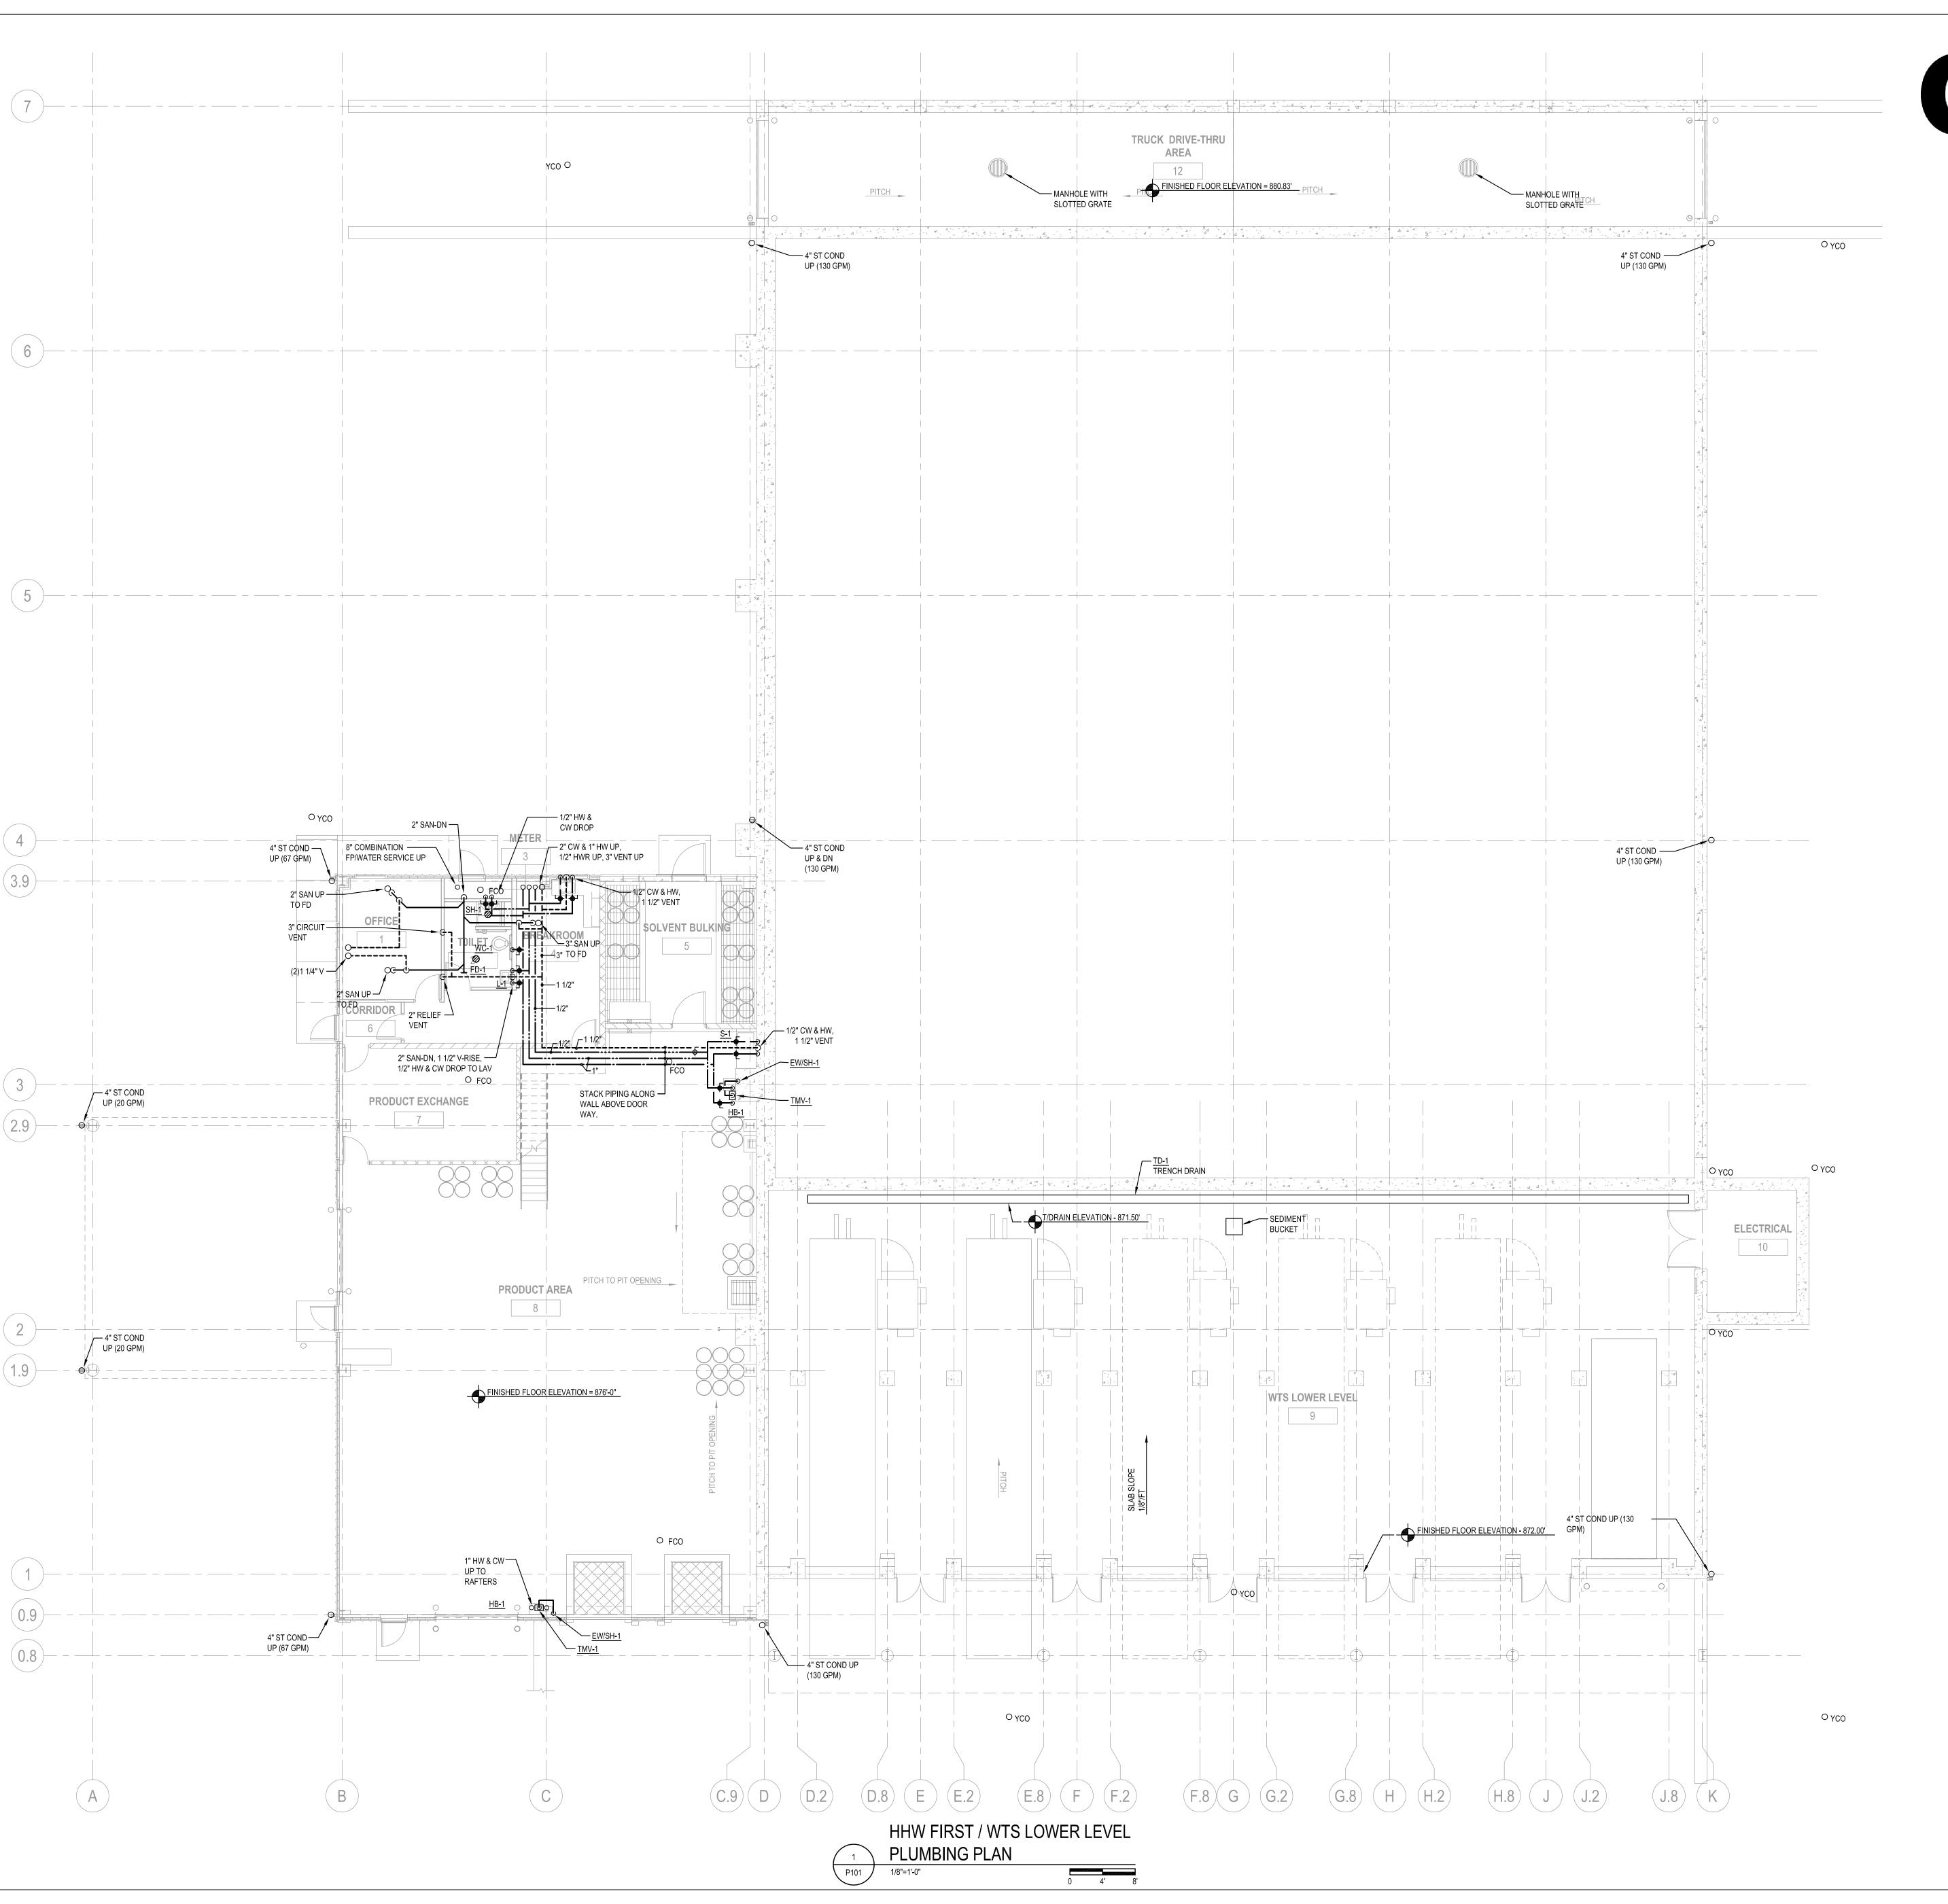
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SHEET TITLE:

HHW FIRST/WTS LOWER LEVEL BELOW SLAB PLUMBING PLAN



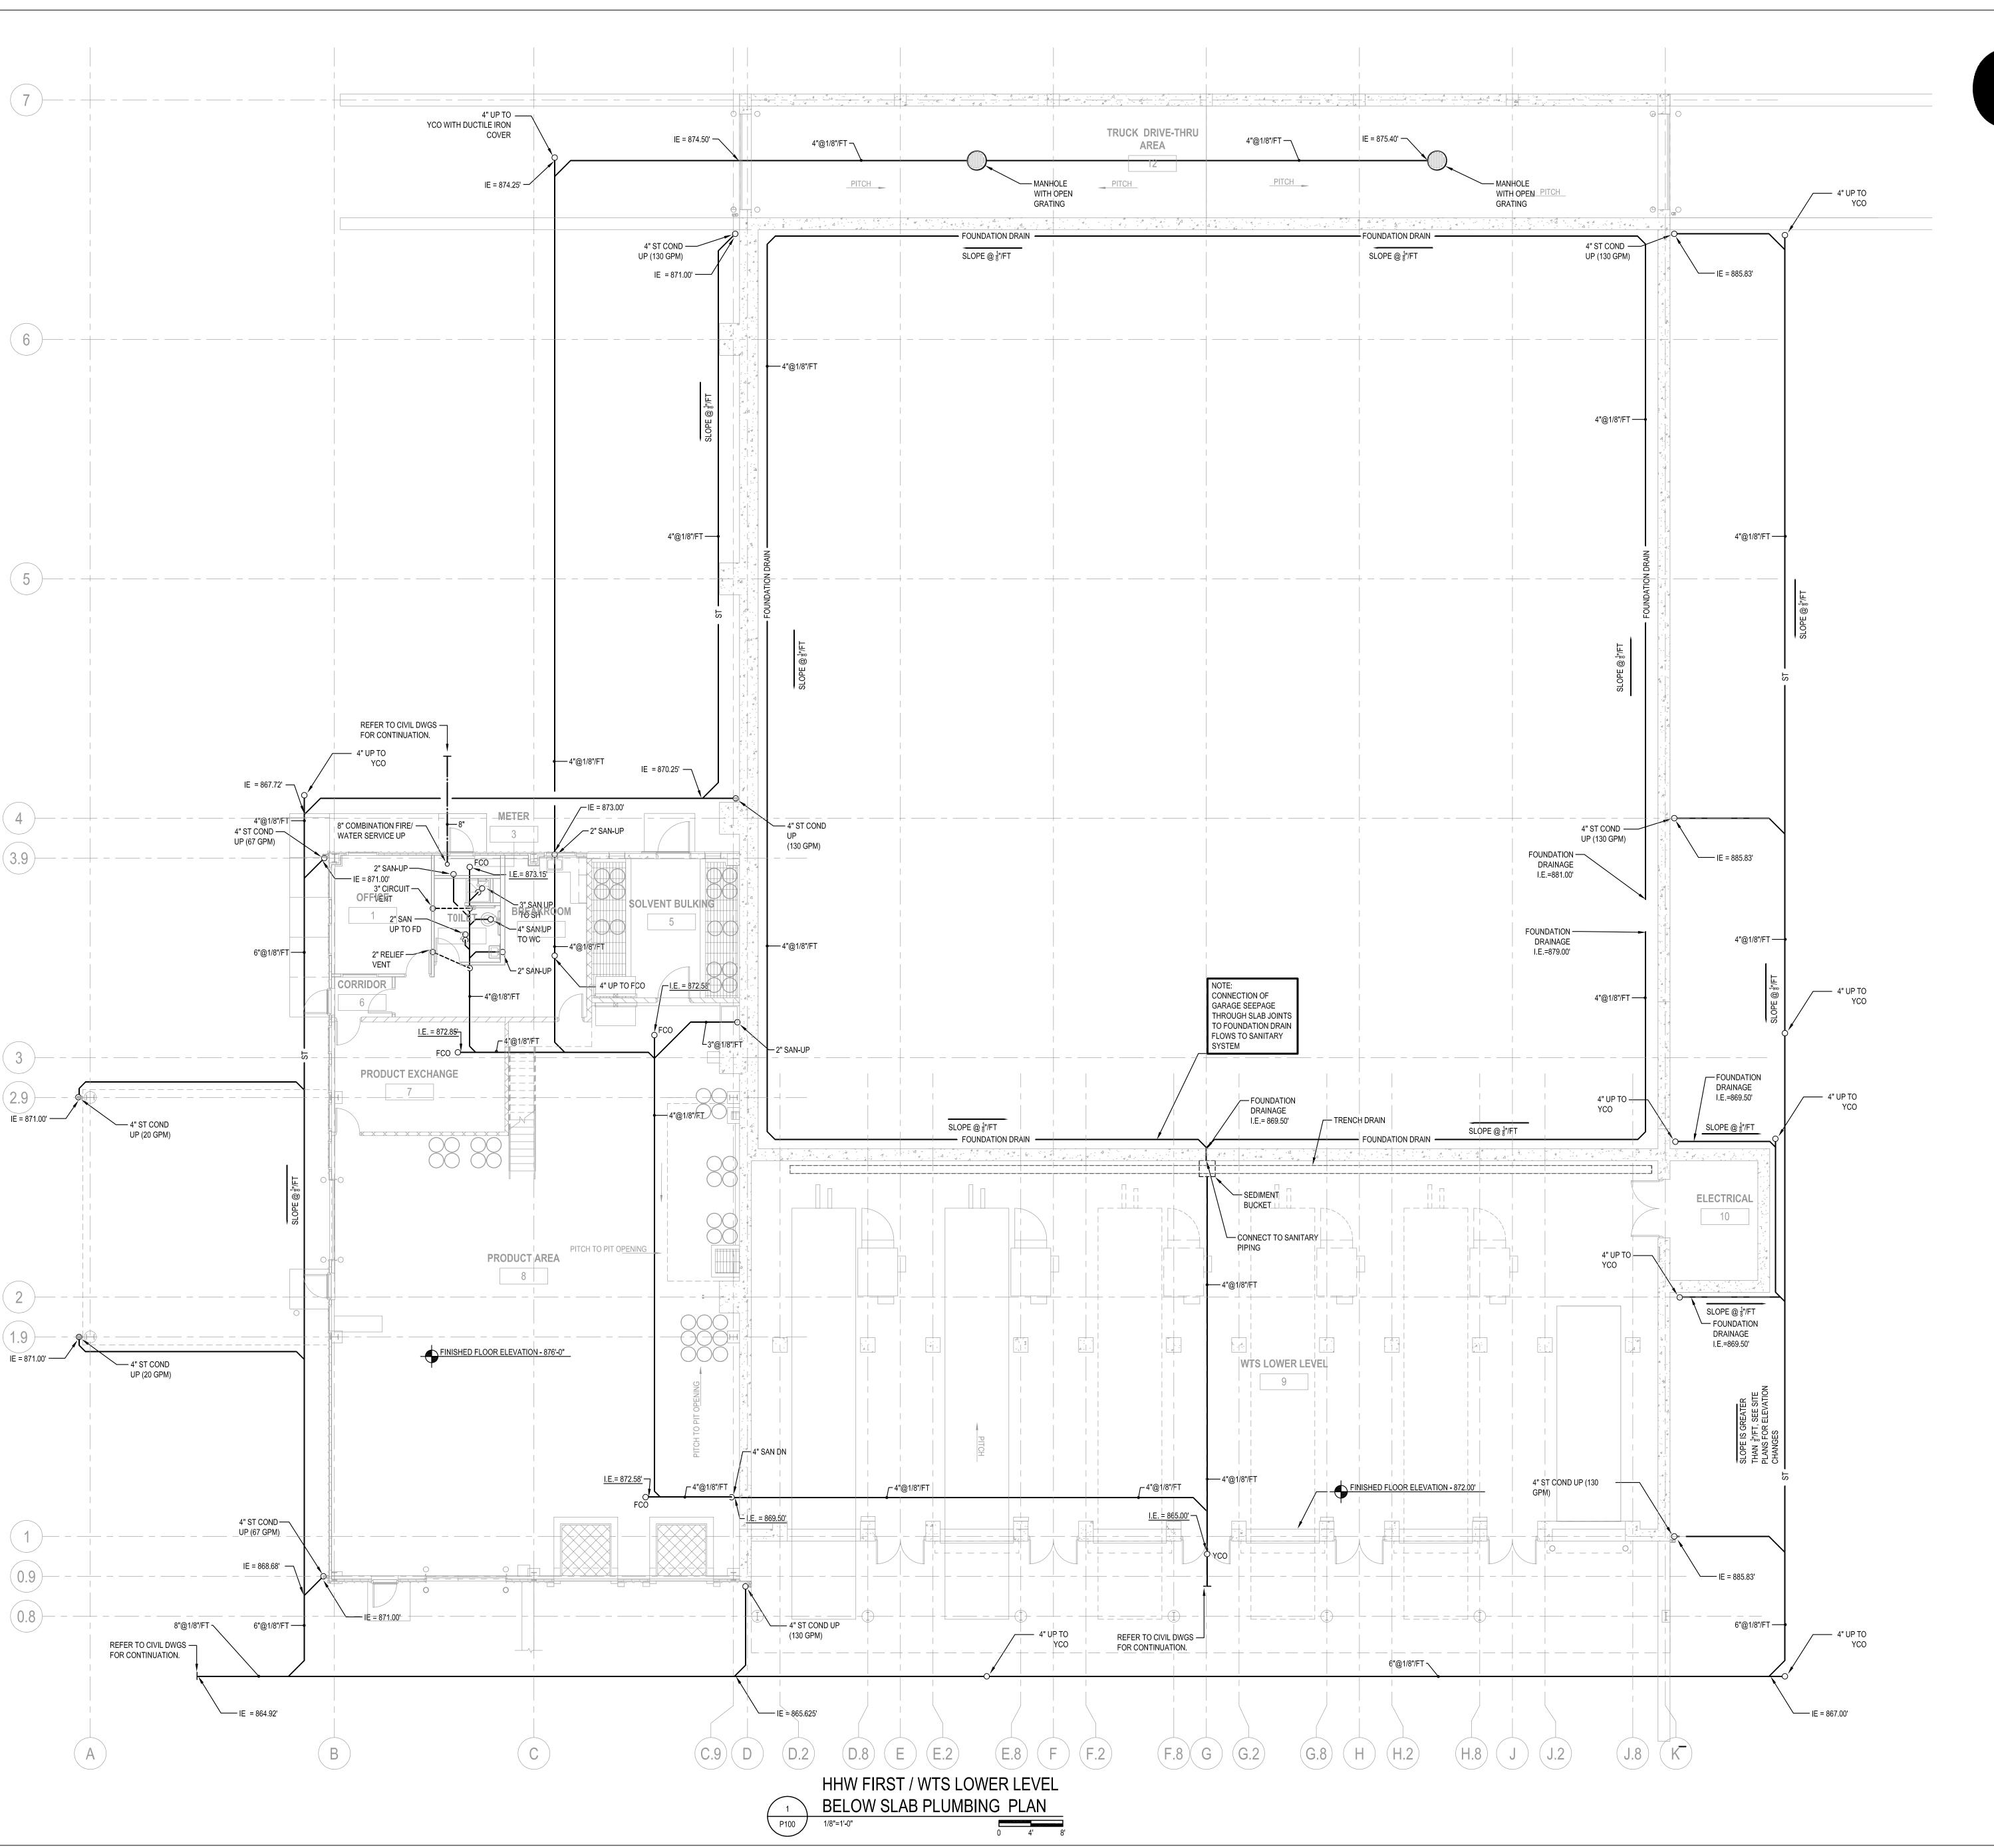

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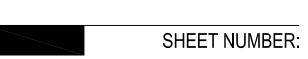
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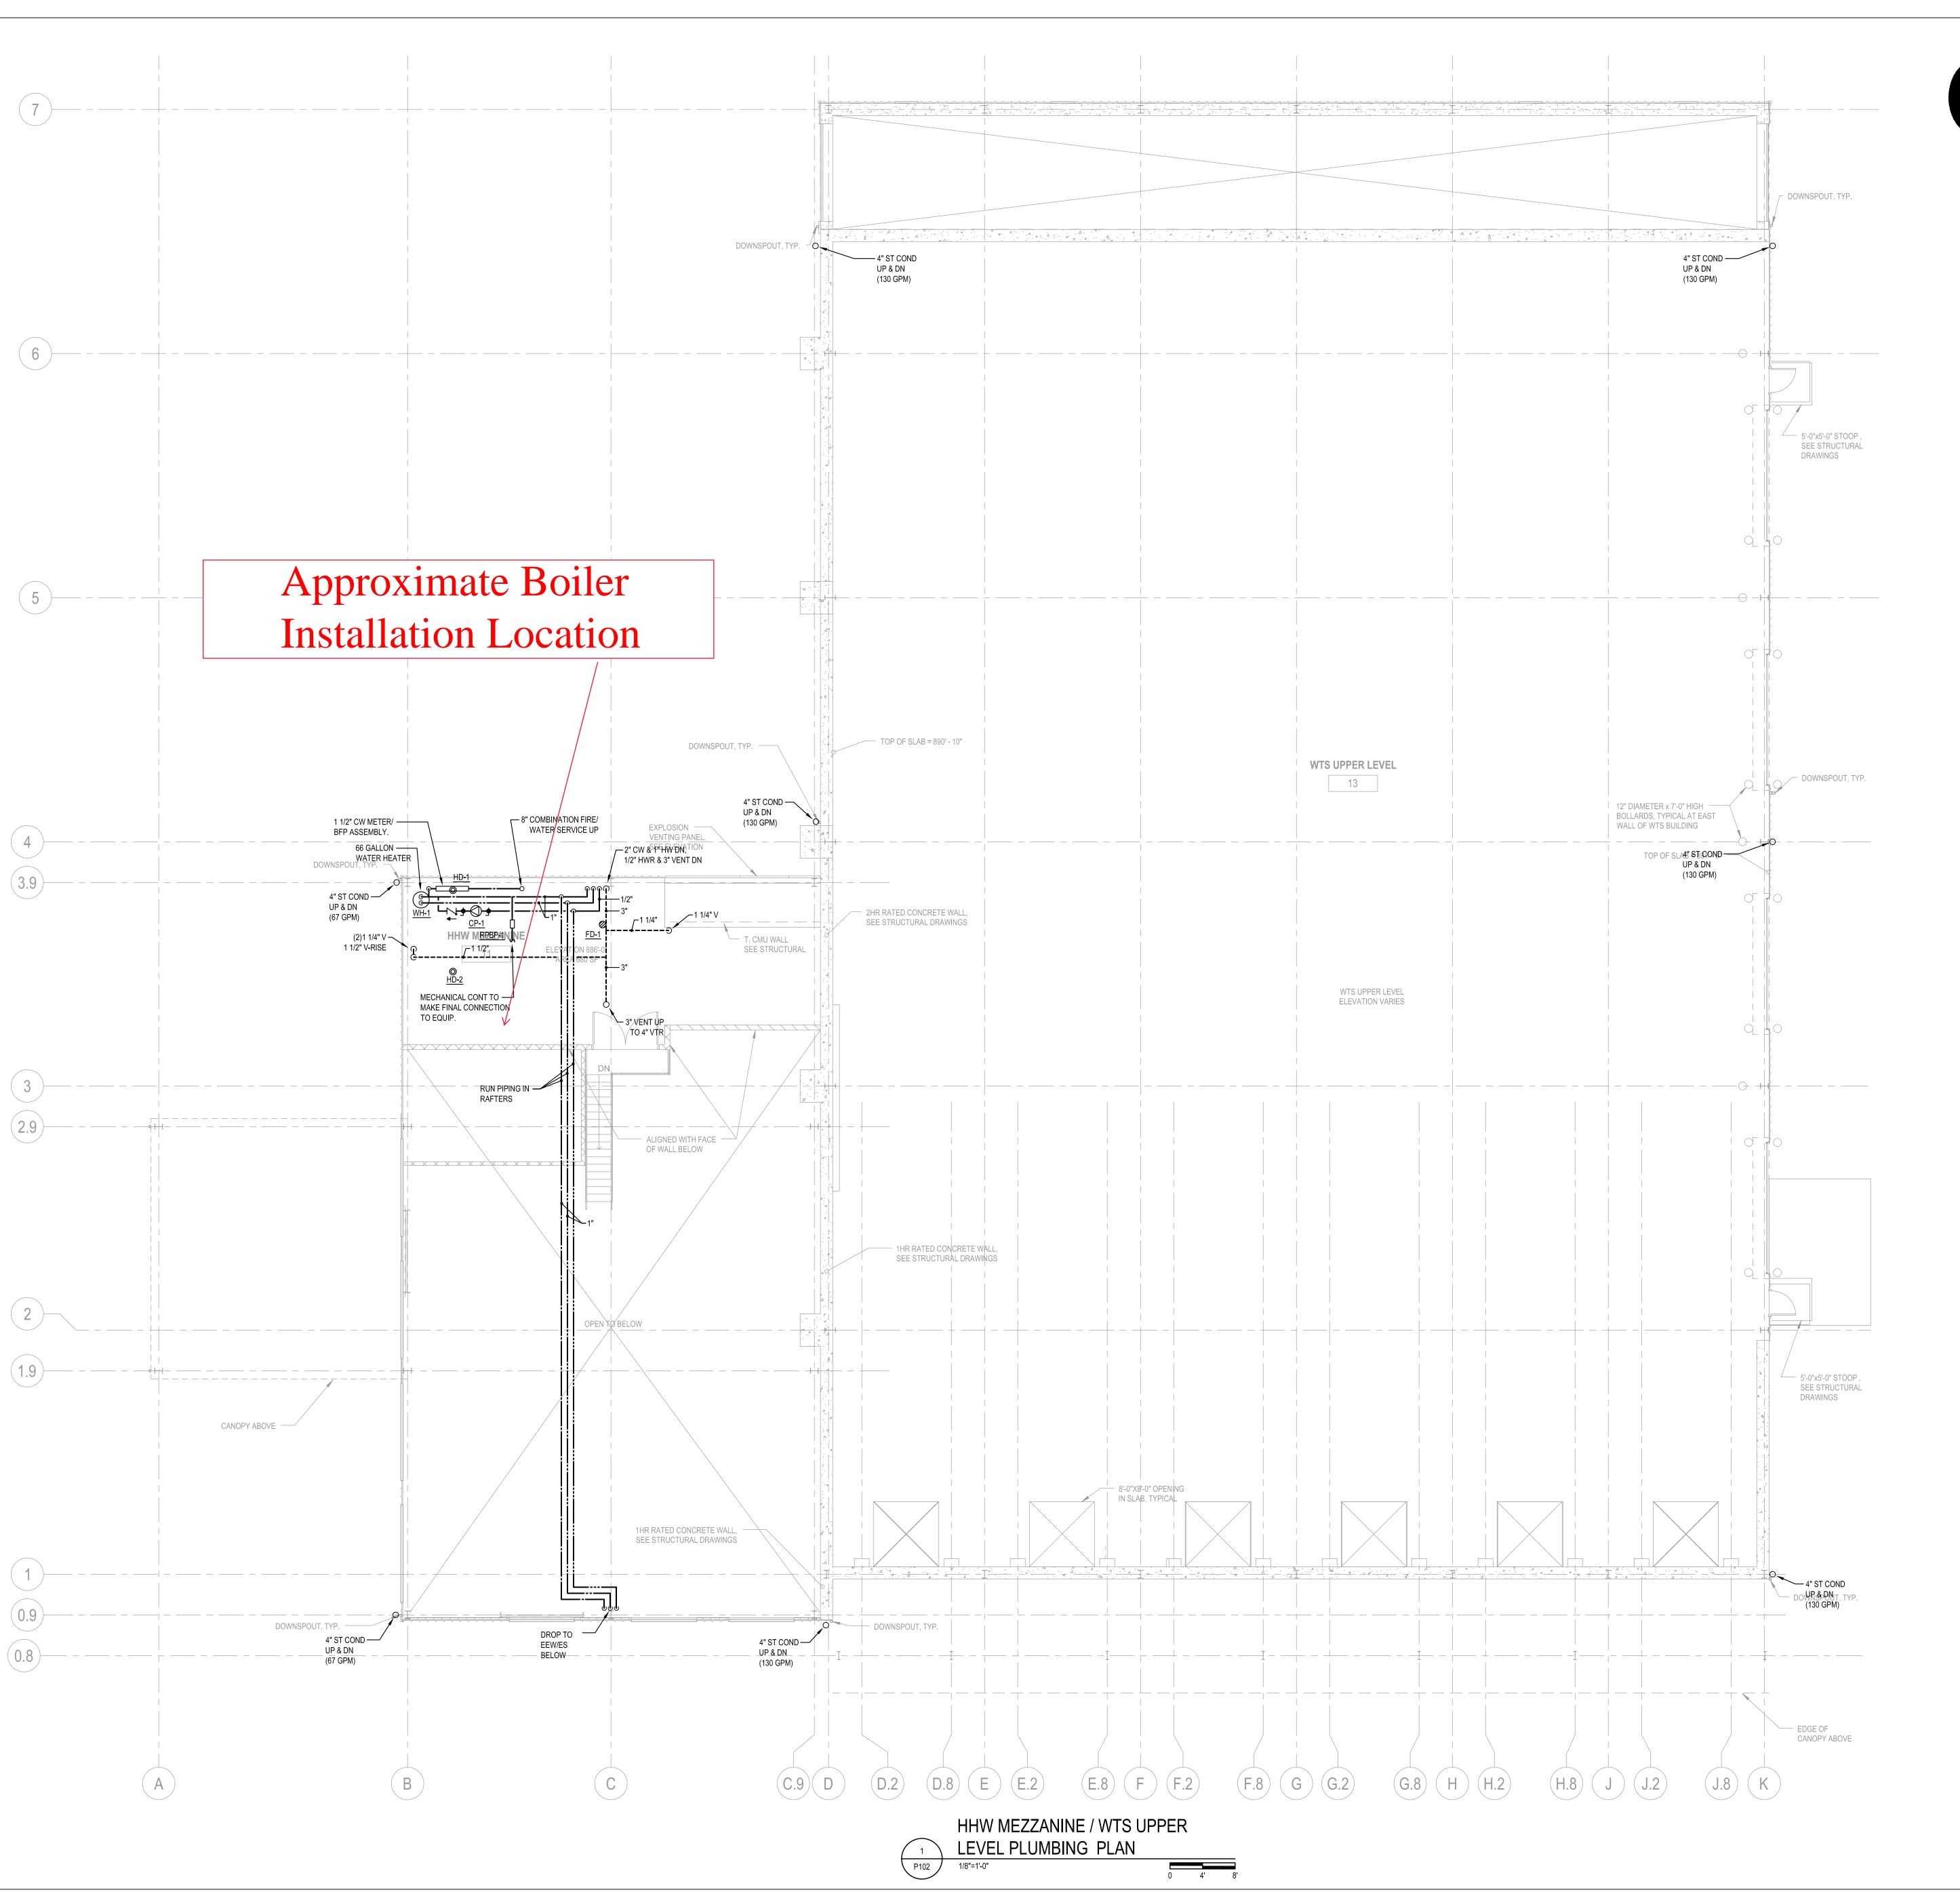
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SCALE: AS NOTED

SHEET TITLE:

HHW FIRST/WTS LOWER LEVEL PLUMBING PLAN







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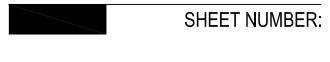
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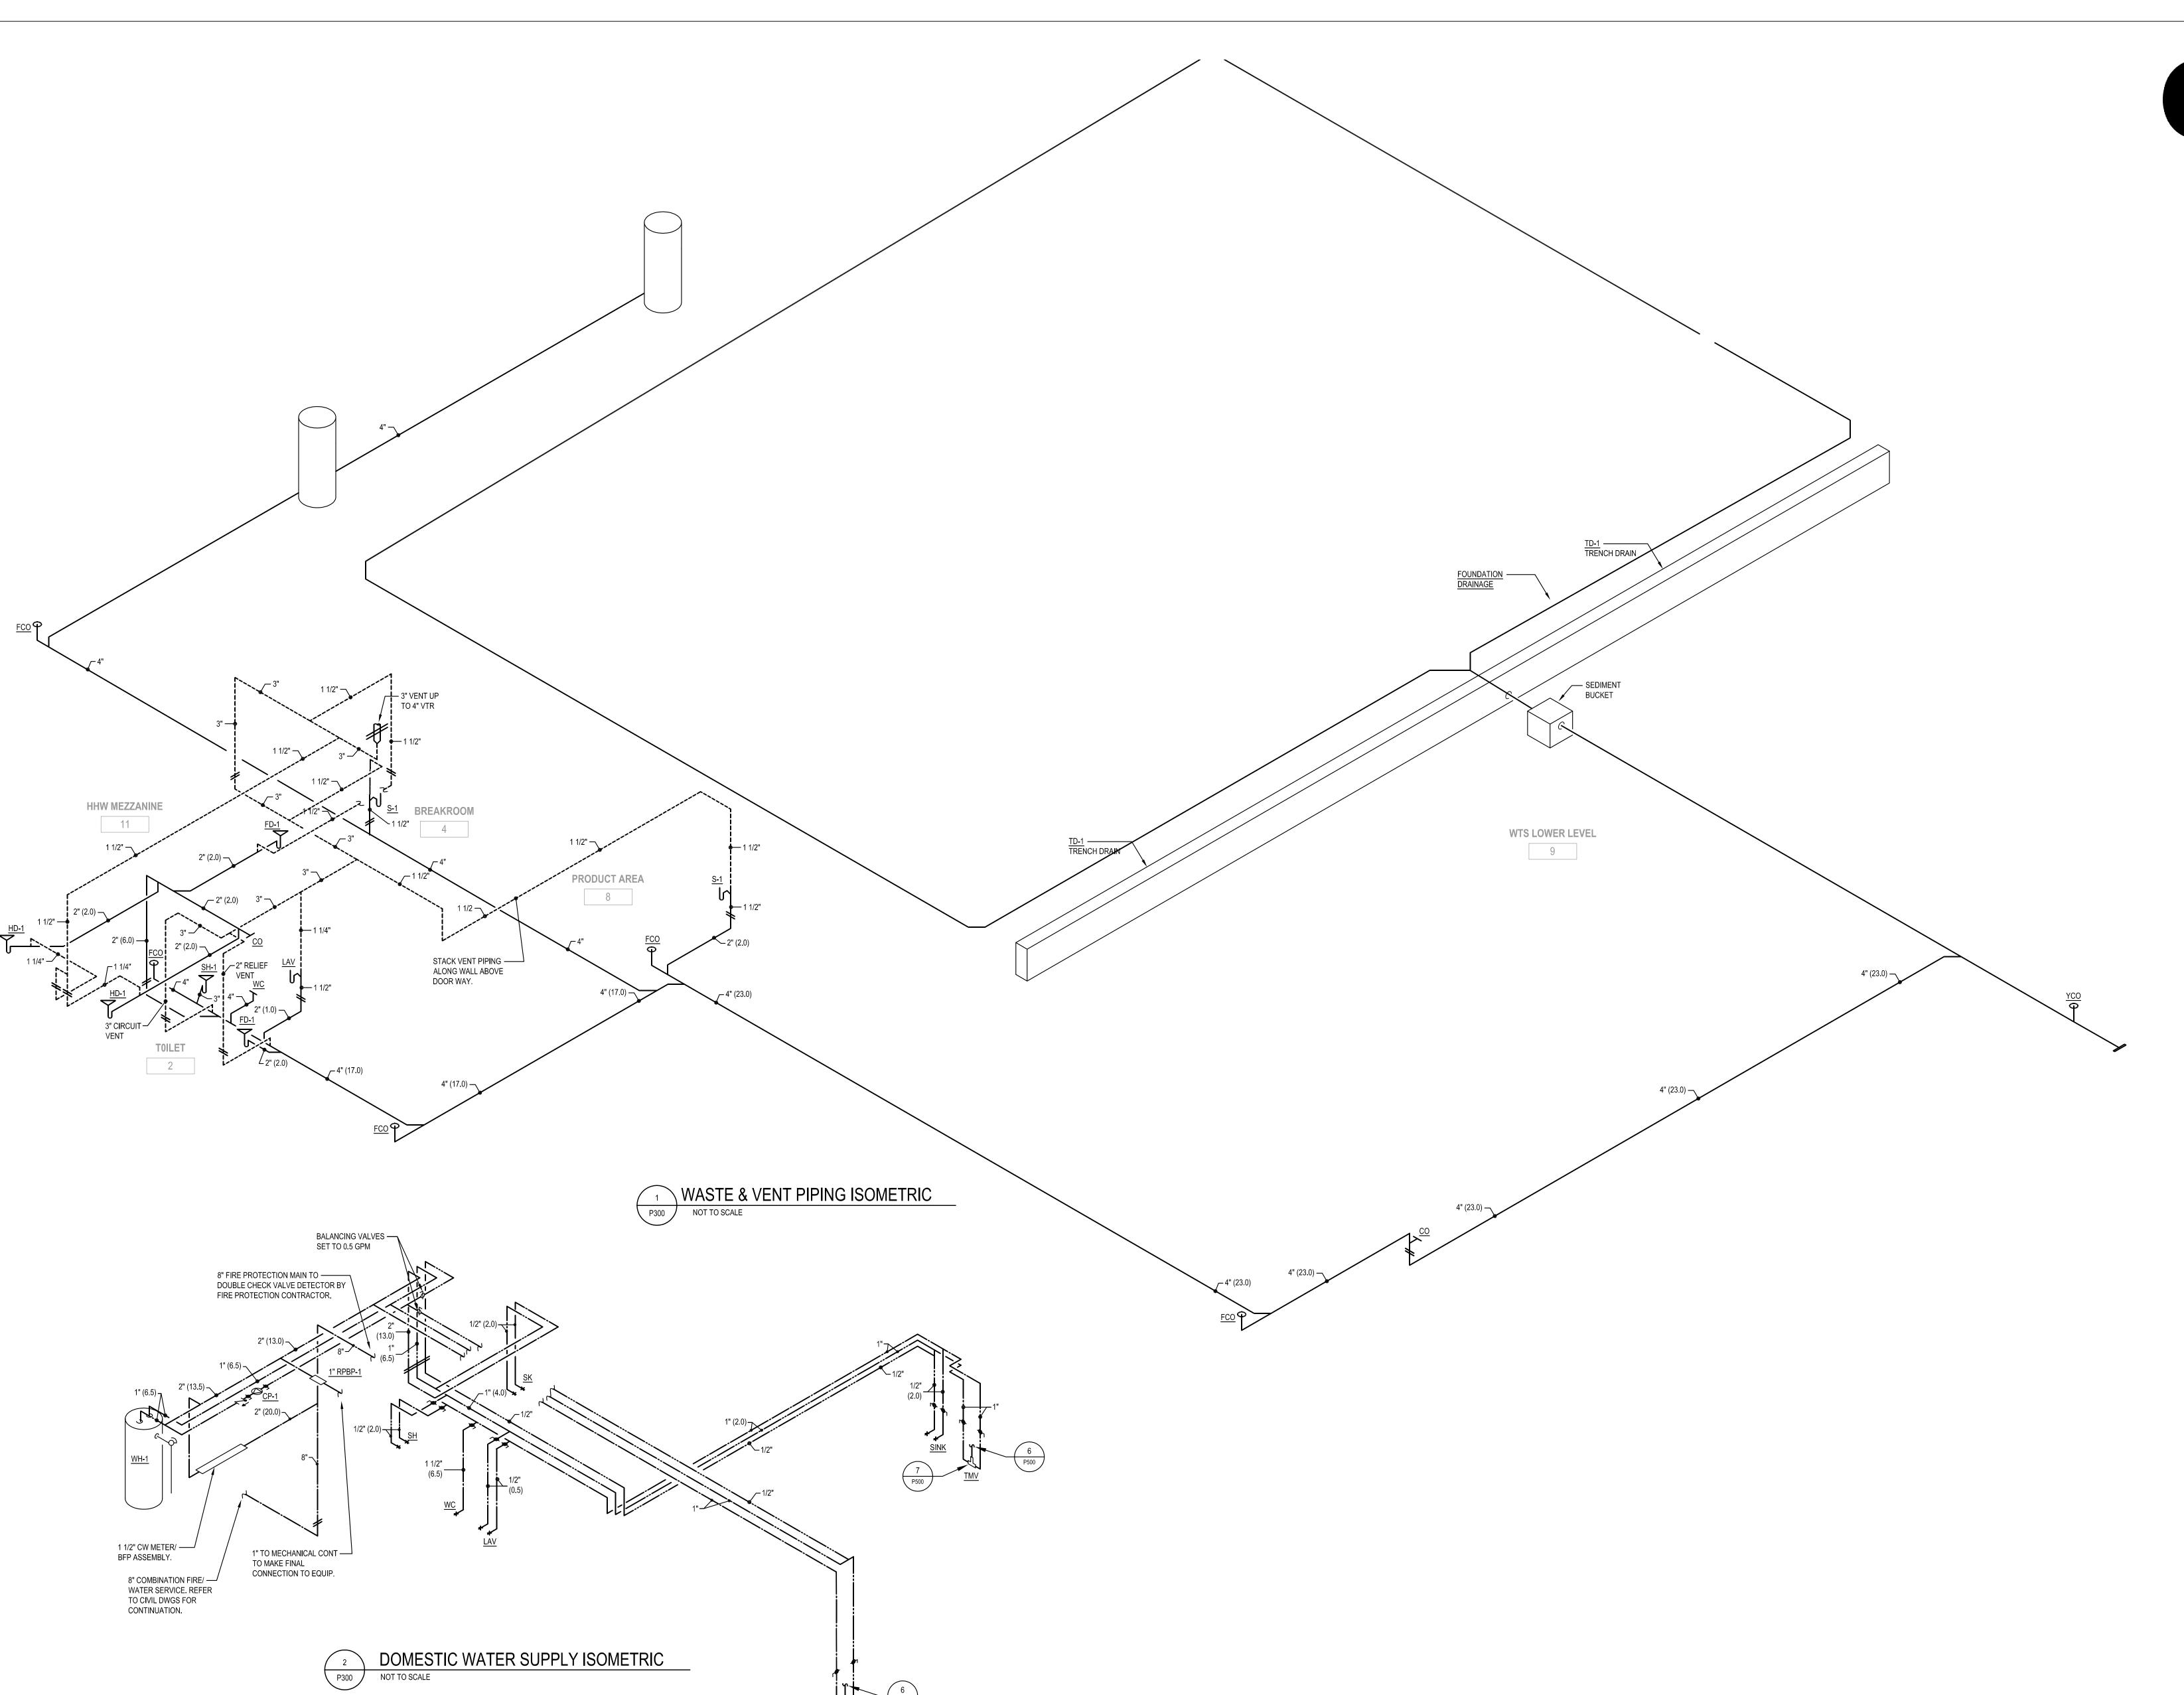
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SCALE: AS NOTED

SHEET TITLE:
HHW MEZZANINE/WTS UPPER LEVEL

PLUMBING PLAN





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SHEET TITLE:

PLUMBING ISOMETRICS

