# WINDOWS REPLACEMENT

## **BID DOCUMENTS CITY-COUNTY BUILDING** 210 MARTIN LUTHER KING JR BLVD MADISON, WI 53703

## OWNER:

## DANE COUNTY PUBLIC WORKS **1919 ALLIANT ENERGY CENTER WAY** MADISON WI 53713

## GENERAL NOTES

Do not scale drawings

- The Contractor shall verify all existing conditions and dimensions at the job site prior to starting the work, and shall immediately notify the Architect/Engineer of any discrepancies, omissions, or other conditions that may affect the scope of work prior to beginning repairs impacted by the noted conditions
- Unanticipated conditions encountered during the course of the work that require additional repairs shall be brought to the attention of the Architect/Engineer. No additional repair work shall be performed unless approved in advance by the Architect/Engineer
- Contractor is solely responsible for all job safety during the repair work
- Contractor shall provide all shoring, bracing, and sheeting required for safety and proper execution of the work
- The Contractor shall be solely responsible for all means and methods. Procedures shall be in accordance with applicable codes and standards. The Contractor shall make any inspections or analysis necessary to verify that existing building elements have adequate load capacity to support any required rigging, shoring, or storage forces he/she chooses to impose on them.
- Contractor shall provide protective barriers, fences, sidewalk bridging, etc. to ensure the safety of pedestrians, building occupants, vehicular traffic, site features, etc. in accordance with the requirements of local and federal authorities, including OSHA. Protective canopy is to be provided at all entrances, exits, sidewalks, and drives below areas of overhead work. Bridging/canopy must be installed at and near all entrances, walkways and other areas where falling objects could injure <u>pedestrians.</u>
- All mechanical, electrical, and plumbing work required to complete the work of this project shall be performed in accordance with all applicable local and national codes Contractor shall provide protection of exterior wall and interior of building at all times against entry of water, dust, and vermin during the work. Contractor shall repair a
- damage caused by such infiltration during the Work at no cost to the Owner.
- If during the interior removals, apparent organic growth/mold or any other suspected health hazard is uncovered, Contractor is to notify the Owner's Representative immediately for resolution.
- 12. These drawings and specifications apply to the "CITY-COUNTY BUILDING WINDOWS REPLACEMENT" project only and shall not be used for any other purpose without the expressed written consent of ZS LLC. . In the event of conflict between the drawings and the specifications, the more stringent requirement and better quality shall govern unless written notification is provided
- by the Architect/Engineer.
- 14. These notes shall apply to all contractors, subcontractors, and suppliers engaged in execution of the work shown on these plans.


## **ARCHITECT/ENGINEER:**


ZS LLC 10501 WEST RESEARCH DRIVE, SUITE 207 MILWAUKEE, WI 53226


AERIAL PHOTO




		Sheet List
	Sheet Number	Sheet Name
	W900	TITLE SHEET
	W901	EAST ELEVATION
	W902	NORTH ELEVATION
	W903	SOUTH ELEVATION
	W904	WEST ELEVATION
	W905	ORIGINAL WINDOW TYPES
	W906	ORIGINAL DETAILS
	W907	NEW WINDOW TYPES
	XV908	WINDOW SYSTEM DETAILS
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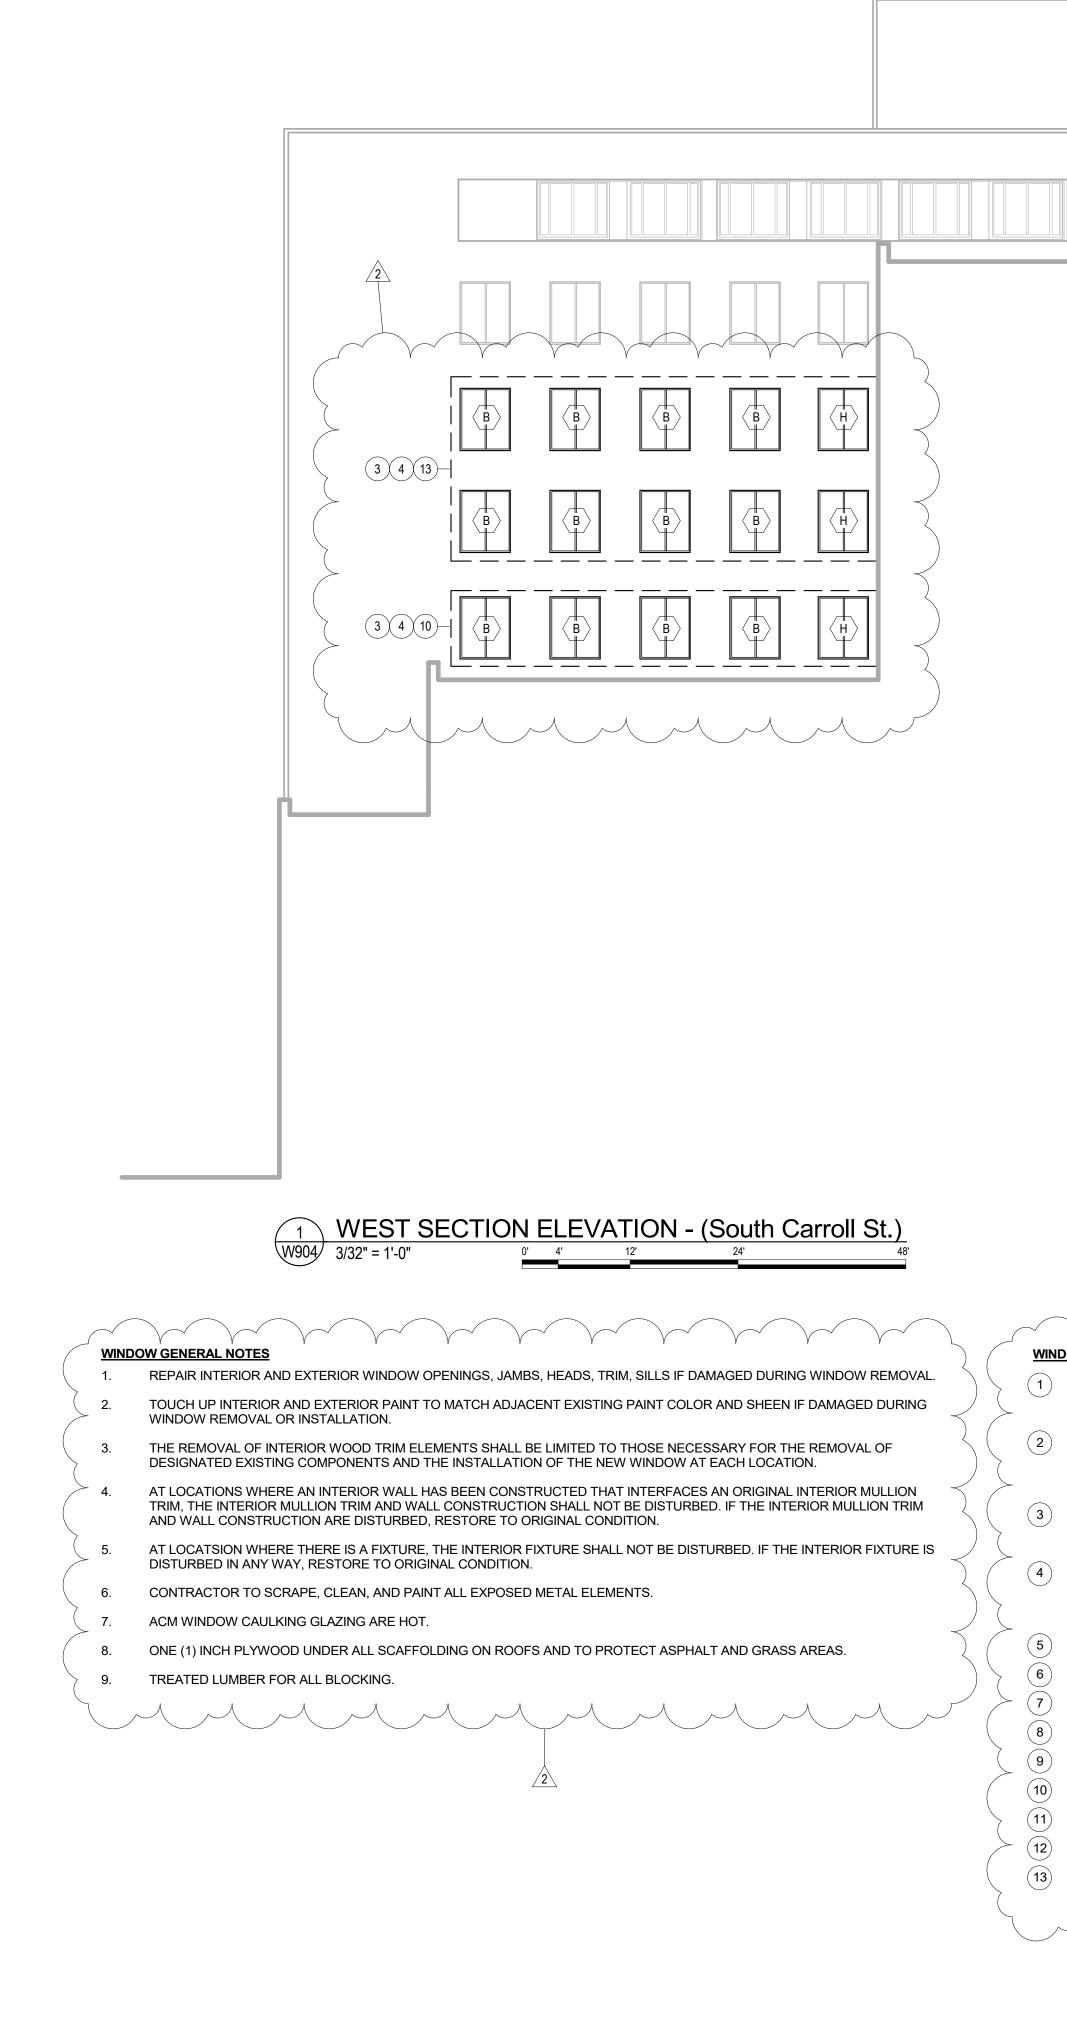


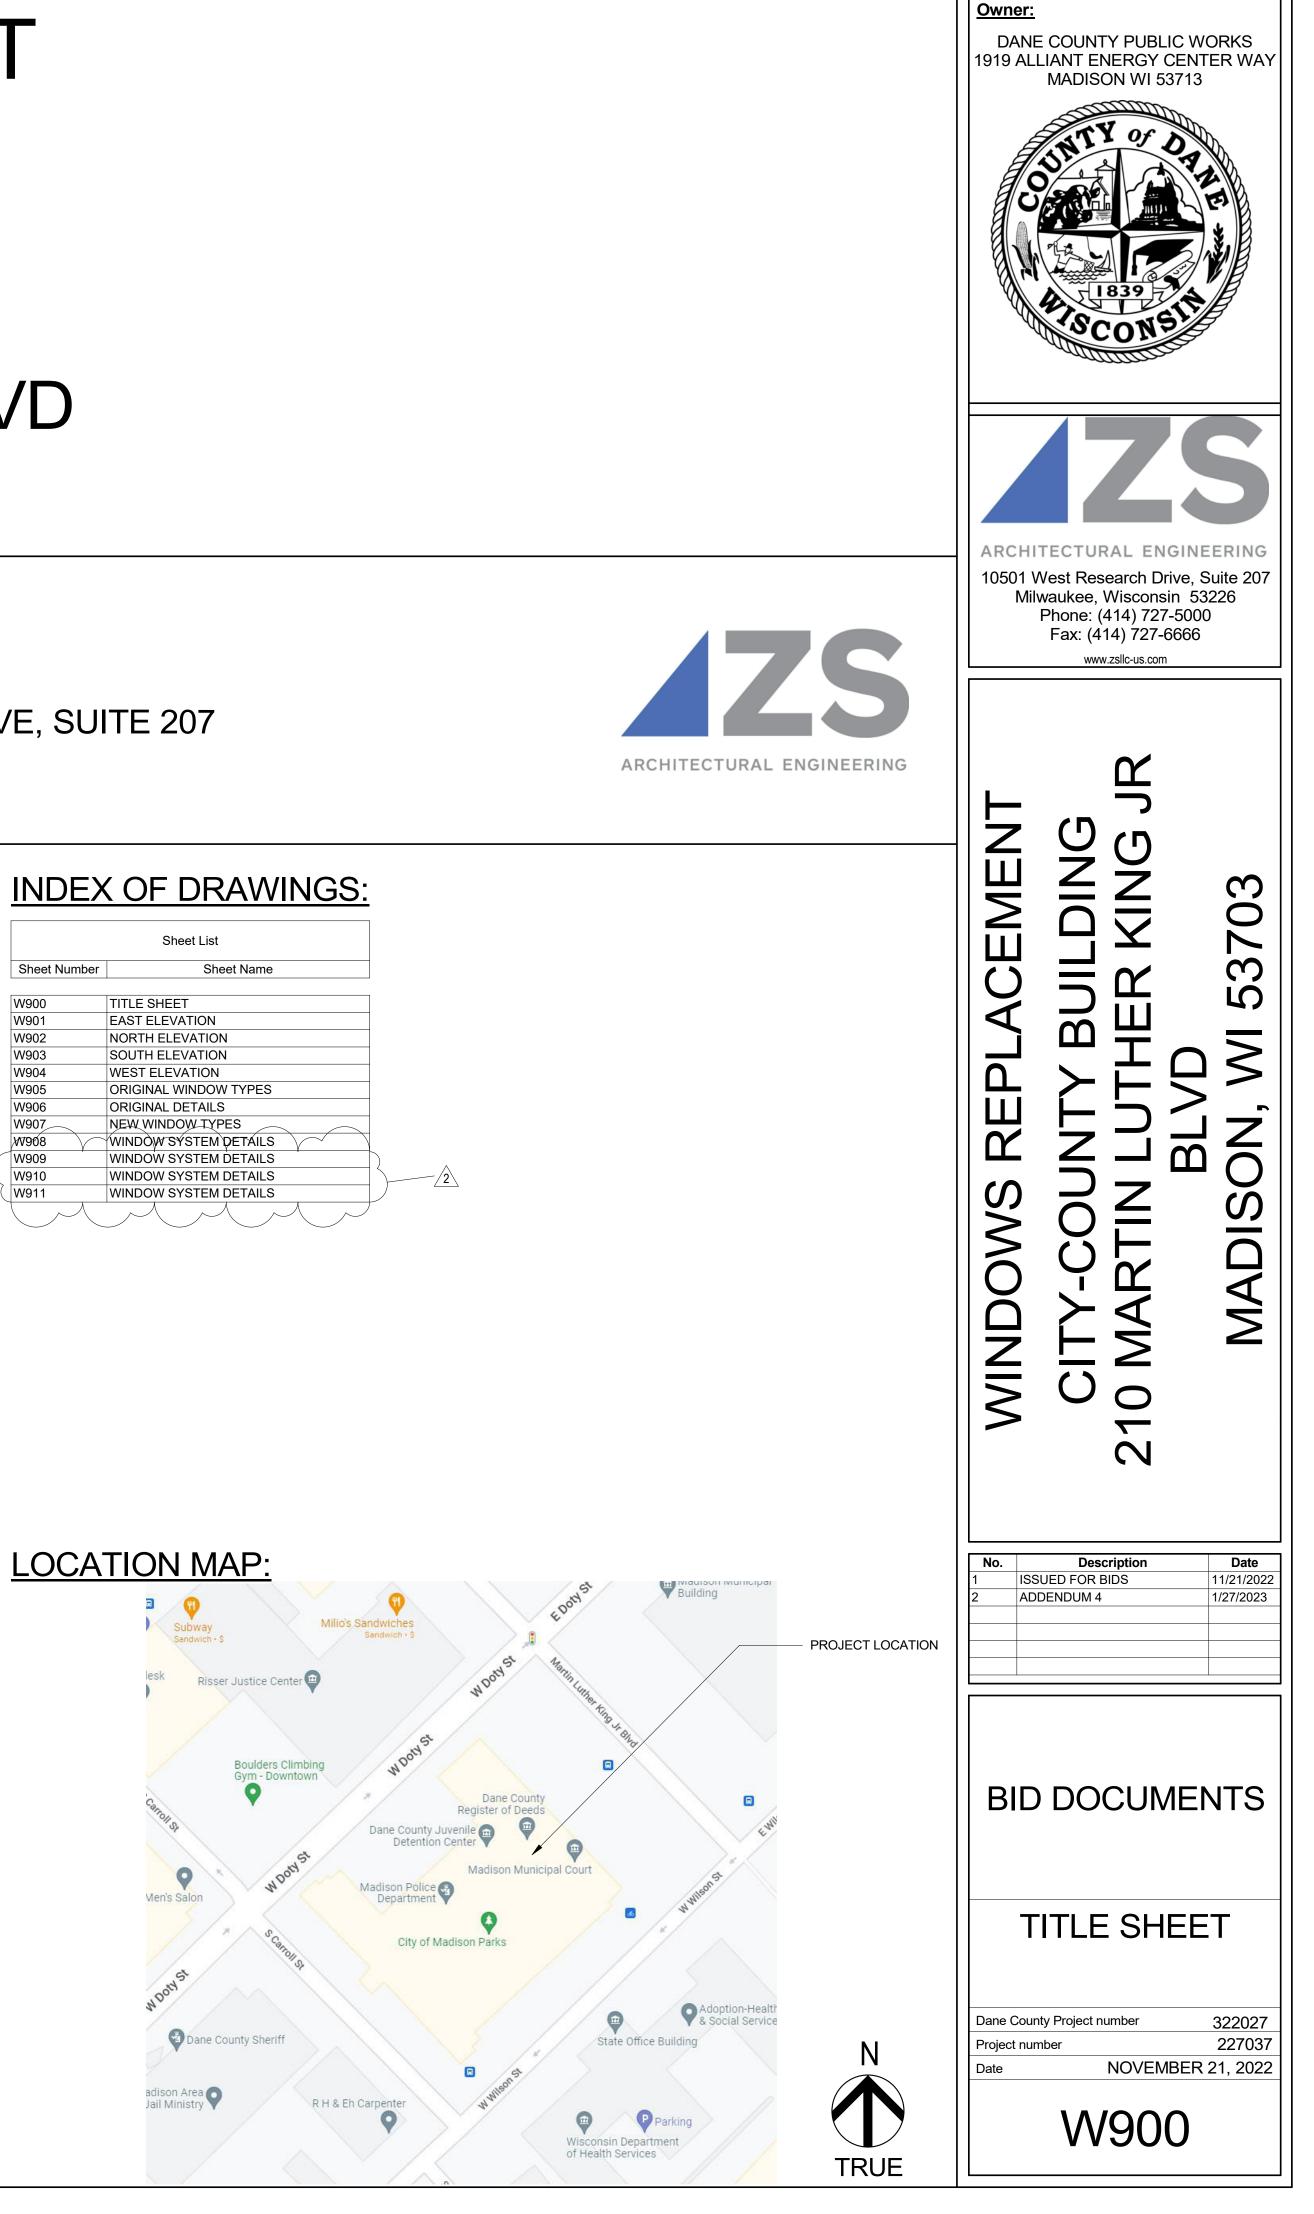


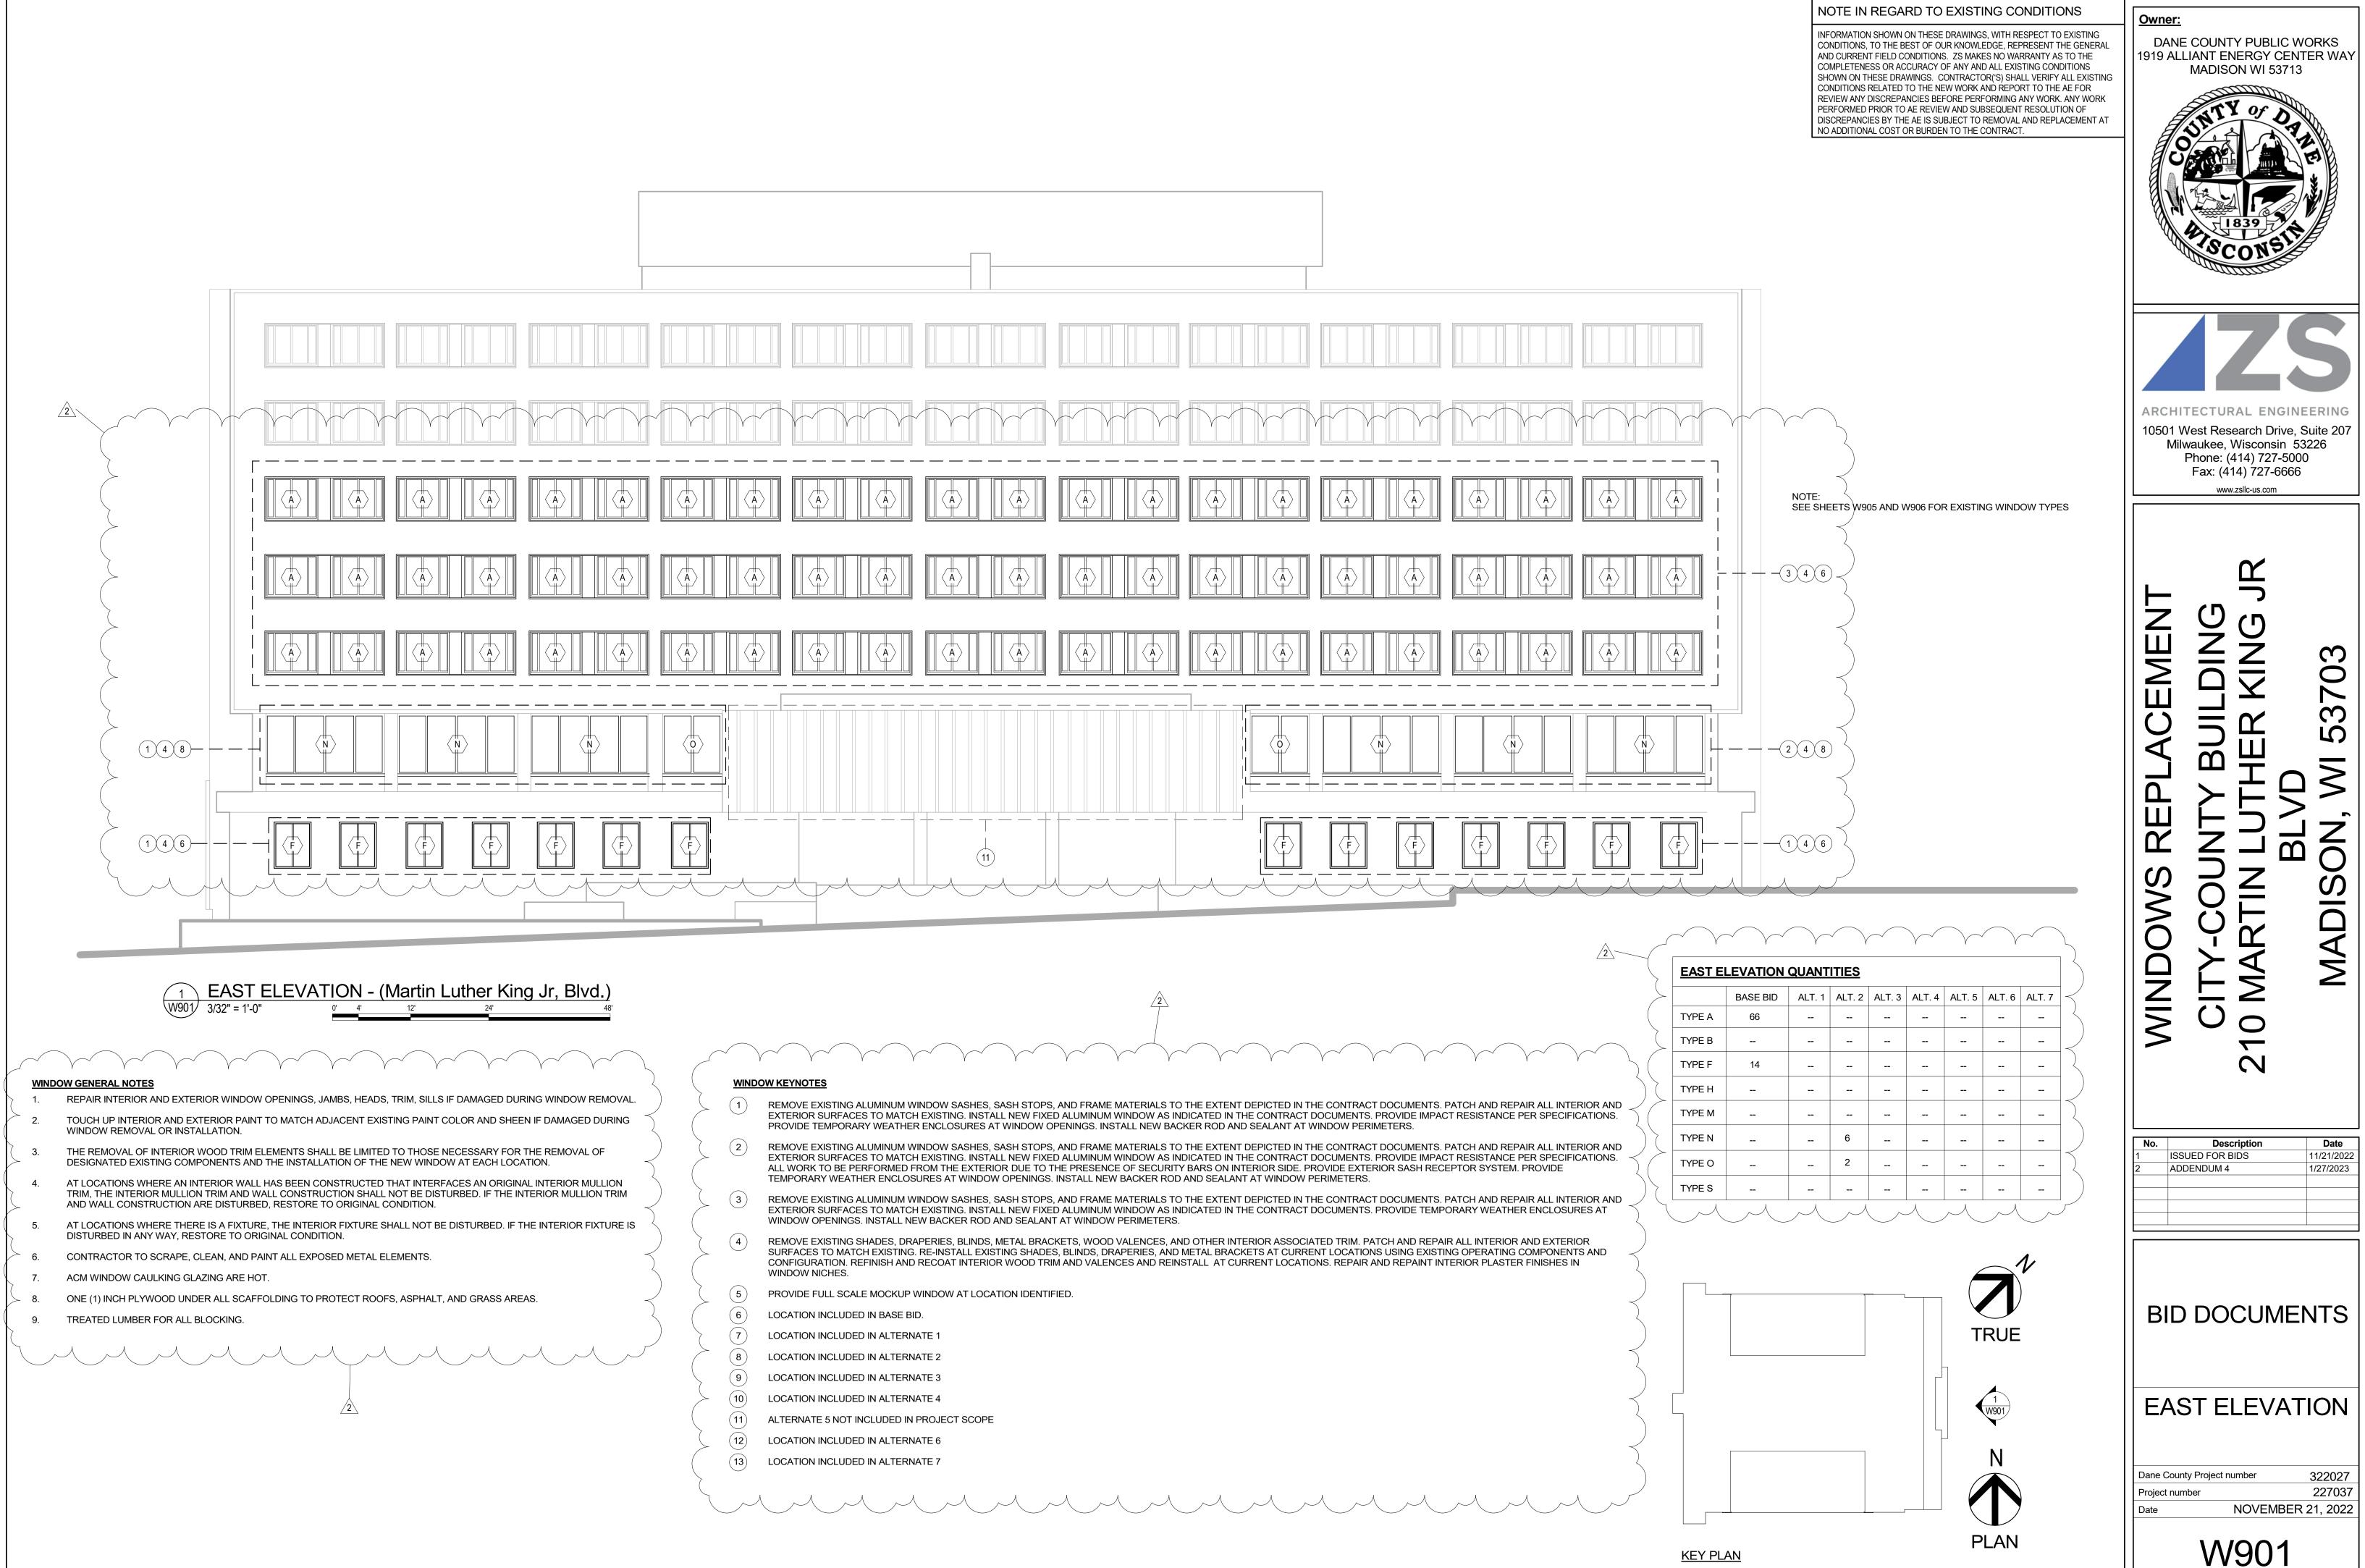

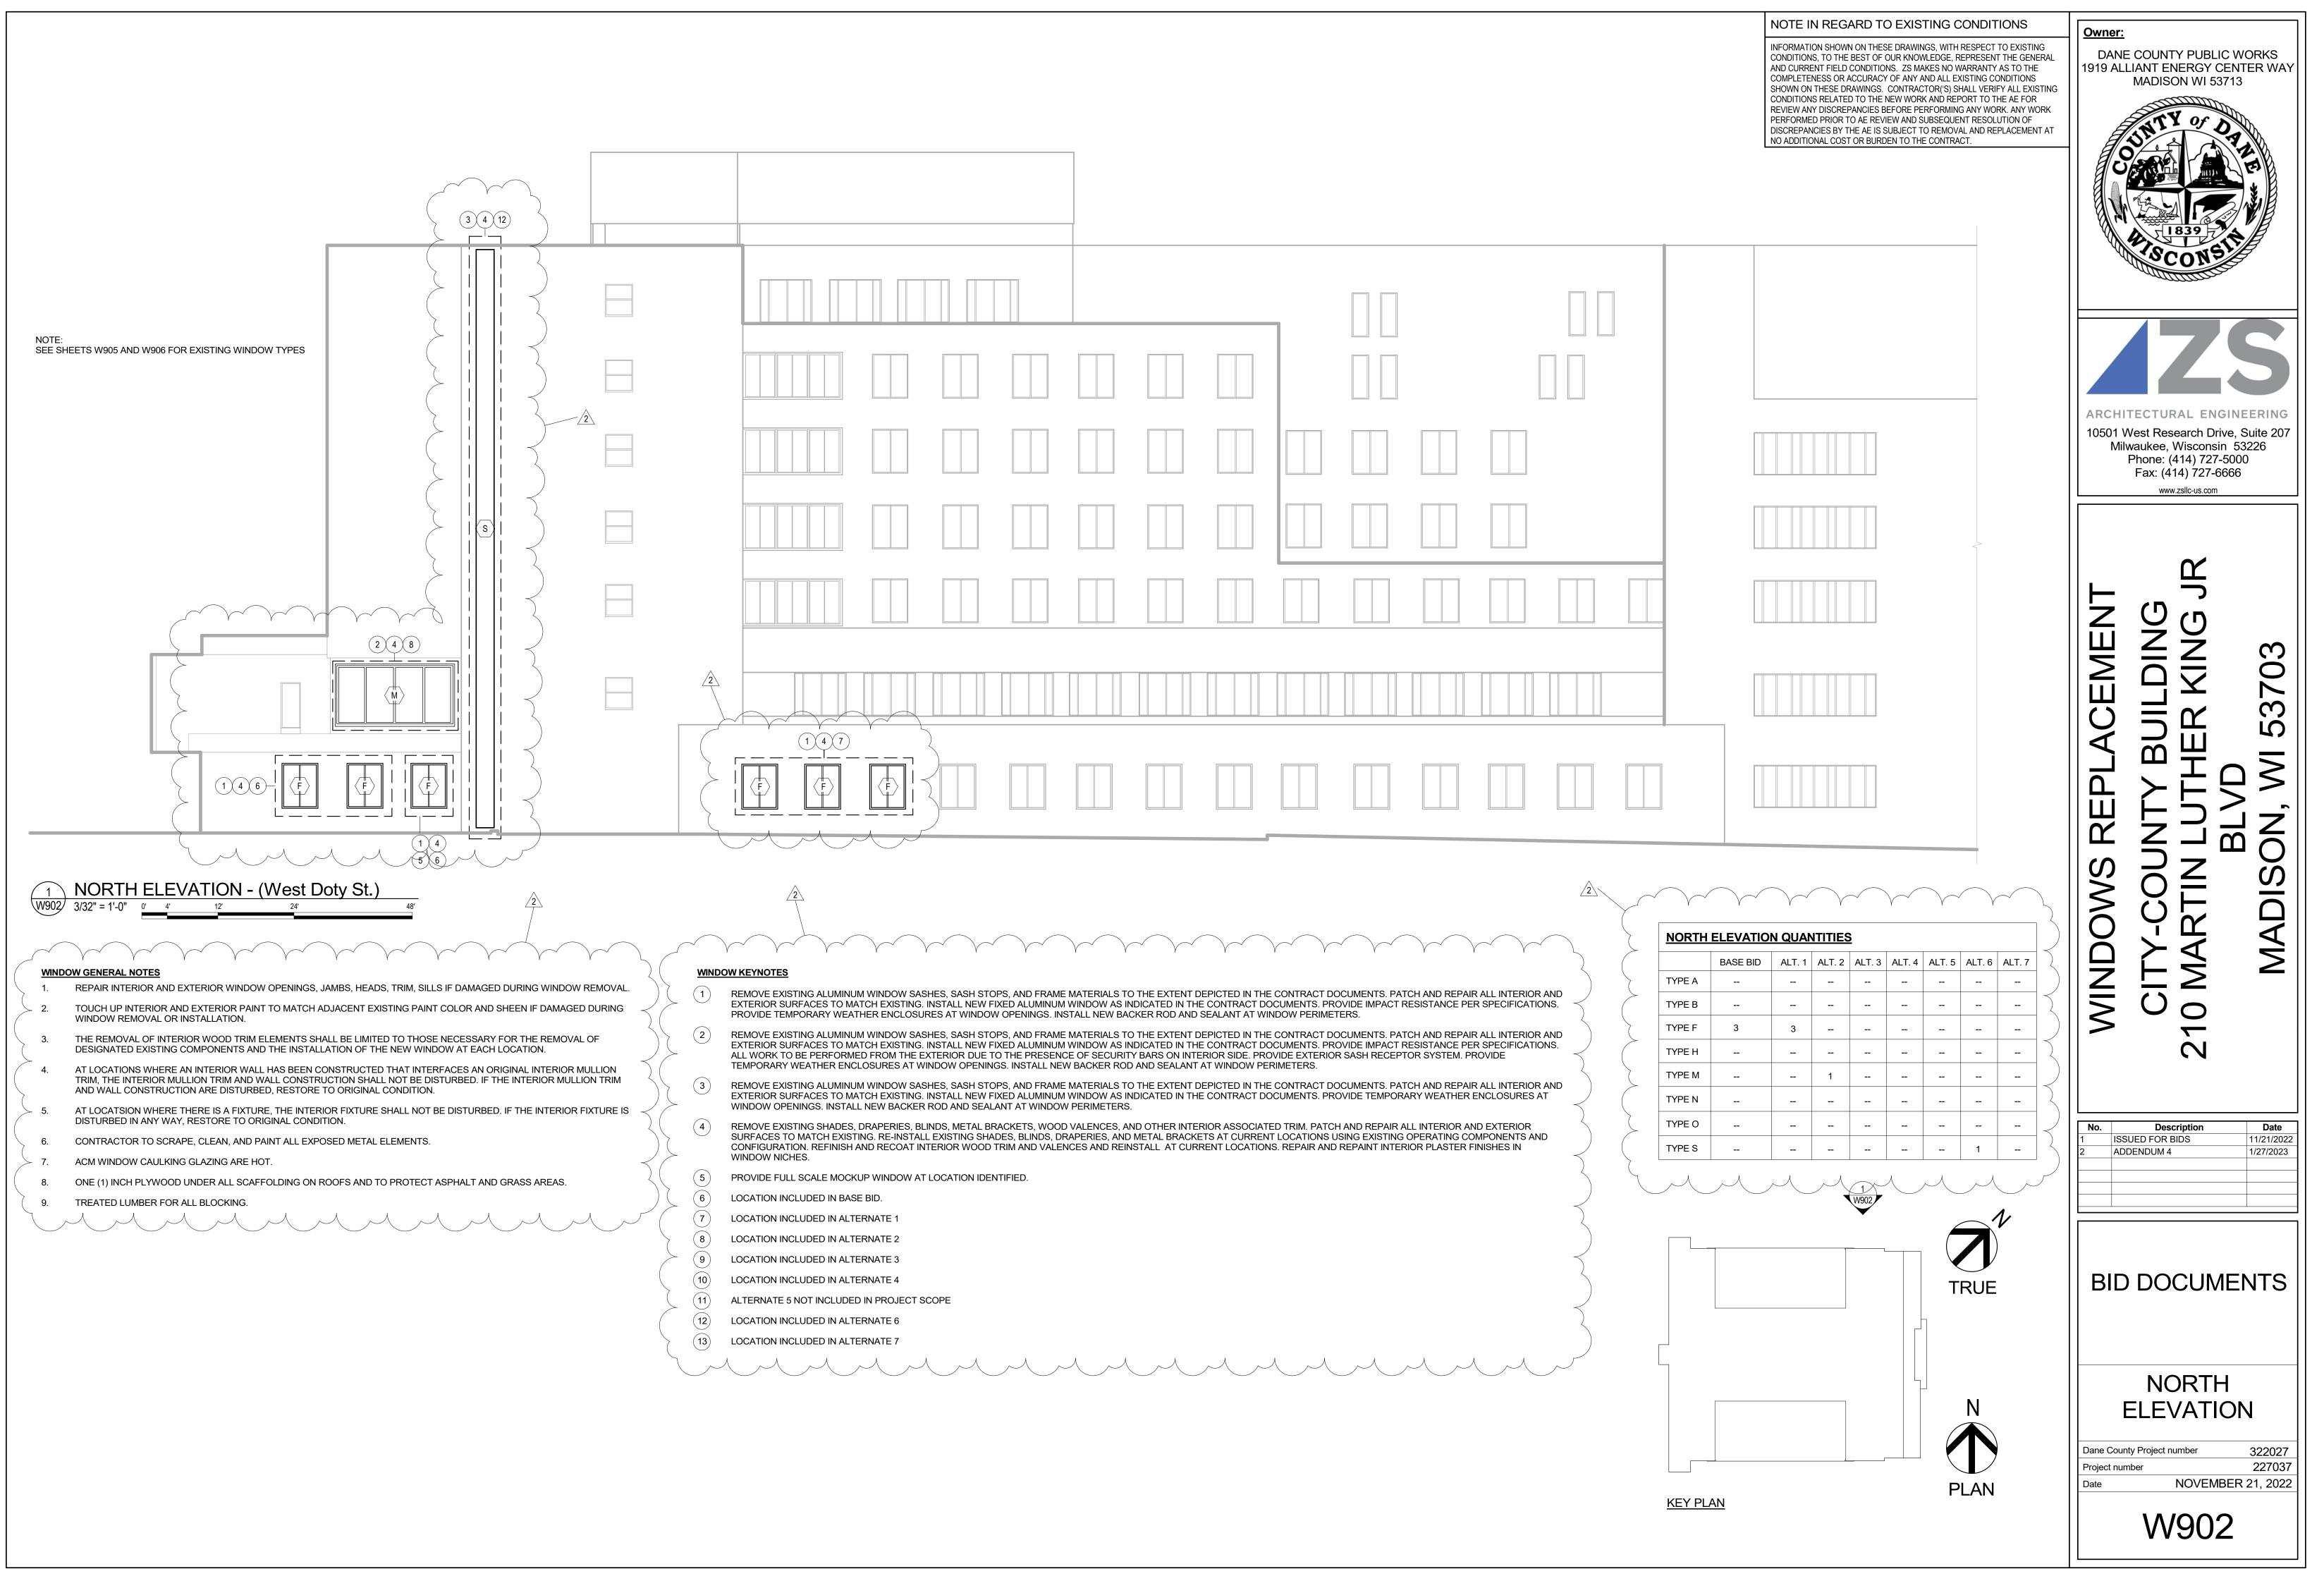1 SOUTH ELEV 3/32" = 1'-0" 0' 4'	ATION - (West Wilso	on St.)	48'			
				2		
TOUCH UP INTERIOR AND WINDOW REMOVAL OR IN THE REMOVAL OF INTERIO	OR WOOD TRIM ELEMENTS SHALL BE	ENT EXISTING	G PAINT COL	OR AND SHEEN	I IF DAMAGED D HE REMOVAL C	
AT LOCATIONS WHERE AN TRIM, THE INTERIOR MULL AND WALL CONSTRUCTIO	OMPONENTS AND THE INSTALLATION N INTERIOR WALL HAS BEEN CONSTR LION TRIM AND WALL CONSTRUCTION IN ARE DISTURBED, RESTORE TO OR HERE IS A FIXTURE, THE INTERIOR FIX	RUCTED THA N SHALL NO <sup>T</sup> RIGINAL CONI	t interfac be distur dition.	es an origina Bed. If the int	L INTERIOR MUI ERIOR MULLION	3
DISTURBED IN ANY WAY, F	RESTORE TO ORIGINAL CONDITION. E, CLEAN, AND PAINT ALL EXPOSED N					
	INDER ALL SCAFFOLDING ON ROOFS		DTECT ASPH	IALT AND GRAS	S AREAS.	$\begin{pmatrix} (5) \\ 6 \\ 7 \end{pmatrix}$
ONE (1) INCH PLYWOOD U						




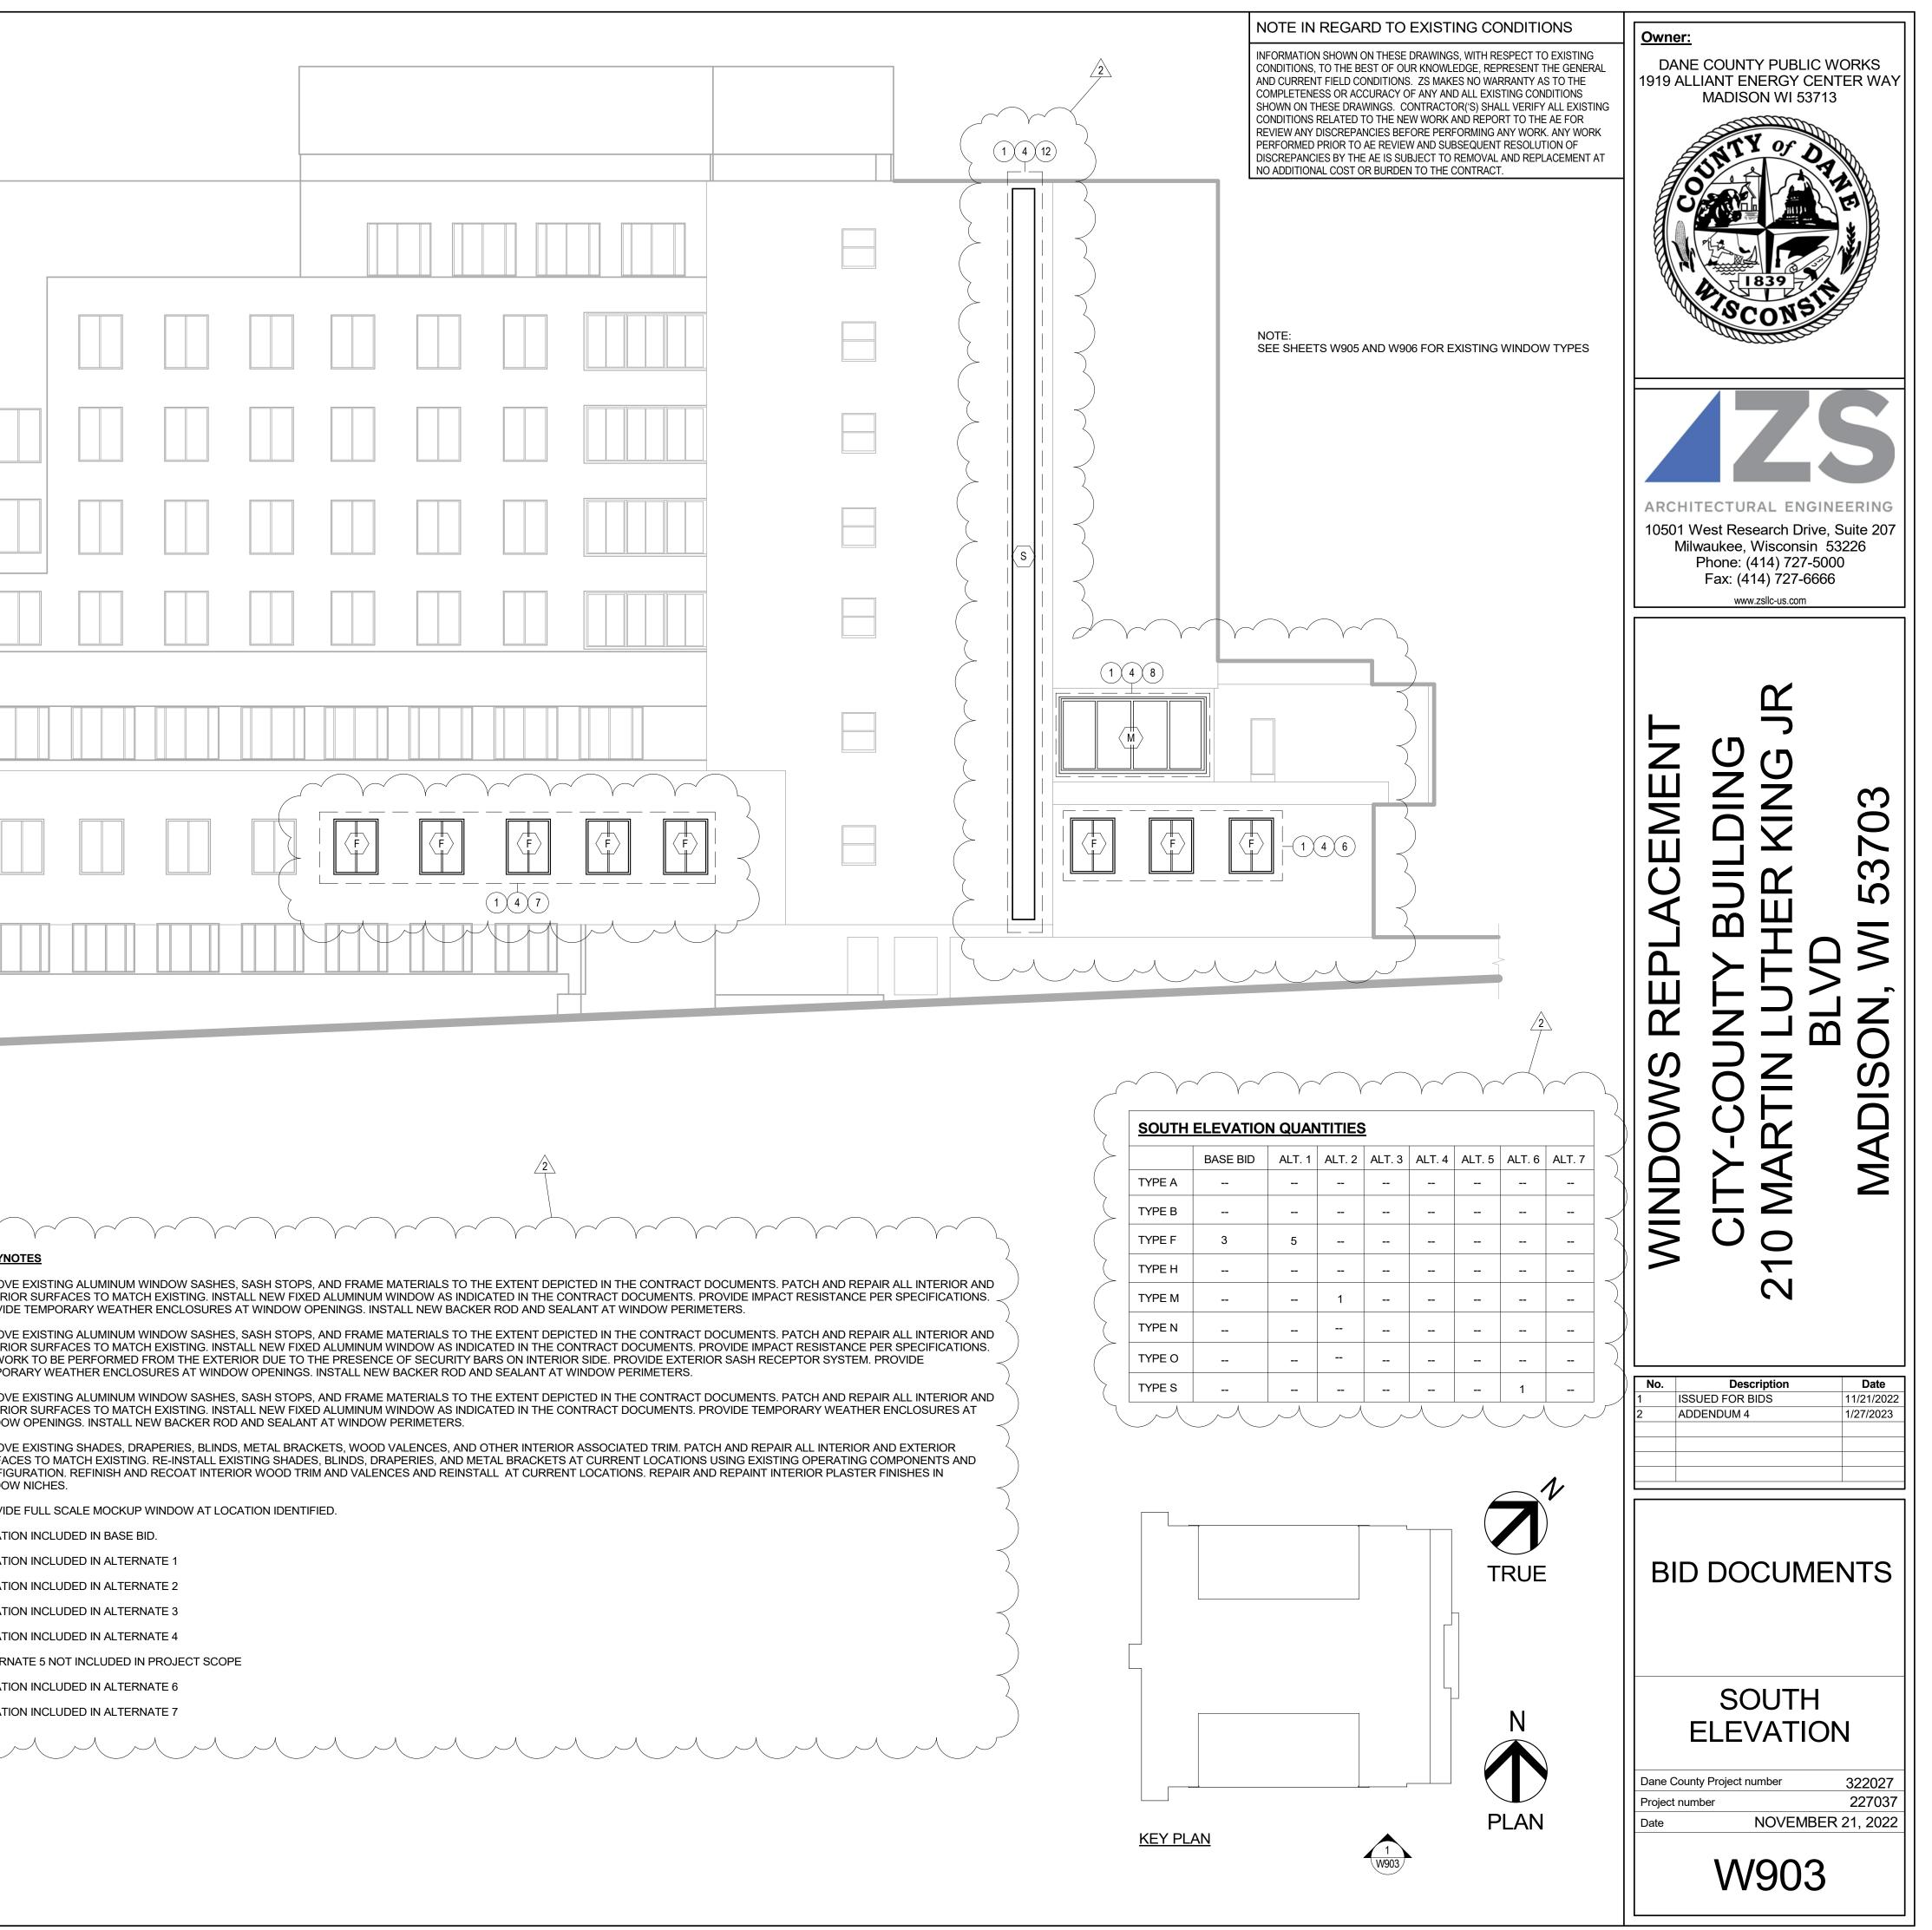


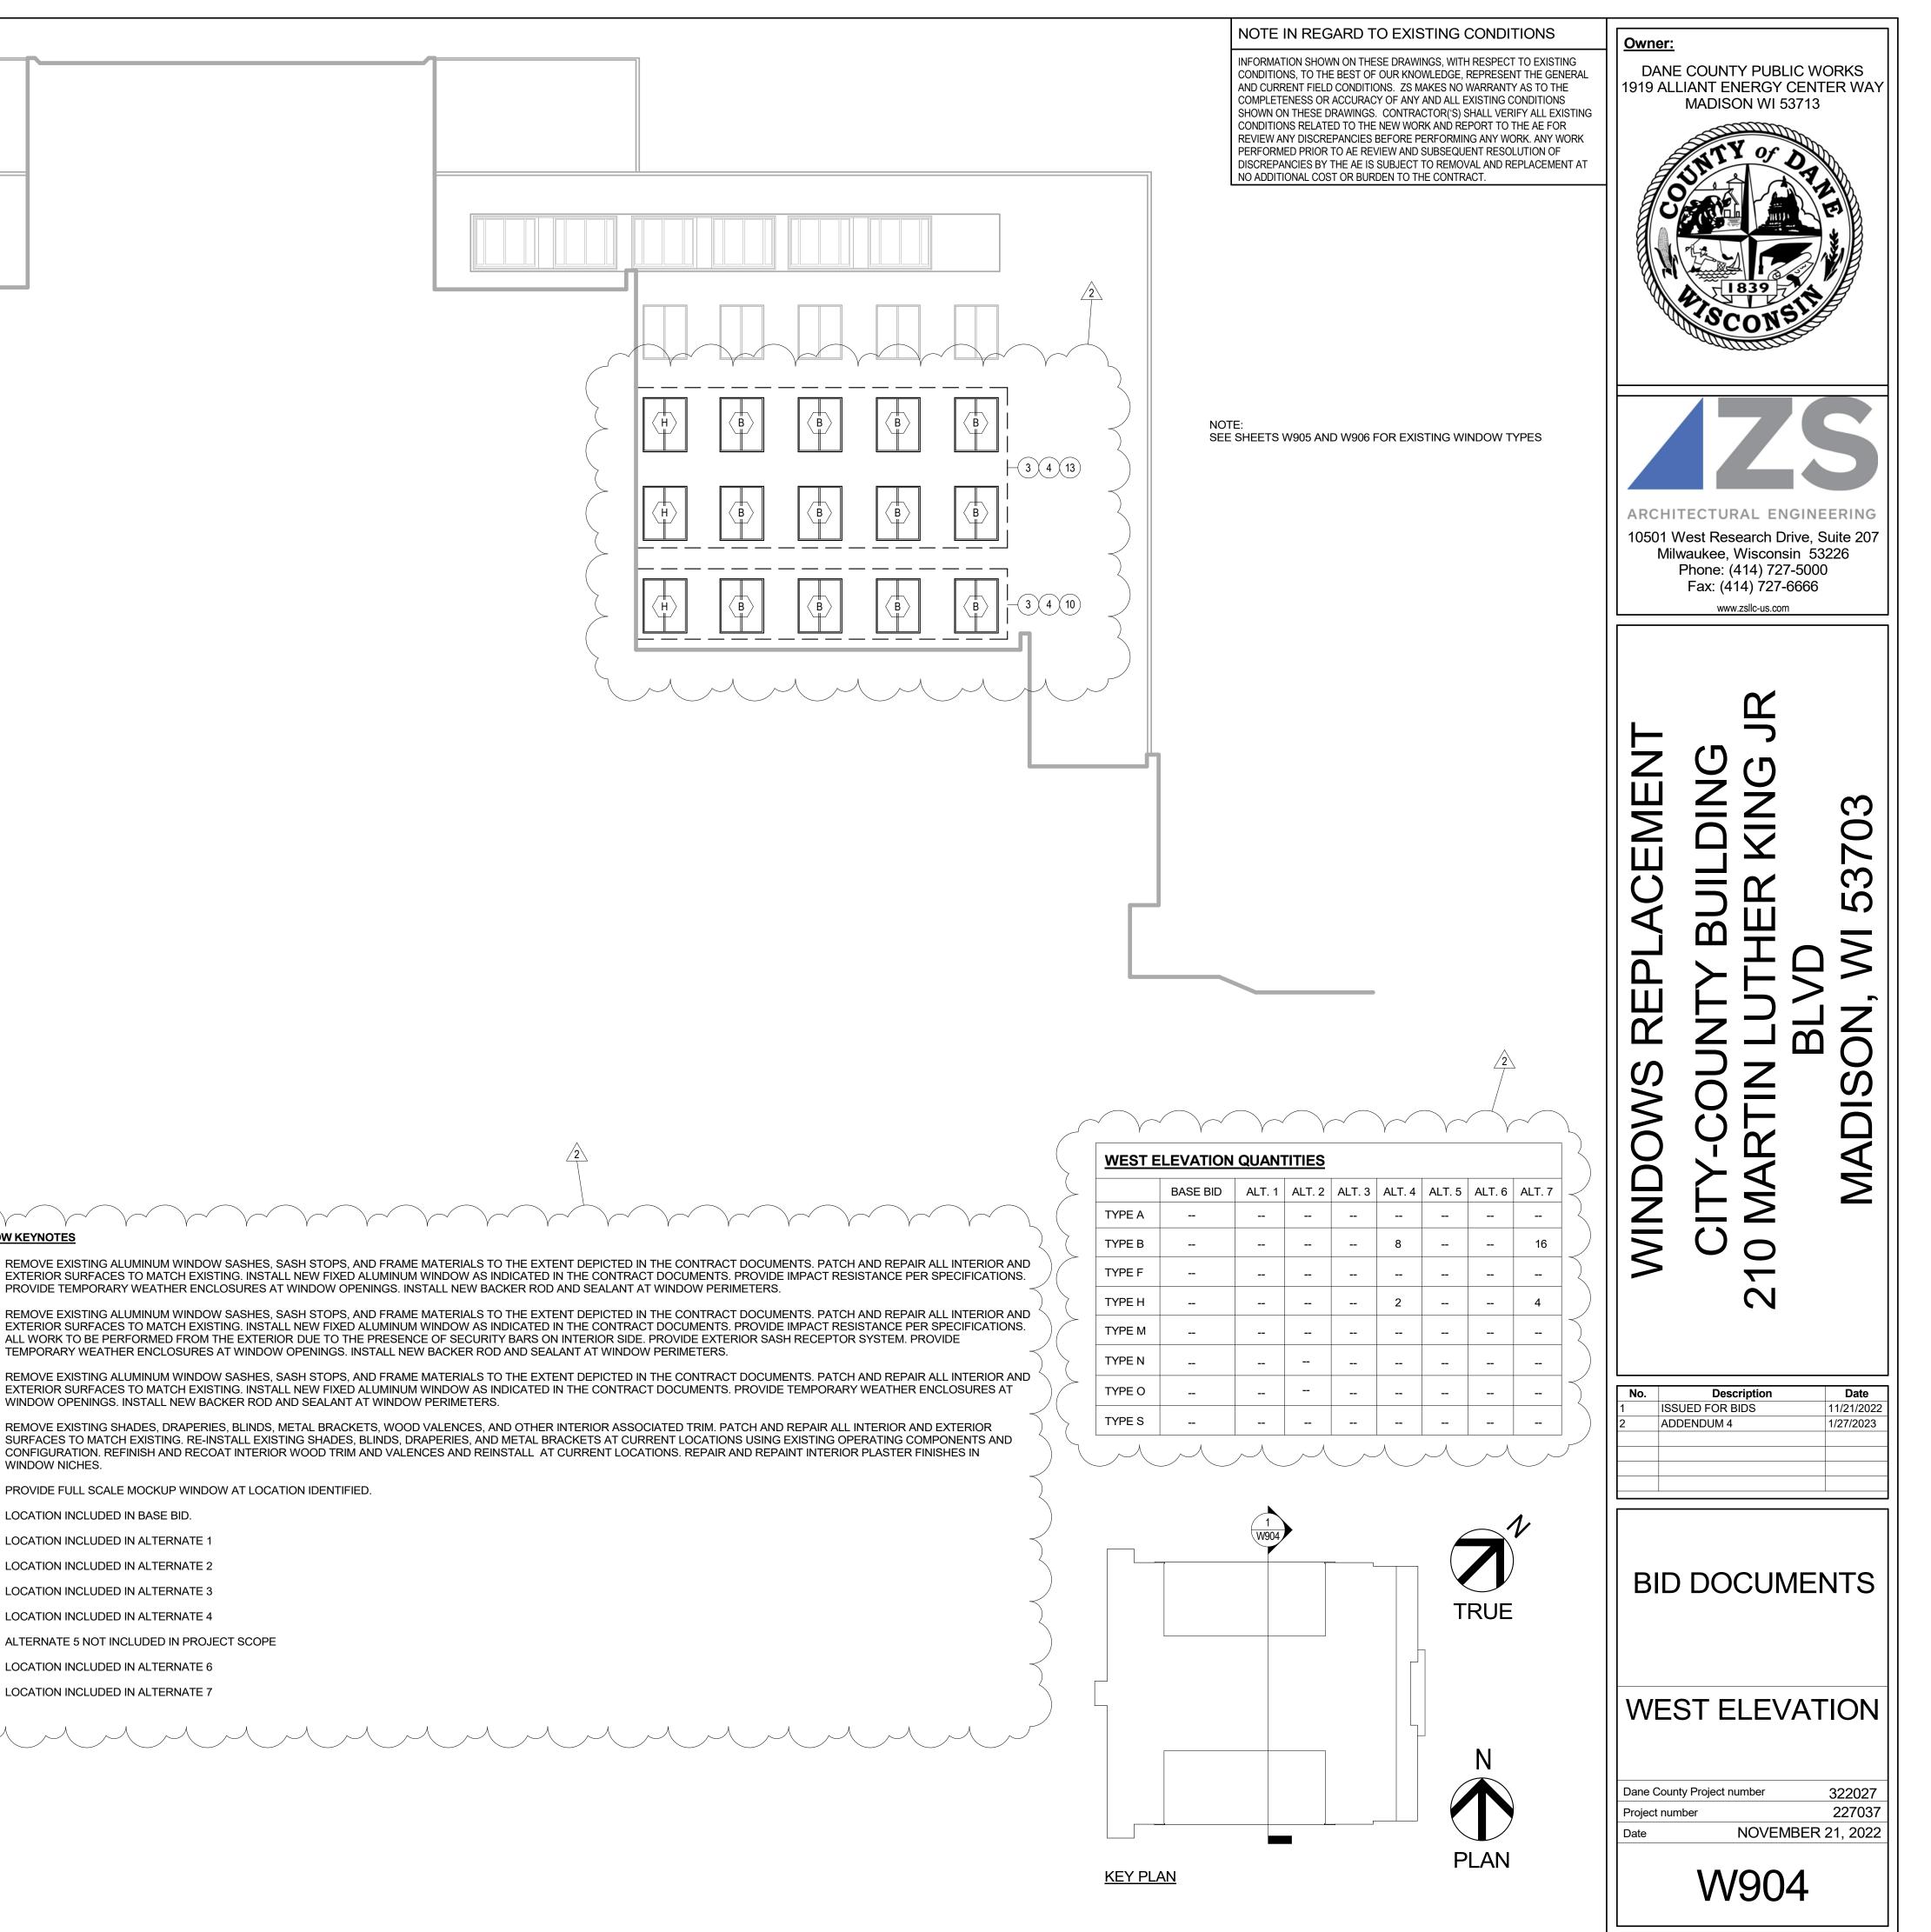



### WINDOW KEYNOTES


- EXTERIOR SURFACES TO MATCH EXISTING. INSTALL NEW FIXED ALUMINUM WINDOW AS INDICATED IN THE CONTRACT DOCUMENTS. PROVIDE IMPACT RESISTANCE PER SPECIFICATIONS. PROVIDE TEMPORARY WEATHER ENCLOSURES AT WINDOW OPENINGS. INSTALL NEW BACKER ROD AND SEALANT AT WINDOW PERIMETERS.
- REMOVE EXISTING ALUMINUM WINDOW SASHES, SASH STOPS, AND FRAME MATERIALS TO THE EXTENT DEPICTED IN THE CONTRACT DOCUMENTS. PATCH AND REPAIR ALL INTERIOR AND EXTERIOR SURFACES TO MATCH EXISTING. INSTALL NEW FIXED ALUMINUM WINDOW AS INDICATED IN THE CONTRACT DOCUMENTS. PROVIDE IMPACT RESISTANCE PER SPECIFICATIONS. ALL WORK TO BE PERFORMED FROM THE EXTERIOR DUE TO THE PRESENCE OF SECURITY BARS ON INTERIOR SIDE. PROVIDE EXTERIOR SASH RECEPTOR SYSTEM. PROVIDE TEMPORARY WEATHER ENCLOSURES AT WINDOW OPENINGS. INSTALL NEW BACKER ROD AND SEALANT AT WINDOW PERIMETERS.
- REMOVE EXISTING ALUMINUM WINDOW SASHES, SASH STOPS, AND FRAME MATERIALS TO THE EXTENT DEPICTED IN THE CONTRACT DOCUMENTS. PATCH AND REPAIR ALL INTERIOR AND EXTERIOR SURFACES TO MATCH EXISTING. INSTALL NEW FIXED ALUMINUM WINDOW AS INDICATED IN THE CONTRACT DOCUMENTS. PROVIDE TEMPORARY WEATHER ENCLOSURES AT WINDOW OPENINGS. INSTALL NEW BACKER ROD AND SEALANT AT WINDOW PERIMETERS.
- REMOVE EXISTING SHADES, DRAPERIES, BLINDS, METAL BRACKETS, WOOD VALENCES, AND OTHER INTERIOR ASSOCIATED TRIM. PATCH AND REPAIR ALL INTERIOR AND EXTERIOR SURFACES TO MATCH EXISTING. RE-INSTALL EXISTING SHADES, BLINDS, DRAPERIES, AND METAL BRACKETS AT CURRENT LOCATIONS USING EXISTING OPERATING COMPONENTS AND CONFIGURATION. REFINISH AND RECOAT INTERIOR WOOD TRIM AND VALENCES AND REINSTALL AT CURRENT LOCATIONS. REPAIR AND REPAINT INTERIOR PLASTER FINISHES IN WINDOW NICHES.
- PROVIDE FULL SCALE MOCKUP WINDOW AT LOCATION IDENTIFIED.
- LOCATION INCLUDED IN BASE BID.
- LOCATION INCLUDED IN ALTERNATE 1
- LOCATION INCLUDED IN ALTERNATE 2
- LOCATION INCLUDED IN ALTERNATE 3
- LOCATION INCLUDED IN ALTERNATE 4
- ALTERNATE 5 NOT INCLUDED IN PROJECT SCOPE
- LOCATION INCLUDED IN ALTERNATE 6
- LOCATION INCLUDED IN ALTERNATE 7

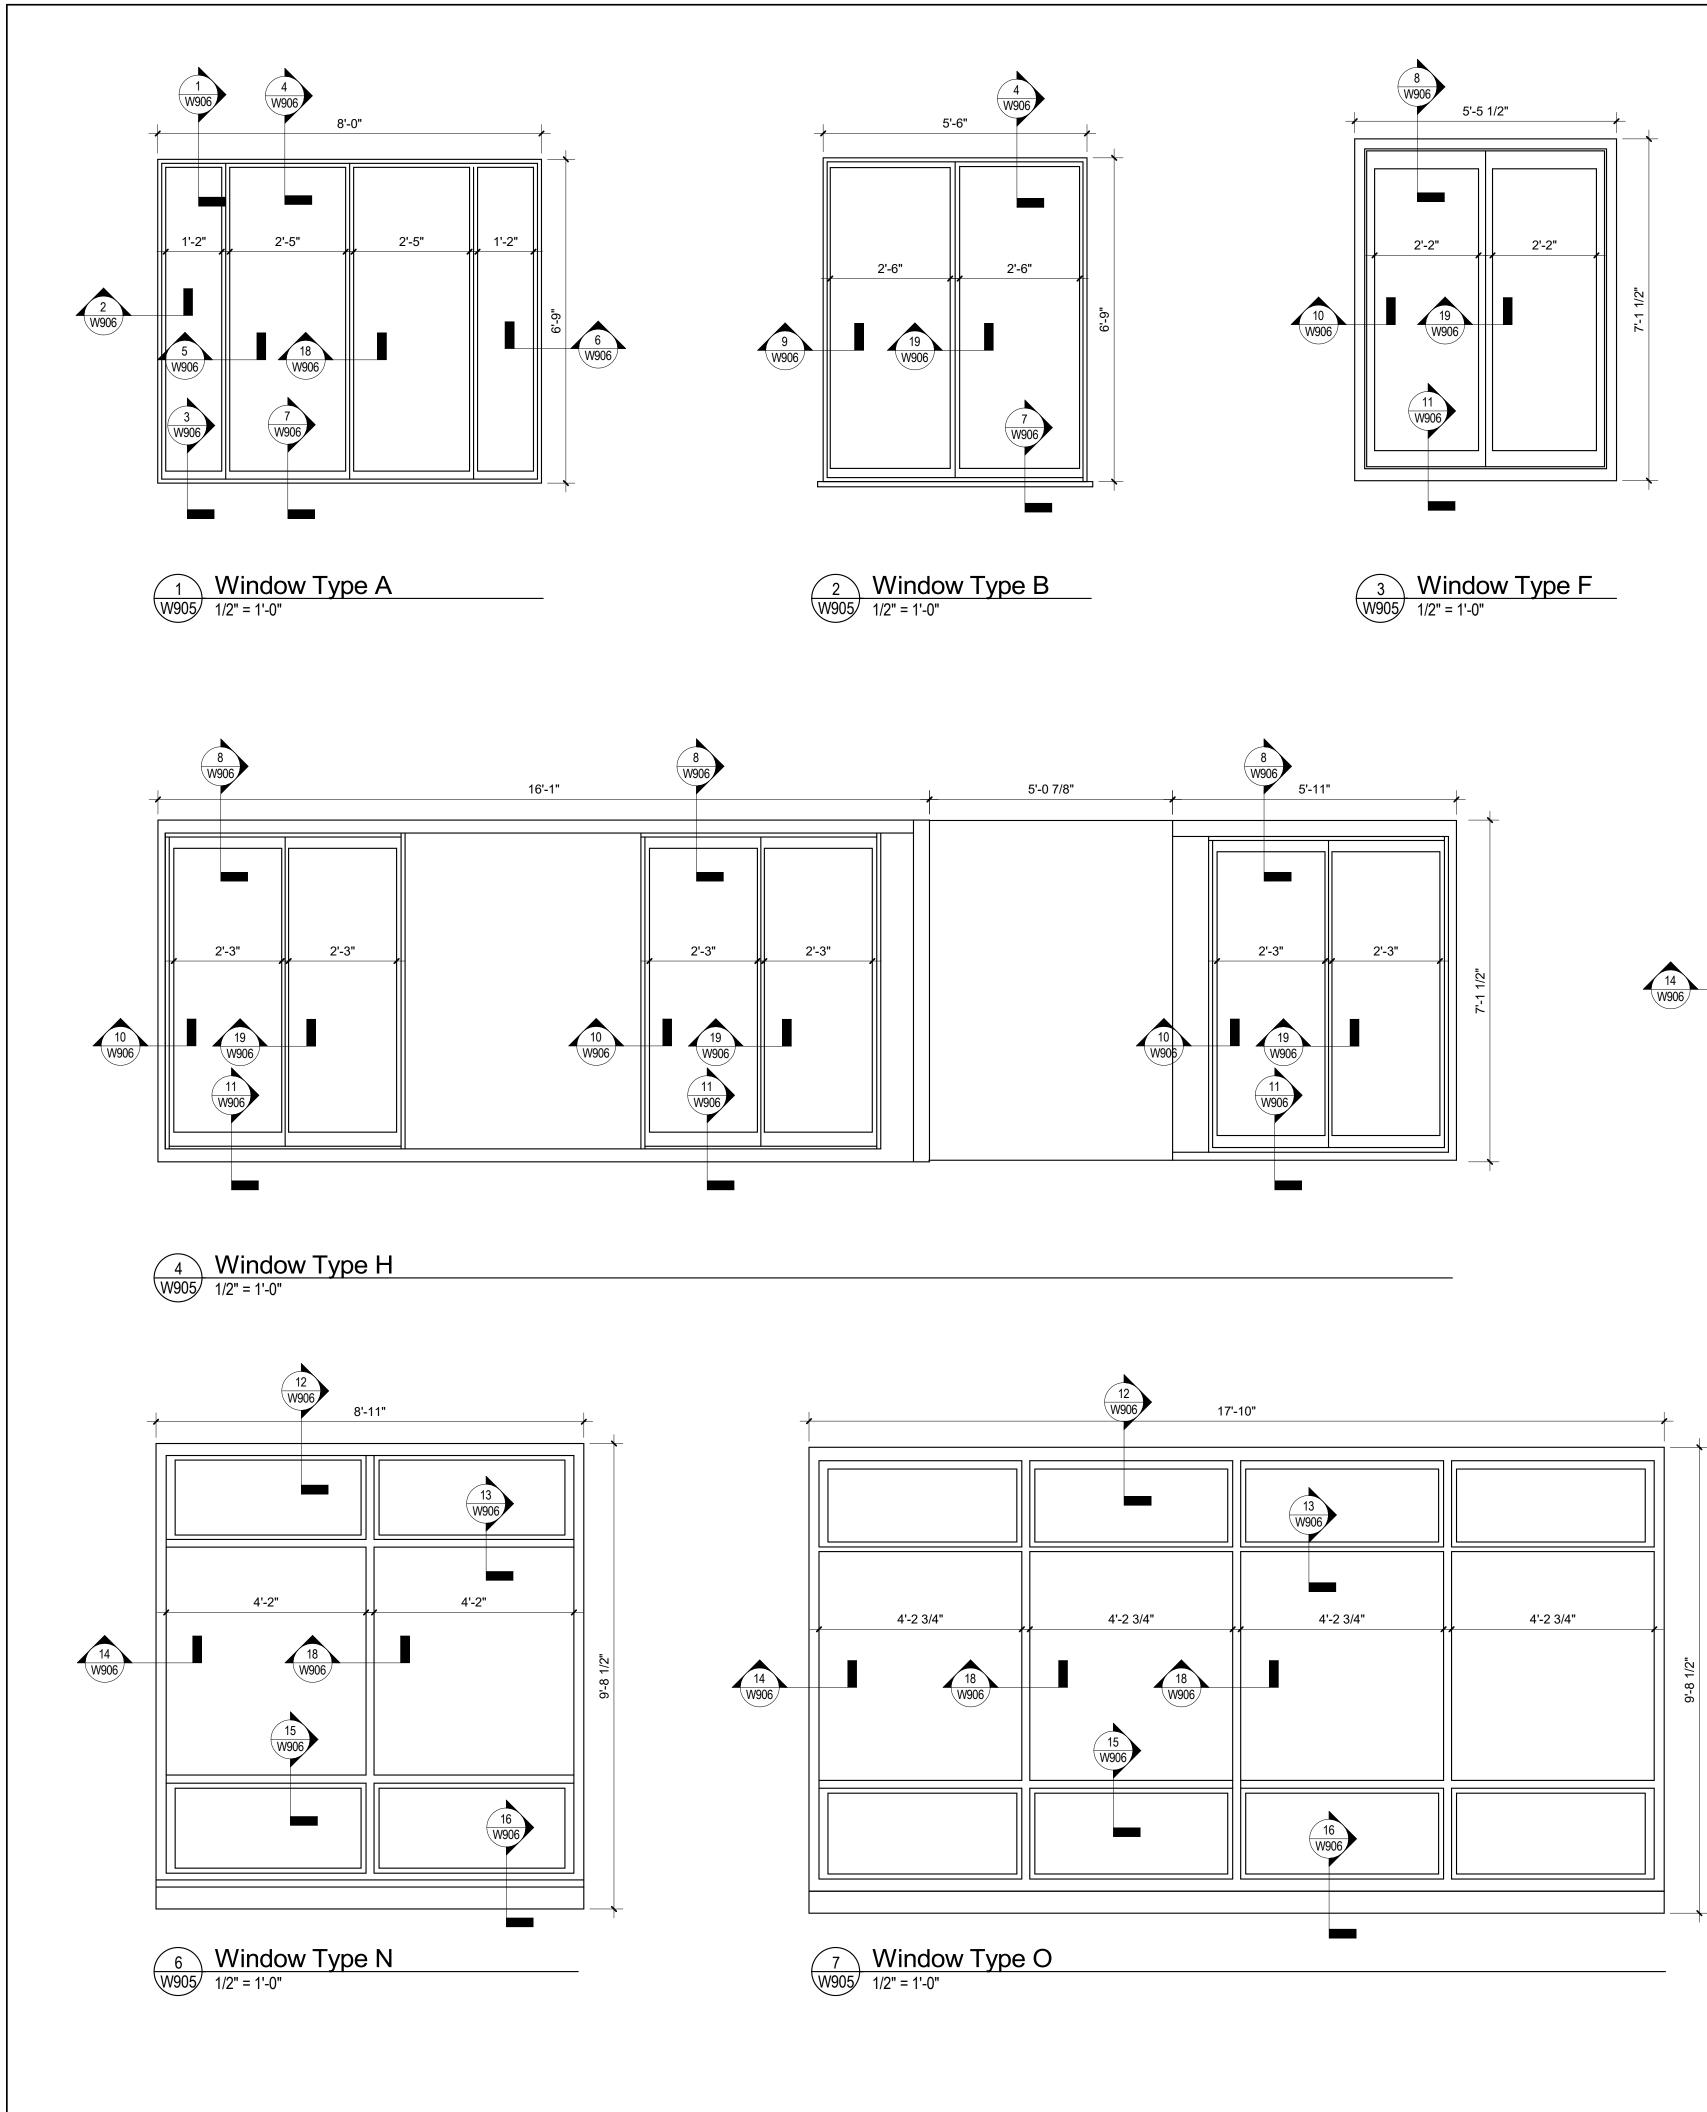

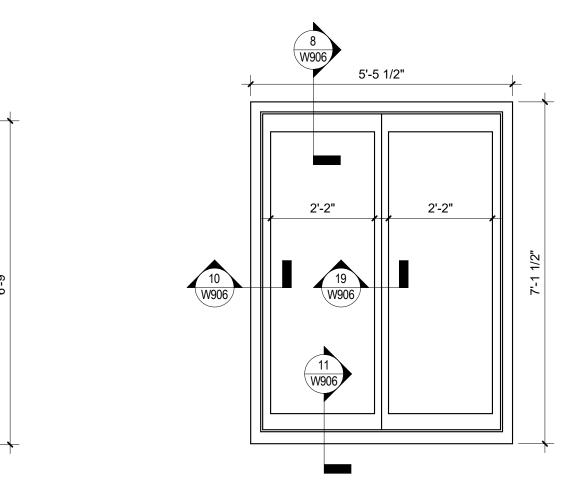


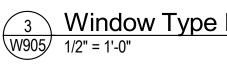


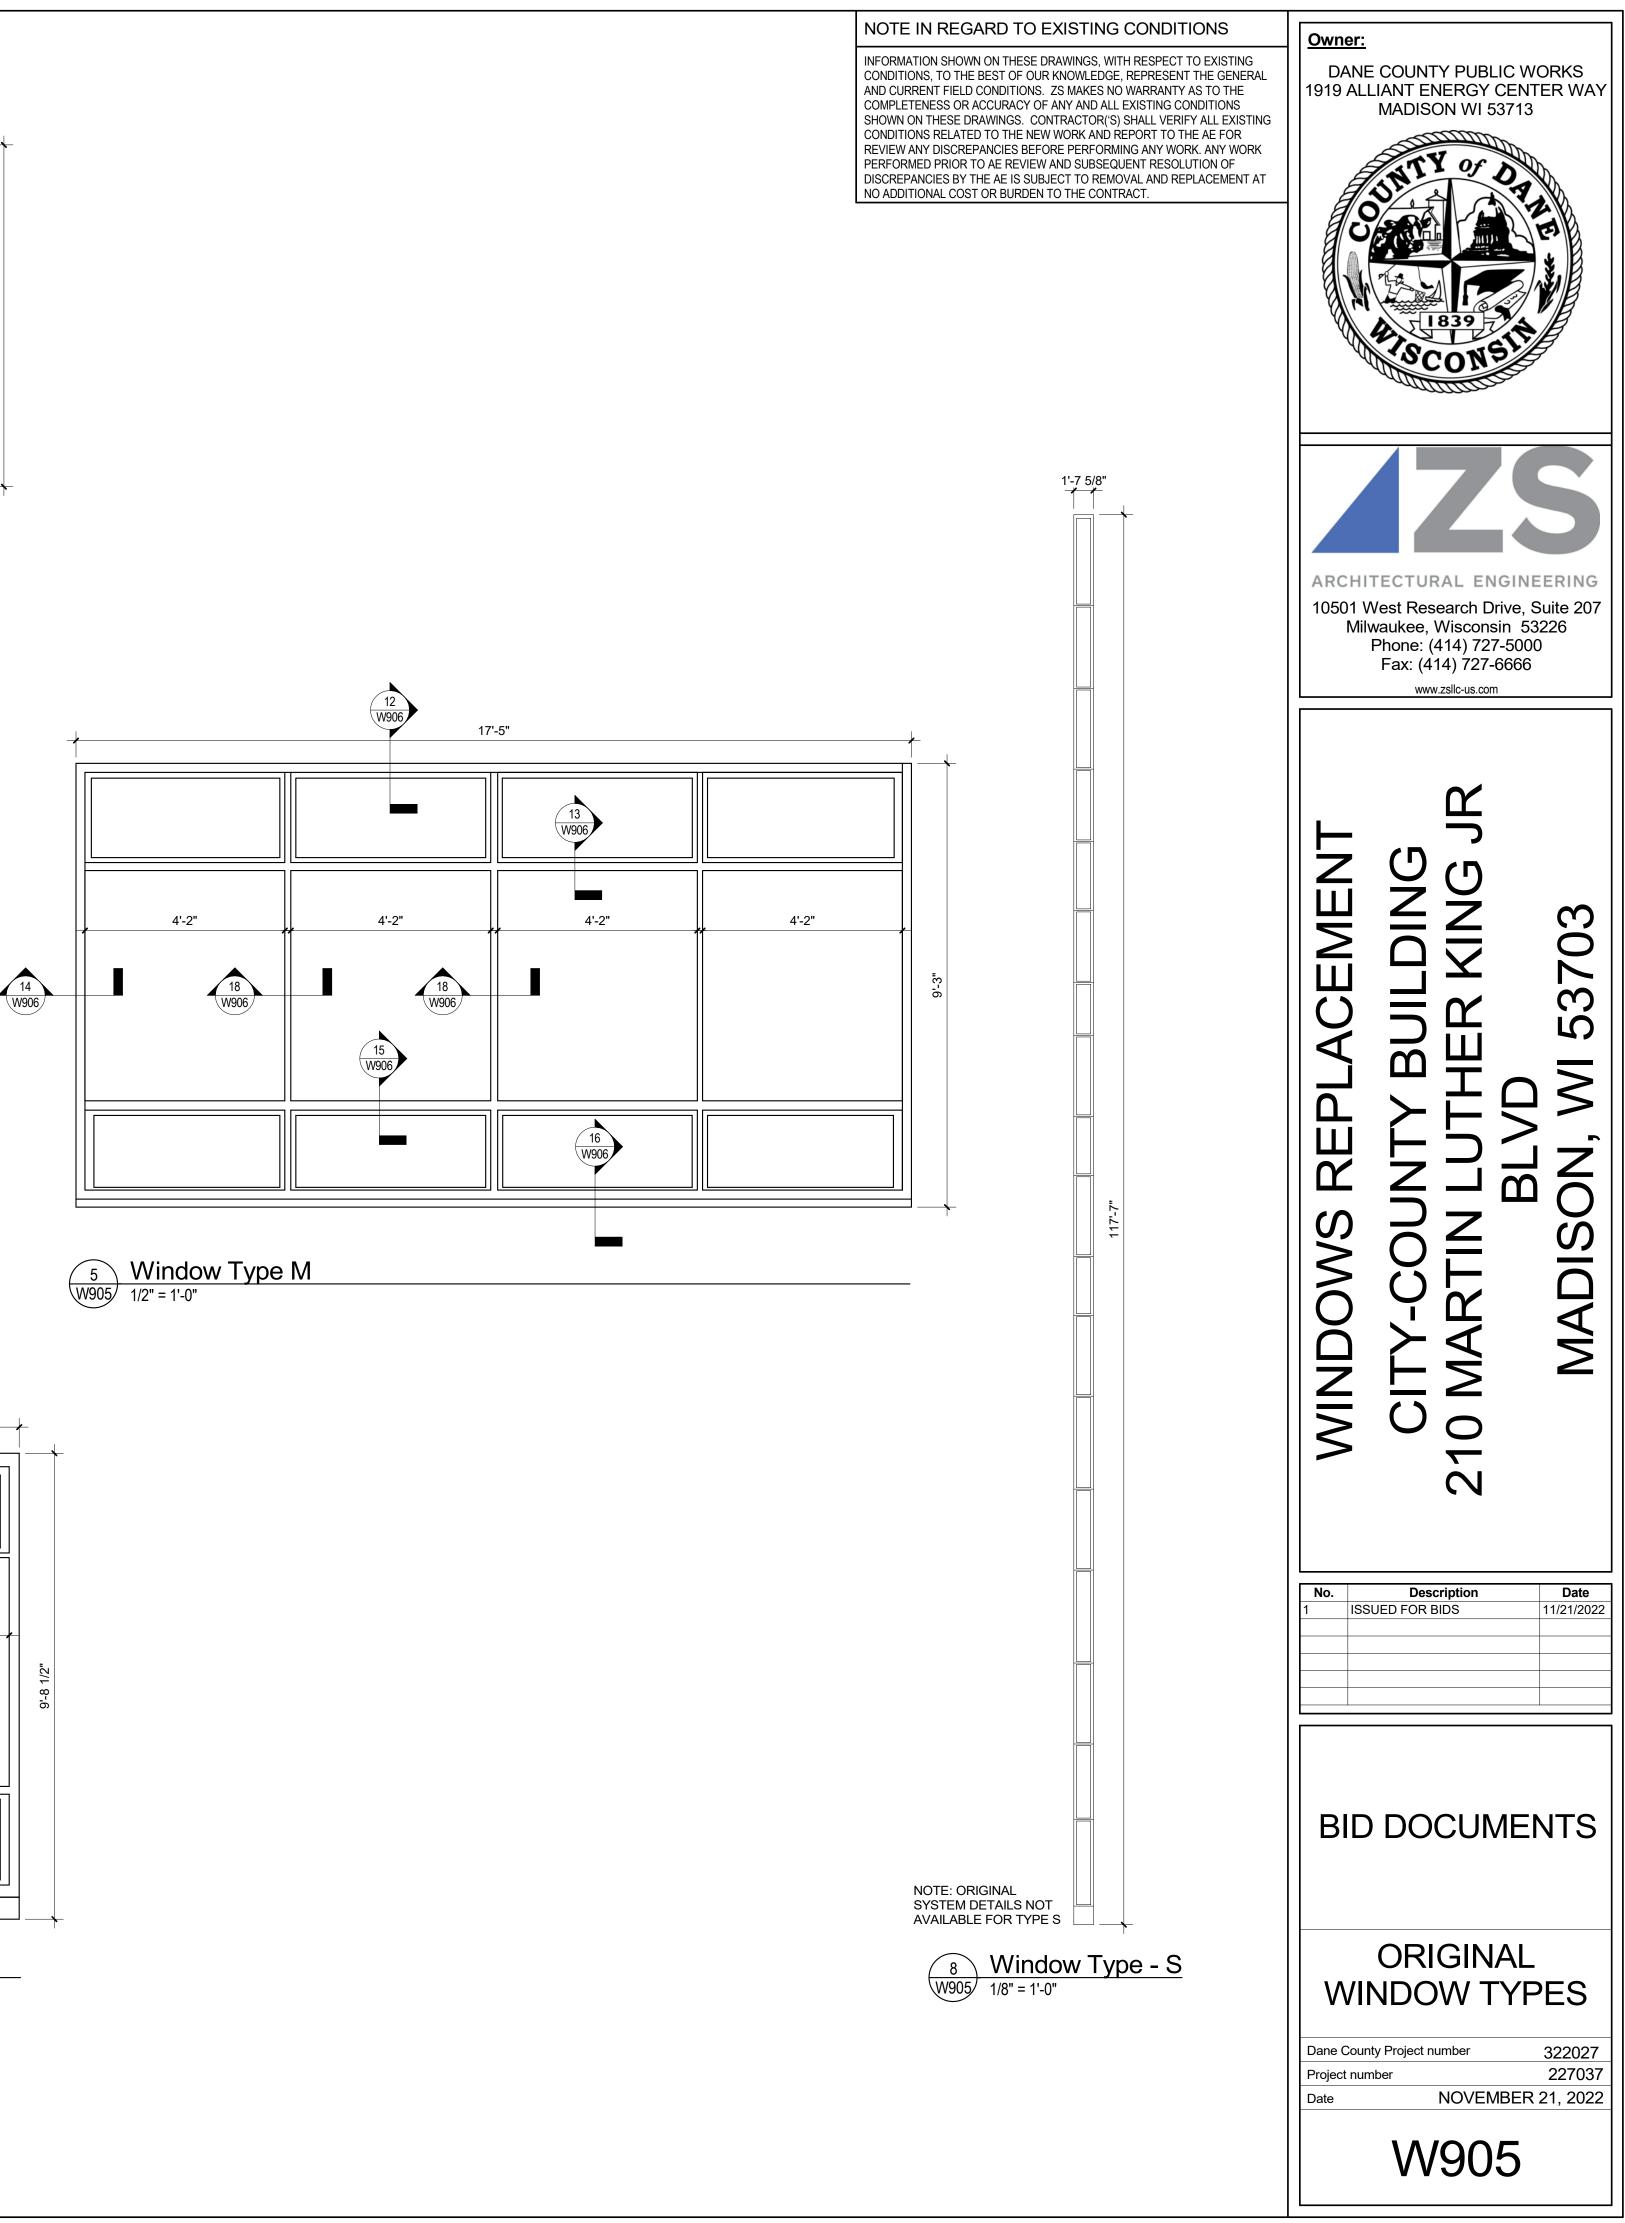


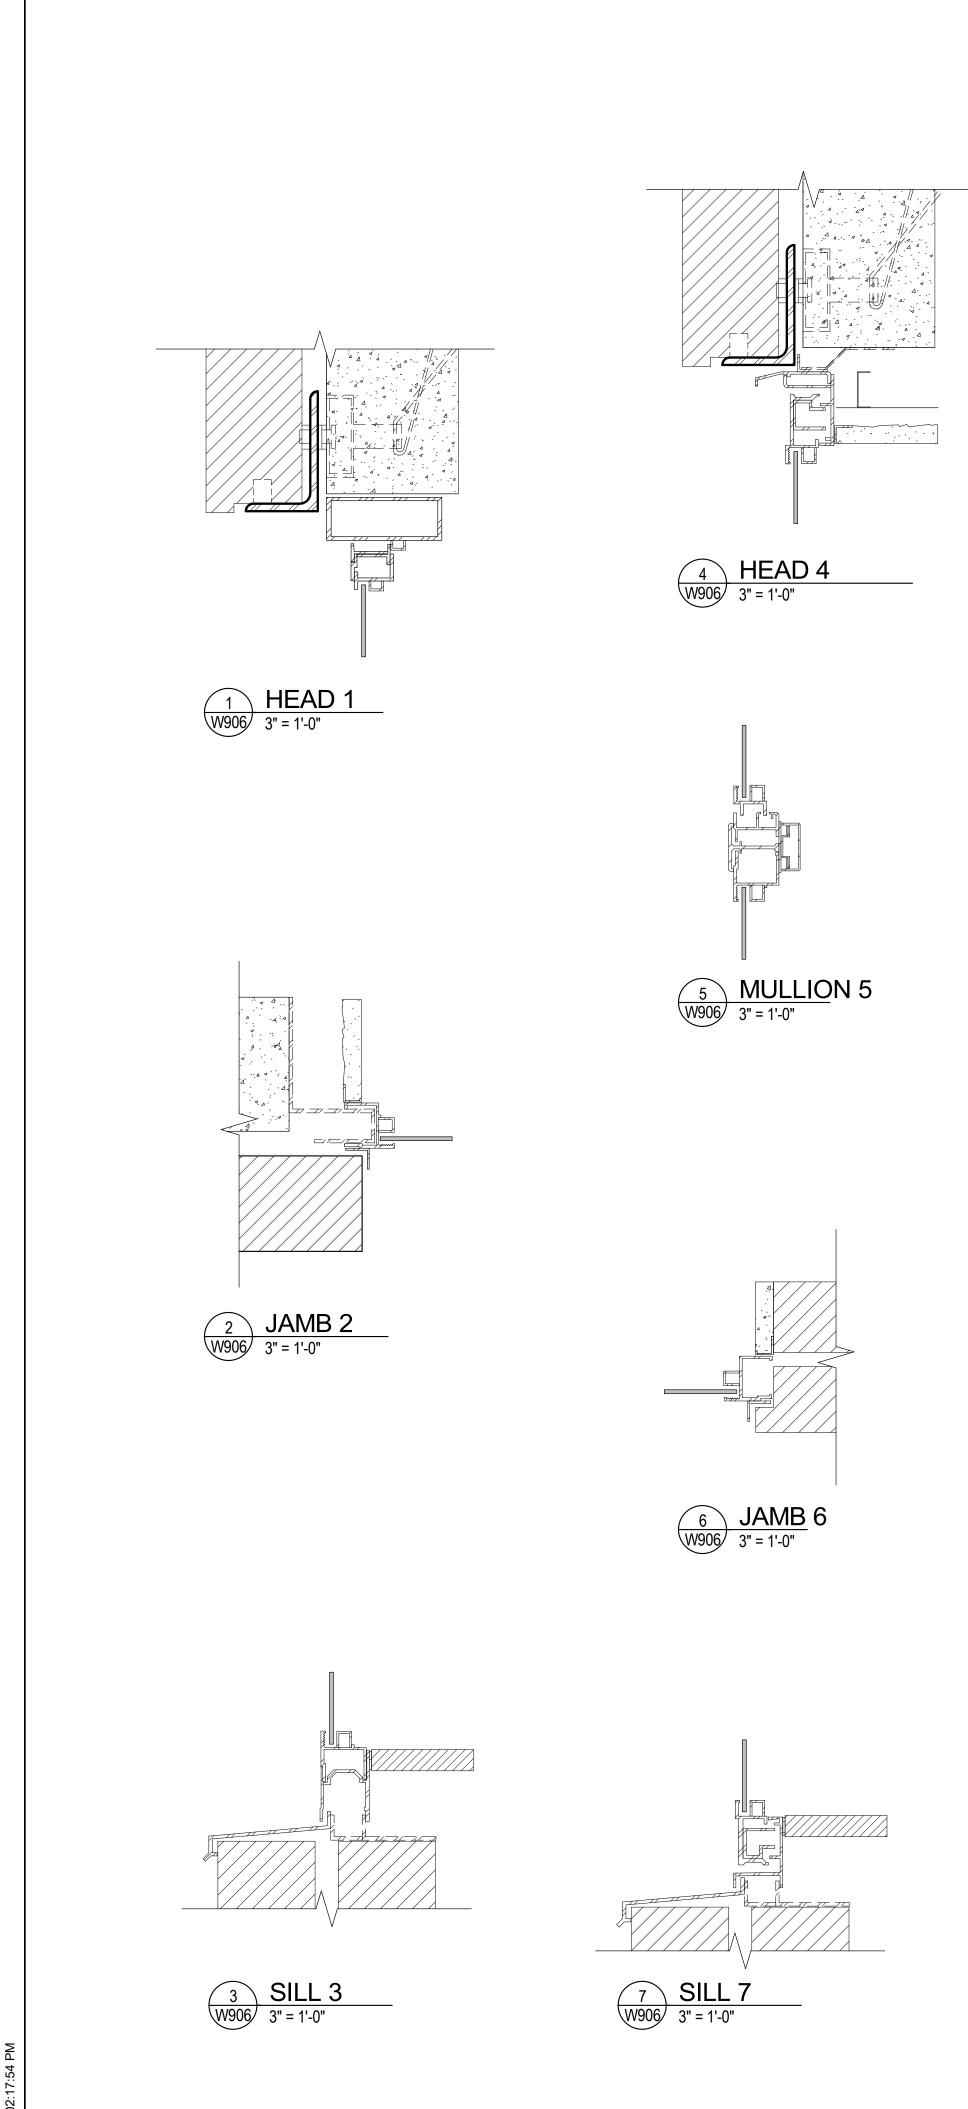



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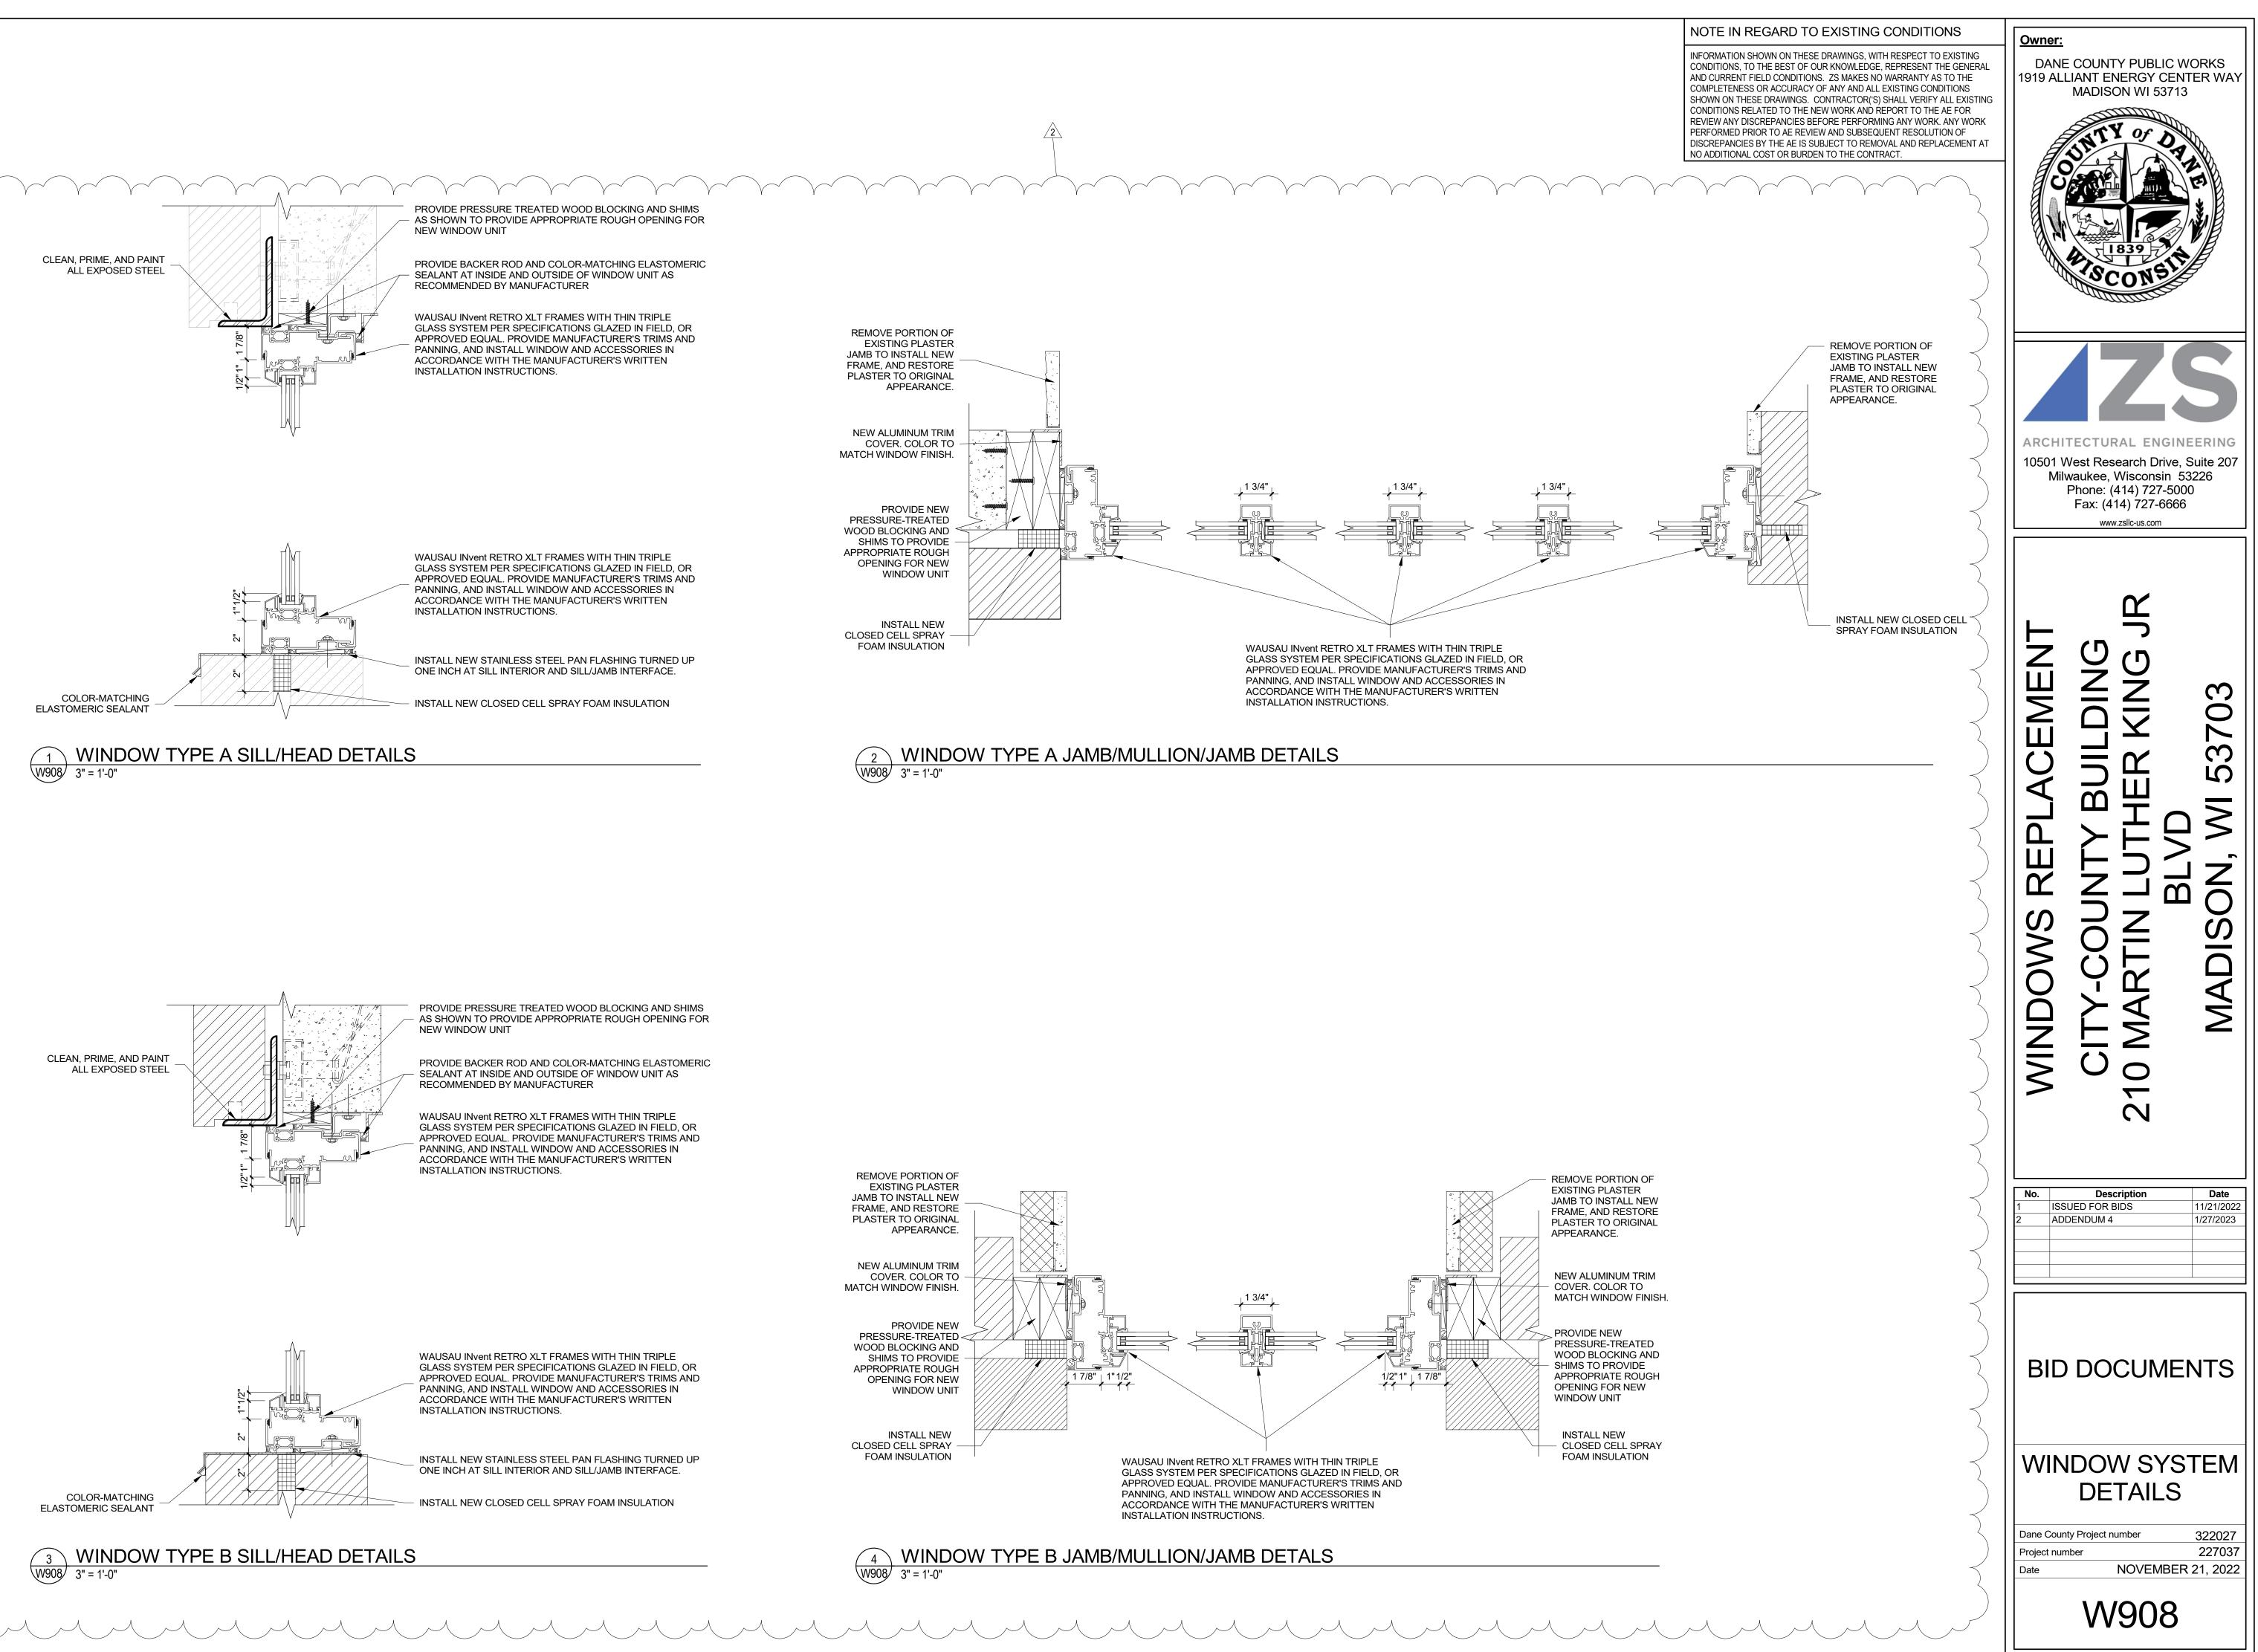


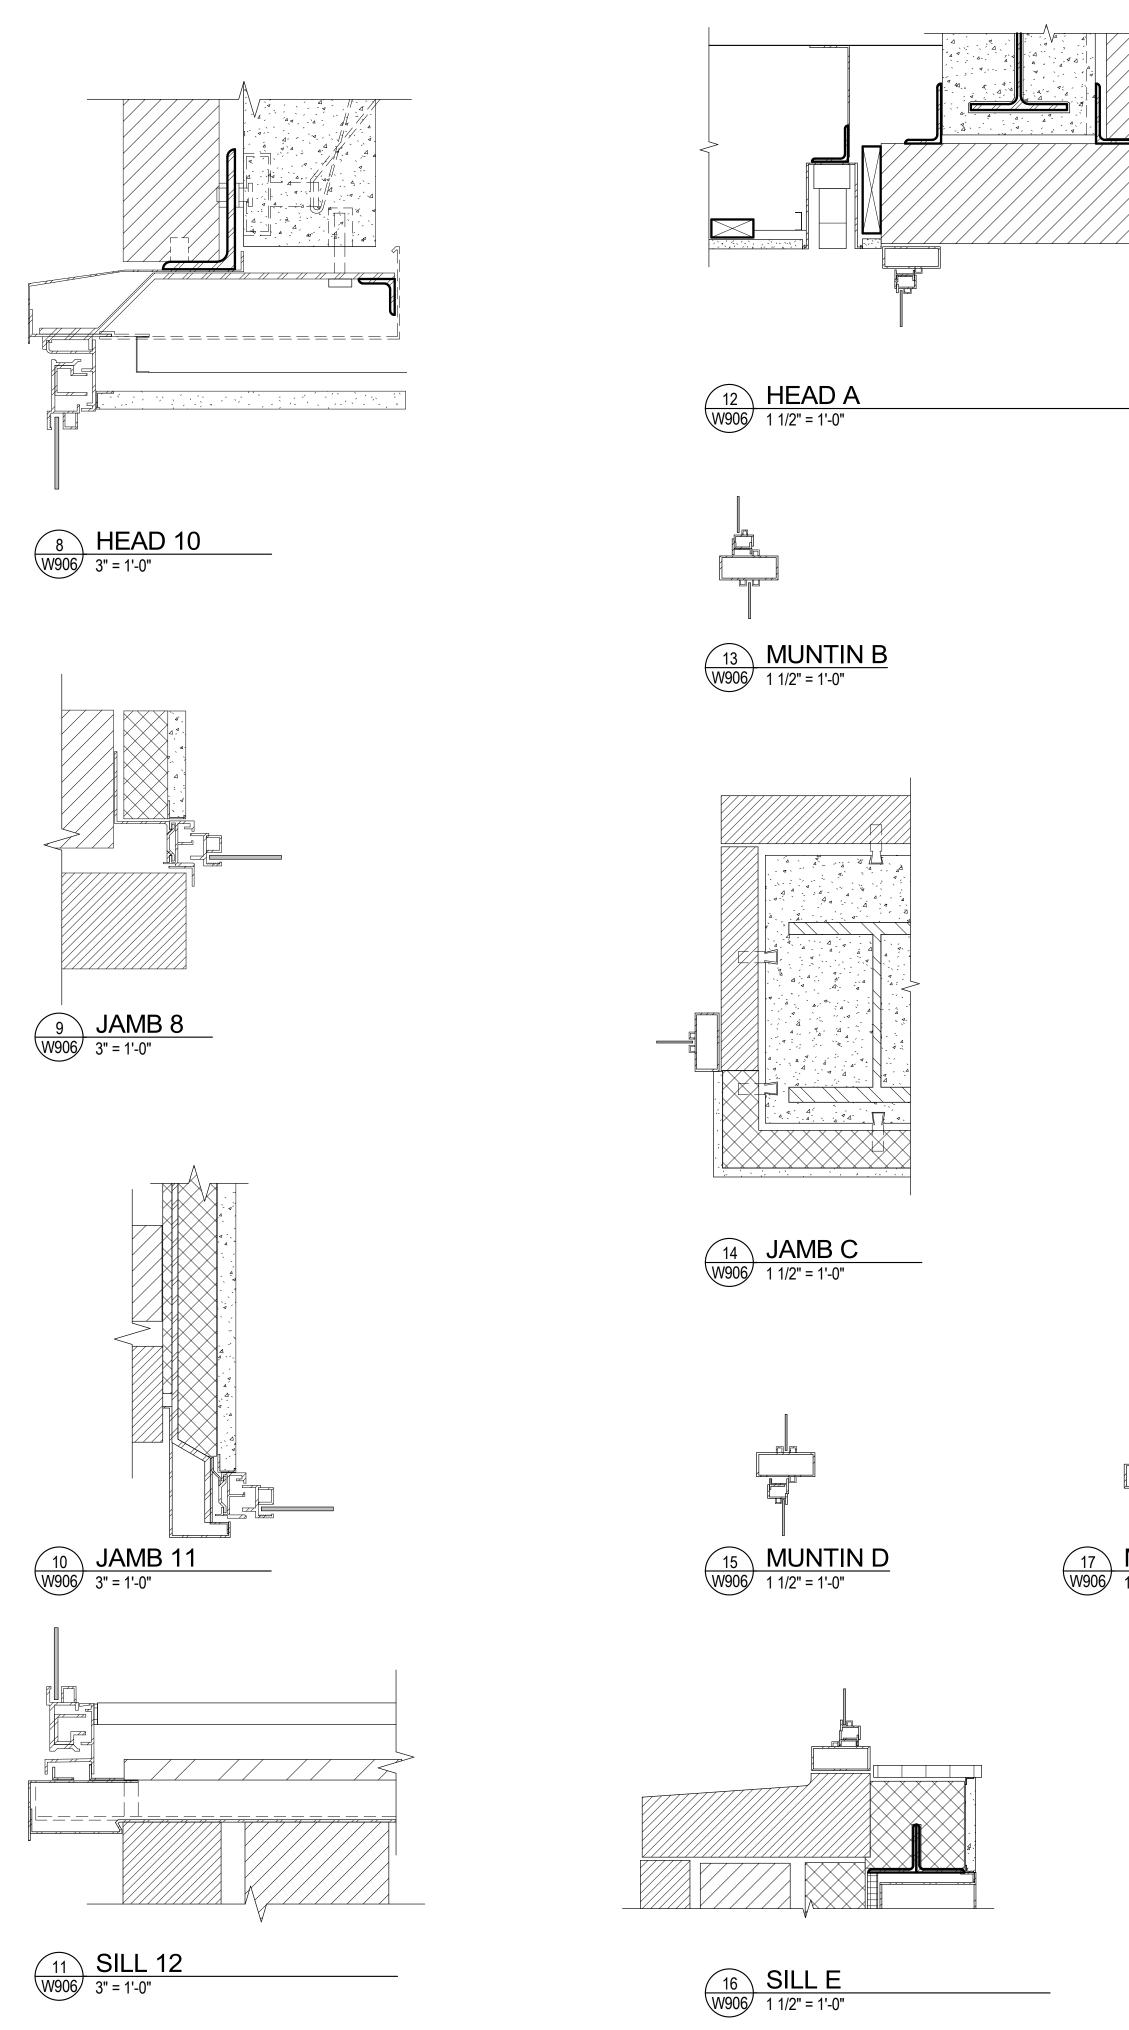

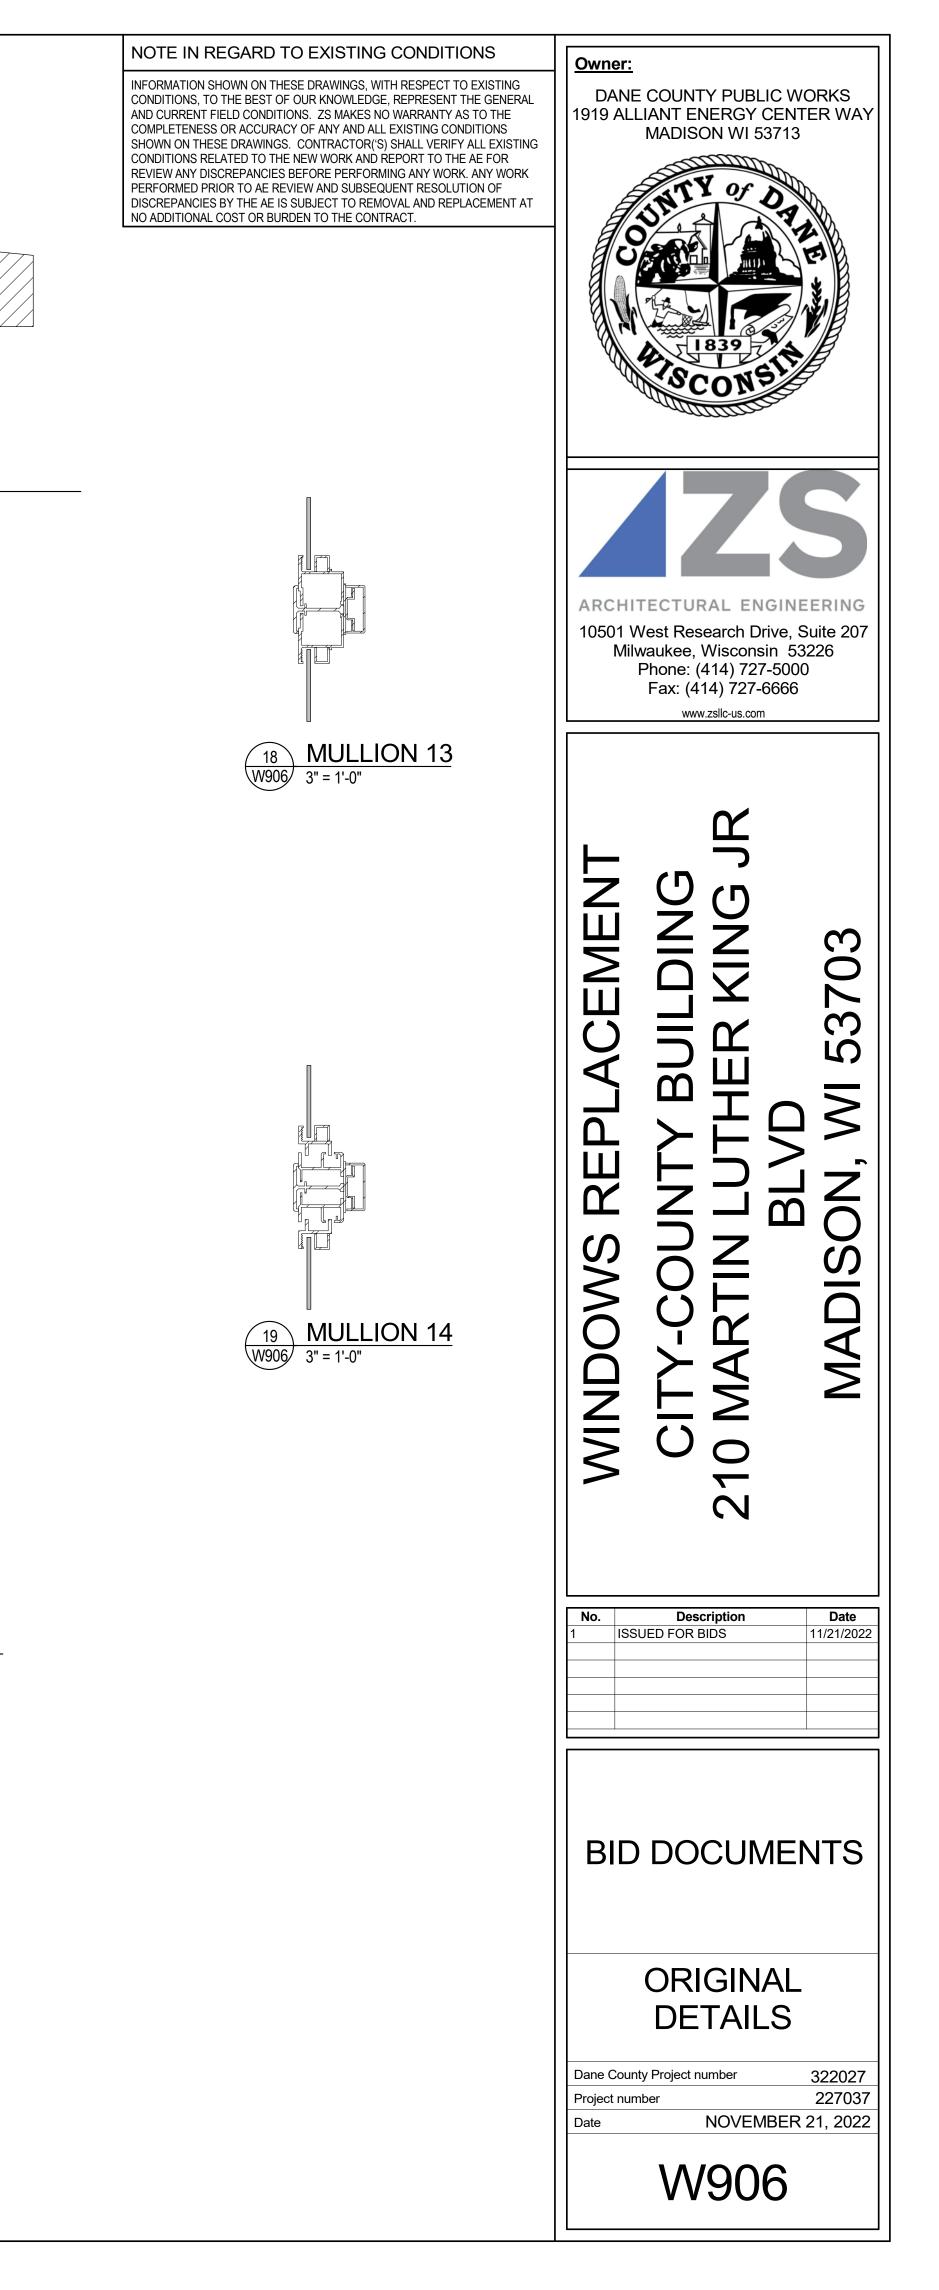


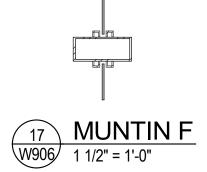


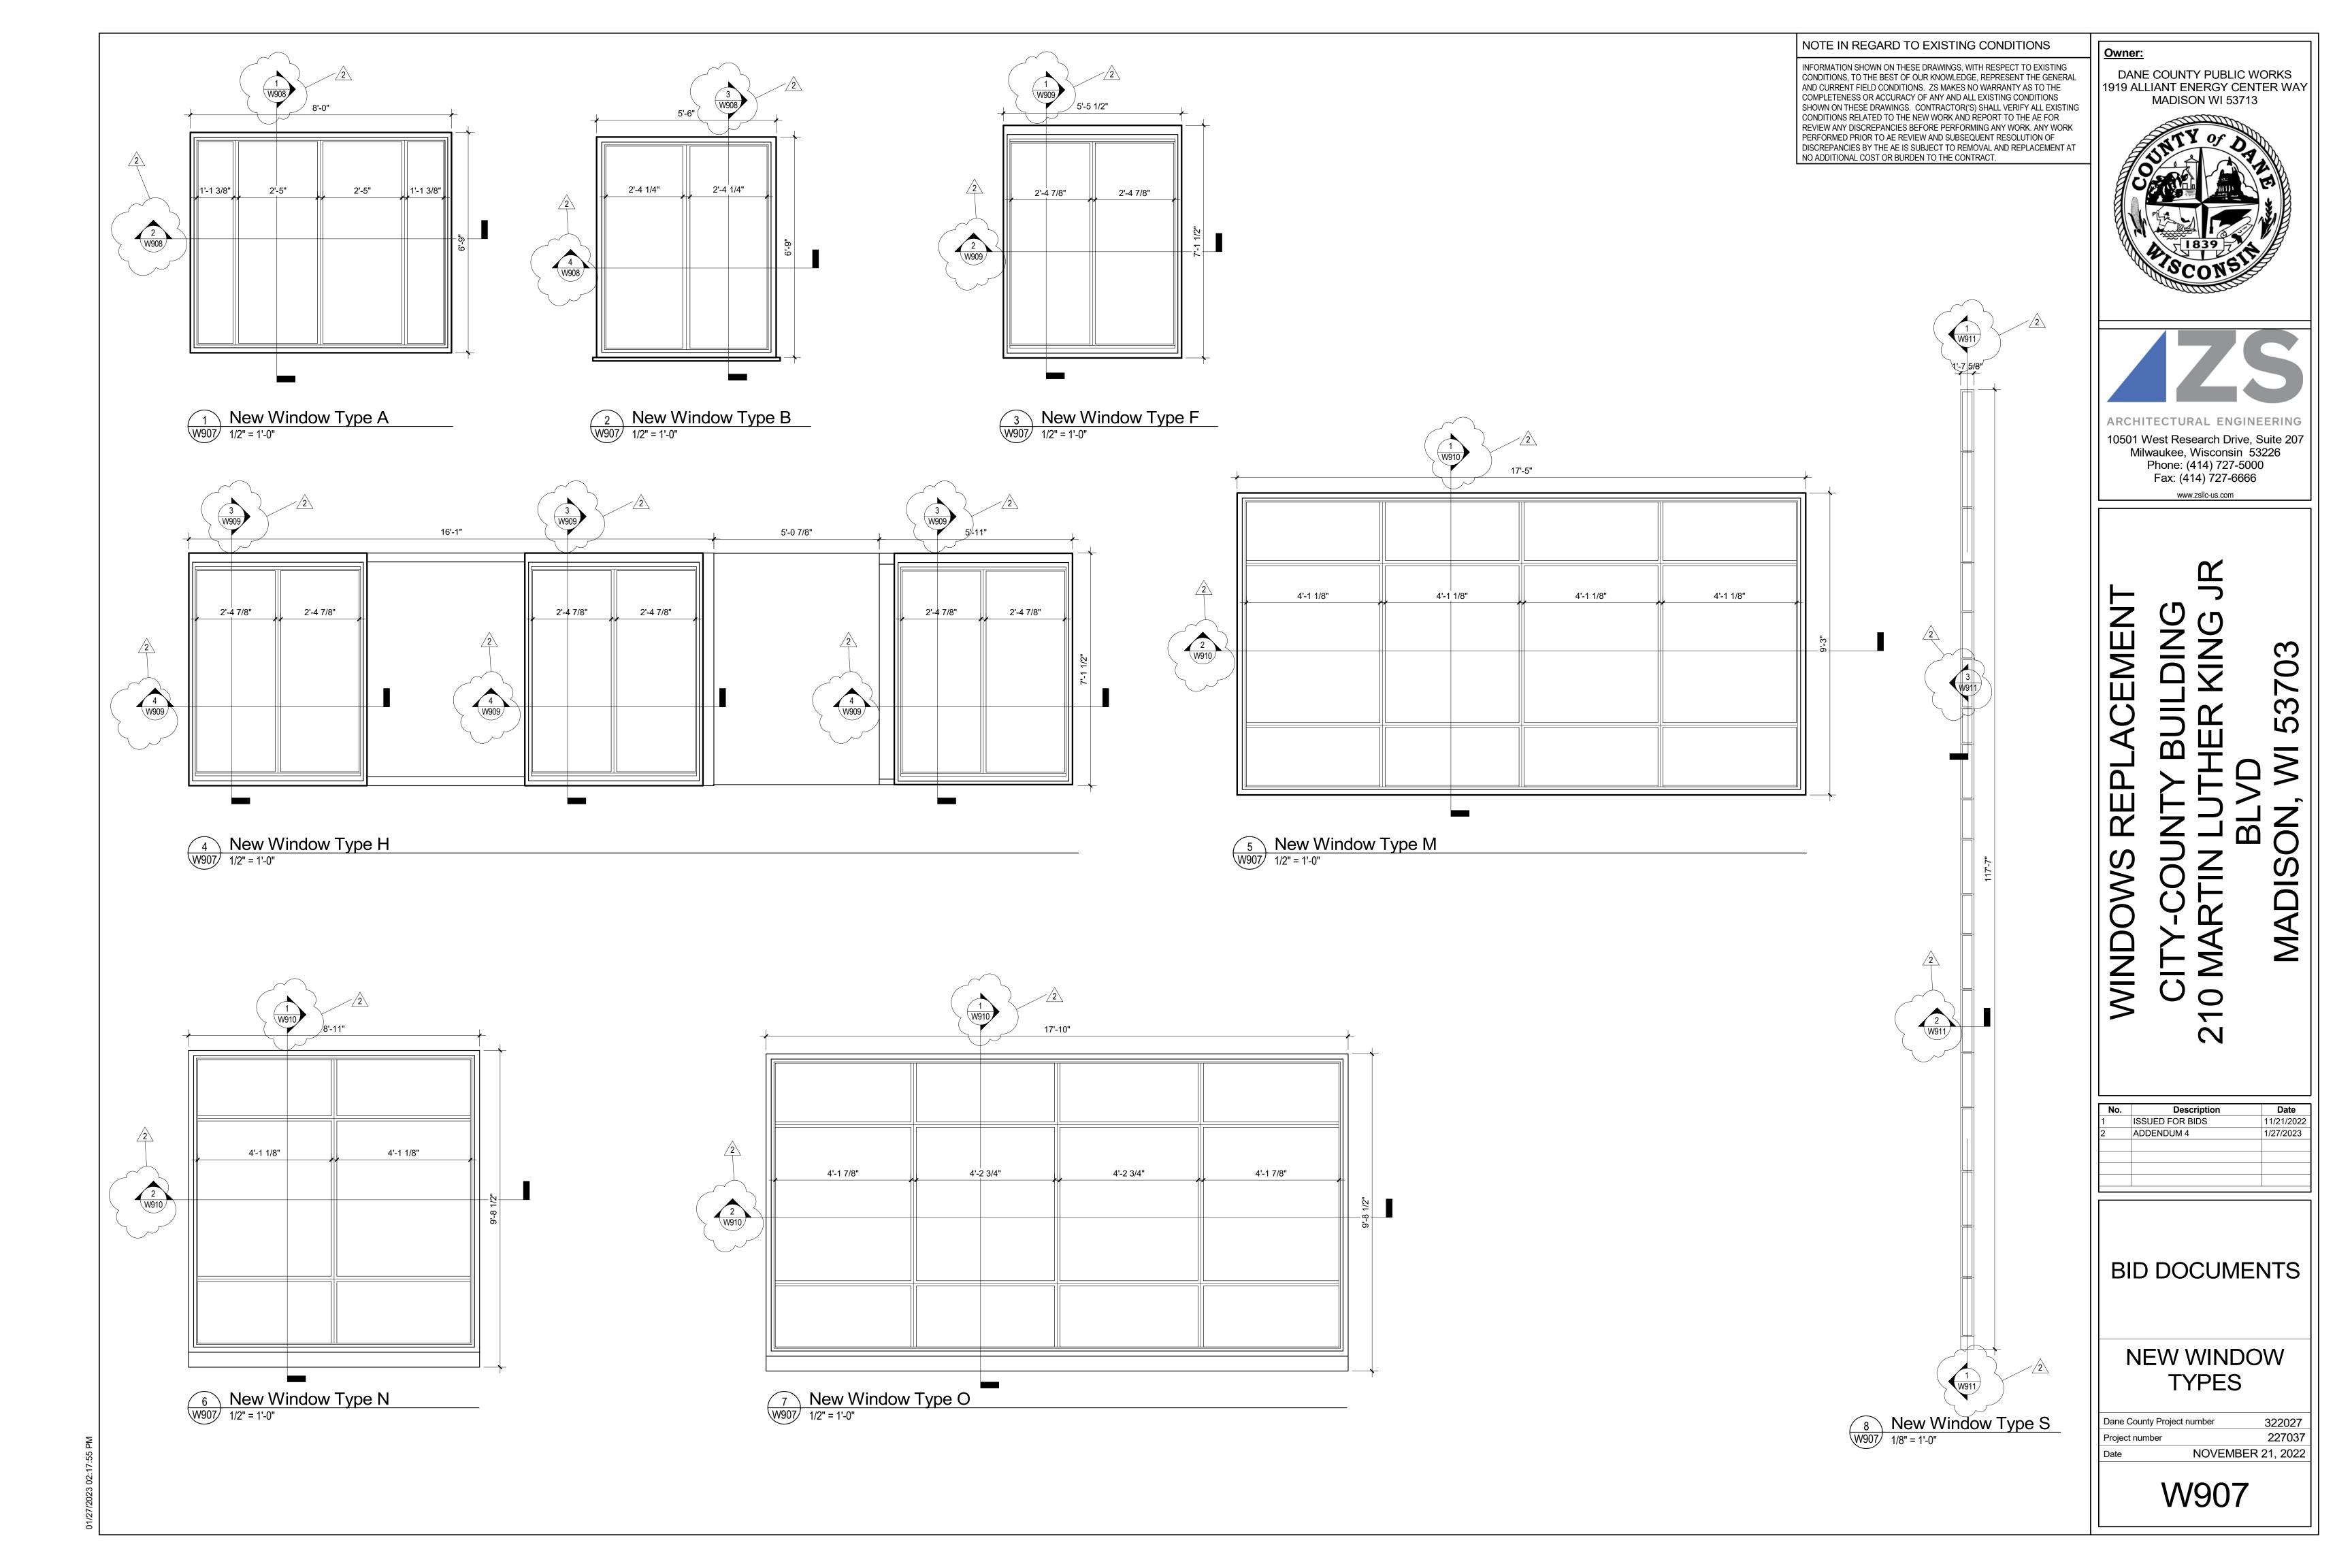


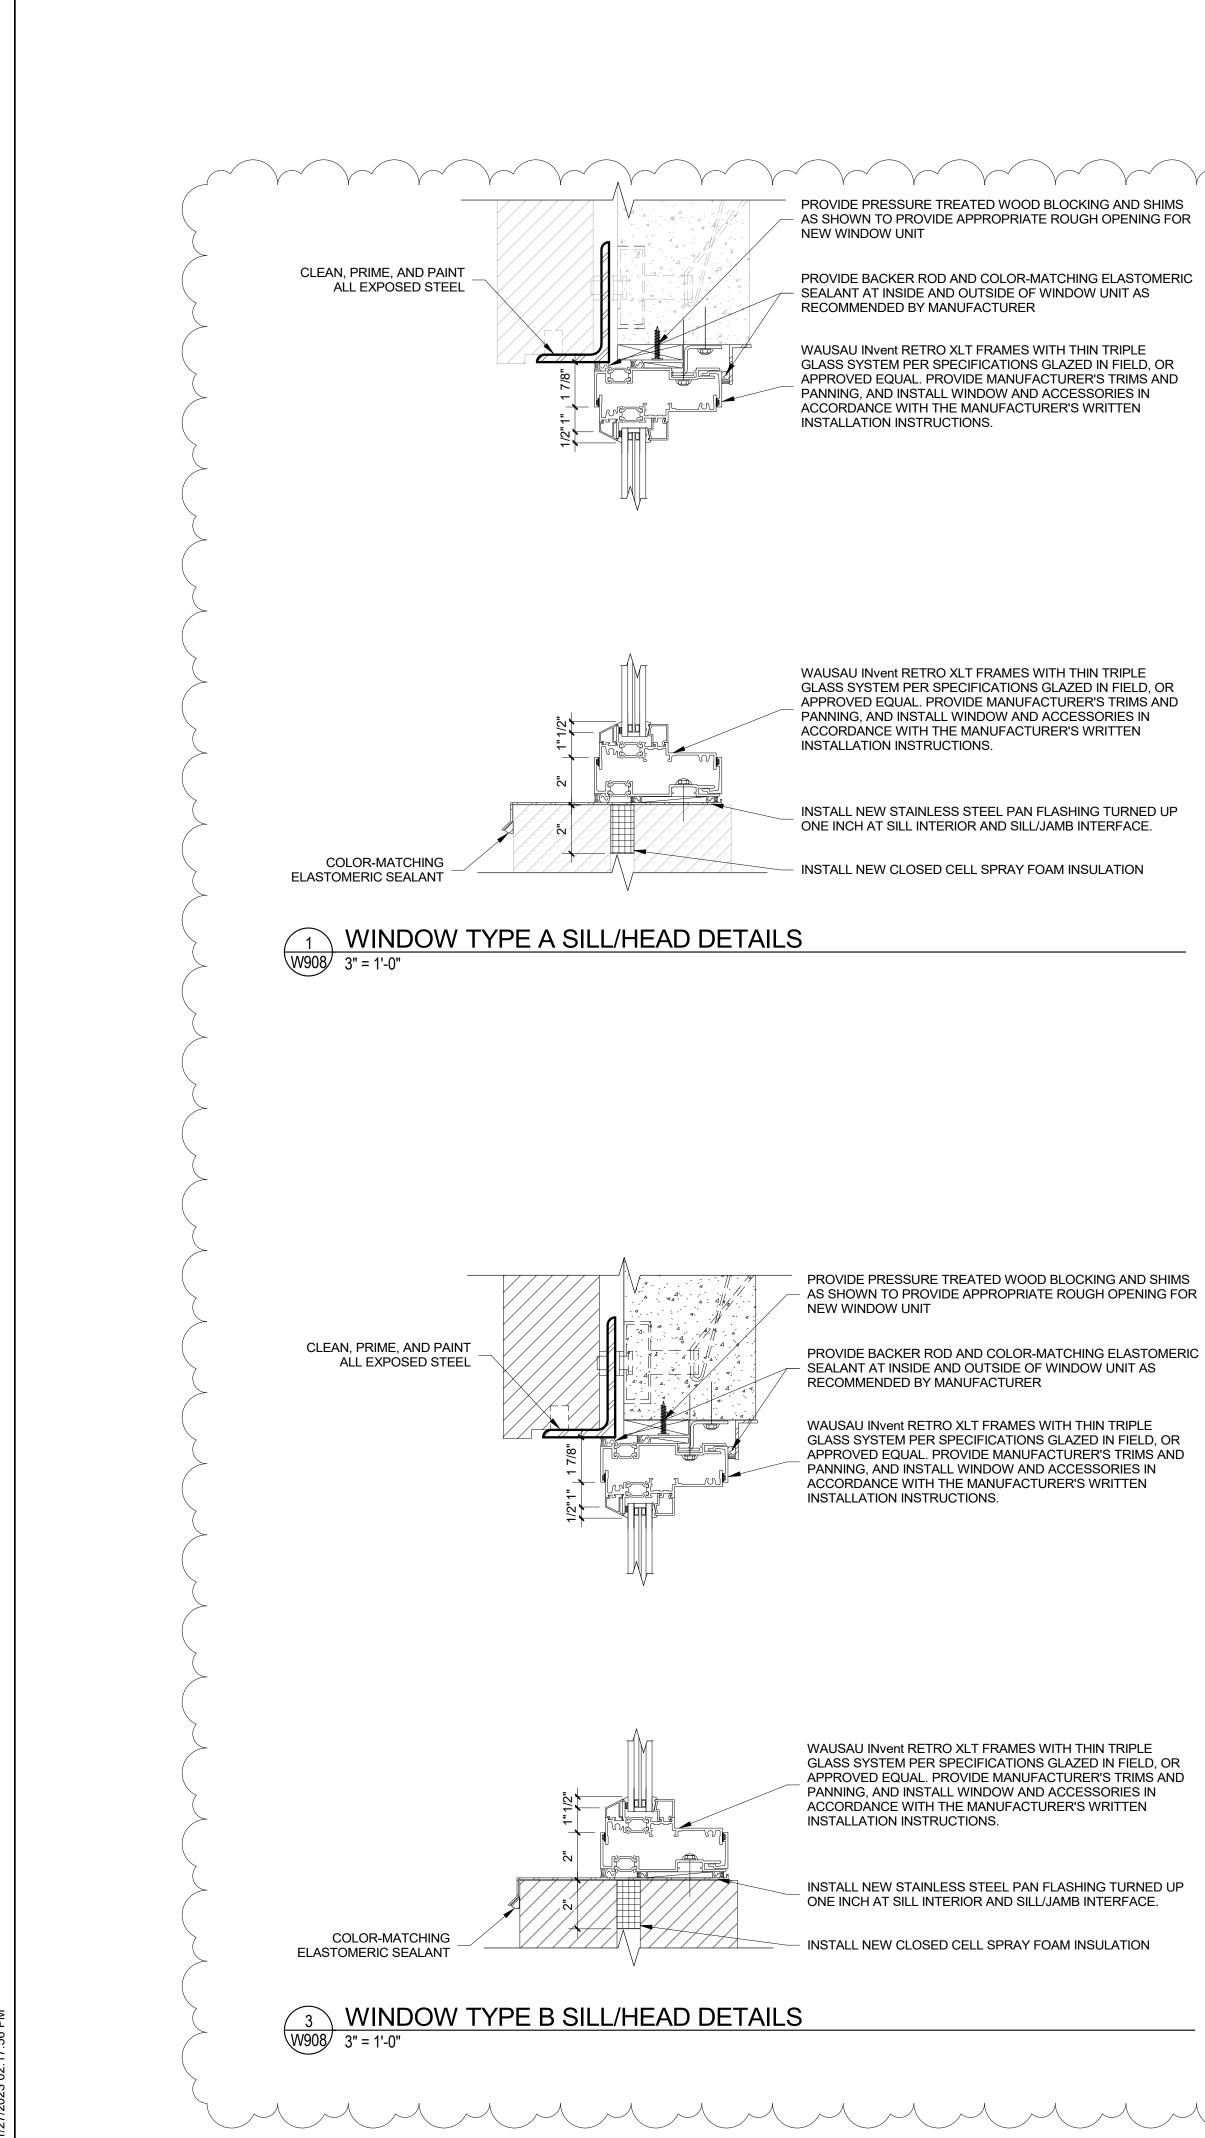




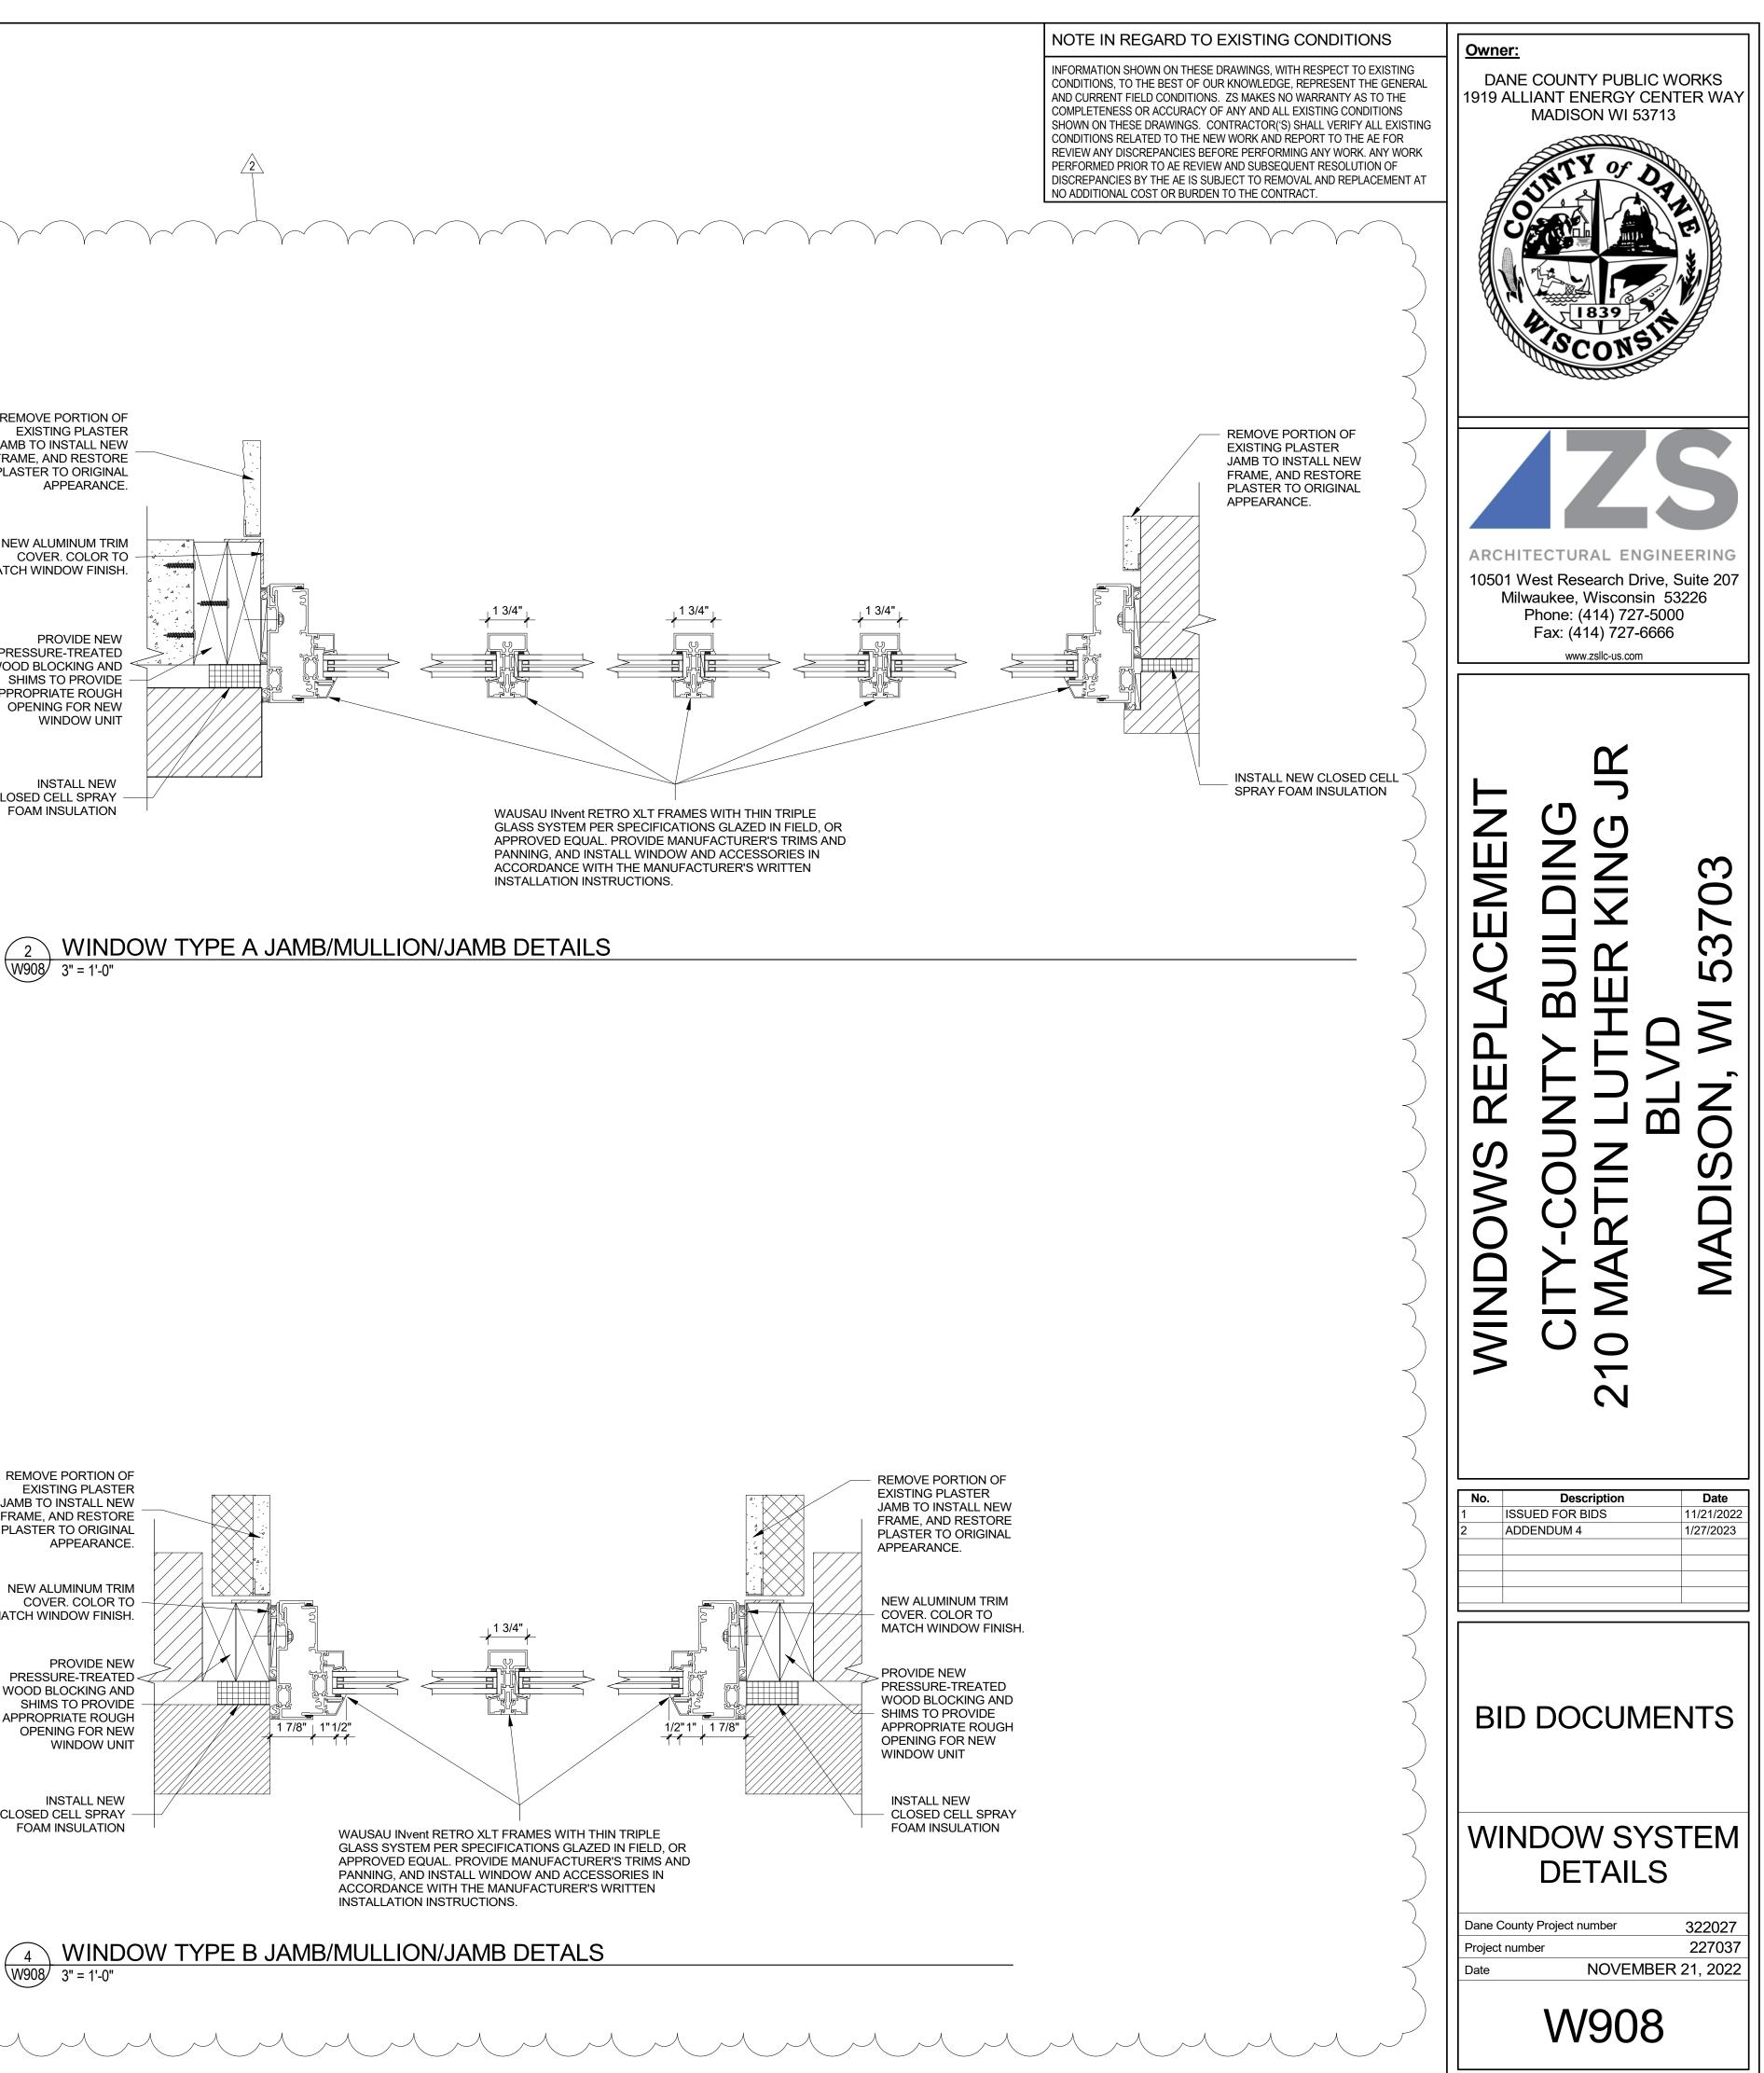


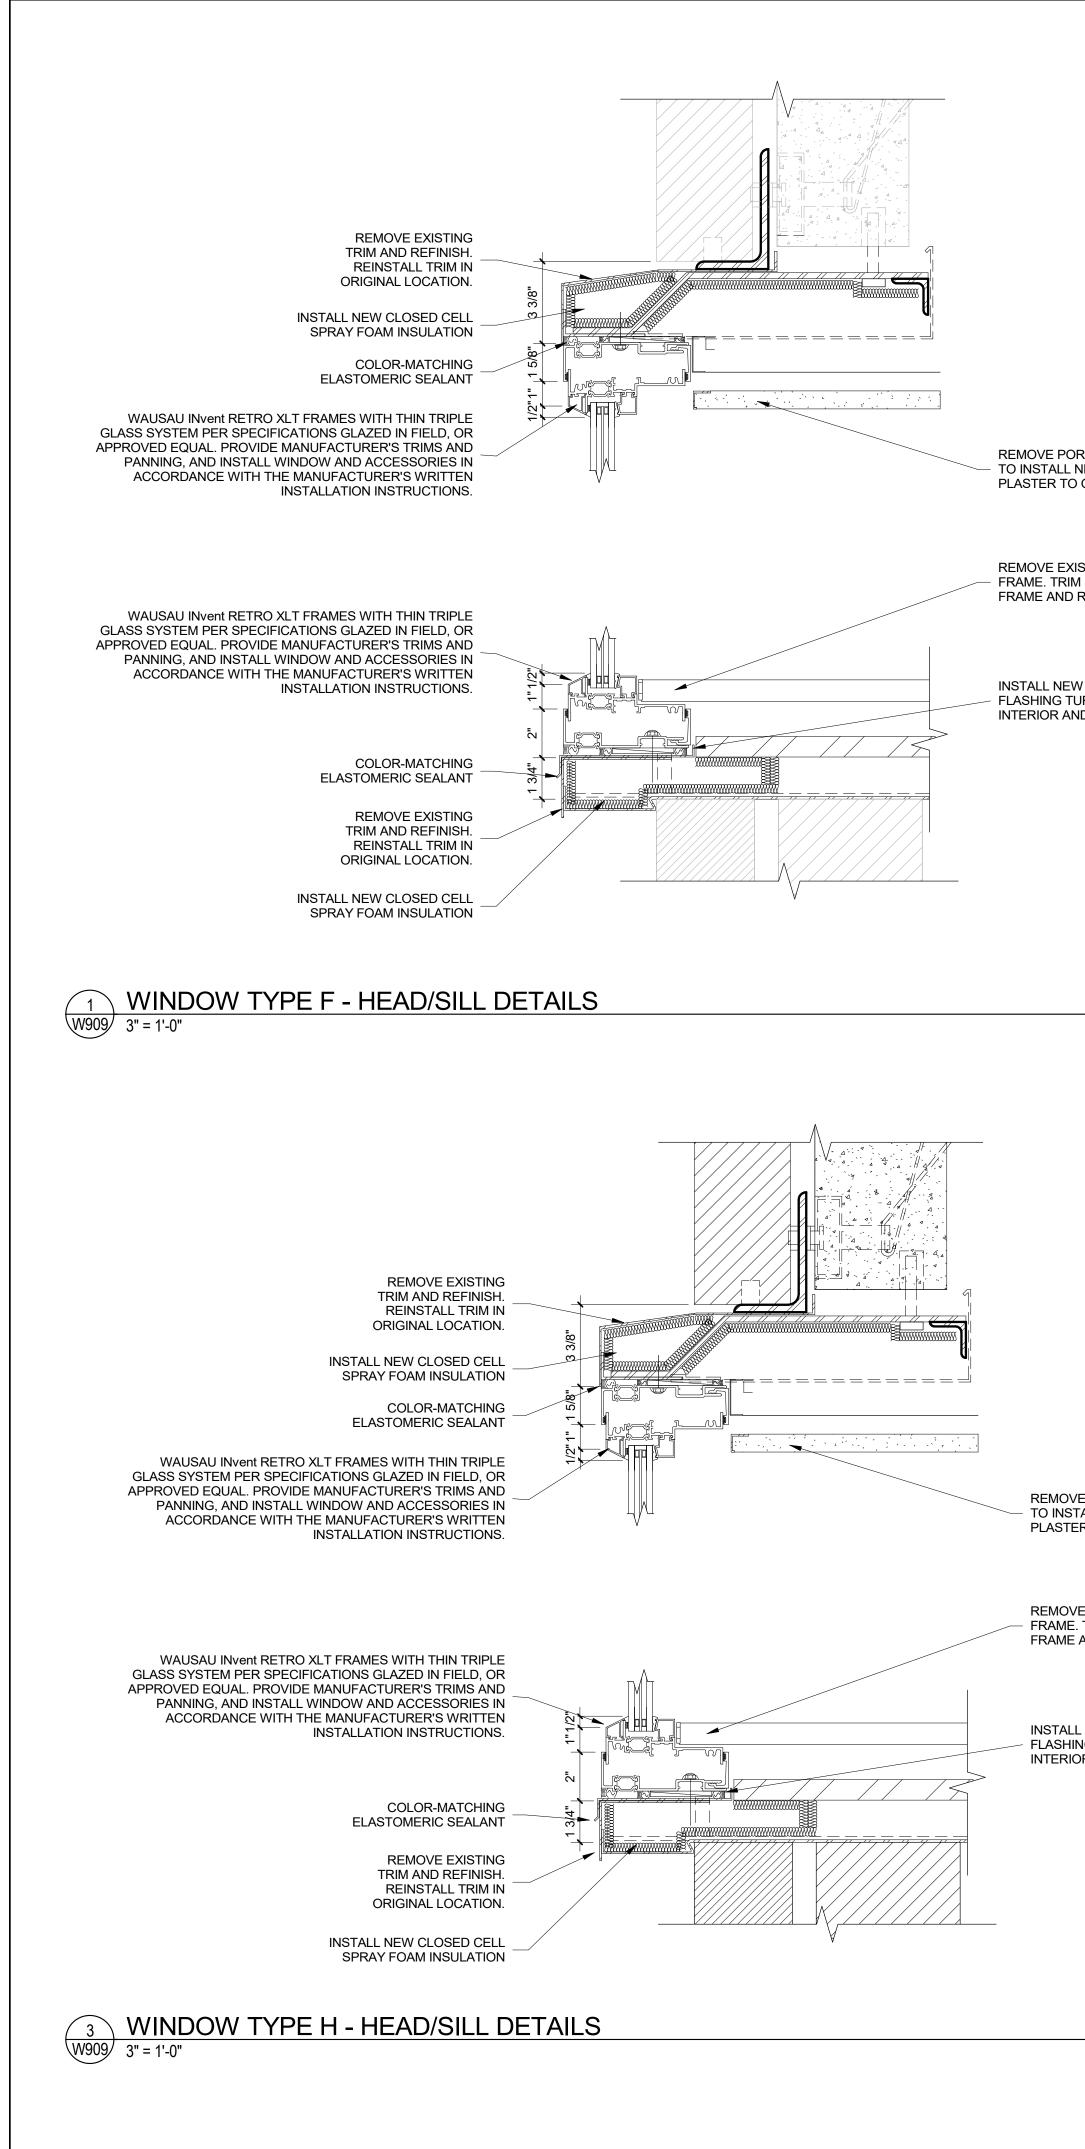

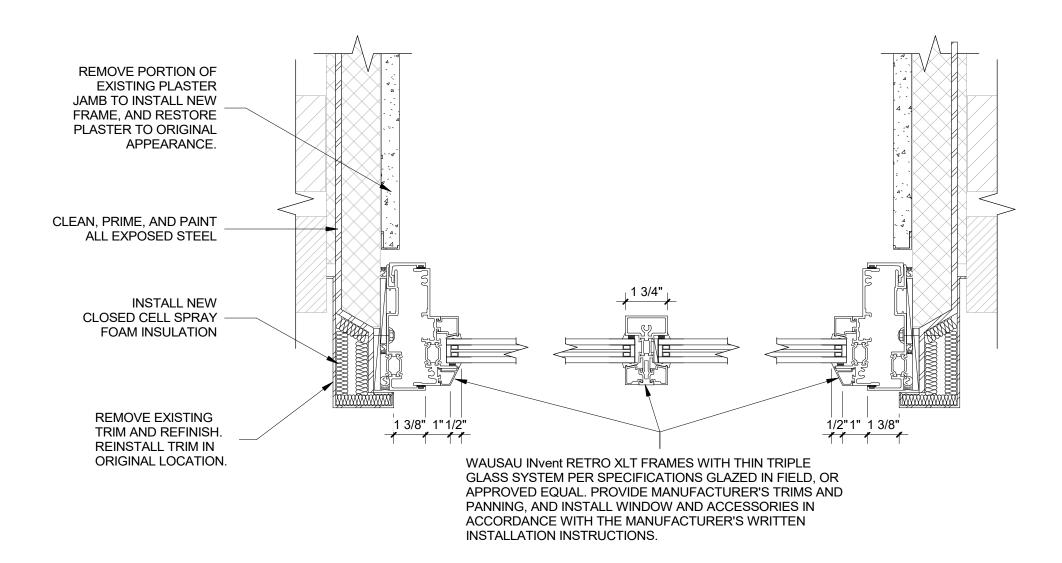

WINDOW TYPE F - JAMB/MULLION/JAMB DETAIS 3" = 1'-0"

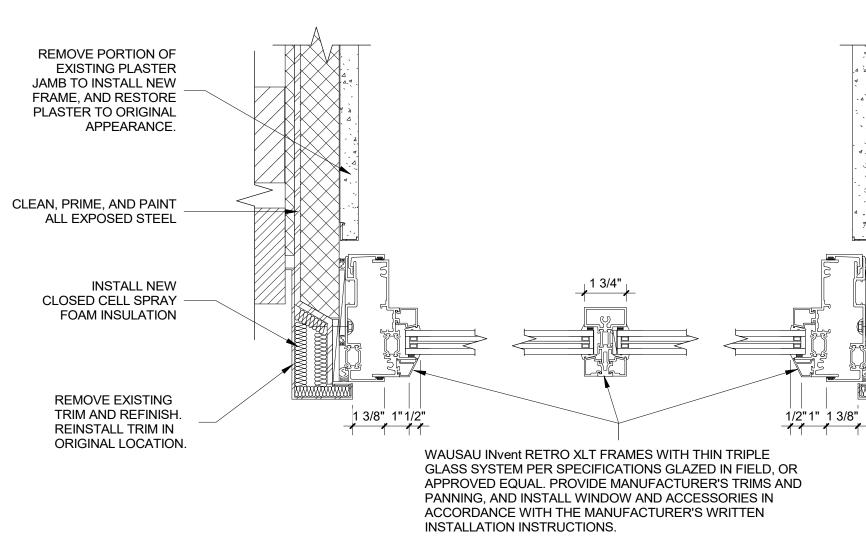

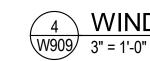

4 WINDOW TYPE H - JAMB/MULLION/JAMB DETAILS

REMOVE PORTION OF EXISTING PLASTER HEAD TO INSTALL NEW FRAME, AND RESTORE PLASTER TO ORIGINAL APPEARANCE.

REMOVE EXISTING STONE SILL TO INSTALL NEW FRAME. TRIM SILL TO ACCOMMODATE NEW FRAME AND REINSTALL IN ORIGINAL LOCATION.

INSTALL NEW STAINLESS STEEL PAN FLASHING TURNED UP ONE INCH AT SILL INTERIOR AND SILL/JAMB INTERFACE.

> REMOVE PORTION OF EXISTING PLASTER HEAD TO INSTALL NEW FRAME, AND RESTORE PLASTER TO ORIGINAL APPEARANCE.

> REMOVE EXISTING STONE SILL TO INSTALL NEW FRAME. TRIM SILL TO ACCOMMODATE NEW FRAME AND REINSTALL IN ORIGINAL LOCATION.

INSTALL NEW STAINLESS STEEL PAN FLASHING TURNED UP ONE INCH AT SILL INTERIOR AND SILL/JAMB INTERFACE. NOTE IN REGARD TO EXISTING CONDITIONS

INFORMATION SHOWN ON THESE DRAWINGS, WITH RESPECT TO EXISTING CONDITIONS, TO THE BEST OF OUR KNOWLEDGE, REPRESENT THE GENERAL AND CURRENT FIELD CONDITIONS. ZS MAKES NO WARRANTY AS TO THE COMPLETENESS OR ACCURACY OF ANY AND ALL EXISTING CONDITIONS SHOWN ON THESE DRAWINGS. CONTRACTOR('S) SHALL VERIFY ALL EXISTING CONDITIONS RELATED TO THE NEW WORK AND REPORT TO THE AE FOR REVIEW ANY DISCREPANCIES BEFORE PERFORMING ANY WORK. ANY WORK PERFORMED PRIOR TO AE REVIEW AND SUBSEQUENT RESOLUTION OF DISCREPANCIES BY THE AE IS SUBJECT TO REMOVAL AND REPLACEMENT AT NO ADDITIONAL COST OR BURDEN TO THE CONTRACT.

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Owner:

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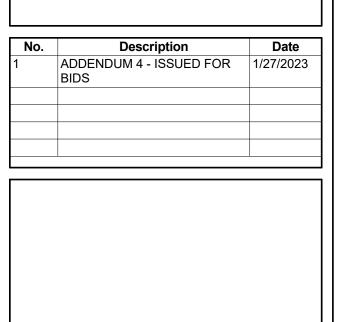
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10501 West Research Drive, Suite 207 Milwaukee, Wisconsin 53226 Phone: (414) 727-5000 Fax: (414) 727-6666 www.zsllc-us.com

# CITY-COUNTY BUILDING 10 MARTIN LUTHER KING J BLVD MADISON, WI 53703





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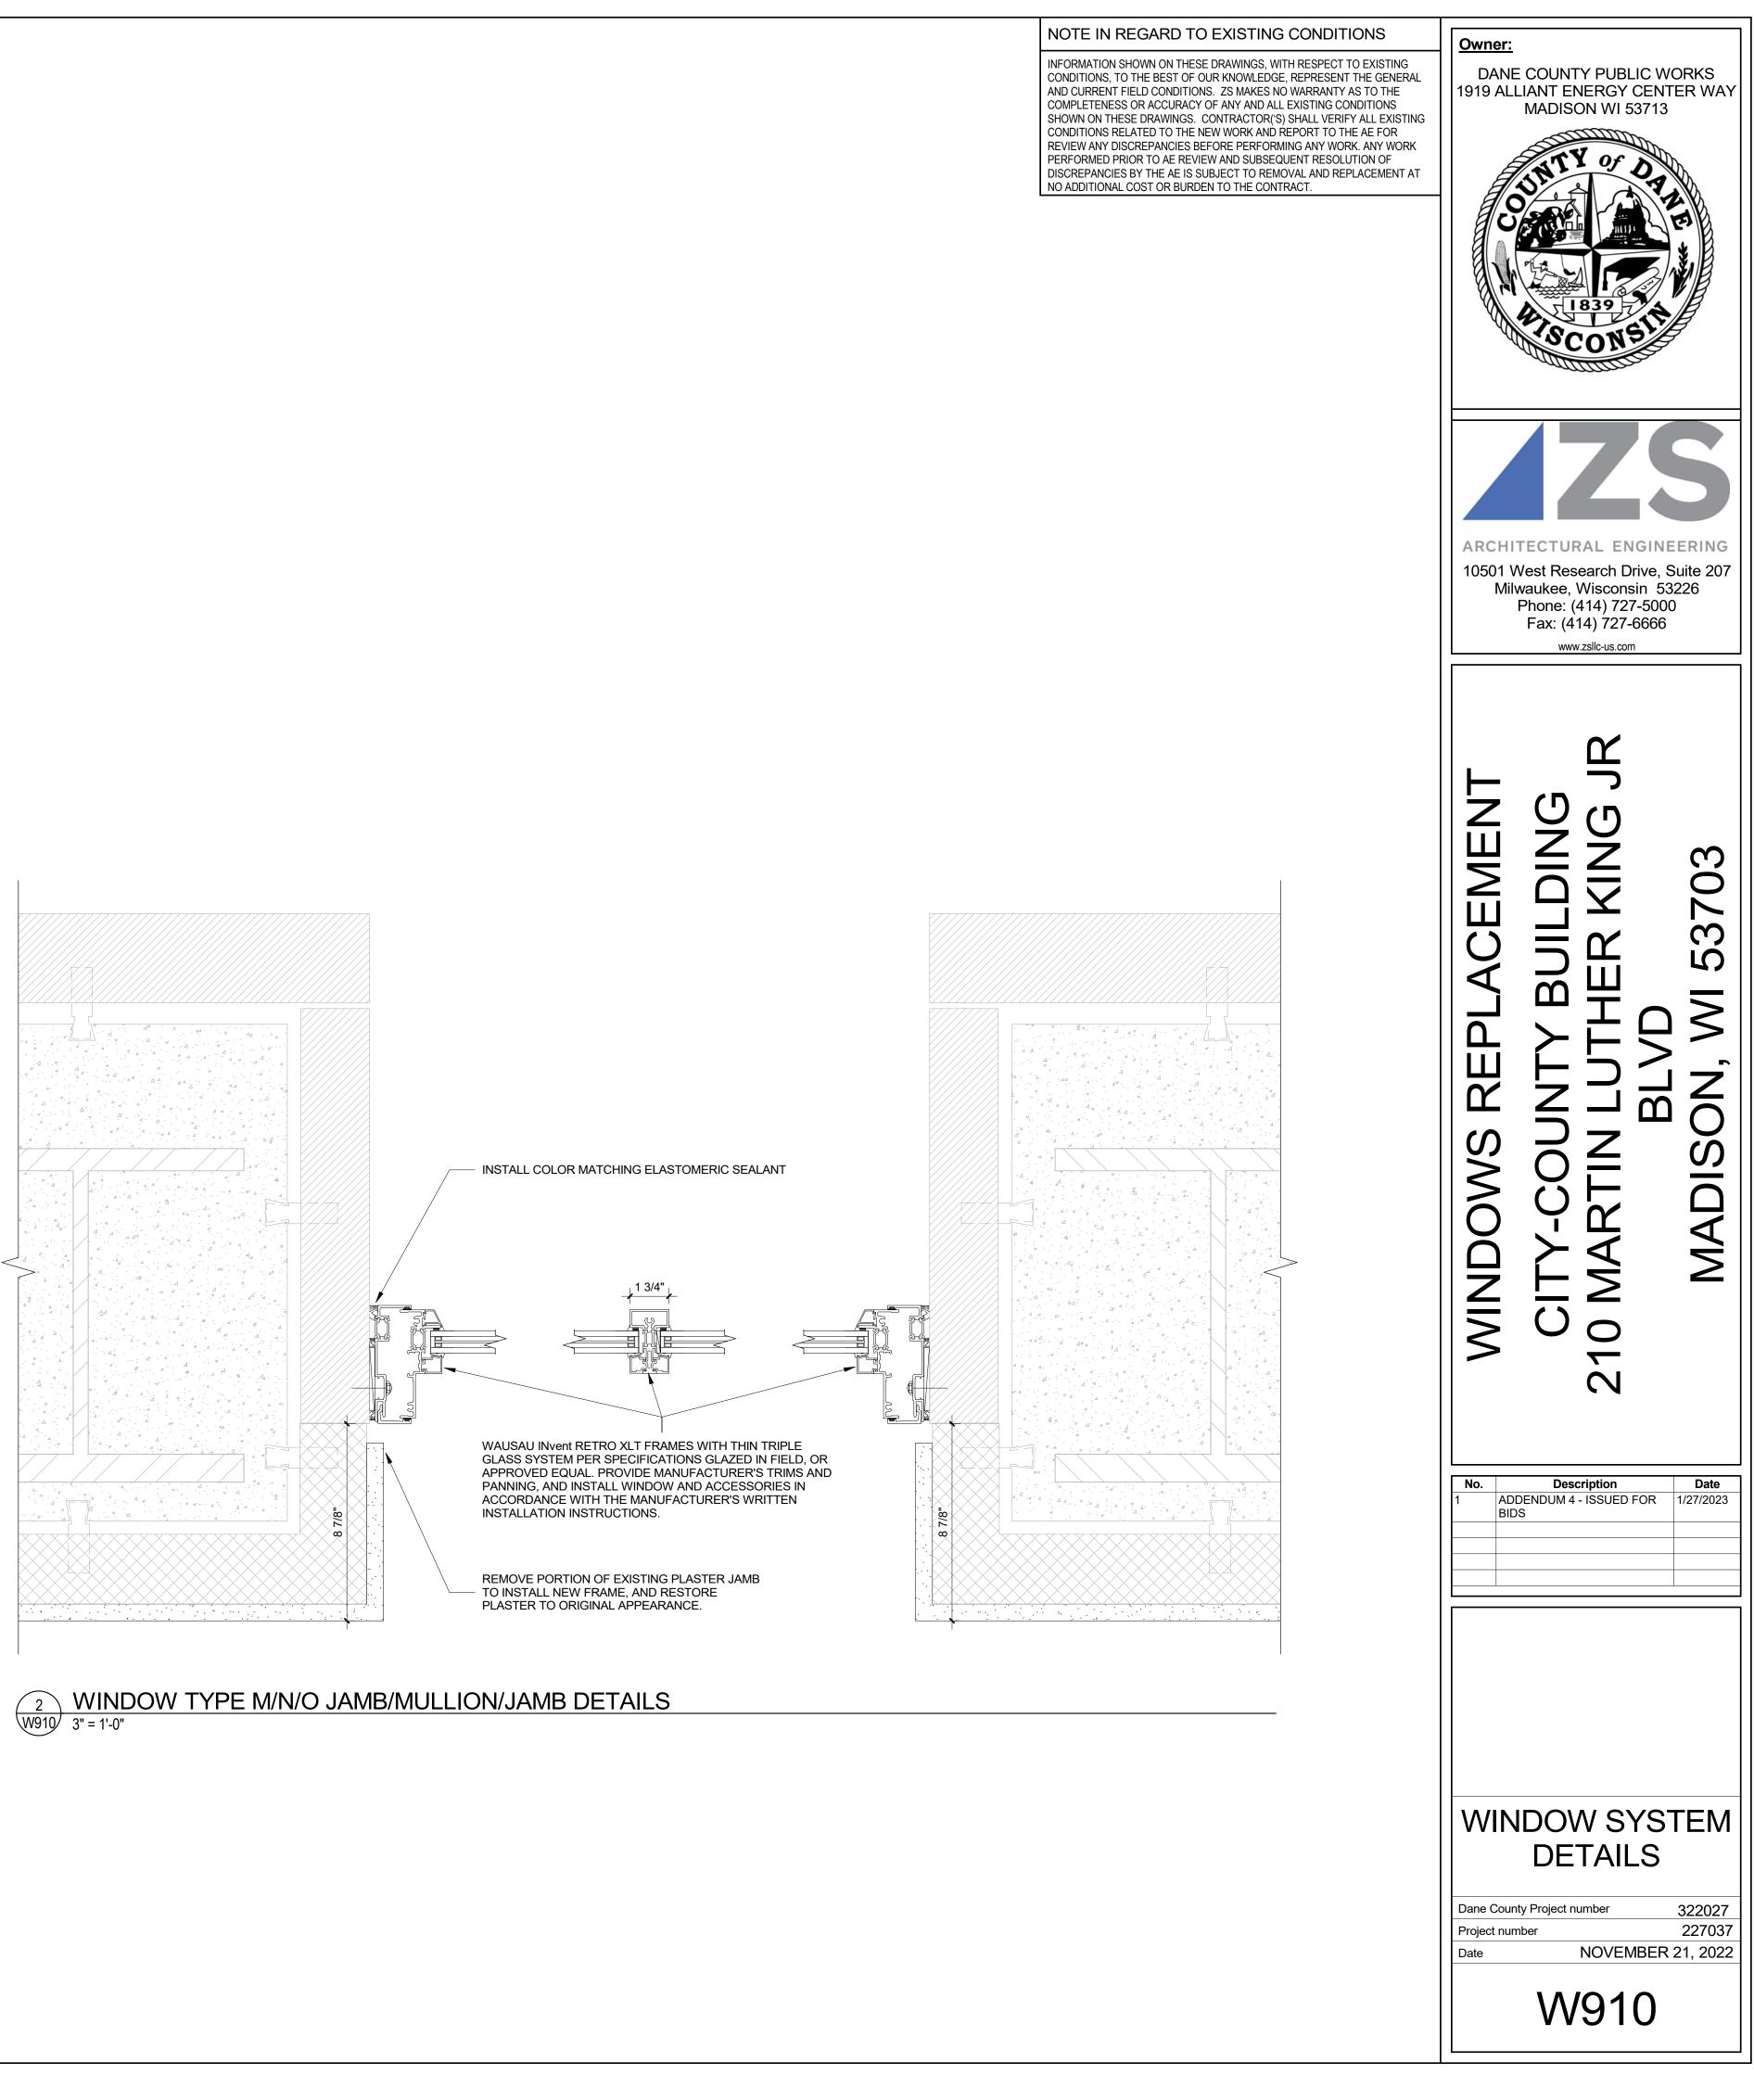
## WINDOW SYSTEM DETAILS


Dane County Project number322027Project number227037DateNOVEMBER 21, 2022






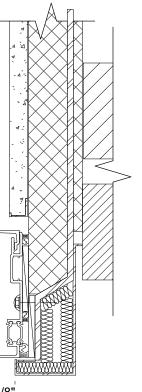

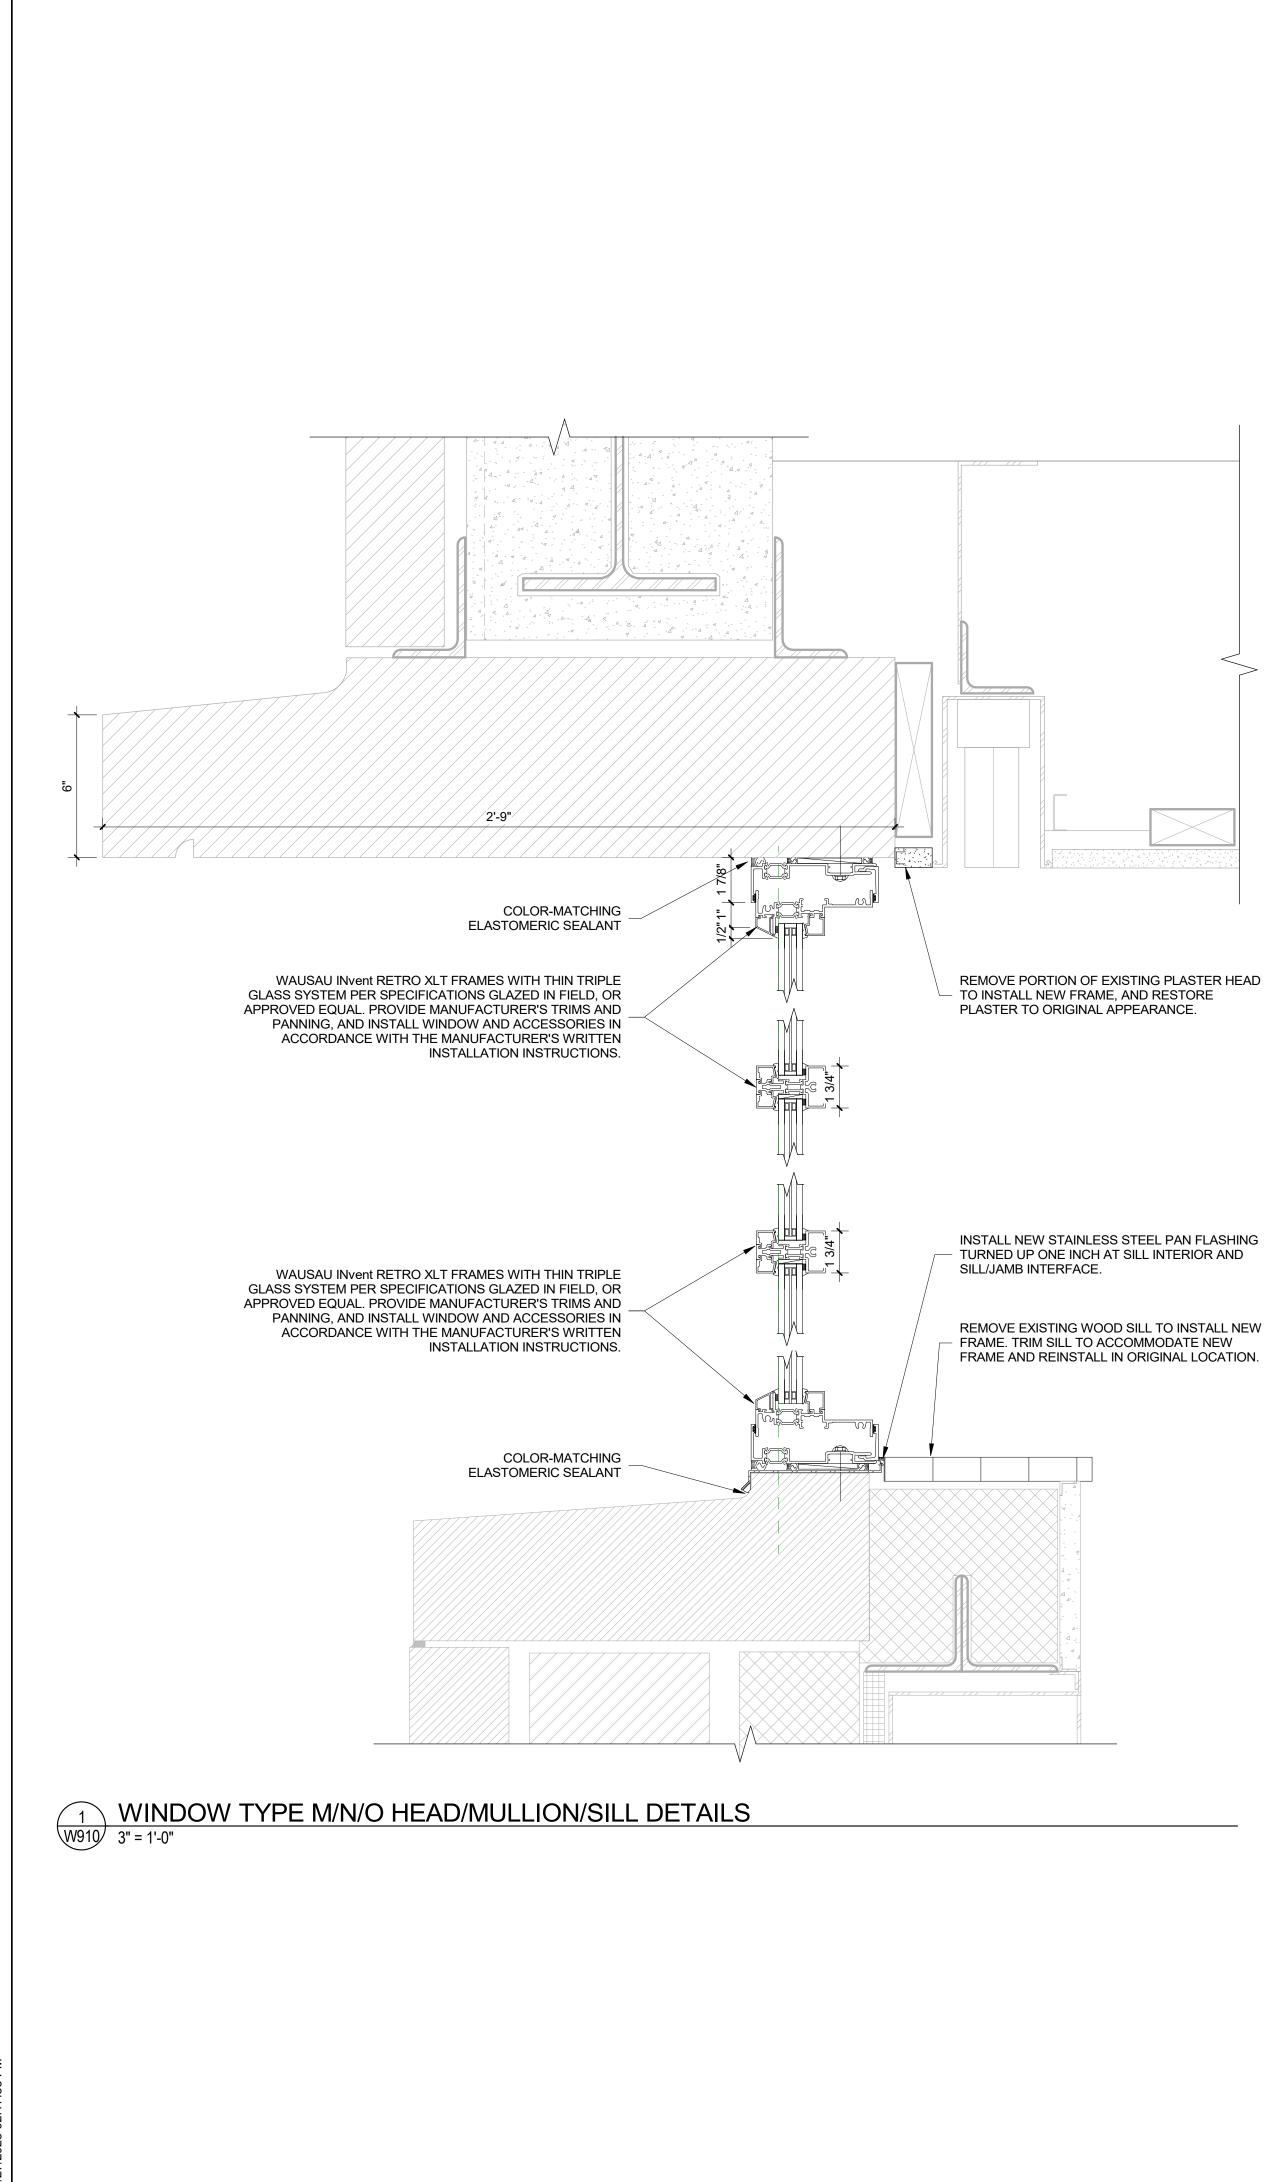

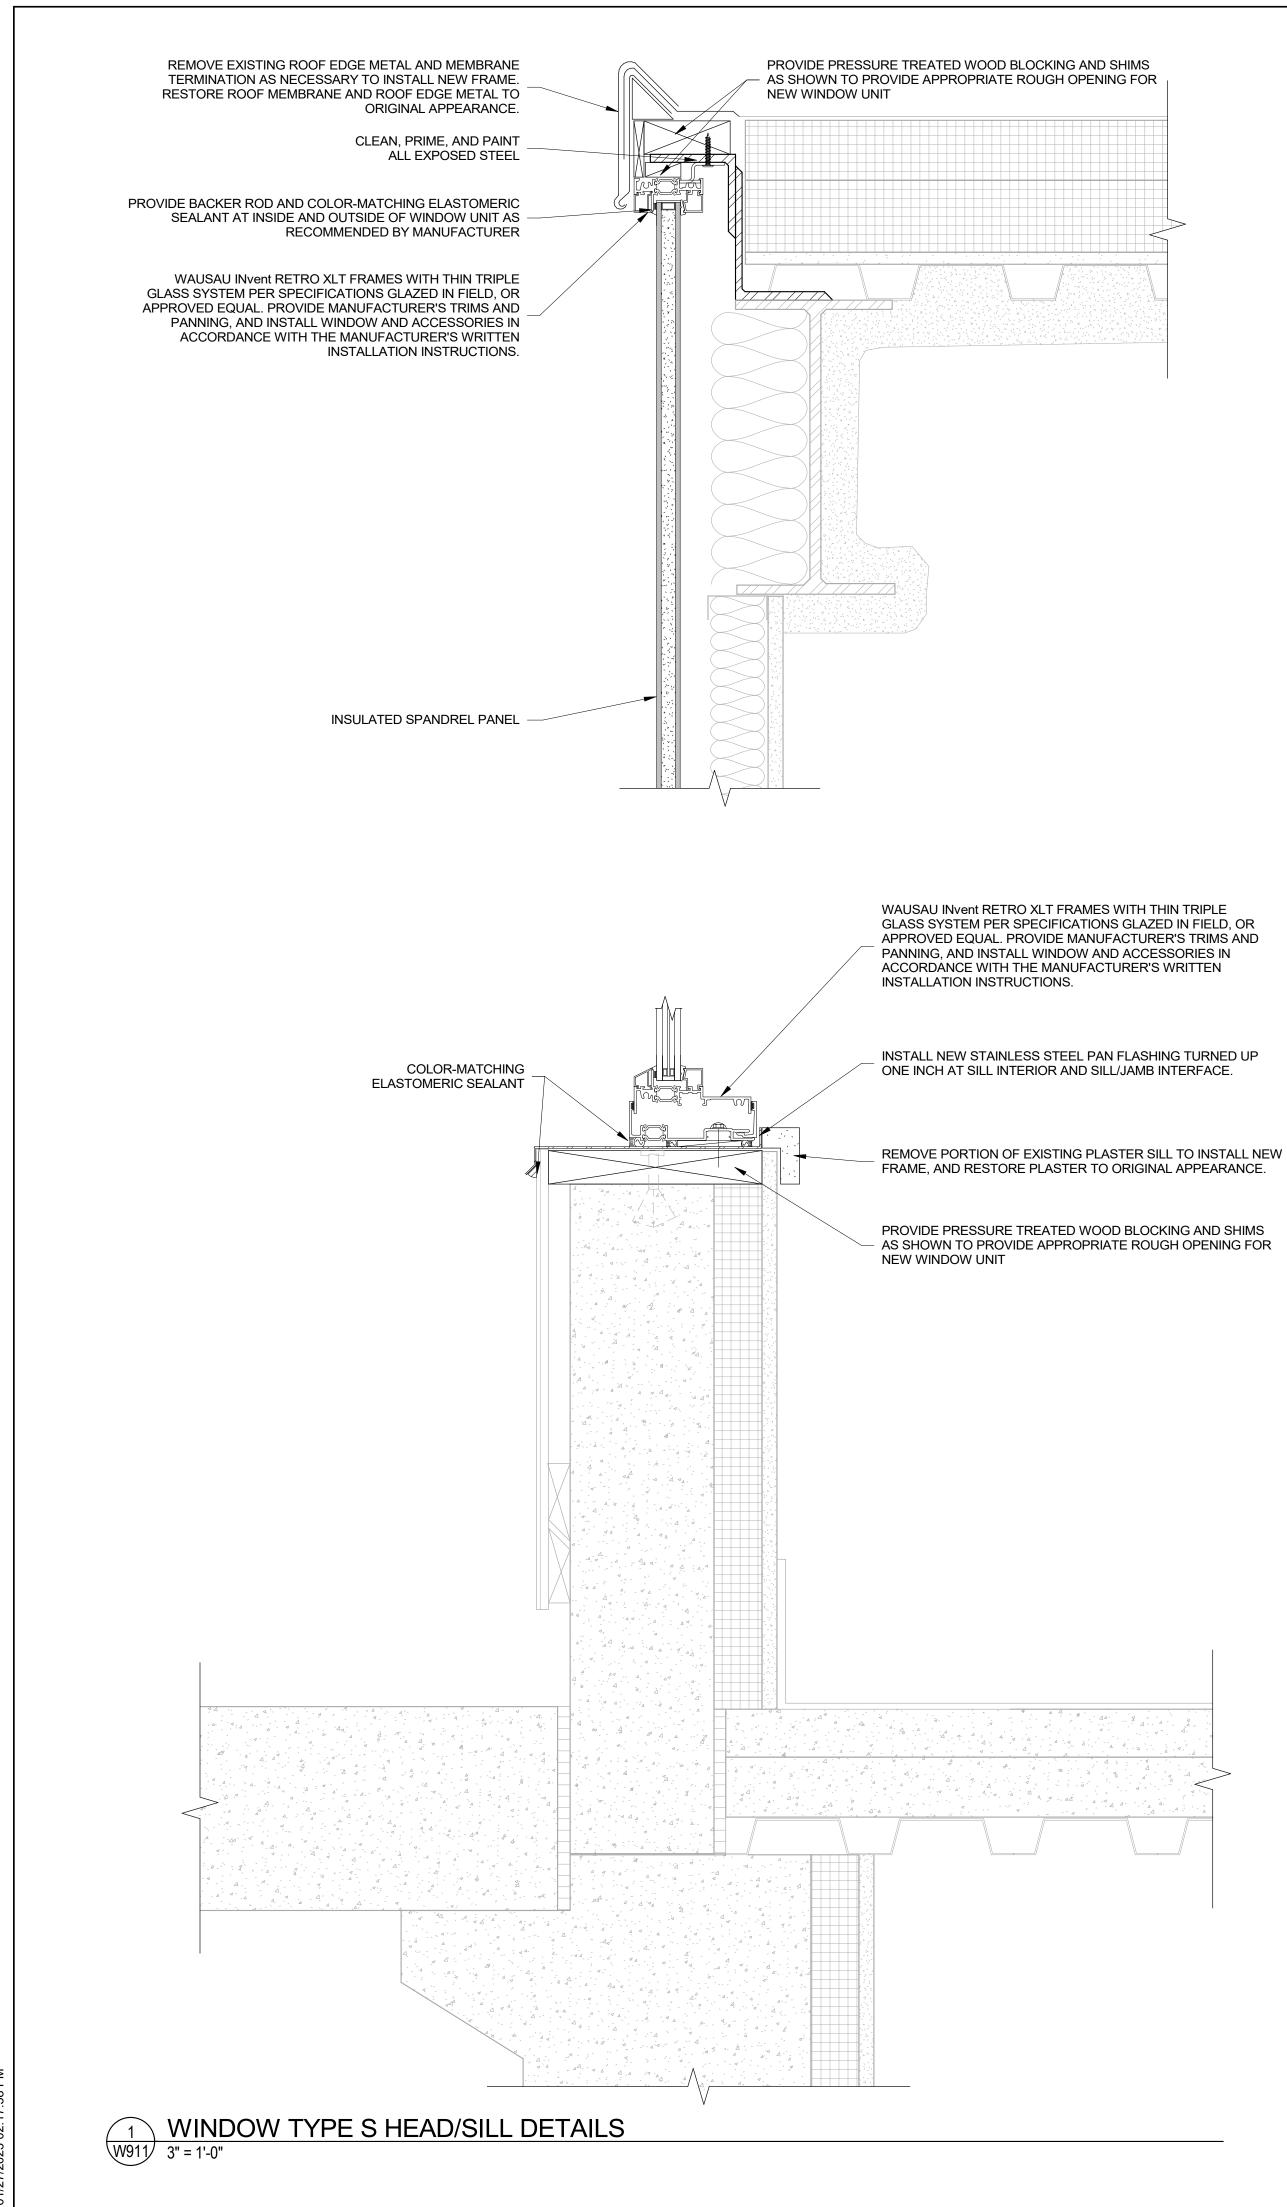

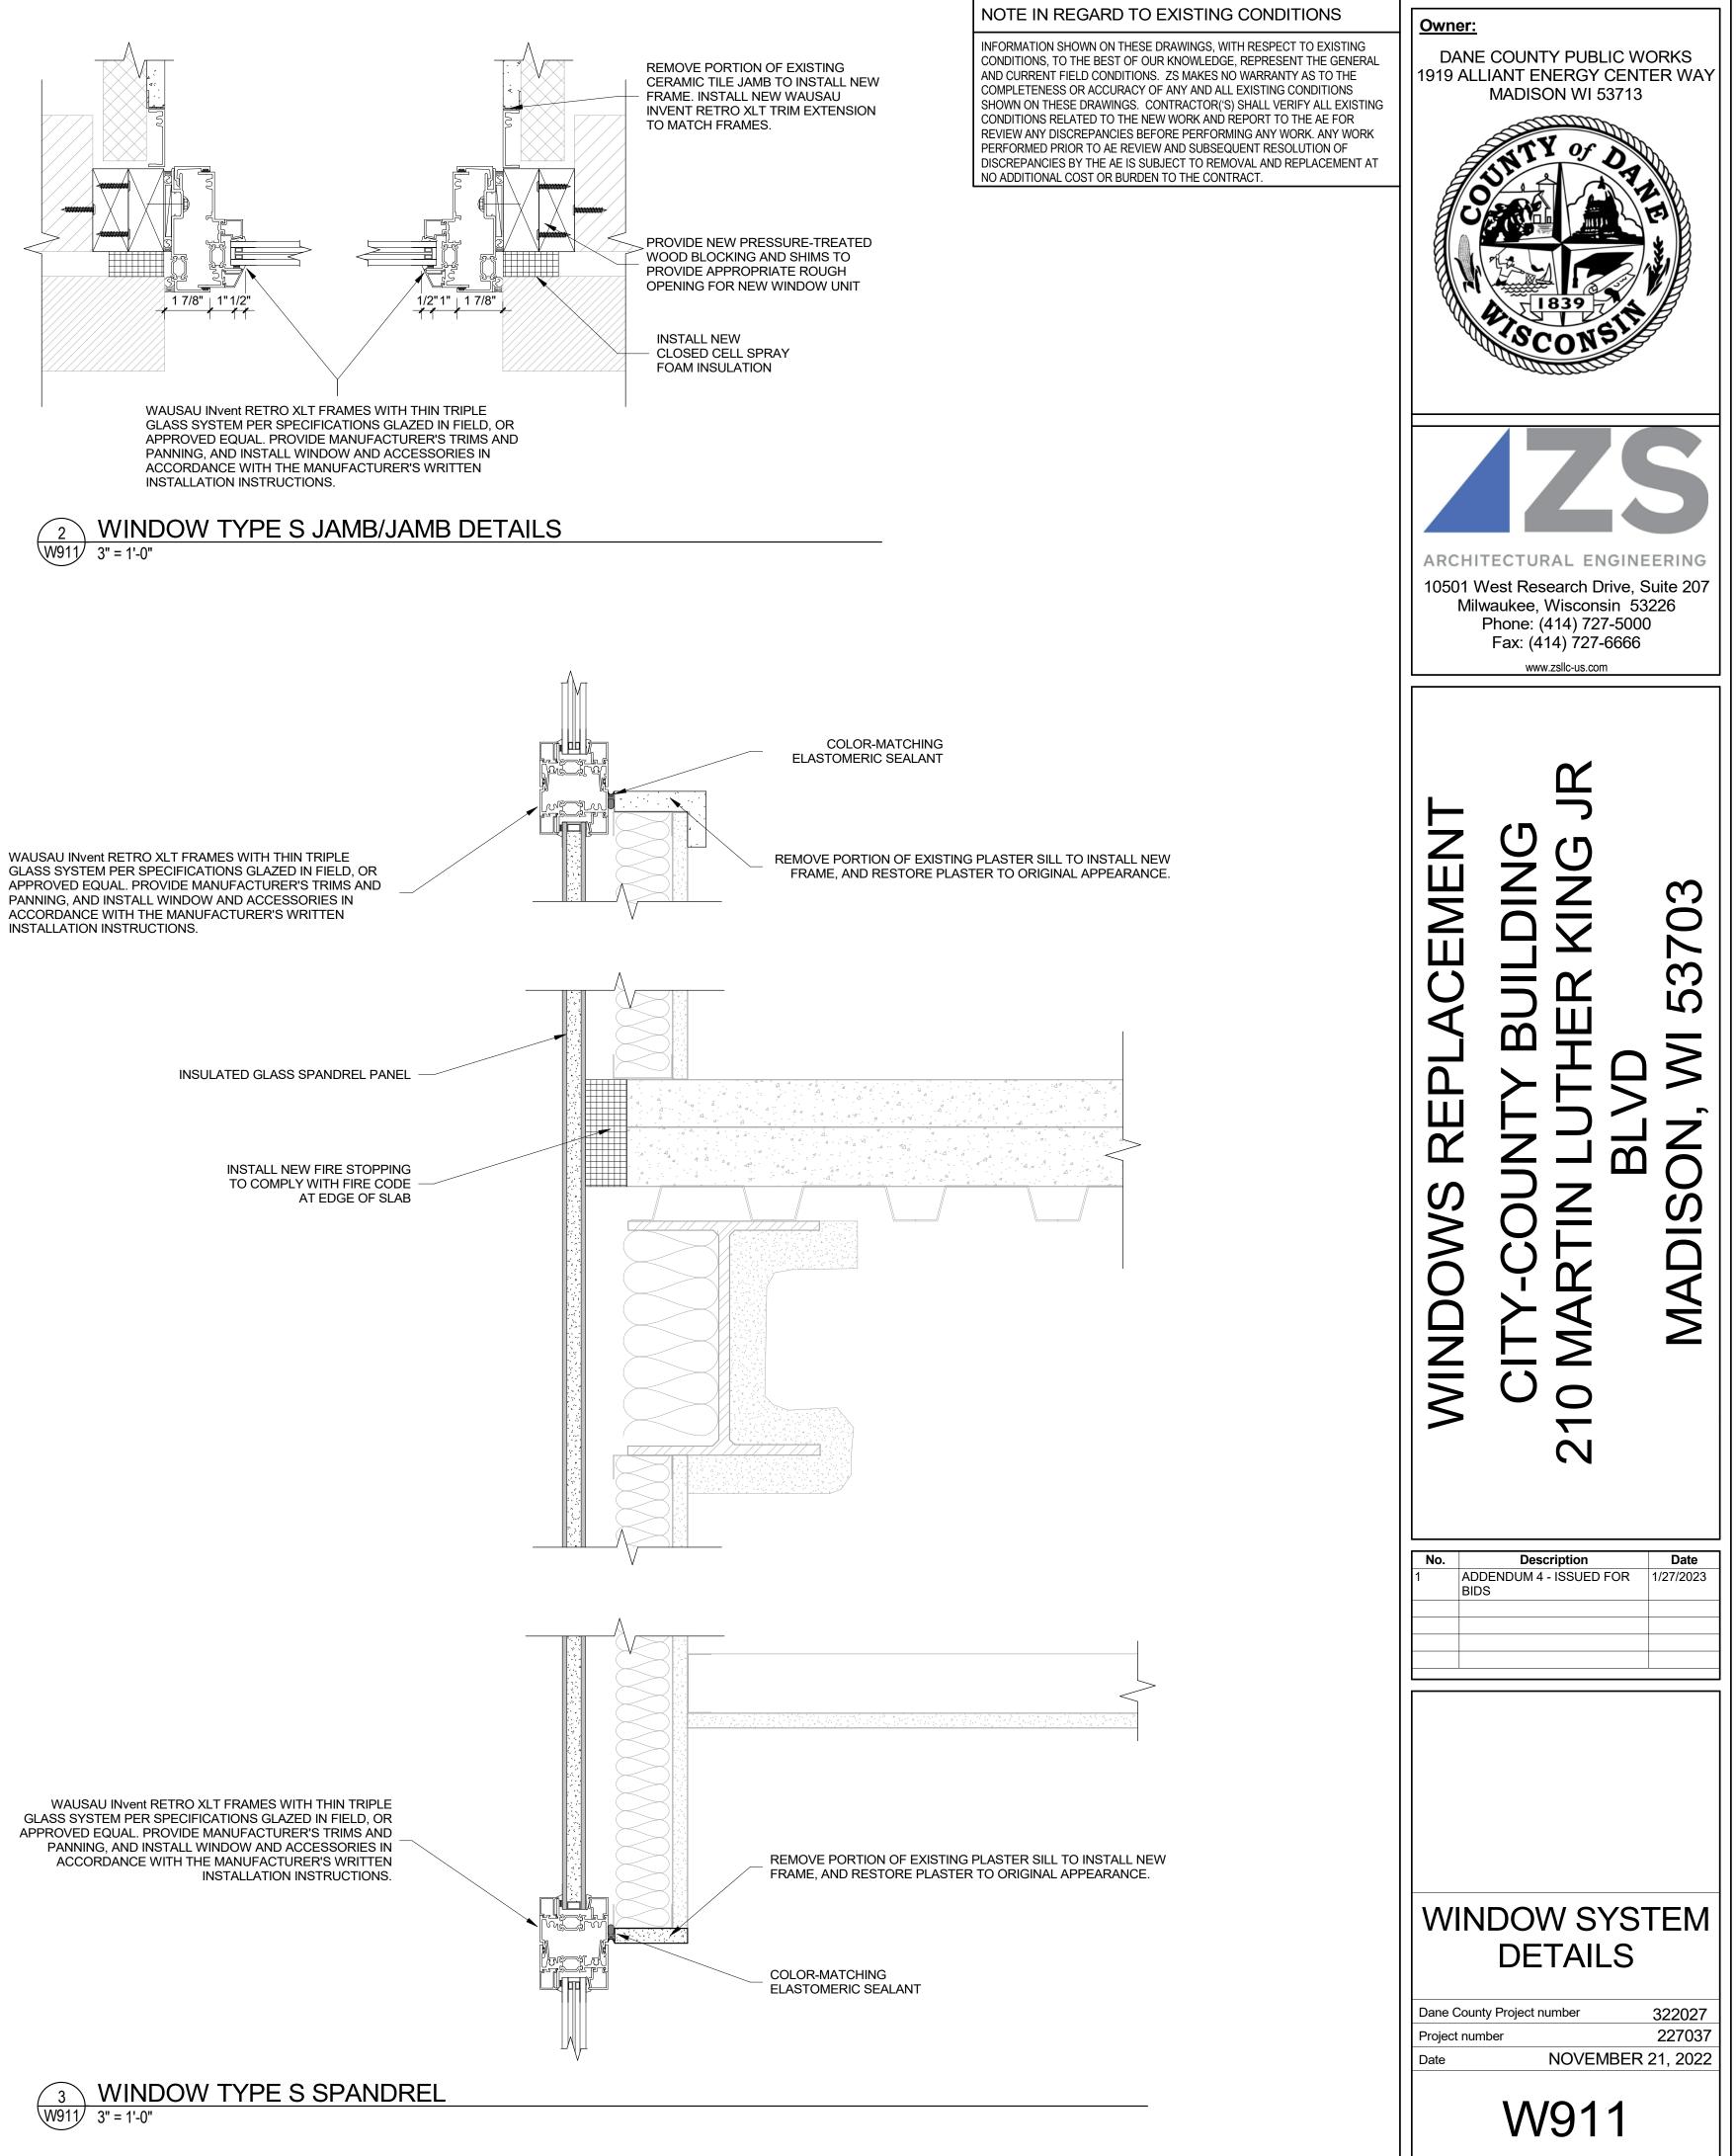

GLASS SYSTEM PER SPECIFICATIONS GLAZED IN FIELD, OR PANNING, AND INSTALL WINDOW AND ACCESSORIES IN ACCORDANCE WITH THE MANUFACTURER'S WRITTEN INSTALLATION INSTRUCTIONS.

